
1728 Coral Way • Suite 702 • Miami, Florida 33145 • Tel (305) 860-9600 • Fax (305) 860-9602

Written Statement of Architectural Style for: Proposed Residence for NP Sorolla LLC 1248 Sorolla Ave, Coral Gables, Fl. 33134

The residence is influenced by the Modern Ranch and Tropical Modern styles of architecture. This style of architecture focuses on open floor plans, juxtaposition between vertical and horizontal elements, and blurring the distinctions between indoor and outdoor spaces.

There is an emphasis on the design's rear views toward the rear garden. A dynamic relationship between the vertical openings and planes and the pronounced horizontal elements found in the façade. The residence has an open floor plan, which unites all the public spaces of the home and creates grand views to the rear yard. Large openings are introduced in the rear façade in order to extend the living spaces into the rear yard. Terraces connect the main spaces of the home to the outdoors. The use of natural materials; such as wood details, and stone walls illustrate the integration with nature being achieved in the design.

LOCATION MAP

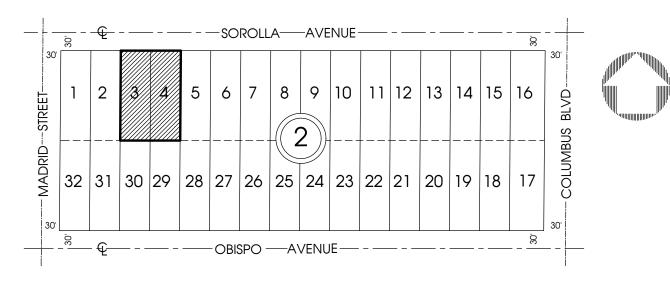

LEGAL DESCRIPTION

Lots 3 & 4, Block 2, "CORAL GABLES SEC. E", according to the plat thereof, as recorded in Plat Book 8, at Page 13, of the Public Record of Miami-Dade County, Florida.

Property address: 1248 SOROLLA AVENUE, CORAL GABLES, FLORIDA 33134-3516

Flood Zone: "X " Community Panel No.: 120639-0239 Base Flood Elevation: N/A Map Revised: September 11th, 2009

FOR THE BENEFIT OF: ARAZOZA AND FERNANDEZ-FRAGA, P.A

1248 SOROLLA LLC, A FLORIDA LIMITED LIABILITY COMPANY OLD REPUBLIC NATIONAL TITLE INSURANCE COMPANY



MARIO PRATS JR. & ASSOCIATES, INC.

SURVEYORS - MAPPERS - PLANNERS

52 SW 81st Avenue - Miami, Florida 33144 Voice(305) 551-6000 Fax(305)265-9480

E-mail: docs@pratssurvey.com Certificate of Authorization No.:4249

The above "BOUNDARY SURVEY", represent the herein described property and it was completed under my supervision and or direction, to the best of my knowledge and belief and it also meets the Minimum Technical Standard set forth by The Florida Board of Land Surveyors and Mappers, pursuant to Section 5J-17.051, Florida Statutes and implementing Rules, Florida Board Administrative Code,

SURVEYOR'S NOTES:

- 1) The above captioned Property was surveyed and described based on the above Legal Description furnished by
- 2) This Certification is only for the lands as described, it is not as certification of Title, Zoning, Easements, or Freedom of Encumbrances, ABSTRACT NOT REVIEWED.
- 3) There may be additional Restrictions not shown on this survey that may be found in the Public Records of this County, Examination of ABSTRACT OF TITLE will have to be made to determine recorded instruments, if any affecting this property.
- 4) Ownership subject to OPINION OF TITLE
- 5) Type of Survey: BOUNDARY SURVEY.
- 6) Location and identification of Utilities and or adjacent to the property were not secured as such information was
- 7) Unless otherwise noted, this Firm has not attempted to locate Footings and/or Foundations (underground).
- 8) This PLAN OF SURVEY, has been prepared for the exclusive use of the entities named hereon. The Certificate does not extend to any unnamed party.
- 9) If Bearings shown they are based on: Centerline of Sorolla Avenue being N00°00'00"E
- 10) Precision of Closure 1:7500 Suburban Class Survey
- 11) Ownership of fences are not determined
- ELEVATIONS NOTES: (IF REQUESTED AND SHOWN)
- 1) 0.0' Indicates existing Elevations
- 2) Elevations are referred to the National Geodetic Vertical Datum.
- 9.83 3) BENCHMARK (Used) B.M.No. P-4016 Elevation: Location: SW 57th Avenue & SW 15th Street

REVISIONS: 08/15/2016 Date: _ J.N.: -09/21/2018 Date: _ .IN 01/21/2021 Date: _ J.N.: Date:

THIS NOT A VALID CERTIFICATION WITHOUT THE SURVEYOR'S ORIGINAL SIGNATURE AND RAISED EMBOSSED SEAL PRESENT.

Mario Prats JR. Professional Surveyor and Mapper No. 3332 State of Florida

ABBREVIATIONS

B.M. = Bench Mark P.T. = Point of Tangency Calc. = Calculated
Meas. = Measured
C/L = Centerline
M/L = Monument Line P.O.B = Point of Begining P.C. = Point of Curvature PRC = Point of Reverse Curvature C.B.S. = Concrete-Block-Structure R/W = Right-of-Way SEC. = Section RGE. = Range N = North N = North
S = South
E = East
W = West
P.R.M. = Permanent Reference Monument
P.C.P. = Permanent Control Point
W.F. = Wood Fence
C.L.F. = Chail Link Fence
Res. = Residence
L = Acadius
D = Delta
T = Tangent
UF = Littliby Ensement TWP = Township Encr. = Encroachment F.F. = Finish Floor
A/C = Air Conditioner
Conc. = Concrete
Swk = Sidewalk STY- Story Elev. = Elevation

U.E. = Utility Easement
D.M.E. = Drainage and Maintenance Easement
I.E. & U.E. = Ingress, Egress & U.E


C.A.D. File: H:Surveys\28515 Original date: 06/26/2015 (For Lin-dates see REVISIONS)

Field date:

06/30/2015 Sheet 1 of 2

Original J.N.:

28515

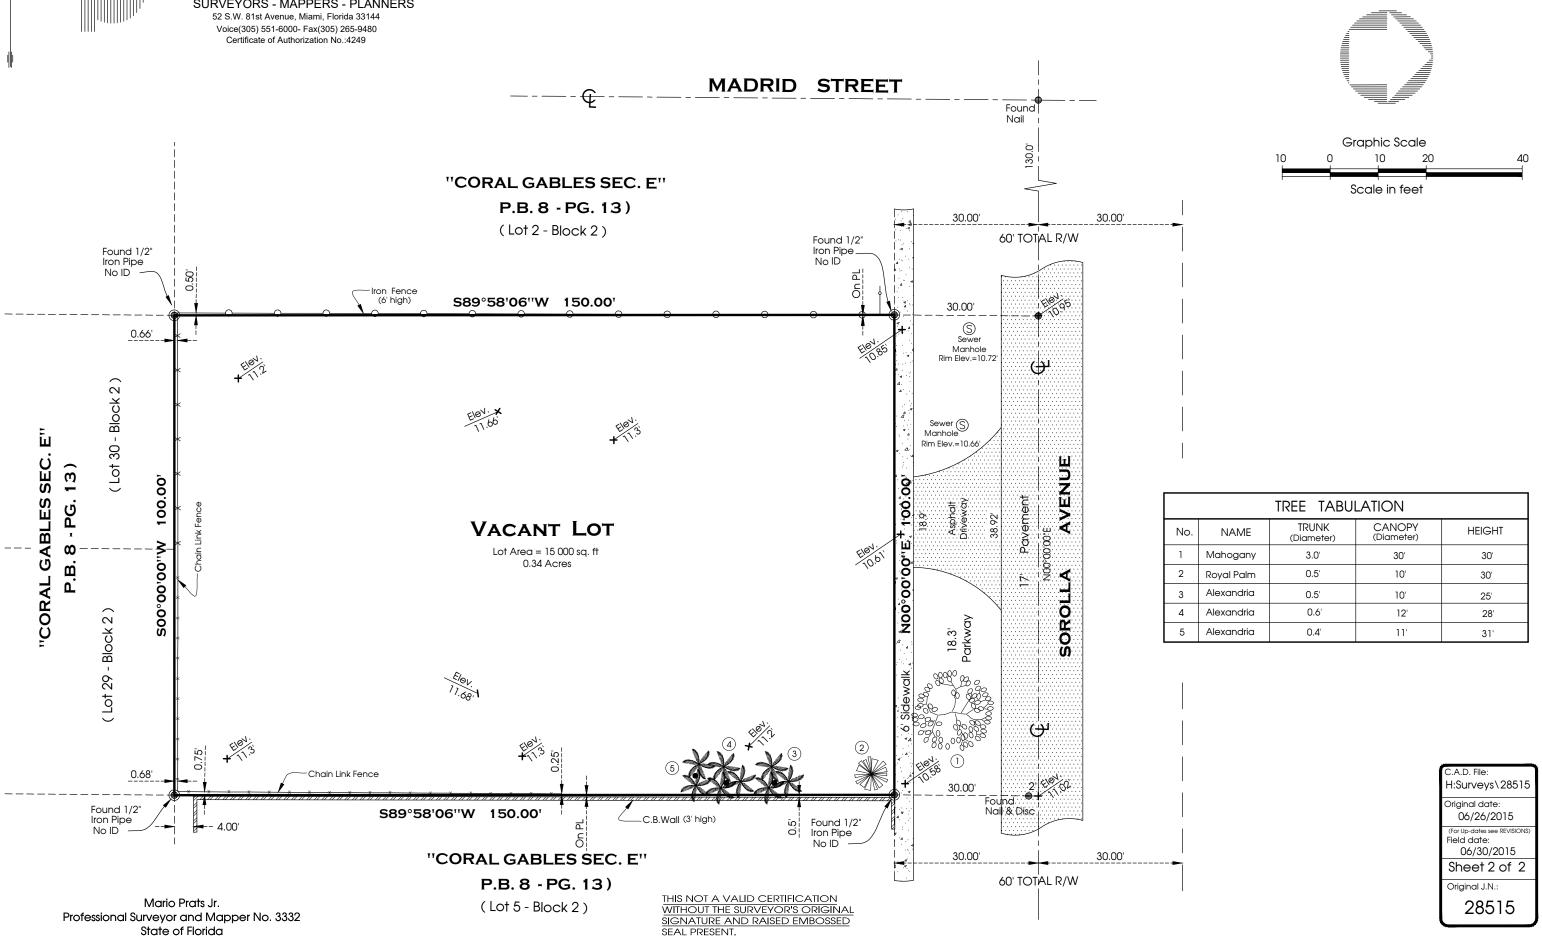

NP SOROLLA LLC. RESIDENCE

1248 SOROLLA AVE. CORAL GABLES, FL 33134

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SHEET DESCRIPTION

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L-1.01 PRELIMINARY LANDSCAPE

ARCHITECTURE

DESCRIPTION NEIGHBORHOOD ANALYSIS ZONING DATA & SITE PLAN LOT COVERAGE DIAGRAM F.A.R. CALCULATIONS A-1.Ø3 SCHEDULES & NOTES A-2.00 A-2.01 FIRST FLOOR PLAN SECOND FLOOR PLAN A-2.Ø2 ROOF PLAN A-2*.*Ø3 MATERIAL BOARD A-3.00 ELEVATIONS A-3.Ø1 ELEVATIONS A-3.02 A-3.51 ELEVATION DETAILS







-: NOTICE:
GENERAL CONTRACTOR:

FOR CONSTRUCTION, IT IS YOUR RESPONSIBILITY TO WORK TOGETHER WITH THE ARCHITECTURAL & ENGINEERING DRAWINGS. IF ANY DISCREPANCIES APPEAR, CALL THE ARCHITECTS & THE ENGINEERS OF RECORD BEFORE CONTINUING ANY WORK.

æ∧jnej∧**e** ¤Cjnej

PROPOSED NEW RESIDENCE FOR:

NP SOROLLA LLC

CLIENT

NP SOROLLA LLC

CALIL ARCHITECTS

(305) 860-9600

1248 SOROLLA AVE. CORAL GABLES, FL 33134

1728 CORAL WAY, SUITE 702 MIAMI, FL 33145 __ _

H I T E C T 5

SUITE-702 MIAMI, FLORIDA 33145
)-9600 FAX: (305) 860-9602
ARCHITECT LICENSE No. AR 0009383
W.CALILARCHITECTS.COM




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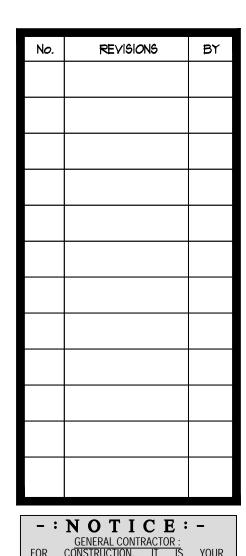
2021-017

SCALE


JOB No.

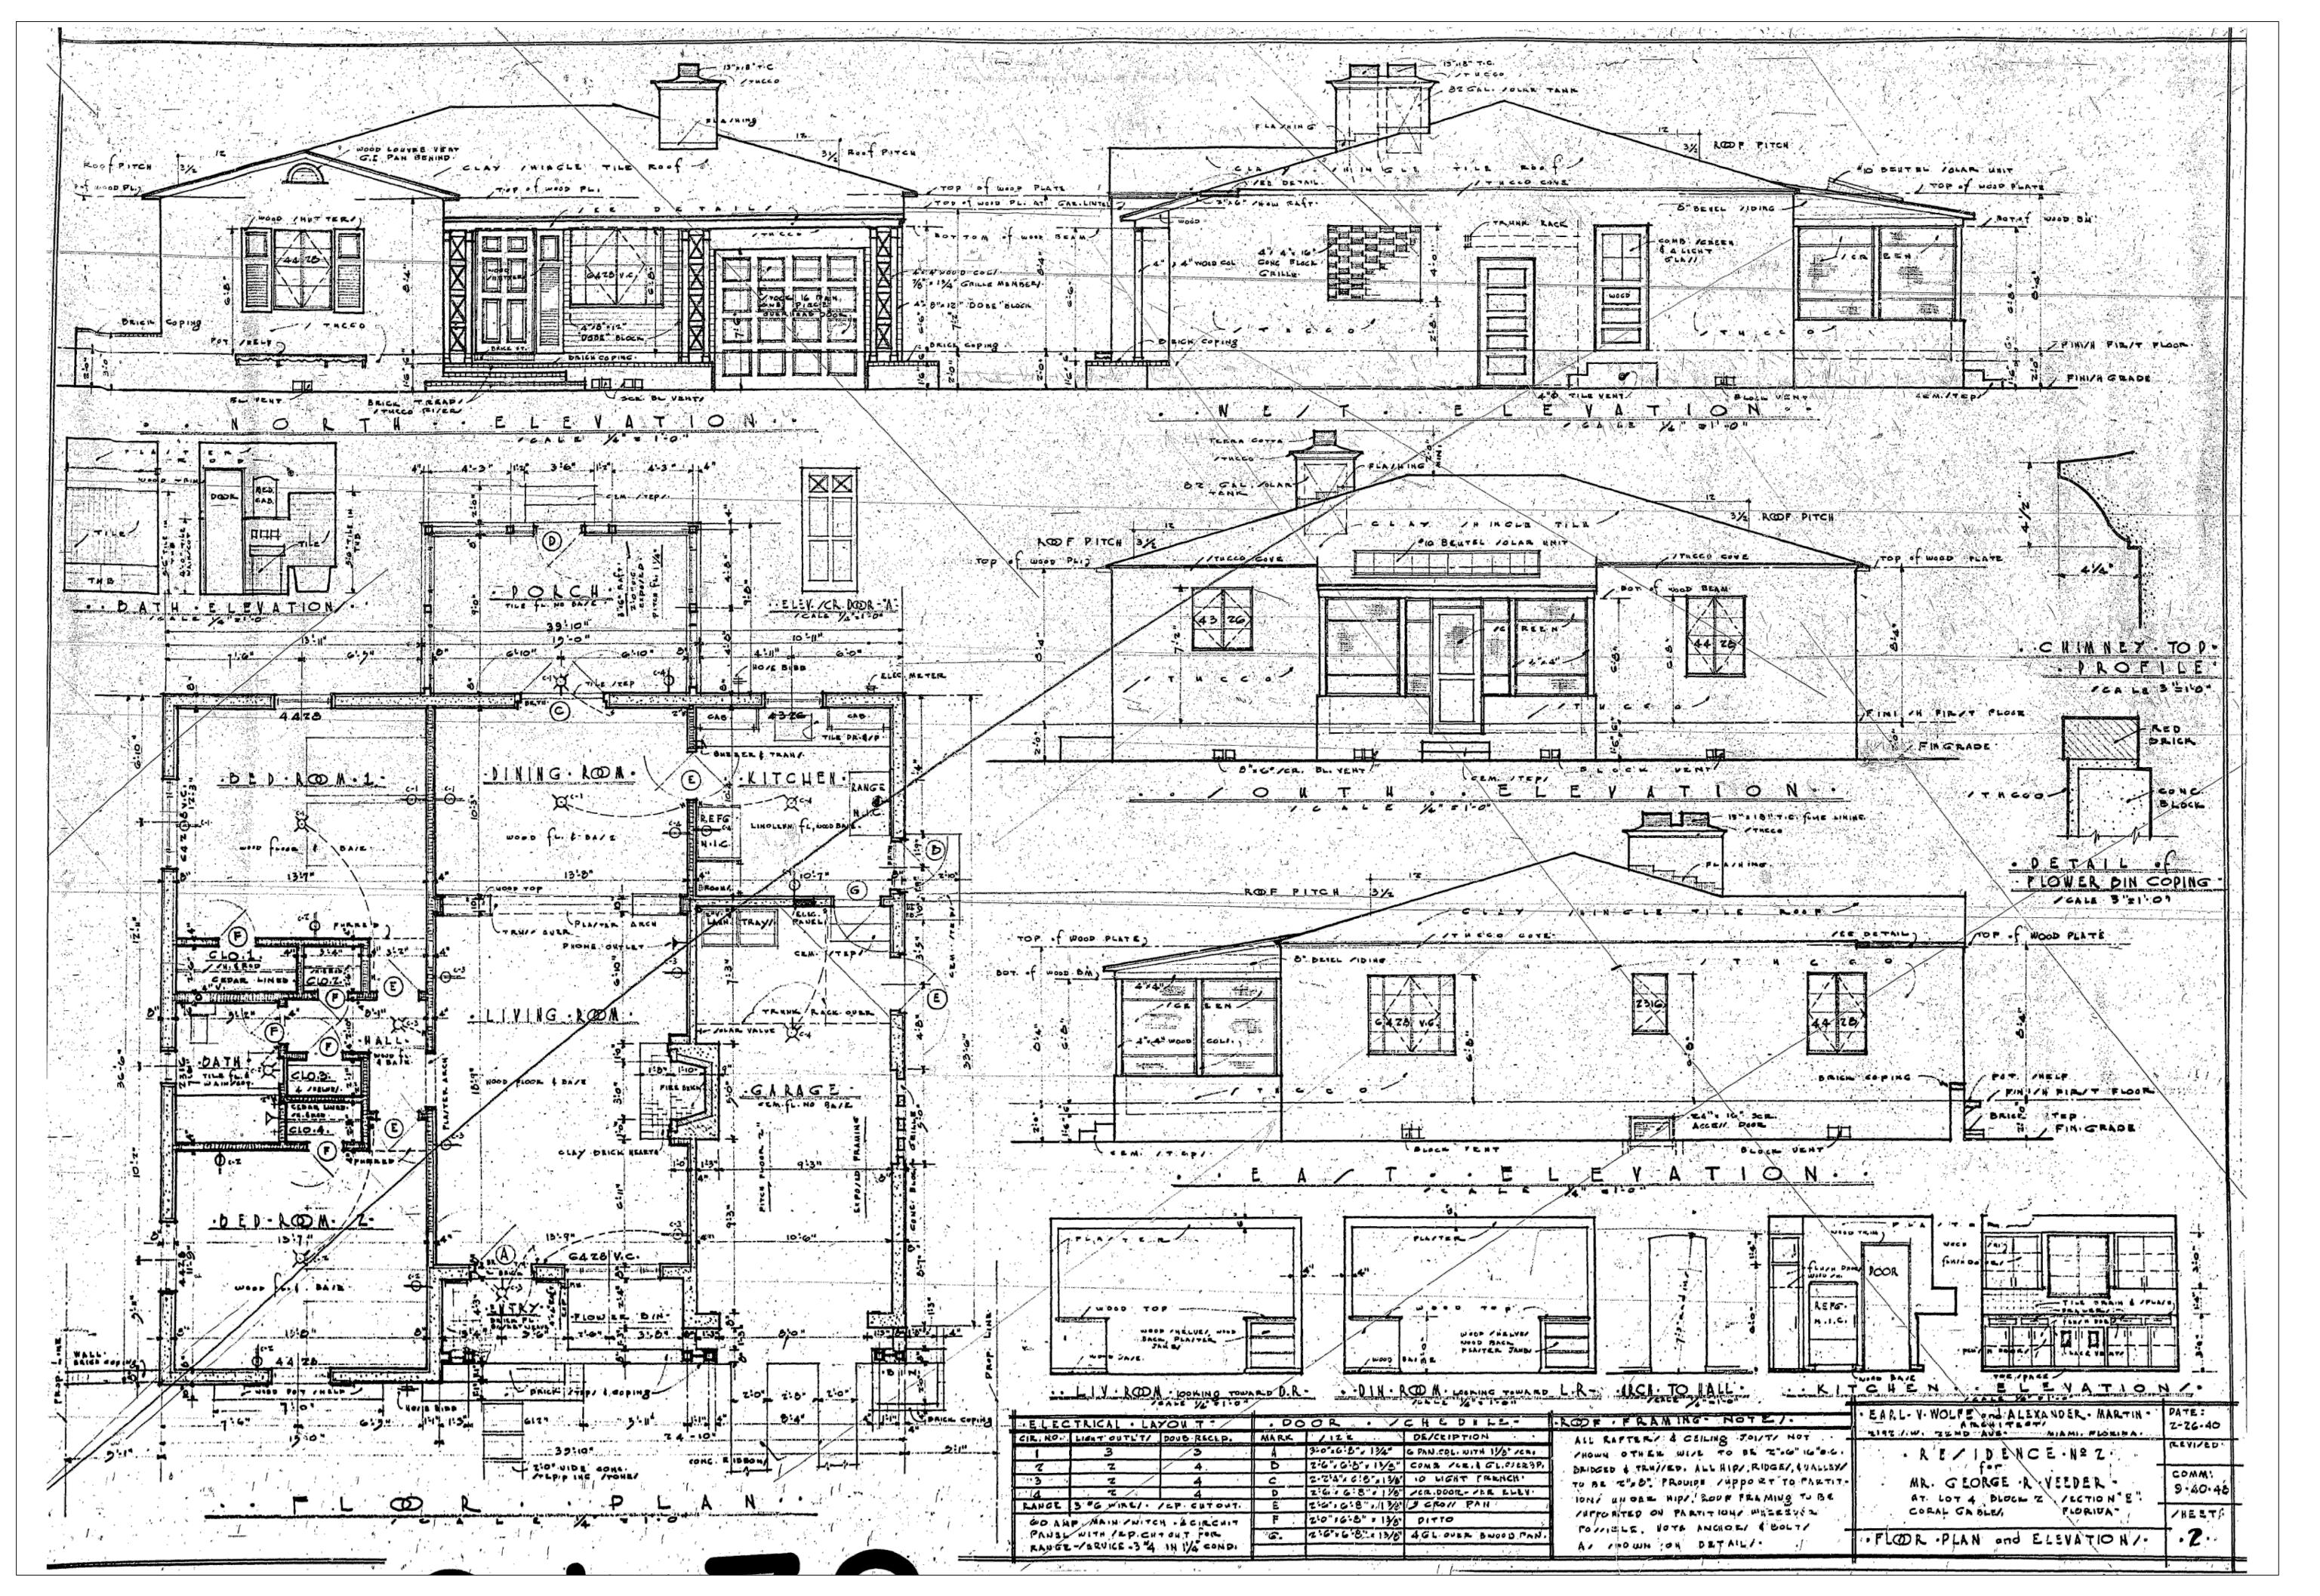

EXISTING FLOOR PLANS & ELEVATIONS



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EXA-1.01

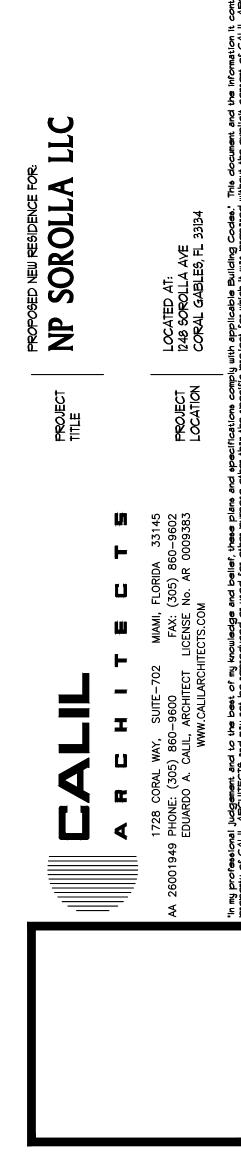E.A.C.

JULY '21

SHOWN

2021-017


DRAWN | E.A.C. JR., E.M.C.

CHECKED

SCALE

JOB No.

No.	TREE NAME			TRUNK	HEIGHT	CANOPY	TO BE	TO BE	†O
, 10.	SCIENTIFIC	COMMON	SPECIES YES/NO	(DIAM.)		(DIAM.)		RELOCATED	
\bigcirc	SWIETENIA MAHAGONI	MAHOGANY	YES	3' -Ø'	30'-0 '	30'-0 '			$> \overline{}$
2	ROYSTONEA REGIA	ROYAL PALM	YES	0'-6"	3Ø'-Ø '	10'-0"			$\overline{}$
3	ARCHONTOPHOENIX ALEXANDRAE	ALEXANDRIA	NO	0'-6"	25'- 0"	10'-0"			
4	ARCHONTOPHOENIX ALEXANDRAE	ALEXANDRIA	NO	Ø'-8 '	28'-Ø "	12'-Ø"			>
(5)	ARCHONTOPHOENIX ALEXANDRAE	ALEXANDRIA	NO	Ø'-5 '	31'- 0'	11'-Ø'			>

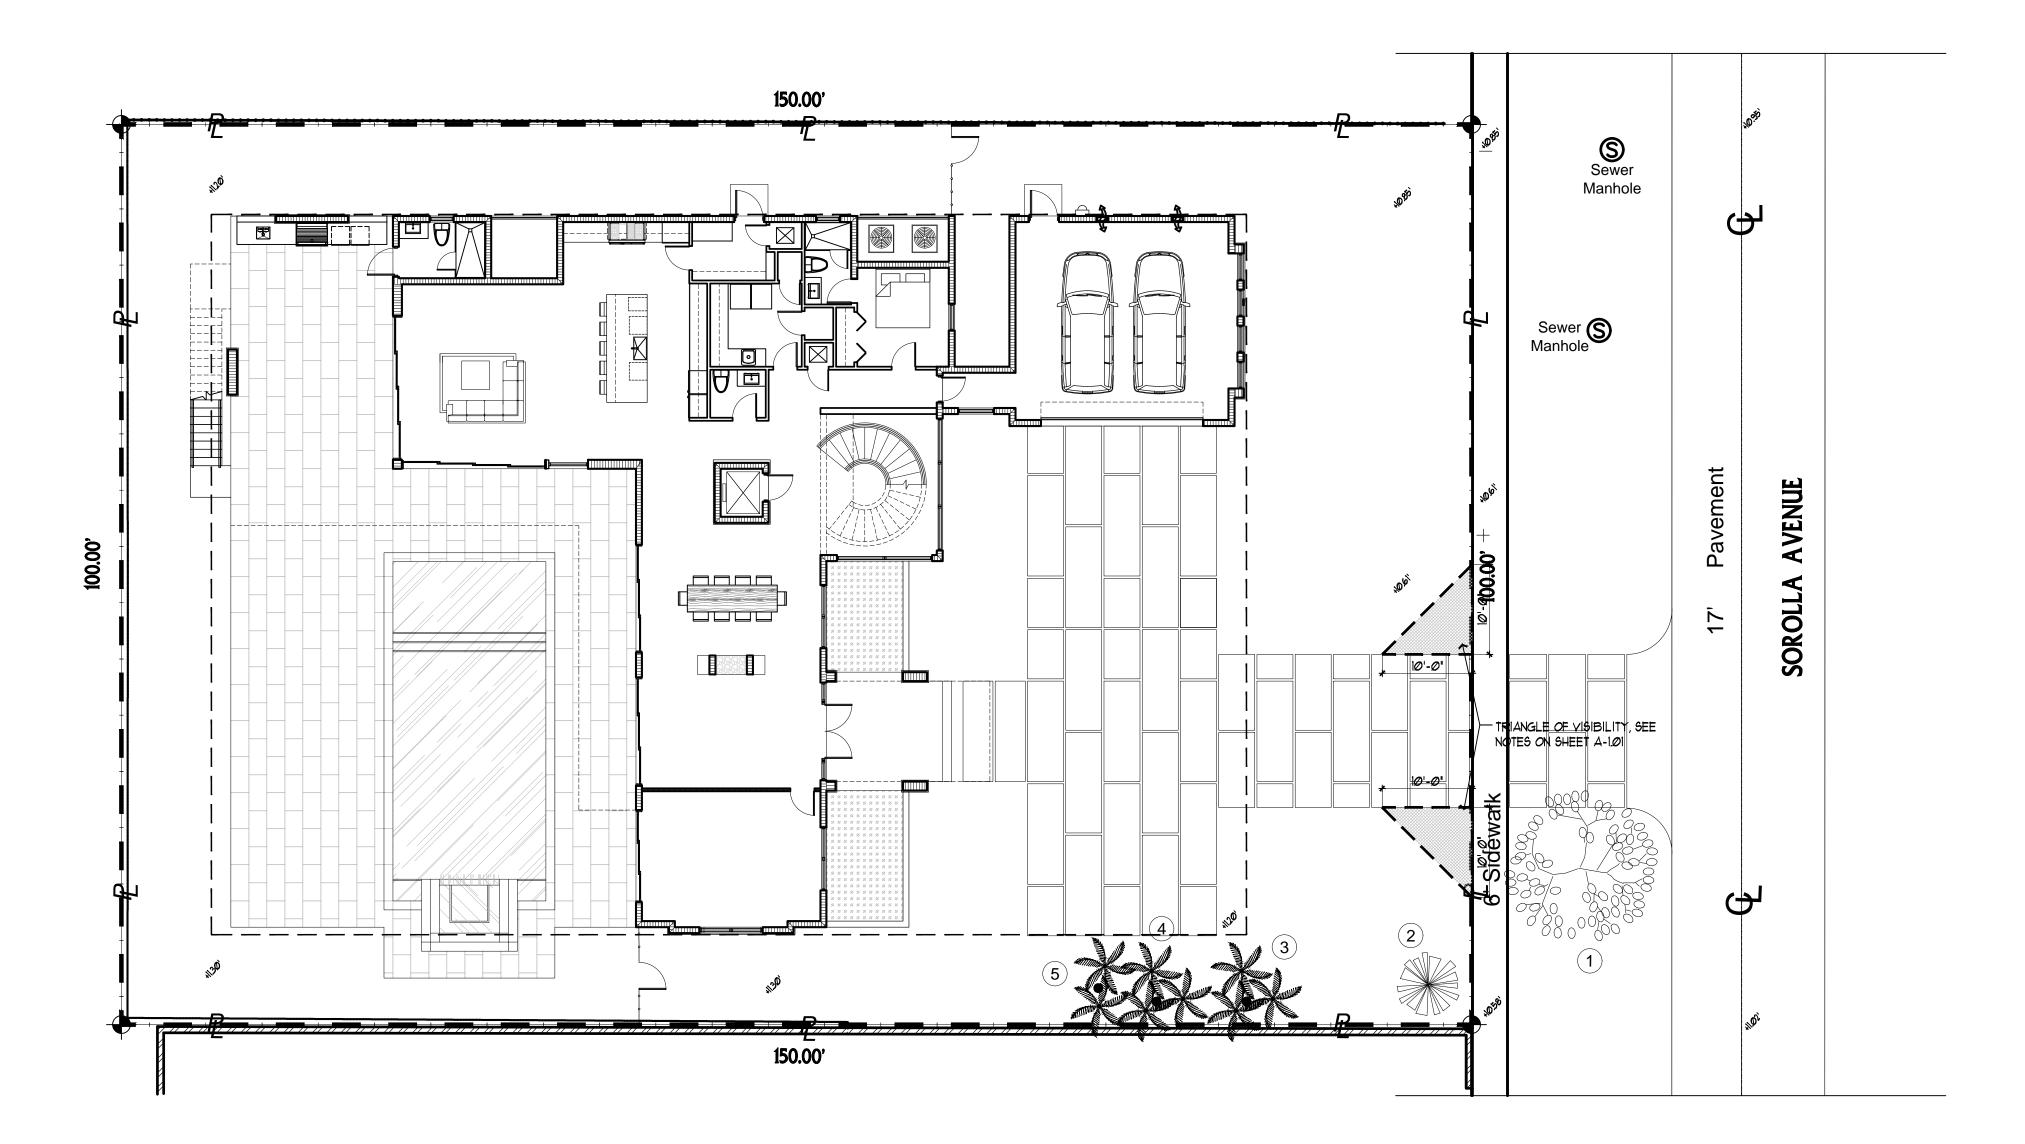

TREE DISPOSITION PLAN

SCALE: 3/32' = 1'-0'

No. REVISIONS BY

-: NOTICE:-

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NP SOROLLA LLC

SHEET No.

DRAWN
CHECKED
DATE
SCALE
JOB No.

E.A.C. JR, E.M.C.
E.A.C.
JULY '21
SHOWN
2021-017



SEE PLANTING DETAILS ON SHEET L-1.02

LANDSCAPING DATA			
ZONE DISTRICT: SFR			
NET LOT: 15,000 SQFT = 0.34 ACRES			
TREES	REQ.	EXIS.	PROV.
I LARGE SHADE TREE PER 5,000 SQFT. 15,000 / 5,000 = 3	9	9	35
2 PALMMEDIUM SHADE TREES PER 5 ρ 00 SQFT. (15 ρ 000 / 5 ρ 000) \times 2 = 6			
MAX LAWN AREA = 60%			
STREET TREES	3	1	3
100'-0" / 35' = 2.85 (3) TREES TREES IN THE RIGHT OF WAY			
SHRUB	45	Ø	116
IS SHRUBS PER 5 <i>000</i> SQFT = (IS <i>000</i> / 5 <i>000</i>) × IS = 45			

NOTE: 1) MULCH SHALL BE WEED-FREE AND SHALL BE APPLIED AND MAINTAINED IN A MINIMUM 3" LAYER UNDER AND AROUND ALL TREES AND SHRUBS, AND IN A MINIMUM 2" LAYER UNDER AND AROUND ALL GROUND COVER 2) THE USE OF MULCH SHALL BE RESTRICTED TO PLANTING 3) CYPRESS MULCH SHALL NOT BE USED BECAUSE ITS HARVEST DEGRADES CYPRESS WETLANDS.

NOTE: ALL RAINWATER MUST BE MAINTAINED WITHIN PRIVATE

LANDSCAPE GENERAL NOTES:

I. ALL PLANT MATERIAL SHALL BE GRADED FLORIDA "A" OR BETTER, AS DEFINED IN THE GRADES AND STANDARD FOR NURSERY PLANTS, PART I AND II BY THE STATE OF FLORIDA, DEPARTMENT OF AGRICULTURE.

2. ALL LANDSCAPE MATERIAL SHALL COMPLY WITH COUNTY, CITY OR LOCAL CRITERIA.

3. SYMBOLS REPRESENT PLANTS AT MATURE STAGE, NEVER AT TIME OF INSTALLATION.

4. VERIFY WITH OWNER'S REPRESENTATIVE OR SITE SUPERVISOR OF ANY EXISTING UNDERGROUND UTILITIES AND/OR EASEMENTS PRIOR TO THE INSTALLATION OF PLANT MATERIAL.

5. ALL TREES, SHRUBS AND GROUNDCOVERS SHALL RECEIVE 3' OF SHREDDED EUCALYPTUS MULCH.

6. LANDSCAPE CONTRACTOR IS RESPONSIBLE FOR THEIR OWN QUANTITY TAKE OFF. IN CASE OF DISCREPANCIES, PLAN SHALL TAKE PRECEDENCE OVER PLANT LIST.

1. SOLID BOD SHALL BE STENOPTHAPRUM SECUNDATUM var. FLORATAM.

8. THERE SHALL BE A 2' WIDE STRIP OF MULCH (3' DEPTH) BETWEEN SOD AND SHRUBS/GROUNDCOVERS.

9. AN UNDERGROUND AUTOMATIC IRRIGATION SYSTEM SHALL BE PROVIDED FOR ALL LANDSCAPE AREAS, AND A SENSOR TO SHUT THE SYSTEM OFF IN THE EVENT OF RAIN.

TREE PROTECTION NOTE:

TREE PROTECTION: 4'-0' HIGH CONTINUOUS CHAIN-LINK FENCE WITH METAL POSTS AT 8'-0' SPACING.

NOTE: EXISTING RESIDENCE, FENCES, AND DRIVEWAYS ON THIS PROPERTY SHALL BE DEMOLISHED / REMOVED UNLESS OTHERWISE NOTED ON THE PLANS. HOSE BIB TO BE PROVIDED AT EVERY 15' IN LIEU OF IRRIGATION PLAN. SEE PLUMBING PLANS FOR LOCATIONS AND DETAILS.

<u>LEGEND</u>

TREE TO BE REMOVED TREE TO BE RELOCATED

1) MULCH SHALL BE WEED-FREE AND SHALL BE APPLIED AND MAINTAINED IN A MINIMUM 3" LAYER UNDER AND AROUND ALL TREES AND SHRUBS, AND IN A MINIMUM 2" LAYER UNDER AND AROUND ALL GROUND COVER.


2) THE USE OF MULCH SHALL BE RESTRICTED TO PLANTING AREAS. 3) CYPRESS MULCH SHALL NOT BE USED BECAUSE ITS HARVEST DEGRADES CYPRESS WETLANDS.

STREET TREES TO BE PLANTED 5' MIN. FROM DRIVEWAYS, 6' (30 MPH ZONES) OR 14' (35+ MPH ZONES) MIN FROM EDGE OF ROADWAY PAVEMENT. SEPARATION BETWEEN TREES IS 25' MIN. AND 35' MAX.

LEGEND & NOTES - TRIANGLE OF VISIBILITY

TRIANGLE OF VISIBILITY

NOTES: LANDSCAPING WILL NOT BE ALLOWED TO GROW IN SUCH A MANNER AS TO IMPEDE TRIANGLE OF VISIBILITY (CONSIDERING THIS PROPERTY AND NEIGHBORS) SO AS TO MATERIALLY IMPEDE VISION BETWEEN A HEIGHT OF 2'-6' AND 8'-0')

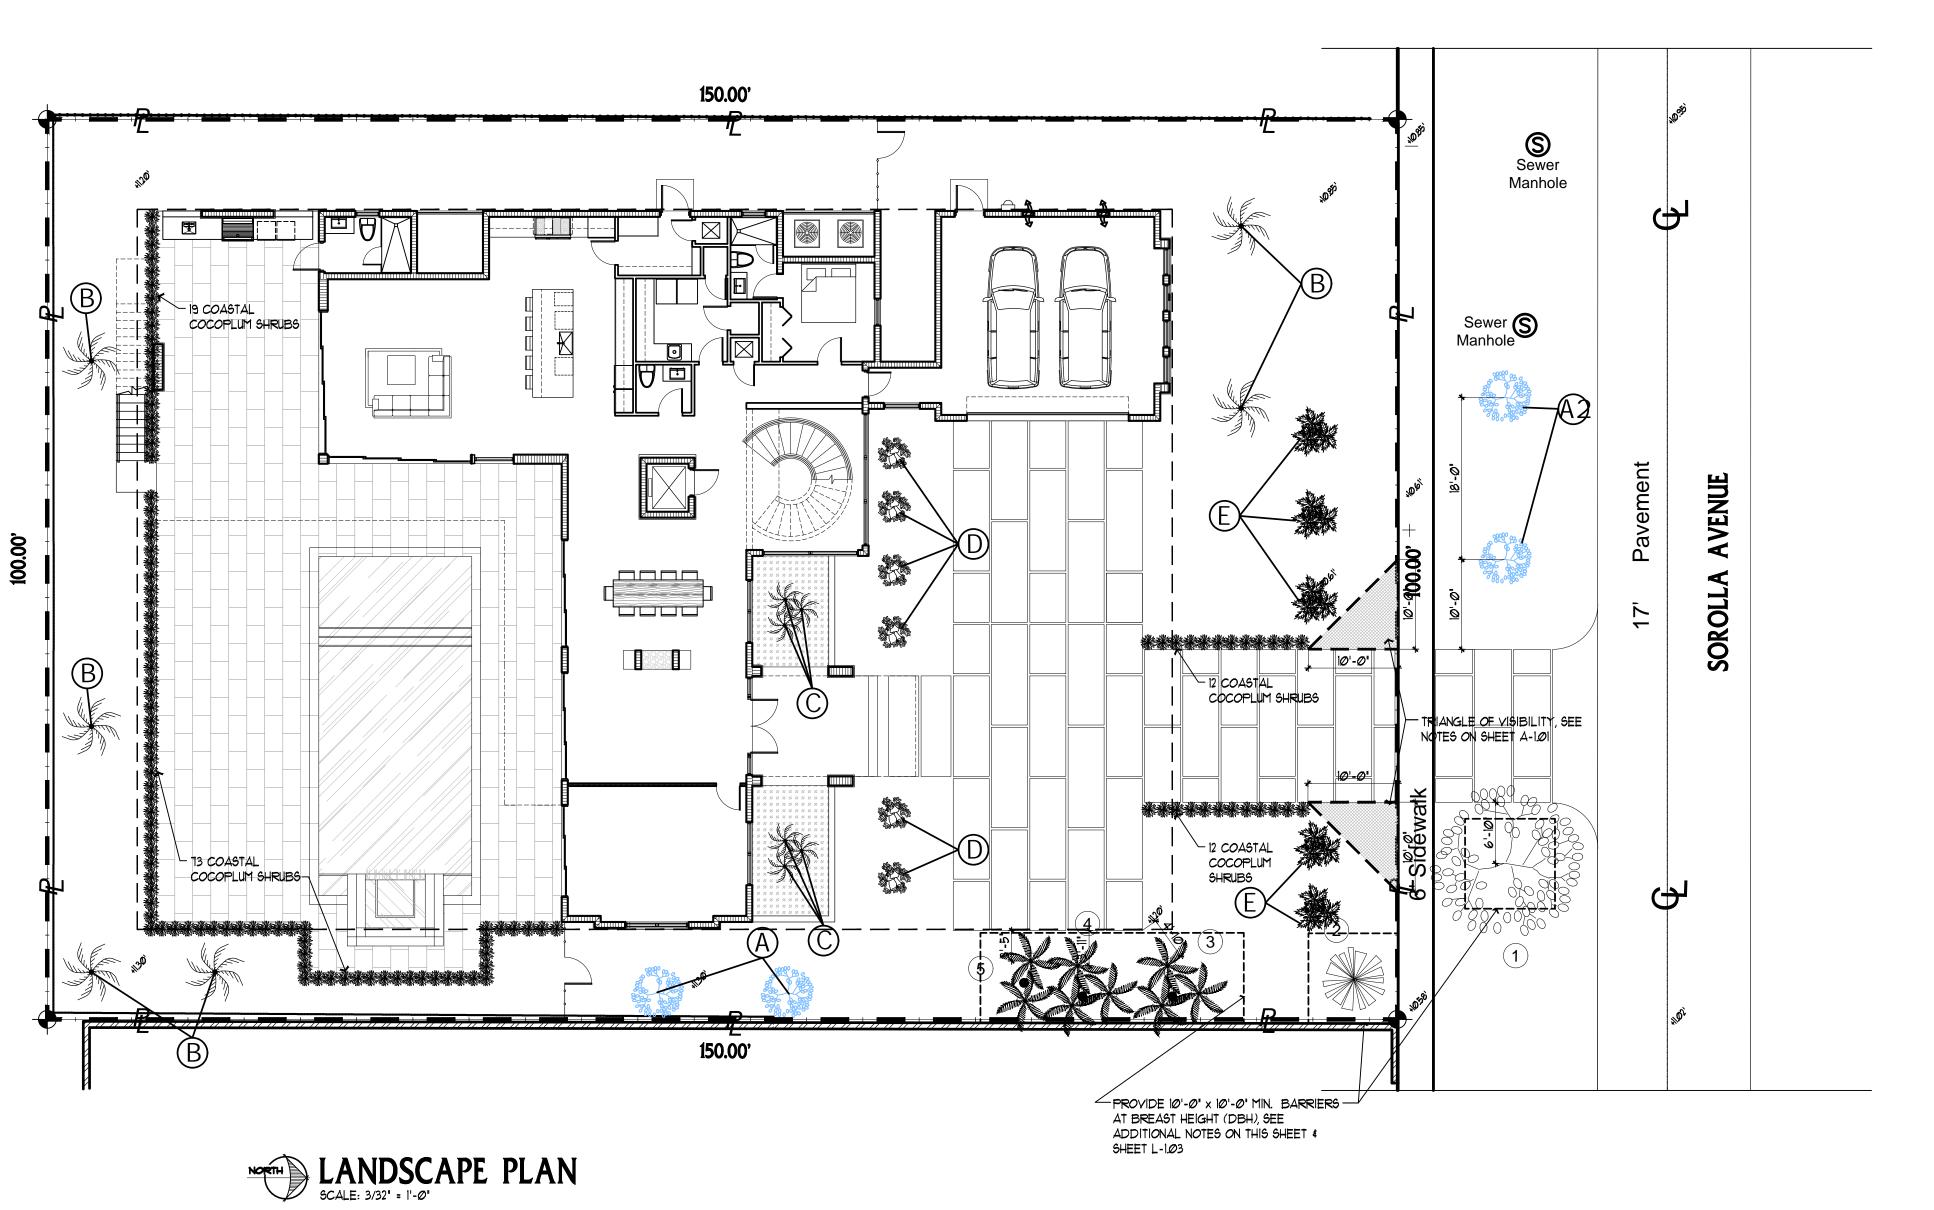

REVISIONS

-: NOTICE:
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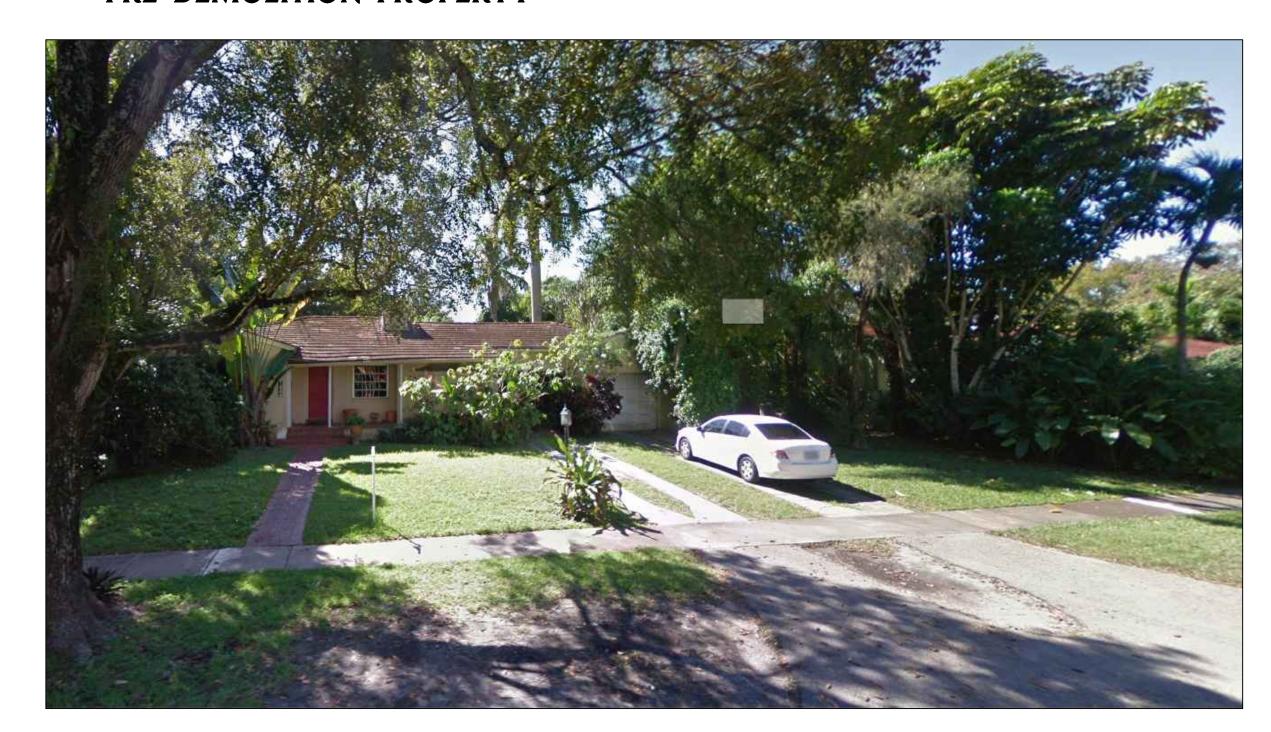
SOROLLA

DRAWN | E.A.C. JR., E.M.C. CHECKED JULY '21 SCALE SHOWN


2**0**21-**01**7

JOB No.

PRE DEMOLITION PROPERTY



EXISTING PROPERTY (POST CONSTRUCTION / PRE REVISION)

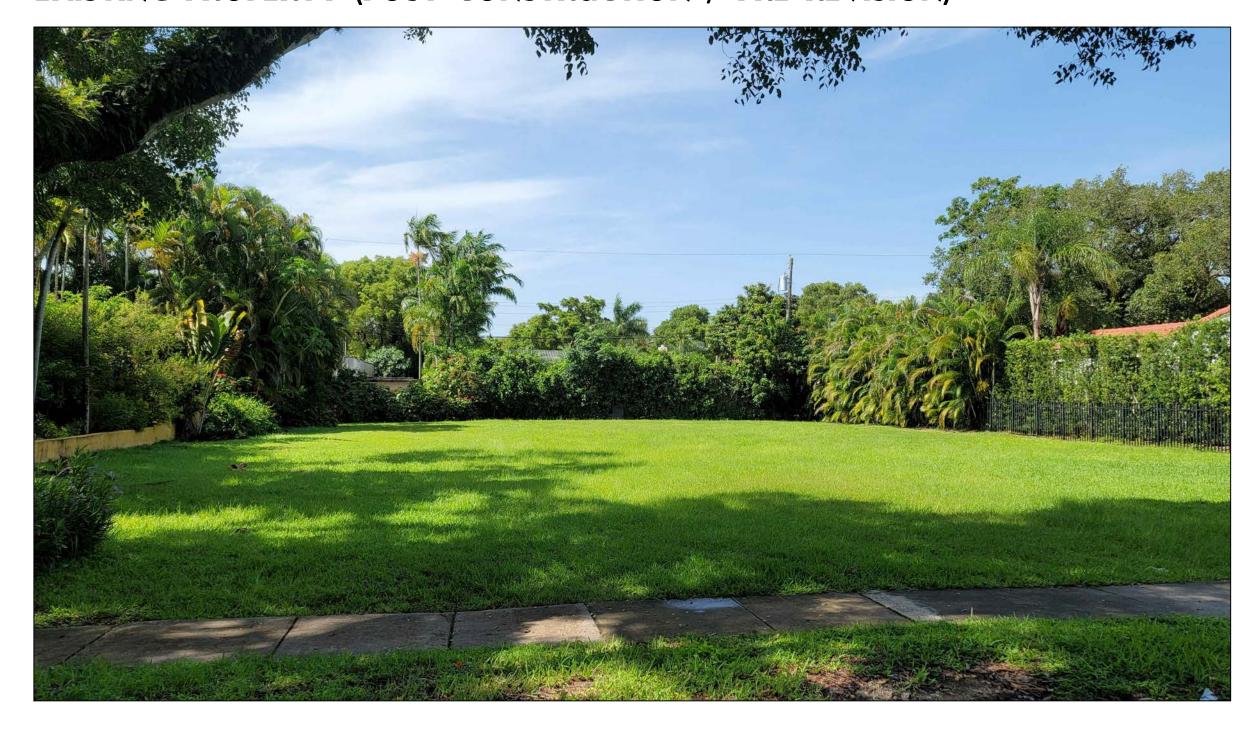

EXISTING + NEIGHBORING PROPERTIES

1248 SOROLLA AVE.

CORAL GABLES, FLORIDA 33134

NEIGHBORING PROPERTIES



1253 SOROLLA AVE.



1256 SOROLLA AVE.




1244 SOROLLA AVE.



1617 SOROLLA AVE.




538 ZAMORA AVE.

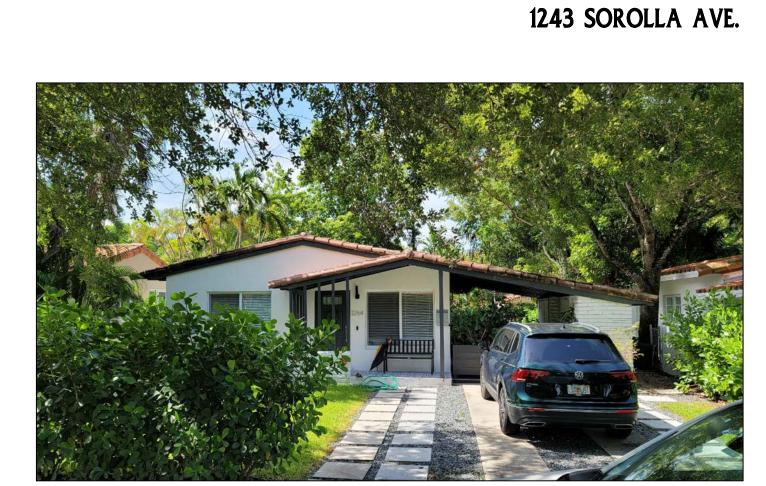

1264 MILAN AVE.



STREET VIEW

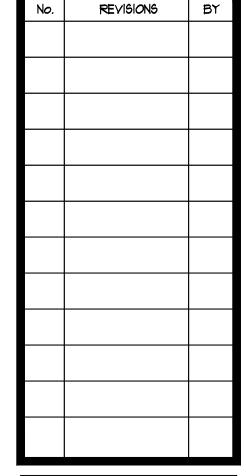


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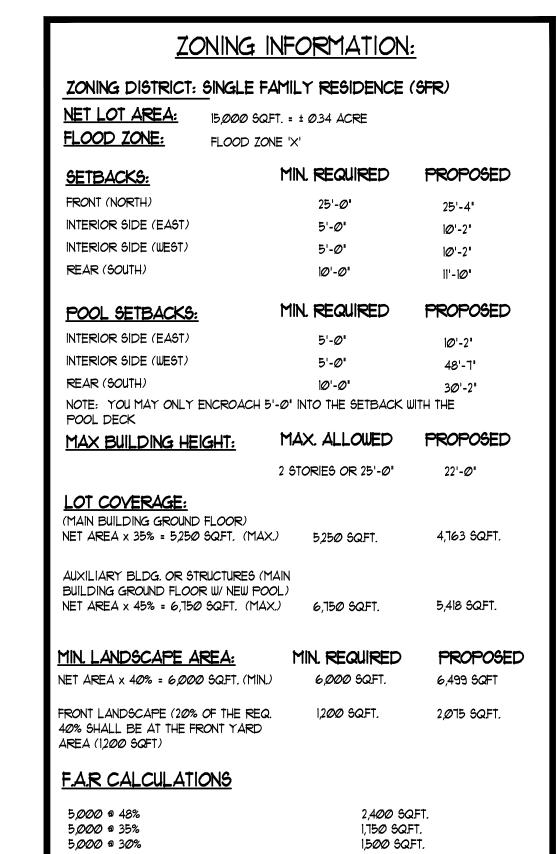




SHEET No.

A-0.01

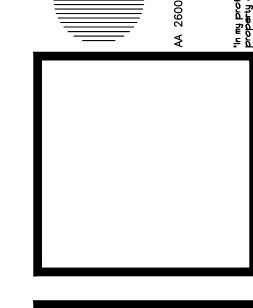DRAWN
CHECKED
DATE
SCALE
JULY '21
SCALE
JOB No.
2021-017



5,650 SQ.FT.

569 SQ.FT.

2,633 SQ.FT.

2,135 SQ.FT.

1,220 SQFT. 1,444 SQFT.

8,001 SQ.FT.

5,331 SQFT. F.A.F.

5,337 SQFT. (** FOR HRS CALCS

MAXIMUM AREA ALLOWED

FIRST FLOOR A/C AREA

TOTAL F.A.R. PROVIDED

SECOND FLOOR A/C AREA


FIRST FLOOR COVERED TERRACES SECOND FLOOR TERRACES

GROSS SQUARE FOOTAGE

GARAGE





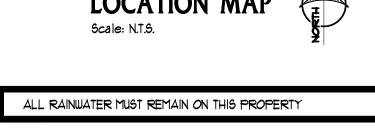

LEGEND & NOTES - TRIANGLE OF VISIBILITY	
TRIANGLE OF VISIBILITY	
NOTES: LANDSCAPING WILL NOT BE ALLOWED TO GROW IN SUCH A MANNER AS TO II TRIANGLE OF VISIBILITY (CONSIDERING THIS PROPERTY AND NEIGHBORS) S	


TO MATERIALLY IMPEDE VISION BETWEEN A HEIGHT OF 2'-6" AND 8'-0")


LEGAL DESCRIPTION

LOTS 3 & 4 , BLOCK 2, CORAL GABLES SECTION E., ACCORDING TO THE PLAT THEREOF, AS RECORDED IN PLAT BOOK 8, PAGE 13, OF THE PUBLIC RECORDS OF MIAMI-DADE COUNTY, FLORIDA.


HRS SQUARE FOOTAGES


** DOUBLE HEIGHT SPACES ARE CALCULATED ONCE FOR HRS FIRST FLOOR = 3,202 SQFT. SECOND FLOOR = 2,135 SQ.FT. TOTAL SQUARE FOOTAGE = 5,331 SQFT.

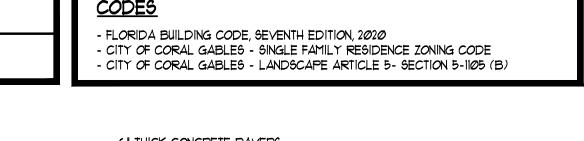

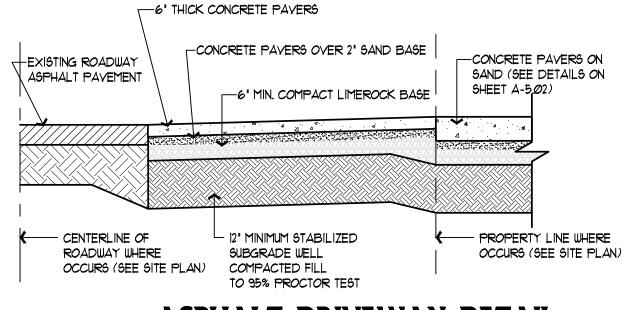



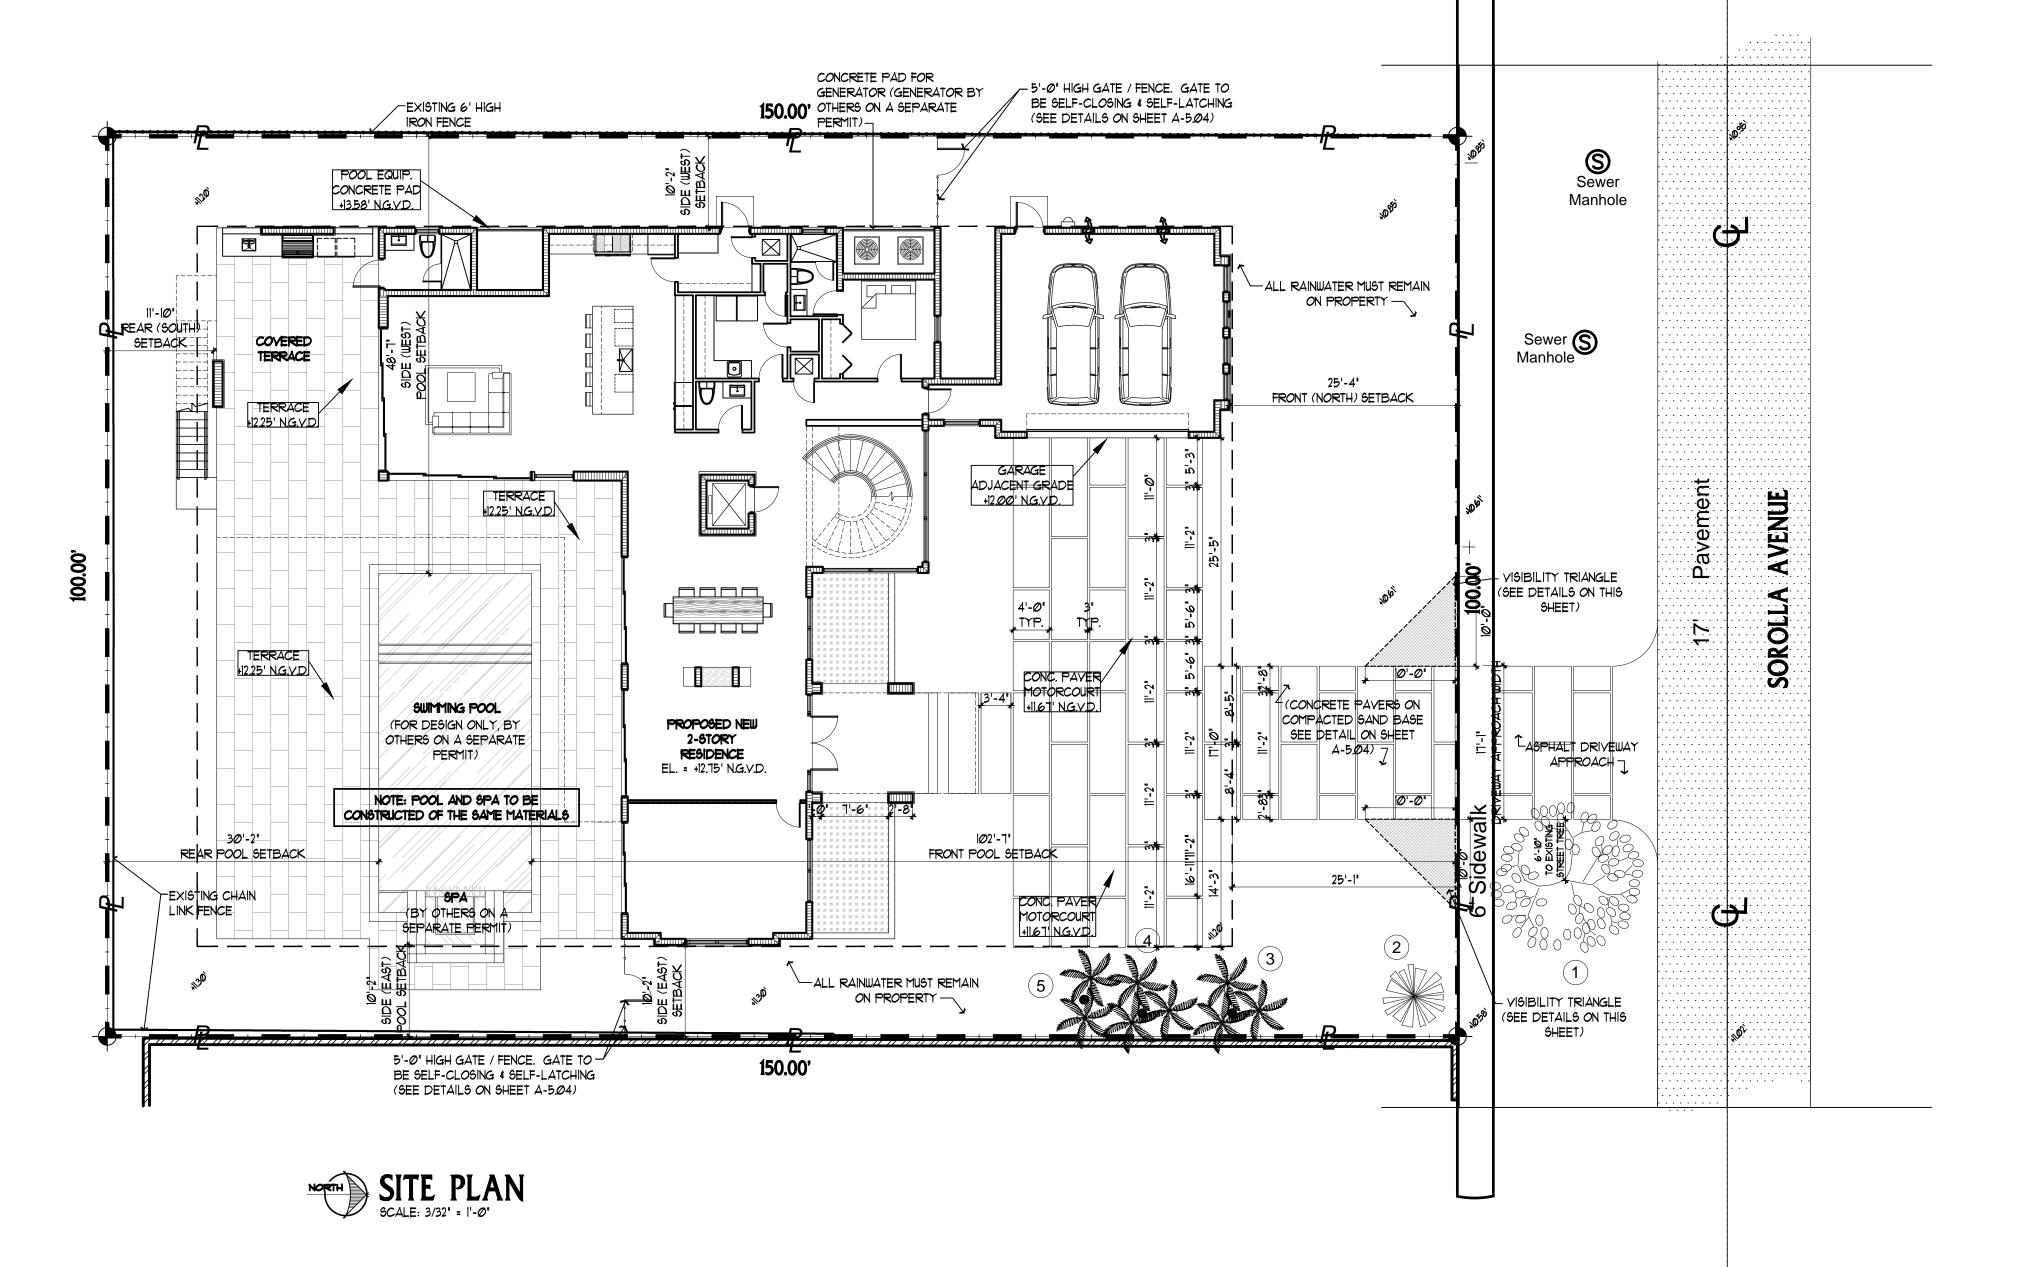


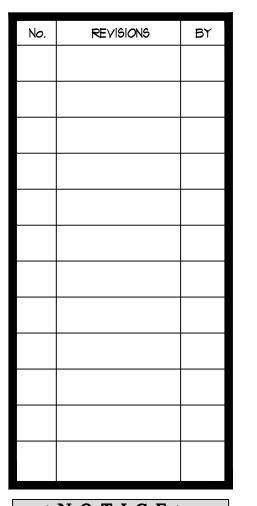


-: N O T I C E:-GENERAL CONTRACTOR : FOR CONSTRUCTION, IT IS YOUR RESPONSIBILITY TO WORK TOGETHER WITH THE ARCHITECTURAL & ENGINEERING DRAWINGS. IF ANY DISCREPANCIES APPEAR, CALL THE ARCHITECTS & THE ENGINEERS OF

SOROLLA

A-1.01 DRAWN | E.A.C. JR., E.M.C. CHECKED E.A.C. JULY '21 SCALE SHOWN JOB No. 2**0**21-**0**17

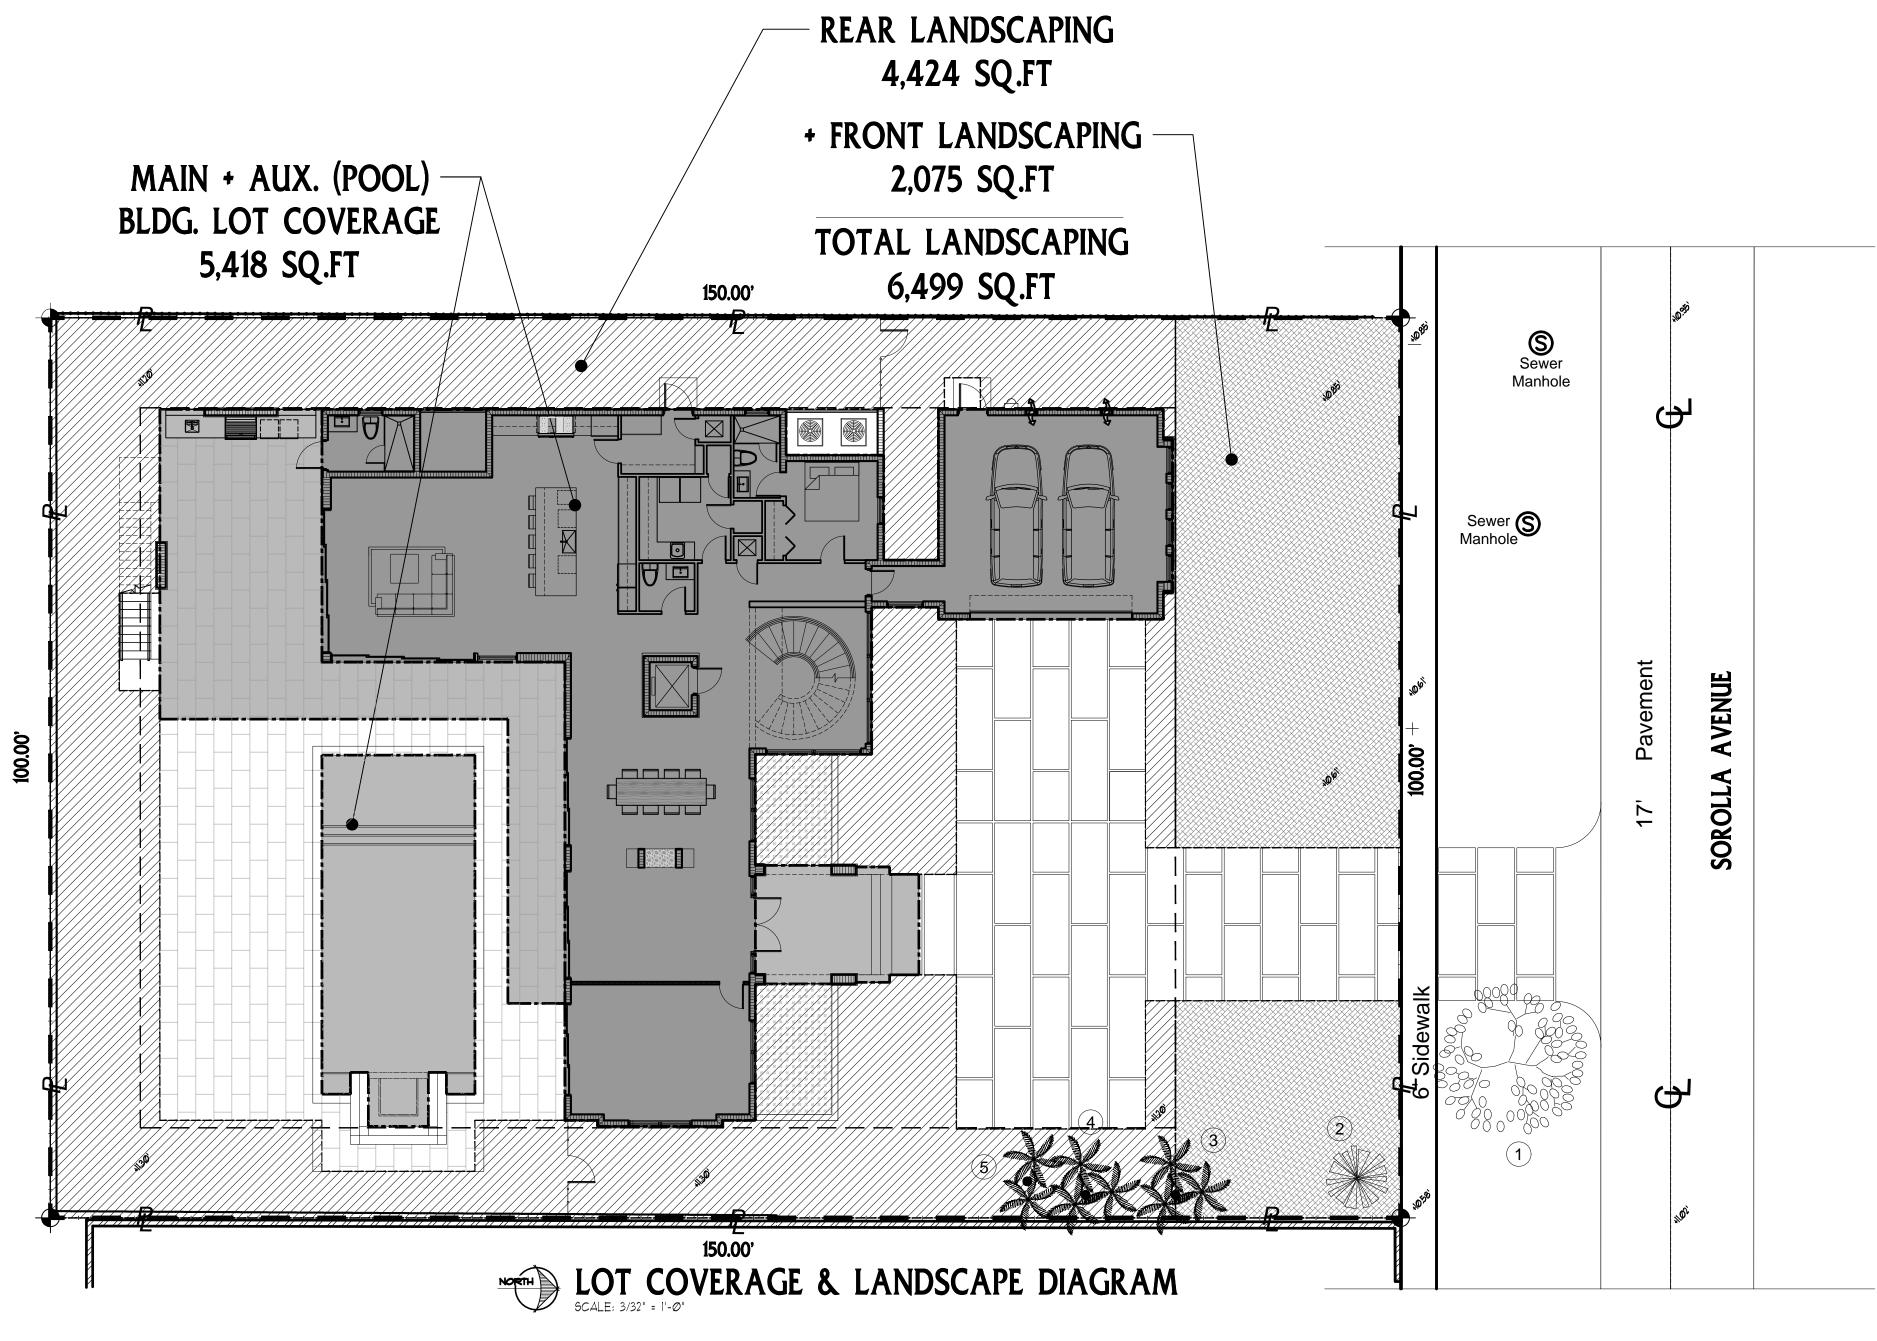


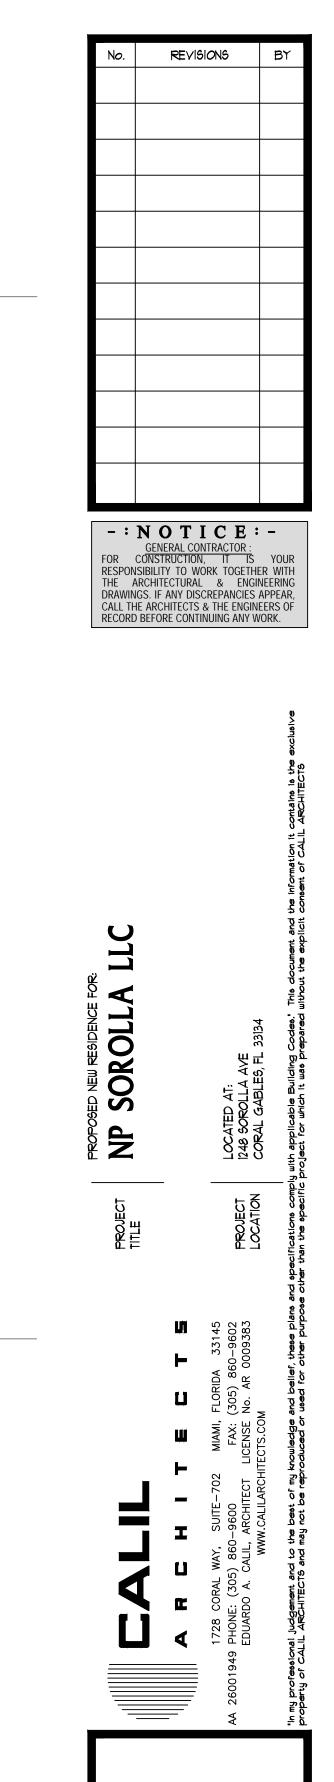


SHEET No.

A-1.02

DRAWN E.A.C. JR., EM.C.
CHECKED E.A.C.
DATE JULY '21

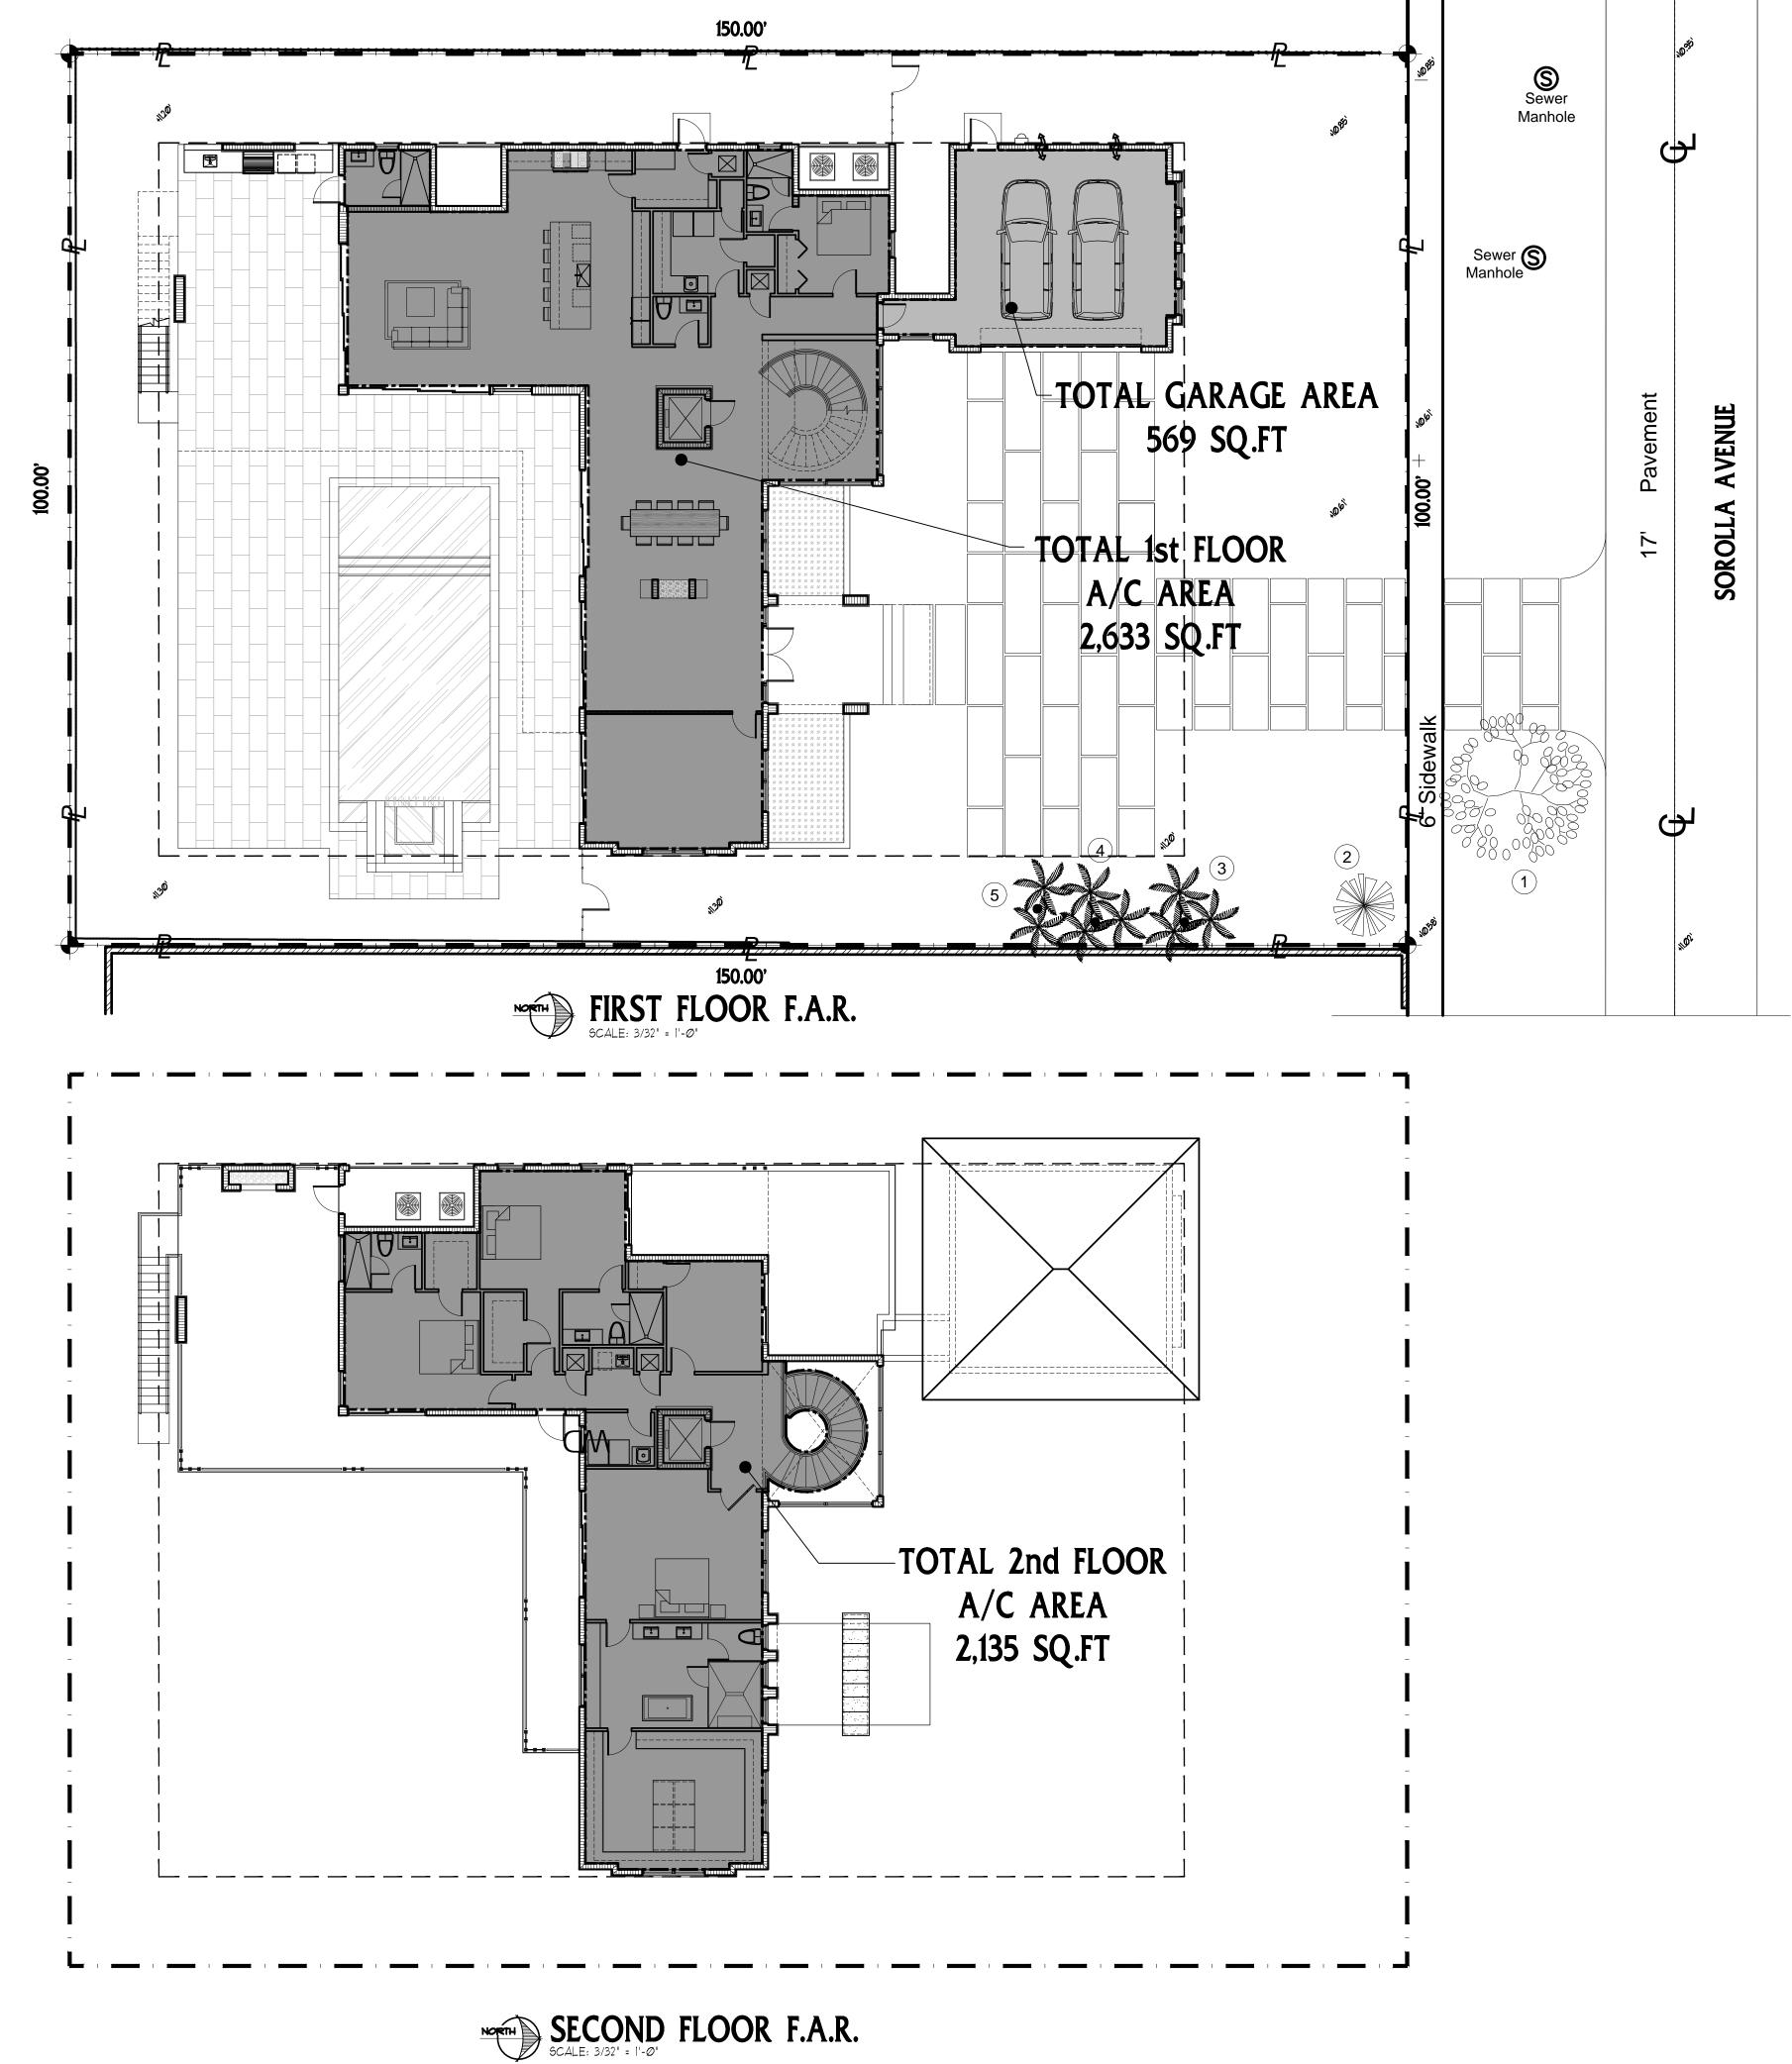

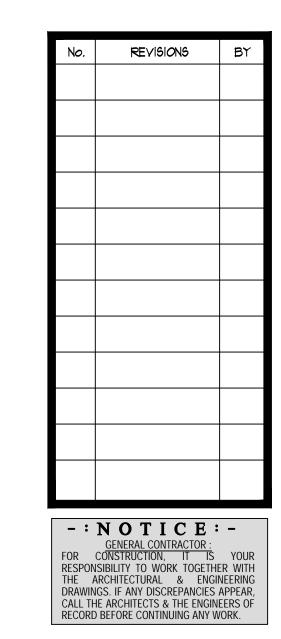

PROPOSED NEW RESIDENCE FOR NEW SOROLLA

A-1.03 DRAWN E.A.C. JR., E.M.C. CHECKED

	MADE	DECERIPTION	# OF PANELS	SIZE			MATE	DEMARKS	
	MARK	DESCRIPTION		M	Н	Т	DOOR	FRAME	REMARKS
	A	DOUBLE WOOD DOOR	2	6'-4" <i>O</i> .	10'-0"	1-3/4"	MOOD	MOOD	N- 1,5
	B	GLASS DOOR	1	3'-4" M.O.	8'-0"	1-3/4"	ALUM./ GL	ALUM.	N- 1,2,5
	©	GLASS DOOR	1	3'-4" M.O.	10'-0"	1-3/4"	ALUM./ GL	ALUM.	N- 1,2,5
	D	HORIZONTAL SLIDING DOOR	4	16'-0" M.O.	10'-0"	1-3/4"	ALUM./ GL	ALUM.	N- 1,2,5
	E	HORIZONTAL SLIDING DOOR	4	16'-O" O.	10'-0"	1-3/4"	ALUM./ GL	ALUM.	N- 1,2,5
	F	HORIZONTAL SLIDING DOOR	3	12'-0" M.O.	10'-0"	1-3/4"	ALUM./ GL	ALUM.	N- 1,2,5
	G	HORIZONTAL SLIDING DOOR	3	10'-3" M.O.	10'-0"	1-3/4"	ALUM./ GL	ALUM.	N- 1,2,5
	\oplus	HORIZONTAL SLIDING DOOR	2	8'-0" M.O.	8'-8"	1-3/4"	ALUM./ GL	ALUM.	N- 1,2,5
	\bigcirc	GLASS DOOR	1	3'-4" M.O.	8'-8"	1-3/4"	ALUM./ GL	ALUM.	N- 1,2,5
	K	HORIZONTAL SLIDING DOOR	2	8'-10" M.O.	8'-8"	1-3/4"	ALUM./ GL	ALUM.	N- 1,2,5
	Ĺ	HORIZONTAL SLIDING DOOR	3	12'-0" M.O.	8'-8"	1-3/4"	ALUM./ GL	ALUM.	N- 1,2,5
	M	METAL DOOR	1	3'-0" M.O.	8'-0"	1-3/4"	METAL	METAL	N- 1,5
	N	GARAGE DOOR	1	18'-0" M.O.	9'-6"	1-3/4"	METAL	METAL	N- 1,4
	P	SOLID WOOD DOOR	1	2'-8"	8'-0"	- ³ / ₄ "	MOOD	MOOD	N- 3
	Q	FULLY LOUVERED DOOR	1	2'-4"	8'-0"	- ³ / ₄ "	MOOD	MOOD	N- 3
	R	BI FOLD DOOR	2	5'-7"	8'-0"	- ³ / ₄ "	MOOD	MOOD	N- 3
	(5)	PIVOT DOOR	1	4'-0" M.O.	8'-0"	1- ³ ⁄4"	MOOD	MOOD	N- 3

- I. OPEN TO OUTSIDE
- 3. HANDICÂP ACCESS AND HARDWARE 4. OVERHEAD DOOR SUBMIT D.C. P.C. APPROVAL
- 5. LARGE MISSILE IMPACT RESISTANT 6. FROSTED
- * GENERAL CONTRACTOR/ BUILDER TO PROVIDE SHOP U-FACTOR SHGC NOTES: DRAWINGS PRIOR TO FABRICATION FOR ARCHITECTS APPROVAL
- ALL WINDOW AND DOOR FRAMES TO BE BRONZE ANODIZED ALUMINUM FRAME. ALL GLASS TO BE GREY TINTED LOW-E.

SAFETY NOTES FOR DOORS

(CLOSETS AND BATHROOMS) NFPA IOI - 2020 CHAPTER-24 2. GLASS $\frac{1}{2}$ " THICK SAFETY GLASS CATEGORY CLASS II (24-2,4,3) EVERY CLOSET DOOR LATCH SHALL BE SUCH THAT CHILDREN CAN OPEN THE DOOR FROM INSIDE THE CLOSET (24-2,4) EVERY BATHROOM DOOR LOCK SHALL BE DESIGNED TO PERMIT THE OPENING OF THE LOCKED DOOR FROM THE OUTSIDE IN AN EMERGENCY.

ALL WINDOWS TO HAVE THE FOLLOWING VALUES:

U-FACTOR = 1.00 SHGC (SOLAR HEAT GAIN COEFFICIENT) = 0.36 ALL FIXED AND CUSTOM WINDOWS TO HAVE SAME FRAME AS CASEMENT WINDOWS.

WINDOW	SCHEDULE
--------	----------

MARK	DECORPTION	# 0F	SI	ZE	MATERIAL	GLASS	TYPE	EGR TY		DEMARKS
	DESCRIPTION	PANELS	X	#	YKILKIKL	IMPACT RESISTAT	TEMPERED	Y	N	REMARKS
	FIXED	2	7'-0" M.O.	9'-4"	ALUM./GLASS	•	•		•	N-2,4
2	FIXED		2'-l" <i>O</i> .	10'-0"	ALUM./GLASS	•	•		•	N-2,4
(3)	FIXED	2	10'-7" M.O.	9'-4"	ALUM./GLASS	•	•		•	N-2,4
4	FIXED	3	14'-8" M.O.	9'-4"	ALUM./GLASS	•	•		•	N-2,4
5	FIXED		4'-0" M.O.	7'-0"	ALUM./GLASS	•	•		•	N-2,4
6	FIXED		3'-0" M.O.	9'-4"	ALUM./GLASS	•	•		•	N-2,4
7	CASEMENT		3'-0" M.O.	7'-0"	ALUM./GLASS	•	•	•		N-2,3
8	FIXED		2'-8" M.O.	4'-0"	ALUM./GLASS	•	•		•	N-2,4
9	FIXED		4'-4" 0.	10'-0"	ALUM./GLASS	•	•		•	N-2,4
(10)	FIXED	2	7'-0" M.O.	5'-4"	ALUM./GLASS	•	•		•	N-2,4
(1)	FIXED		2'-10" M.O.	5'-4"	ALUM./GLASS	•	•		•	N-2,4
(12)	FIXED	2	10'-7" M.O.	8'-10"	ALUM./GLASS	•	•		•	N-2,4
(13)	FIXED	3	14'-8" M.O.	8'-10"	ALUM./GLASS	•	•		•	N-2,4
(14)	CASEMENT		3'-0" M.O.	5'-4"	ALUM./GLASS	•	•	•		N-2,3
(15)	FIXED		5'-2" M.O.	2'-6"	ALUM./GLASS	•	•		•	N-2,4
(16)	FIXED		4'-0" M.O.	8'-8"	ALUM./GLASS	•	•		•	N-2,4
	FIXED		3'-0" M.O.	2'-6"	ALUM./GLASS	•	•		•	N-2,4

U-FACTOR SHGC NOTES:

U-FACTOR = 1.00

CASEMENT WINDOWS.

ALL WINDOWS TO HAVE THE FOLLOWING VALUES:

SHGC (SOLAR HEAT GAIN COEFFICIENT) = 0.36

ALL FIXED AND CUSTOM WINDOWS TO HAVE SAME FRAME AS

- ALL GLASS SHALL BE TINTED 2. LARGE MISSILE IMPACT RESISTANT
- 3. CS (CASEMENT) 4. FIXED
- GENERAL CONTRACTOR/ BUILDER TO PROVIDE SHOP DRAWINGS PRIOR TO FABRICATION FOR ARCHITECTS APPROVAL
- ALL WINDOW AND DOOR FRAMES TO BE BRONZE ANODIZED ALUMINUM FRAME. ALL GLASS TO BE GREY TINTED LOW-E.

ROOM FINISH SCHEDULE

ROOM	FLOOR	WALLS	CEILING - HEIGHT	BASE	REMARKS
COVERED ENTRY	PORCELAIN TILE	N/A	SMOOTH STUCCO	N/A	N-1
GREAT ROOM	PORCELAIN TILE	DRYWALL	DRYWALL	WOOD	N-2
GYM	PORCELAIN TILE	DRYWALL	DRYWALL	MOOD	N-1, 2
DINING AREA	PORCELAIN TILE	DRYWALL	DRYWALL	WOOD	N-2
POWDER BATH	PORCELAIN TILE	DRYWALL	DRYWALL	WOOD	N-2
LAUNDRY 1 & 2	PORCELAIN TILE	DRYWALL	DRYWALL	WOOD	N-2
MAID'S BEDROOM	PORCELAIN TILE	DRYWALL	DRYWALL	WOOD	N-2
MAID'S BATHROOM	PORCELAIN TILE	DRYWALL	DRYWALL	WOOD	N-2
KITCHEN	PORCELAIN TILE	DRYWALL	DRYWALL	WOOD	N-2
PANTRY	PORCELAIN TILE	DRYWALL	DRYWALL	WOOD	N-2
FAMILY ROOM	PORCELAIN TILE	DRYWALL	DRYWALL	WOOD	N-2
MASTER BEDROOM	PORCELAIN TILE	DRYWALL	DRYWALL	WOOD	N-2
MASTER BATHROOM	PORCELAIN TILE	DRYWALL	DRYWALL	WOOD	N-2
MASTER W.I.C.	PORCELAIN TILE	DRYWALL	DRYWALL	WOOD	N-2
BEDROOM 2 4 3	PORCELAIN TILE	DRYWALL	DRYWALL	WOOD	N-2
BATHROOM 2 & 3	PORCELAIN TILE	DRYWALL	DRYWALL	WOOD	N-2
W.I.C. 2 \$ 3	PORCELAIN TILE	DRYWALL	DRYWALL	WOOD	N-2
OFFICE	PORCELAIN TILE	DRYWALL	DRYWALL	WOOD	N-2
CABANA BATH	PORCELAIN TILE	DRYWALL	DRYWALL	WOOD	N-2
COVERED TERRACE	PORCELAIN TILE	DRYWALL	SMOOTH STUCCO	N/A	N-1
COVERED BALCONY	PORCELAIN TILE	DRYWALL	SMOOTH STUCCO	N/A	N-1
GARAGE	CONCRETE	GREEN BOARD	DRYWALL	N/A	N-3

- I. USE NON-SLIP TILE
- 2. USE IMPERVIOUS MATERIAL 3. BROOM FINISH CONCRETE FLOOR

ALL FIXED AND CUSTOM WINDOWS TO HAVE SAME FRAME AS CASEMENT

SHOWER GLASS NOTE: INSULATION MATERIAL NOTE

INSULATION MATERIALS TO MEET THE FLAMESPREAD AND SMOKE DEVELOPED CRITERIA AS SET FORTH IN F.B.C. 2020 R302.10

R302.10.1 - FLAME SPREAD INDEX - FLOOR-CEILING ASSEMBLIES, ROOF-CEILING ASSEMBLIES, WALL ASSEMBLIES, CRAWL SPACES AND ATTICS SHALL HAVE A FLAME SPREAD INDEX NOT TO EXCEED 225 WITH AN ACCOMPANYING SMOKE DEVELOPED INDEX NOT TO EXCEED 450 WHERE TESTED IN ACCORDANCE WITH ASTM E84 OR UL 723.

FINISH MATERIAL NOTE

FINISH MATERIALS TO MEET THE FLAMESPREAD AND SMOKE DEVELOPED REQUIREMENTS AS SET FORTH IN F.B.C. 2020 R302.9.1 & R302.9.2 F.B.C. 2020 R302.9.1 - FLAME SPREAD INDEX - WALL AND CEILING FINISHES SHALL HAVE A FLAME SPREAD INDEX OF NOT GREATER THAN 200 F.B.C. 2020 R302.9.2 - SMOKE-DEVELOPED INDEX - WALL AND CEILING FINISHES SHALL HAVE A SMOKE-DEVELOPED INDEX OF NOT GREATER THAN 450

PRE FAB WOOD TRUSSES @ 24" O.C. - BY OTHERS (SUBMIT SHOP DRAWINGS FOR APPROVAL IN SEPARATED PERMIT)

<u>LEGEND</u>

NEW 8" CMU WALL

NEW PARTITION WALL (4" TYP. UNLESS OTHERWISE NOTED)


STEEL COLUMN

GENERAL CONTRACTOR/BUILDER TO VERIFY ALL EGRESS AND NON-EGRESS WINDOWS AND OPENINGS PRIOR TO WINDOW FABRICATION. EGRESS WINDOW NEED TO MEET NFPA


PROVIDE 3" SAFETY GLASS CATEGORY CLASS II ON SHOWER GLASS AND 24" WIDE DOOR \$ 22" MIN CLEARANCE

UNVENTED ATTIC ASSEMBLIES SHALL COMPLY WITH THE FOLLOWING PER R806.5: - MUST BE COMPLETELY CONTAINED WITHIN BUILDING

THERE SHALL BE NO INTERIOR VAPOR RETARDER INSTALLED ON CEILING SIDE INSULATION SHALL BE AIR PERMEABLE AND COMPLY WITH R806.5 ITEM 5.1.1.

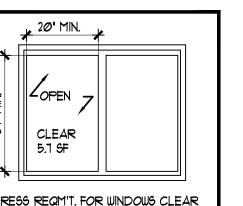


EGRESS REQM'T. FOR WINDOWS CLEAR OPENING: 20" MIN. HORIZ. DIMENSION 24 MIN. VERT. DIMENSION AND 5.7 SF. CLEAR 42 A.F.F. TO BOTTOM OF WINDOW OPENING

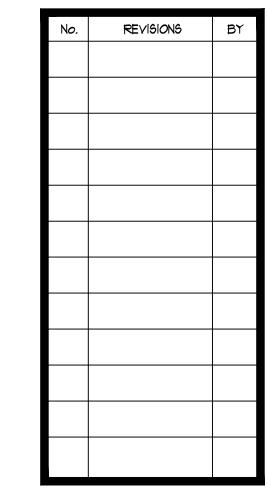



-: N O T I C E:-GENERAL CONTRACTOR : FOR CONSTRUCTION, IT IS YOUR RESPONSIBILITY TO WORK TOGETHER WITH THE ARCHITECTURAL & ENGINEERING DRAWINGS. IF ANY DISCREPANCIES APPEAR, CALL THE ARCHITECTS & THE ENGINEERS OF RECORD BEFORE CONTINUING ANY WORK.

SOROLLA

DRAWN E.A.C. JR., E.M.C. CHECKED E.A.C. JULY '21 SCALE SHOWN JOB No. 2**0**21-**017**

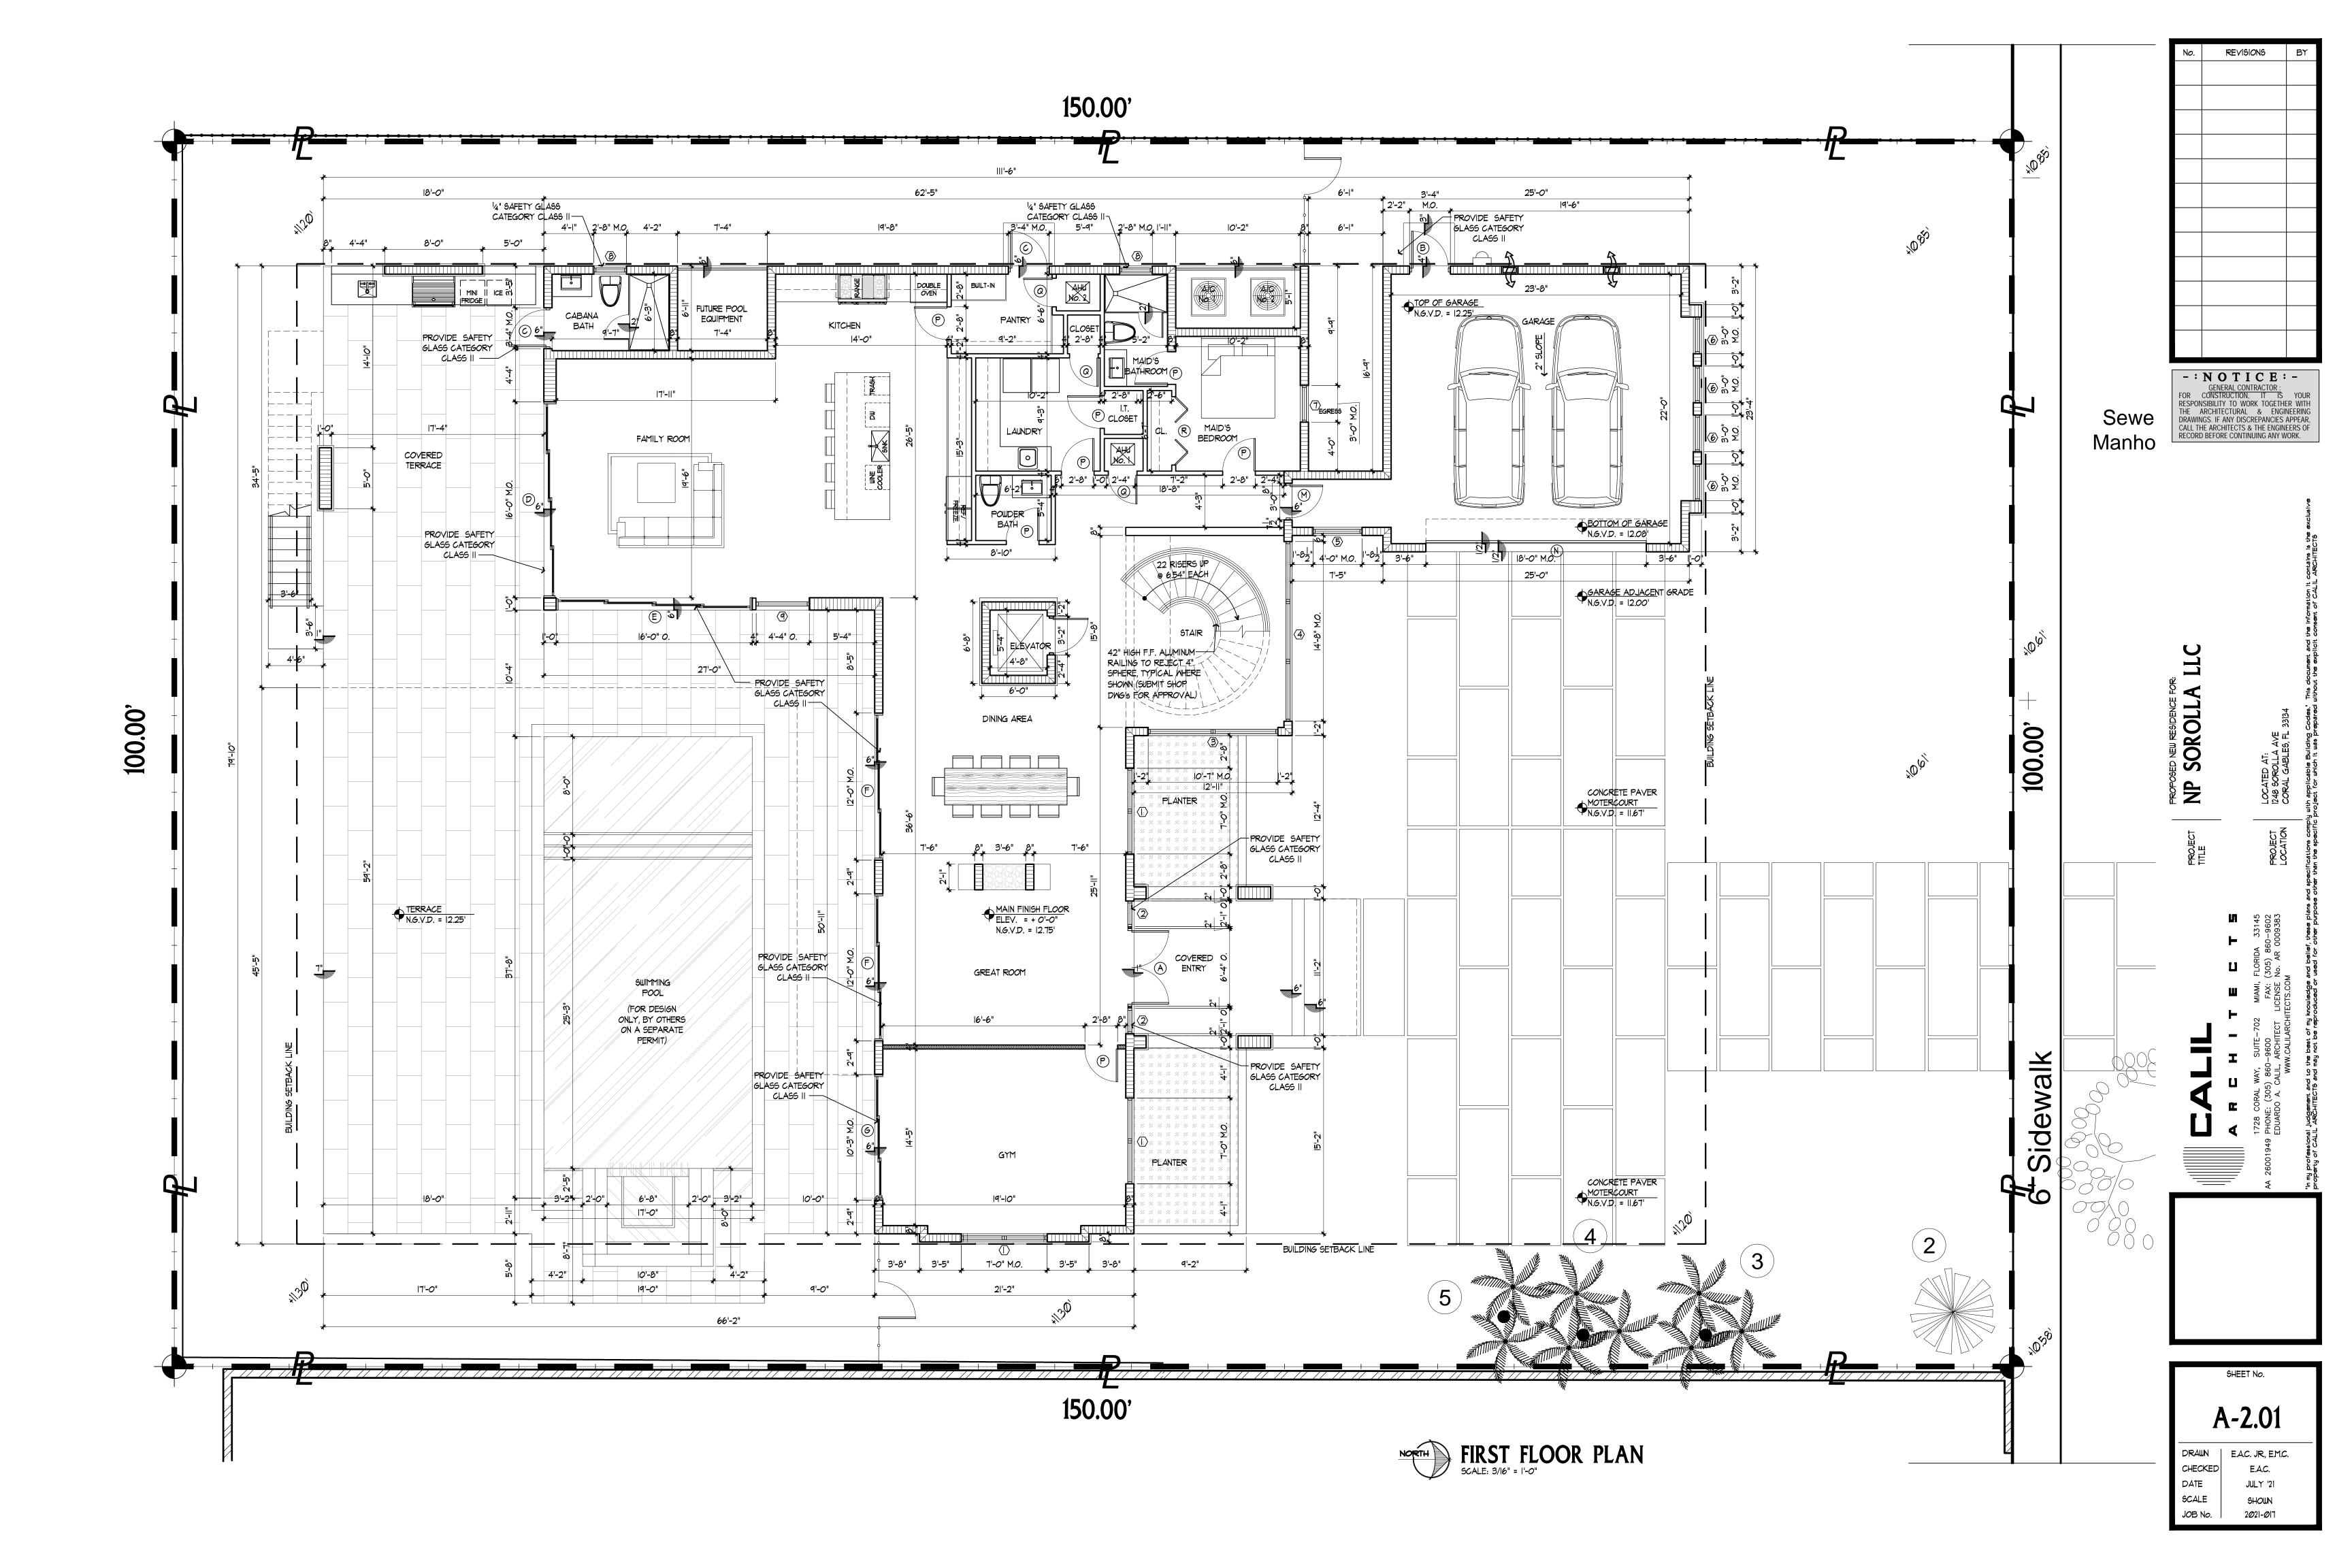

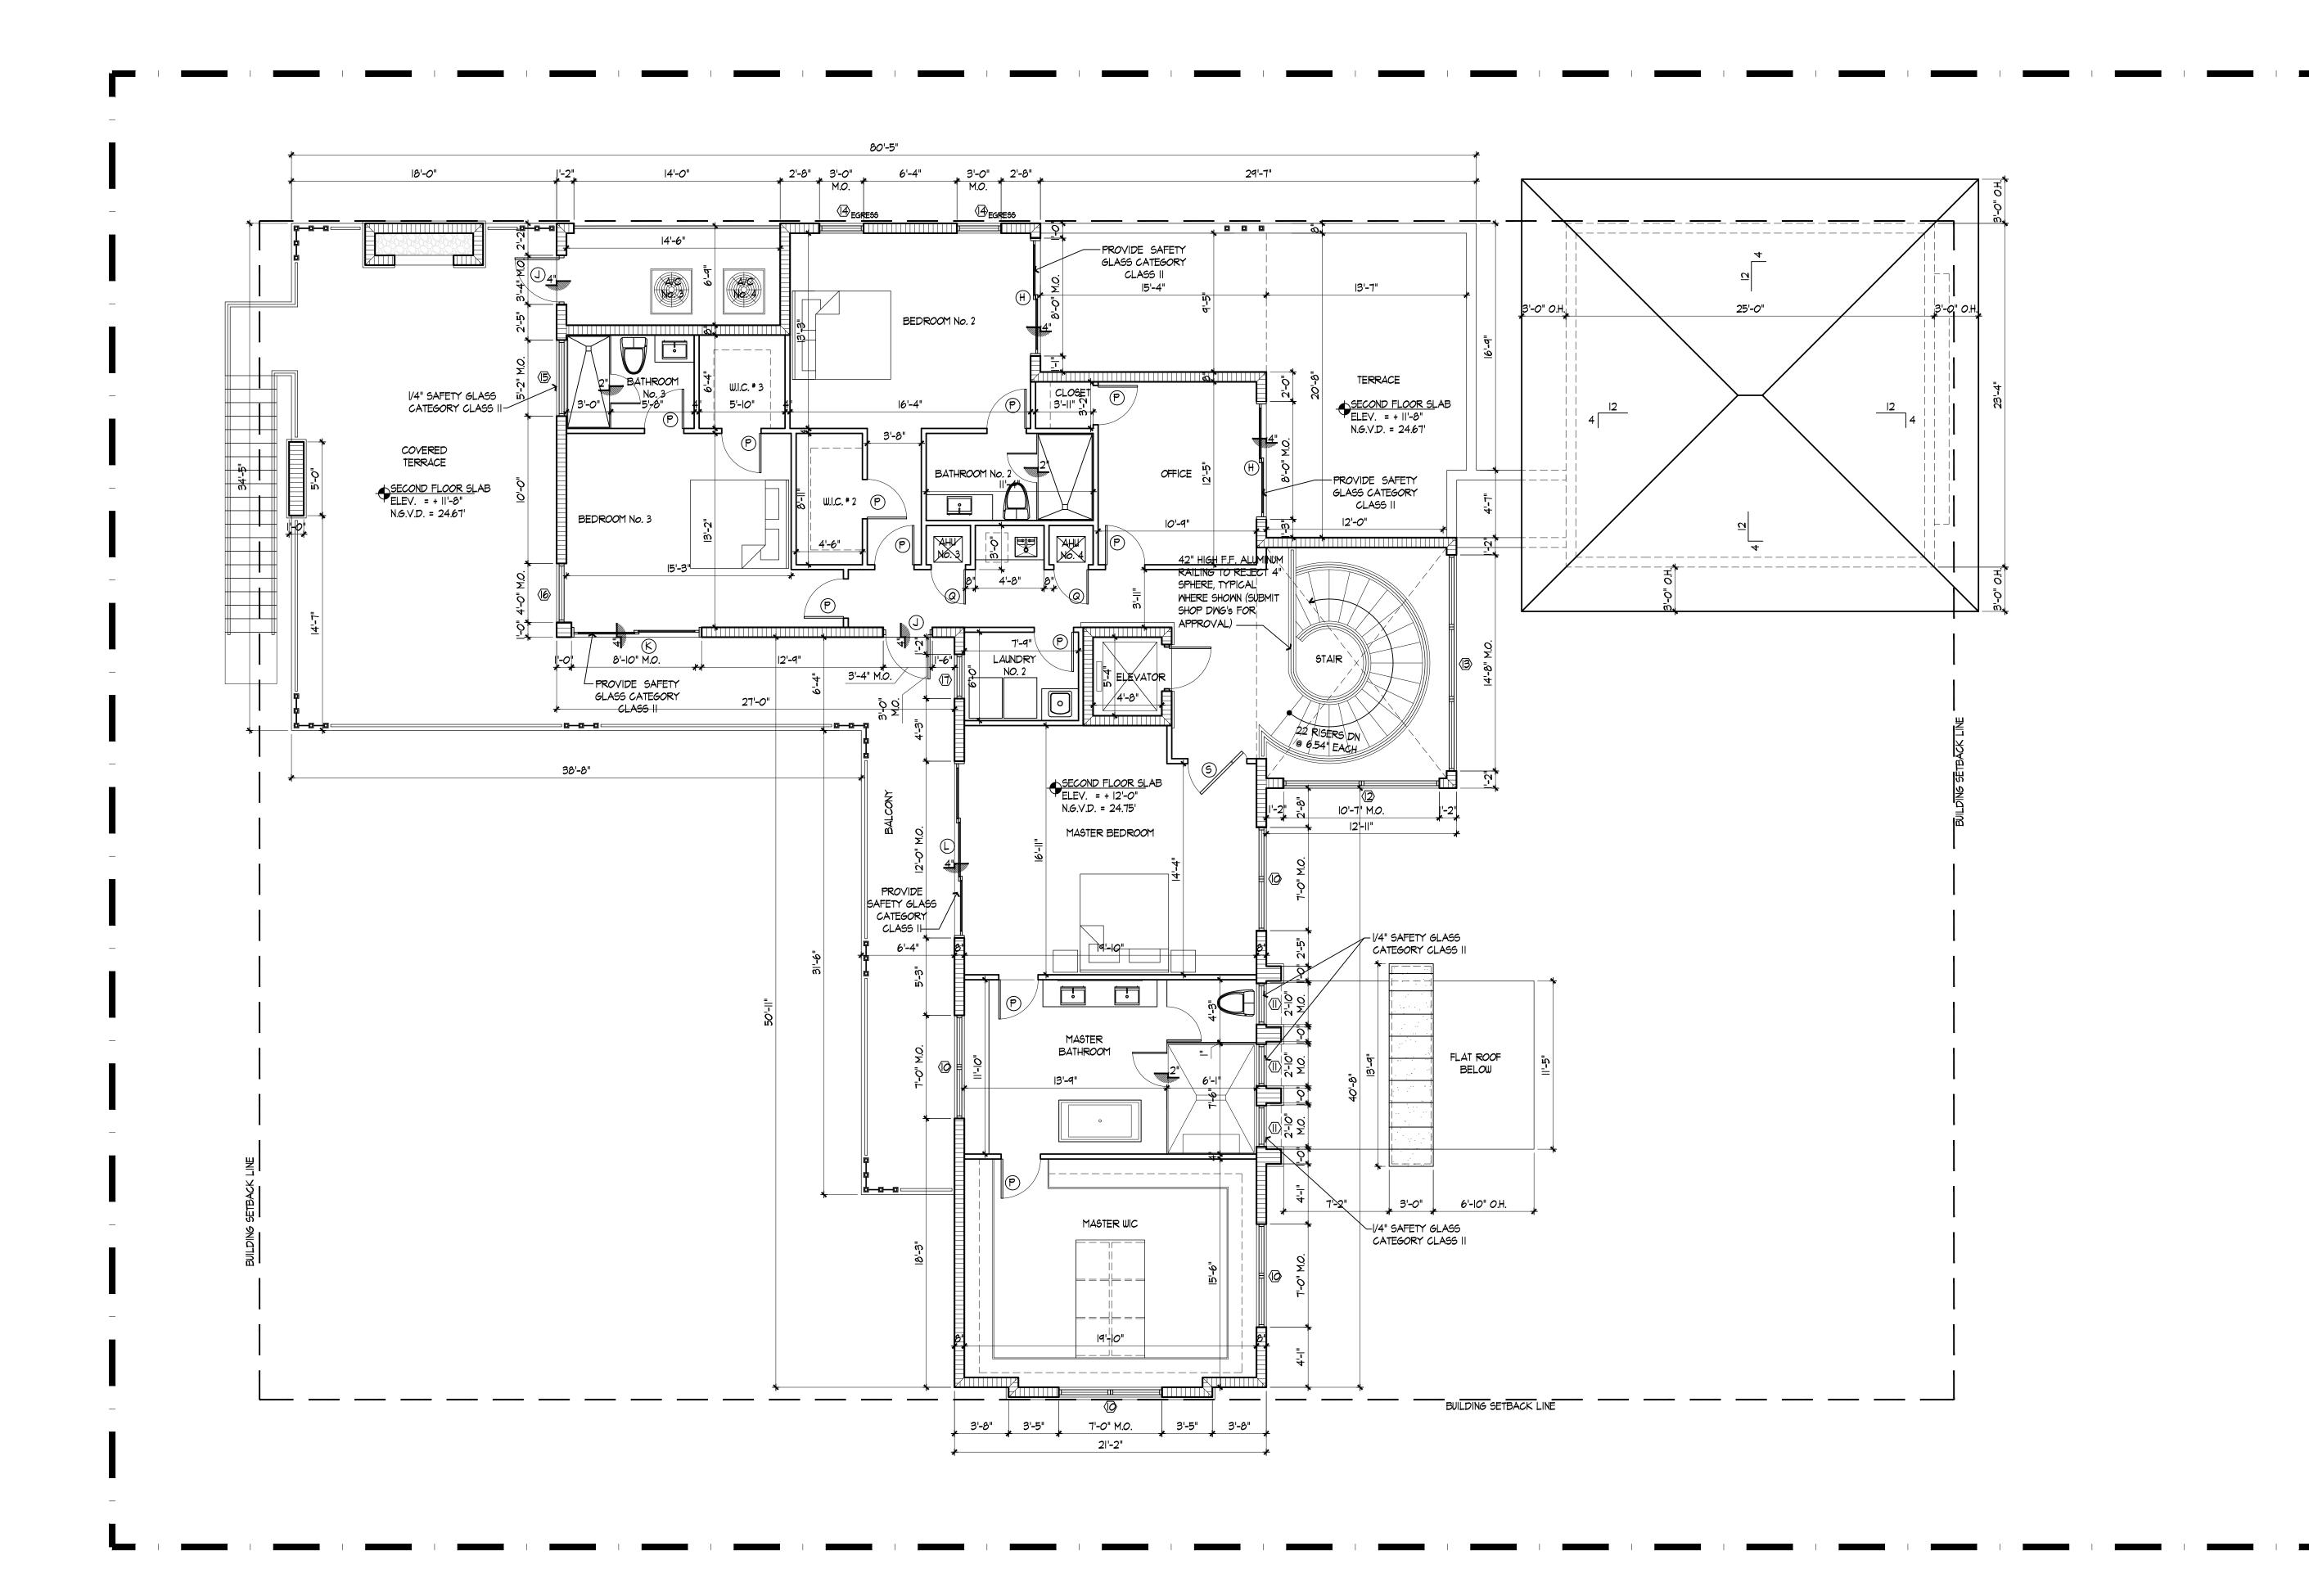

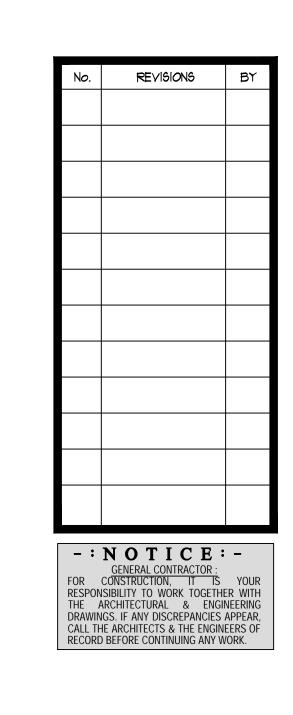


UECT | NP SOROLLA LLC

A-2.02

DRAWN | E.A.C. JR., E.M.C.

DRAWN E.A.C. JR., E.M.C.
CHECKED E.A.C.
DATE JULY '21
SCALE SHOWN
JOB No. 2021-017

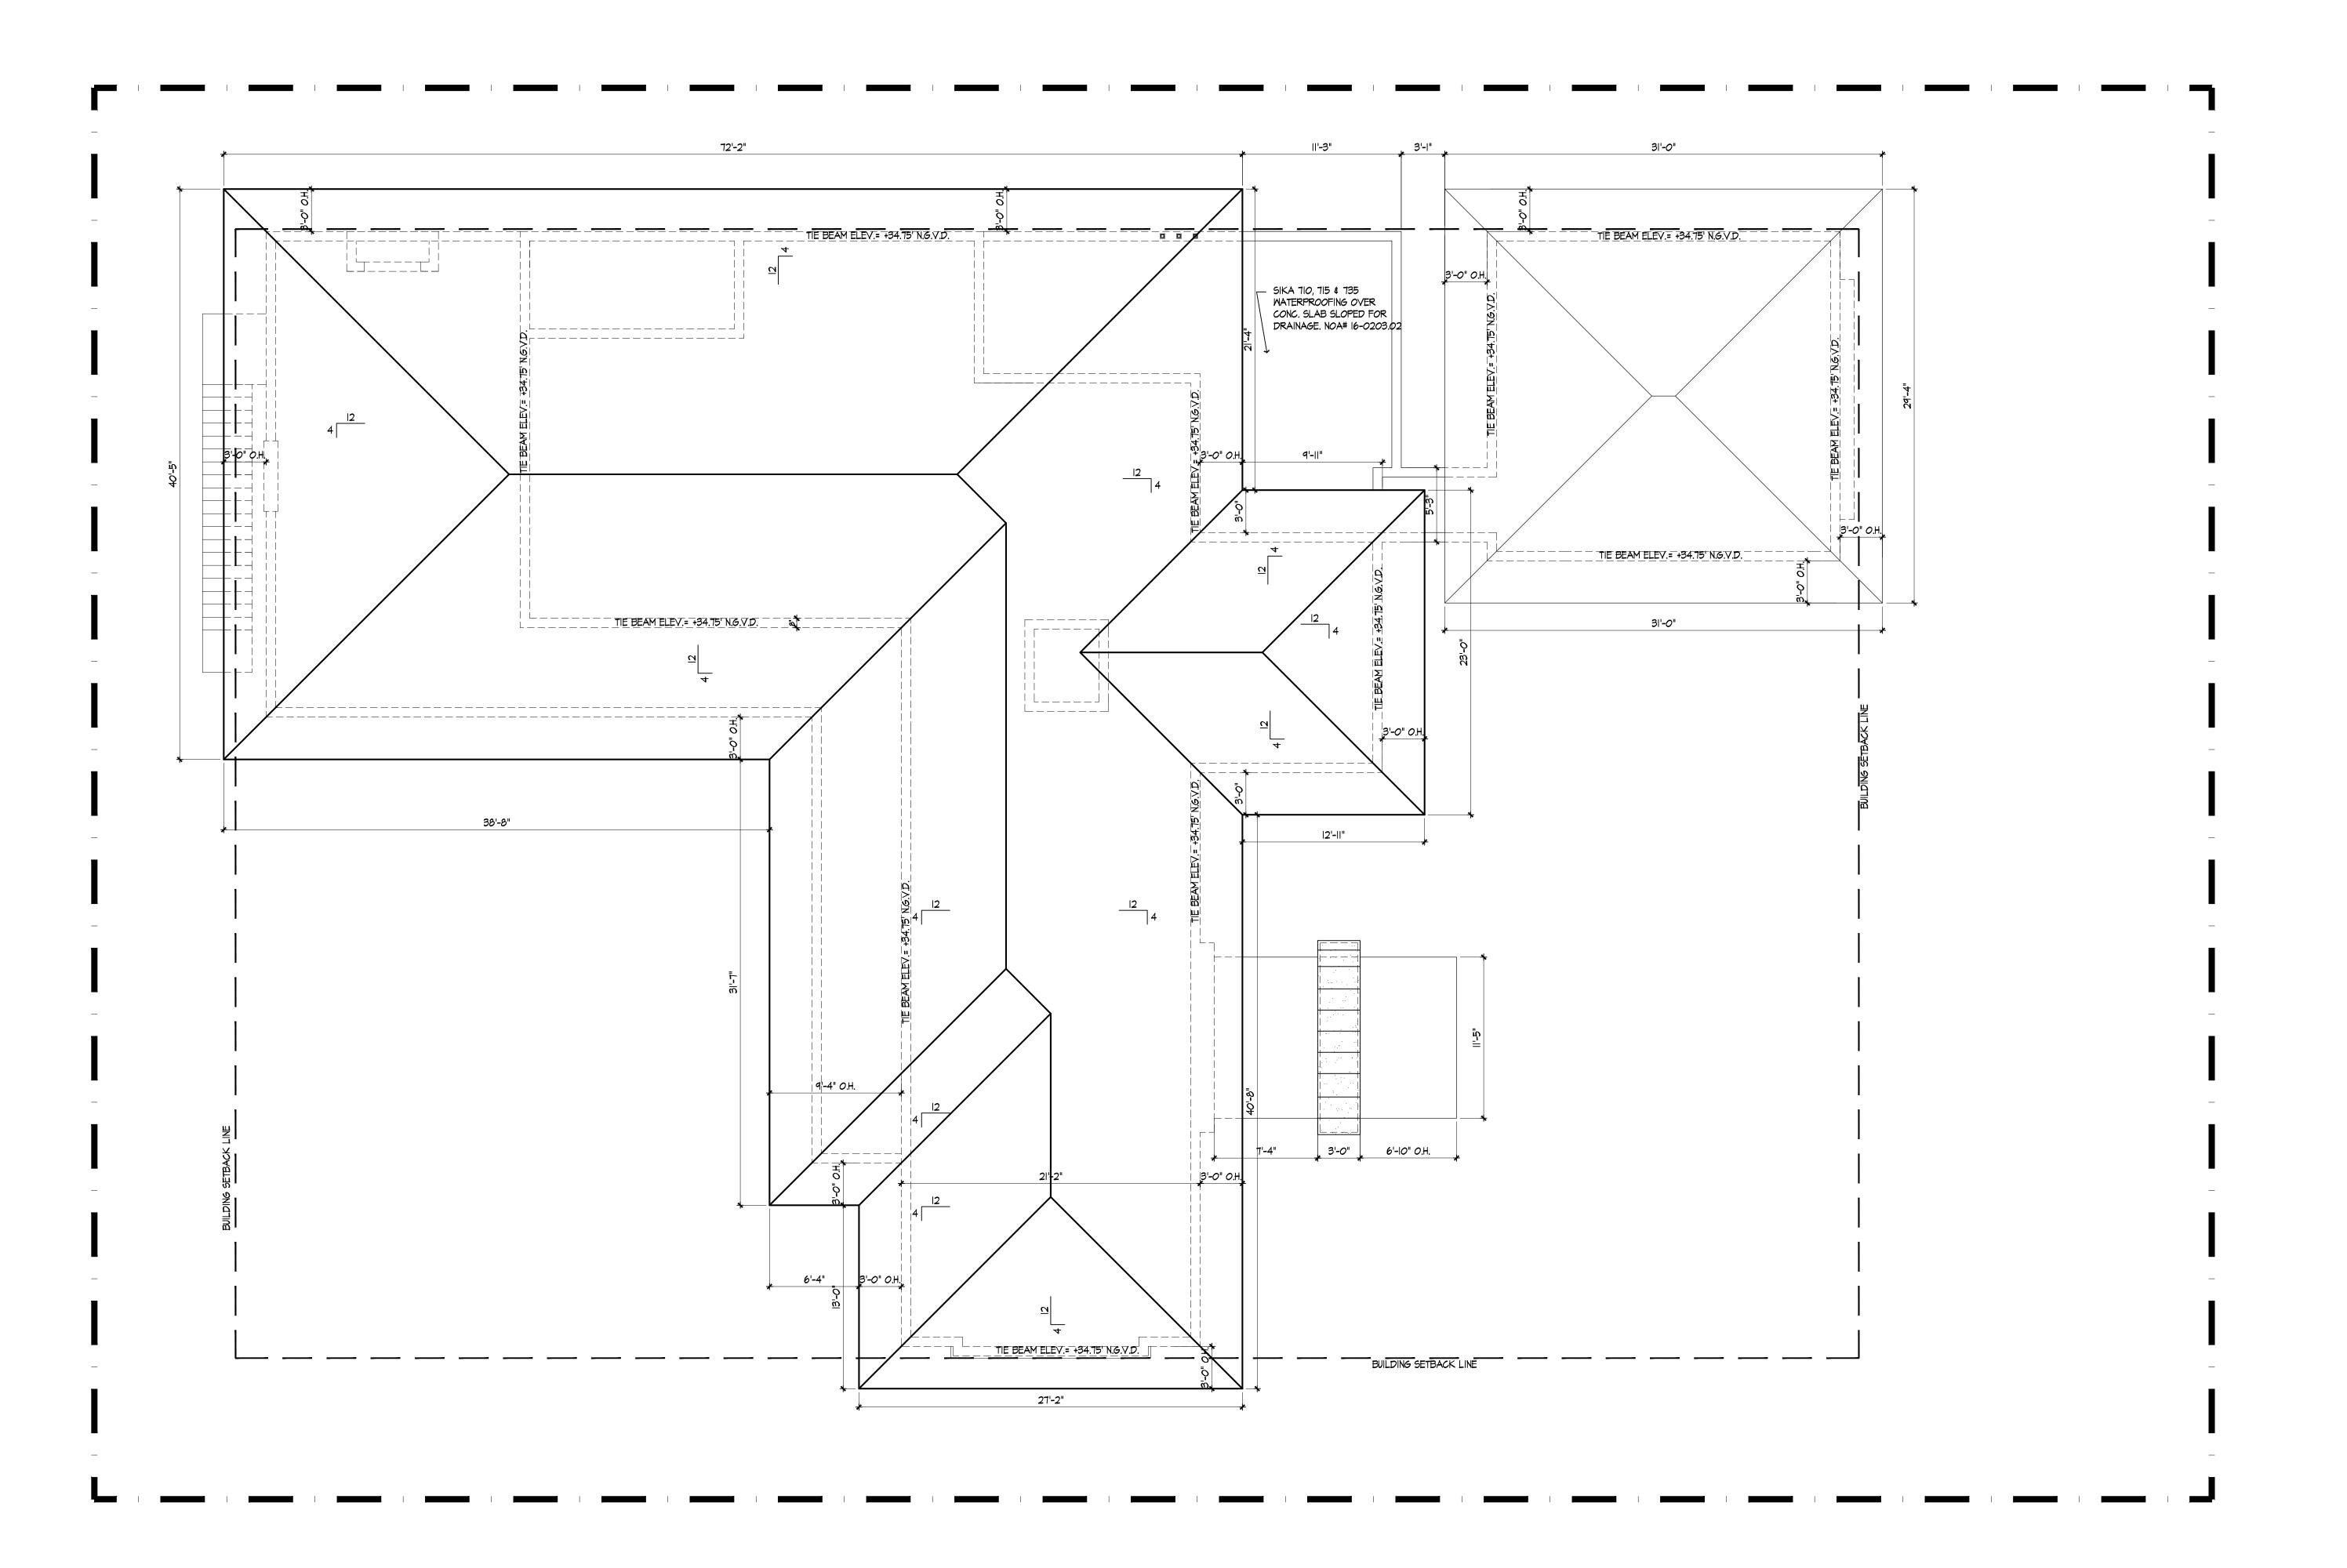

-: NOTICE:
GENERAL CONTRACTOR:

FOR CONSTRUCTION, IT IS YOUR RESPONSIBILITY TO WORK TOGETHER WITH THE ARCHITECTURAL & ENGINEERING DRAWINGS. IF ANY DISCREPANCIES APPEAR, CALL THE ARCHITECTS & THE ENGINEERS OF RECORD BEFORE CONTINUING ANY WORK. SOROLLA


A-2.03

DRAWN E.A.C. JR., EM.C.

DRAWN E.A.C. JR., E.M.C.
CHECKED E.A.C.
DATE JULY '21
9CALE SHOWN
JOB No. 2021-017



MATERIAL BOARD

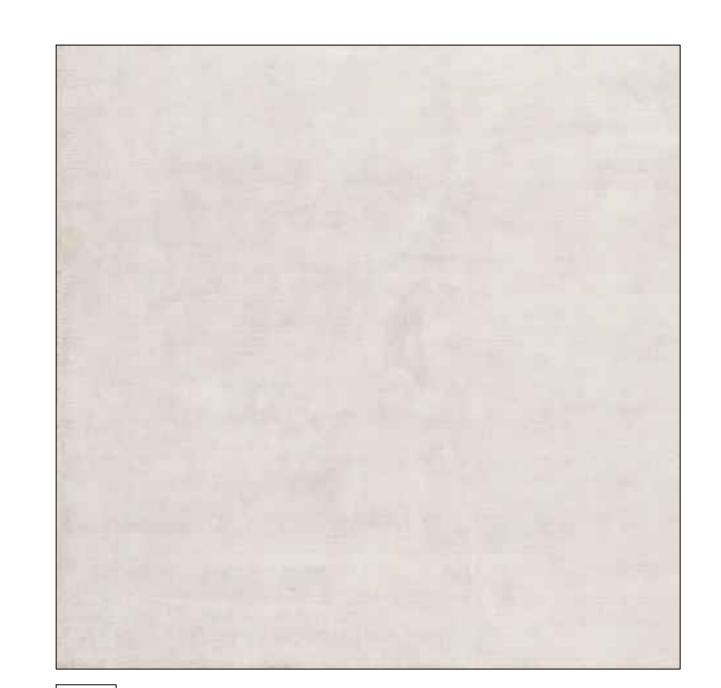

SS SMOOTH STUCCO



WD WOOD/ WOOD VENEER



BR BRONZE METAL FINISH




RT FLAT CEMENT ROOF TILE



LM LIMESTONE



CP CONCRETE PAVERS

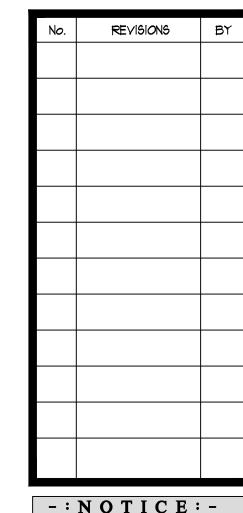

-: NOTICE:
GENERAL CONTRACTOR:


FOR CONSTRUCTION, IT IS YOUE
RESPONSIBILITY TO WORK TOGETHER WITH
THE ARCHITECTURAL & ENGINEERING
DRAWINGS. IF ANY DISCREPANCIES APPEAR
CALL THE ARCHITECTS & THE ENGINEERS OF
RECORD BEFORE CONTINUING ANY WORK.

PROPOSED NEW RESIDENCE FOR:


NP SOROLLA LLC


PROJECT


CORAL WAY, SUITE-702 MIAMI, FLORIDA
E: (305) 860-9600 FAX: (305) 86
ED A. CALIL, ARCHITECT LICENSE No. AR WWW.CALILARCHITECTS.COM

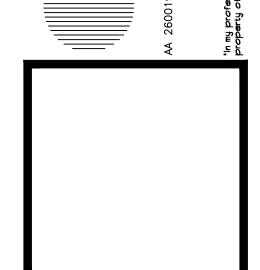

DRAWN E.A.C. JR., EM.C.
CHECKED E.A.C.
DATE JULY '21
6CALE

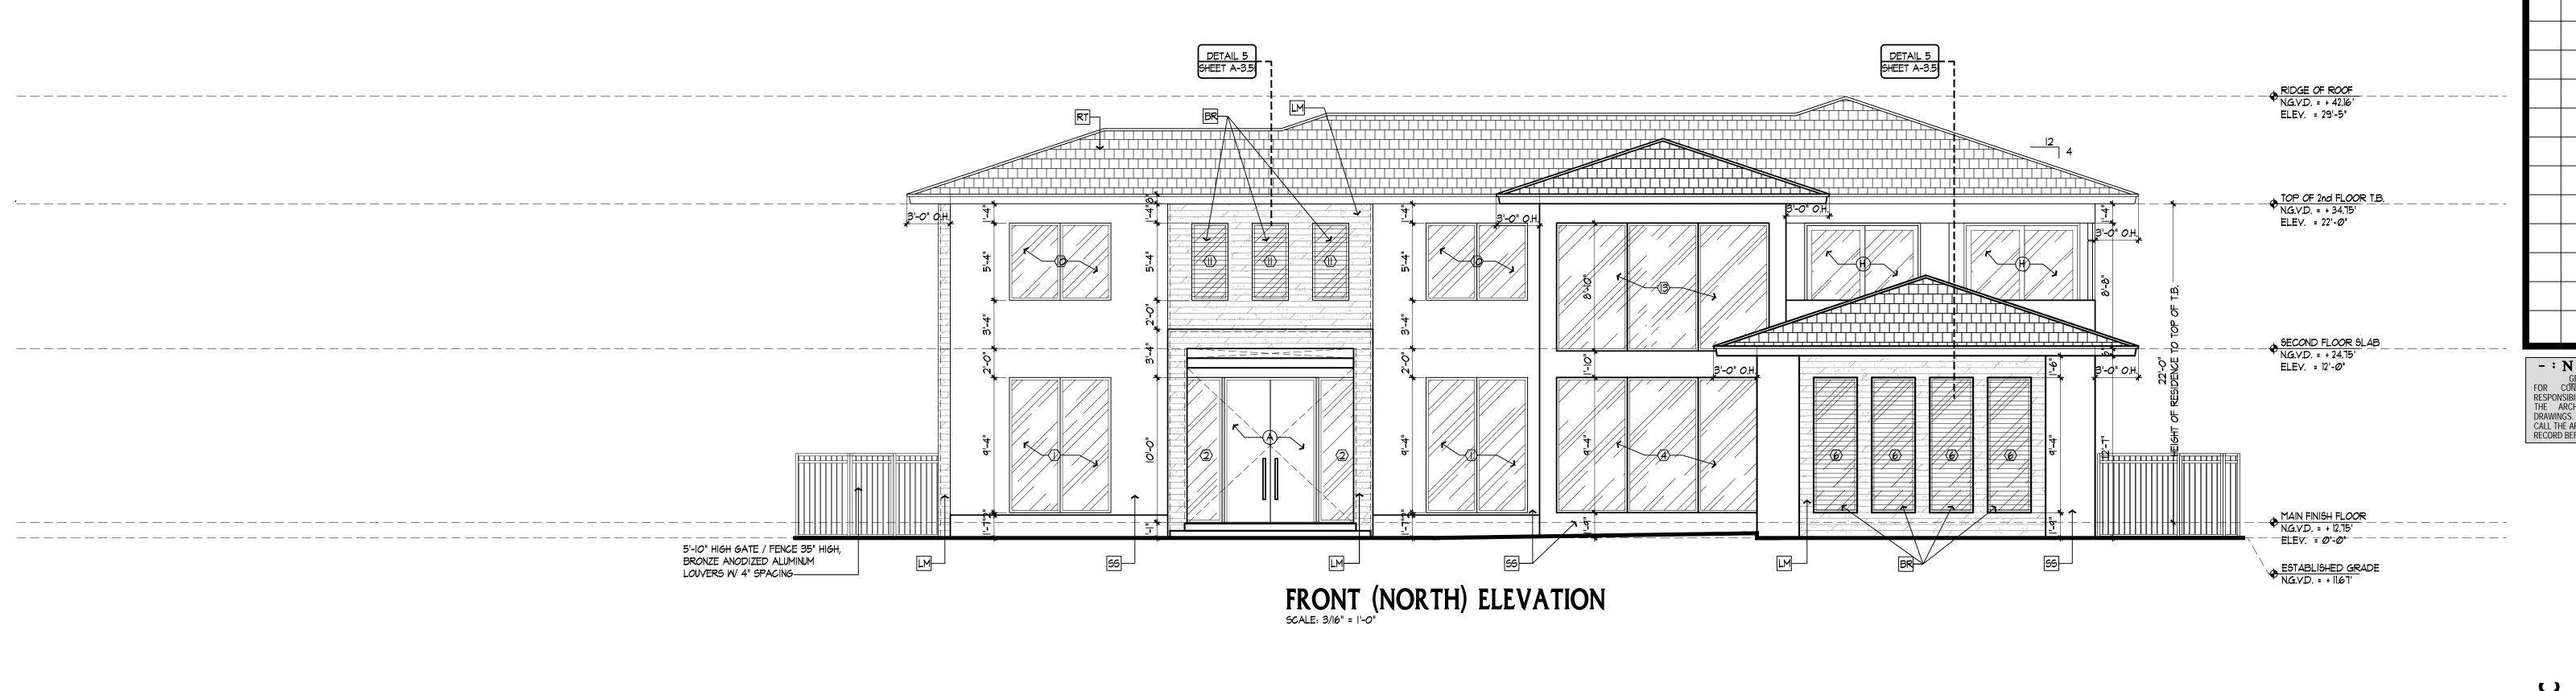

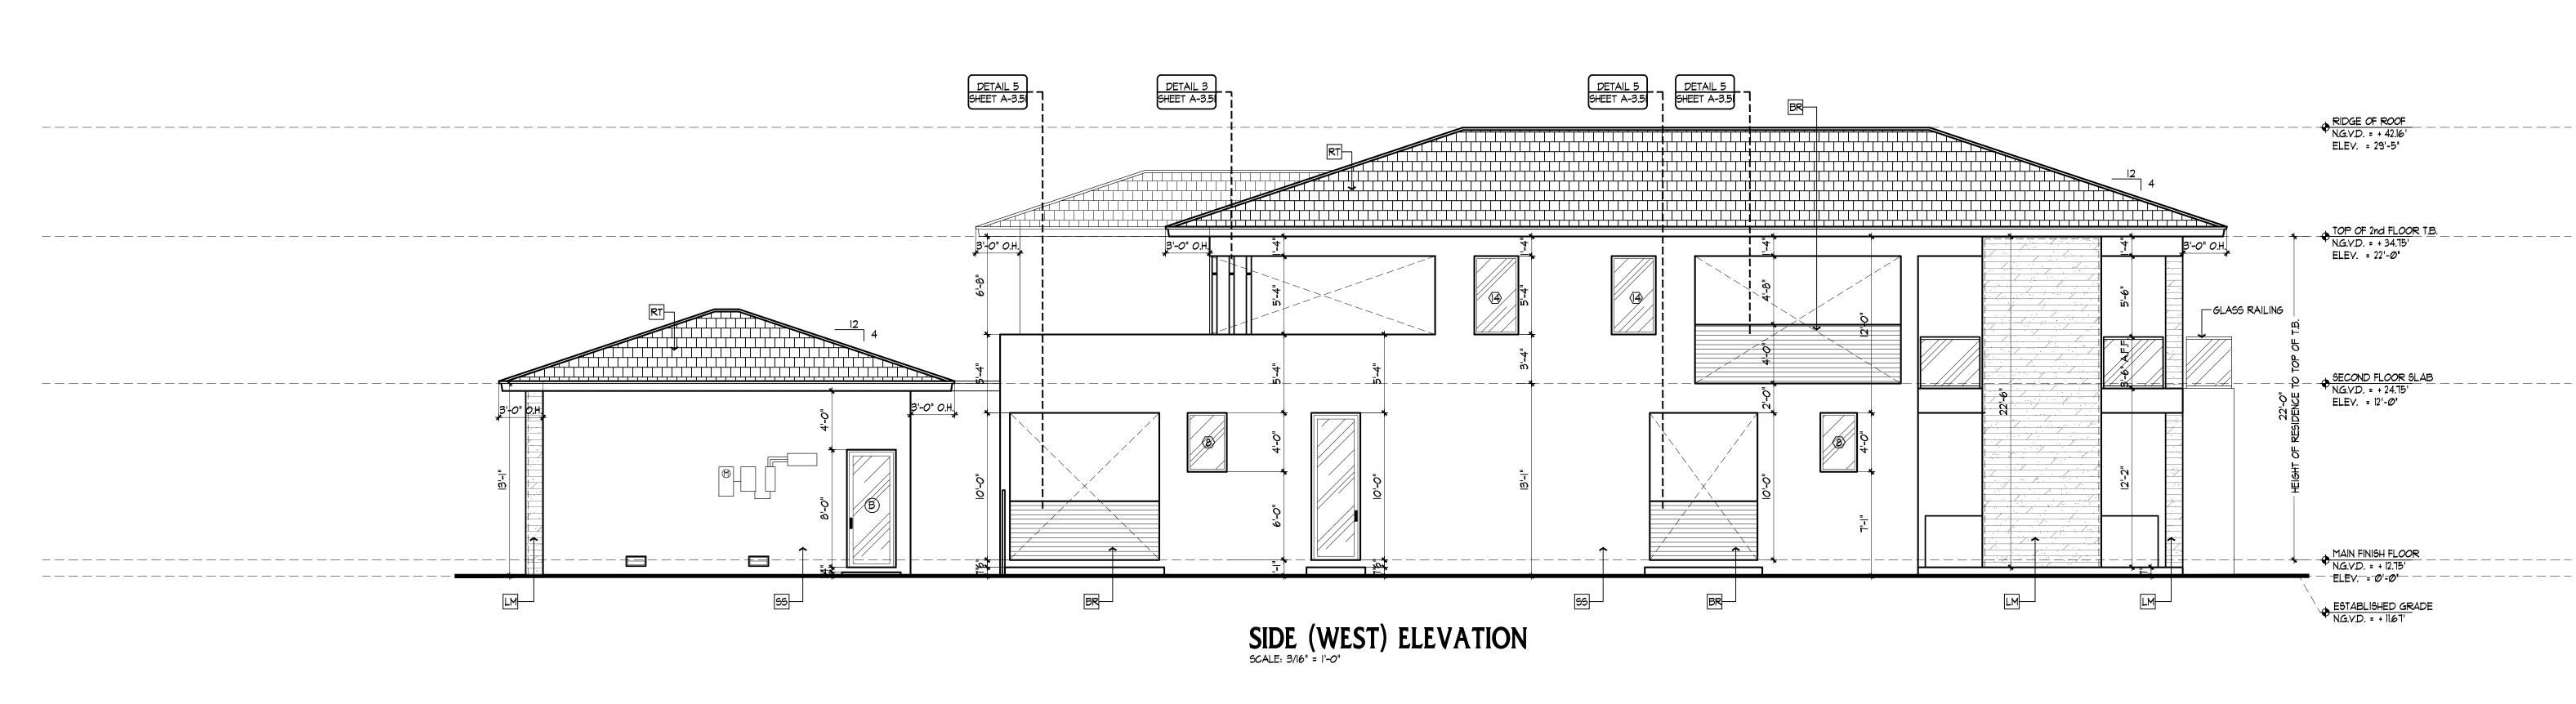


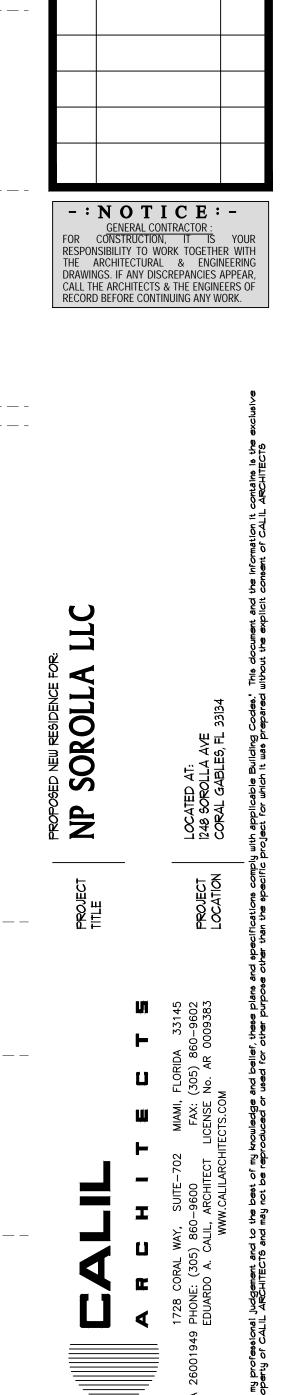



SHEET NO.

A-3.01

DRAWN E.A.C. JR., EM.C.
CHECKED E.A.C.
DATE JULY '21
SCALE SHOWN
2021-017

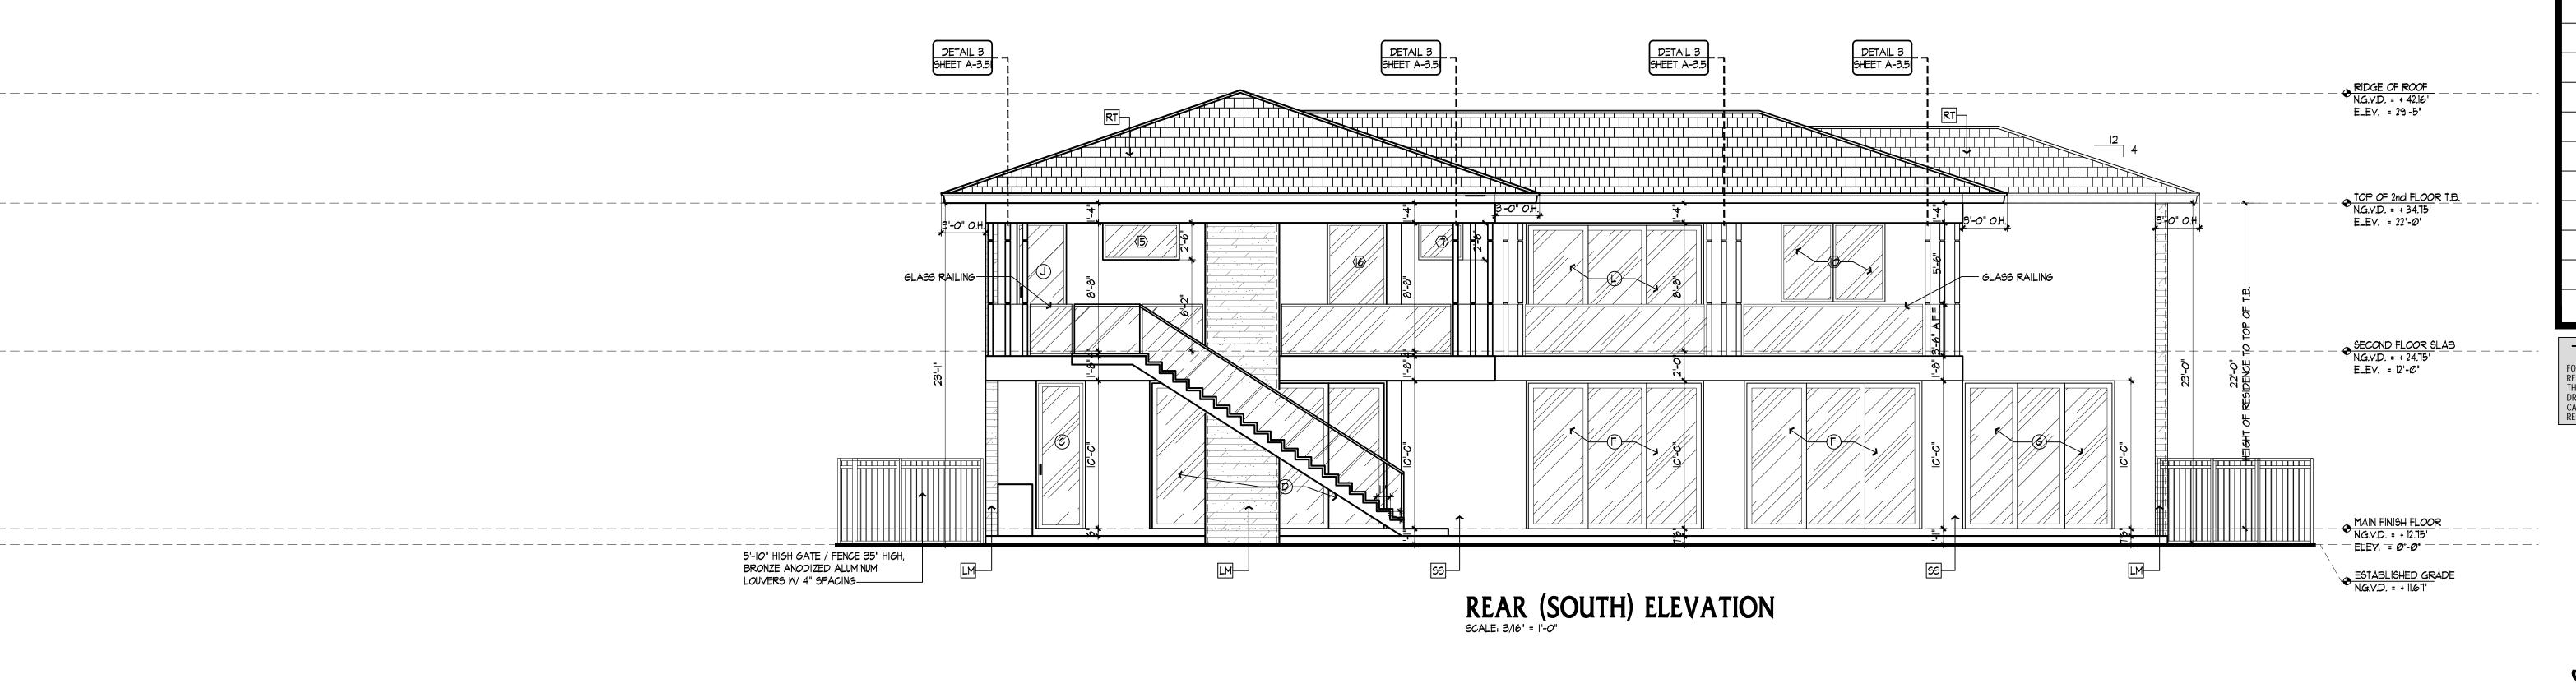

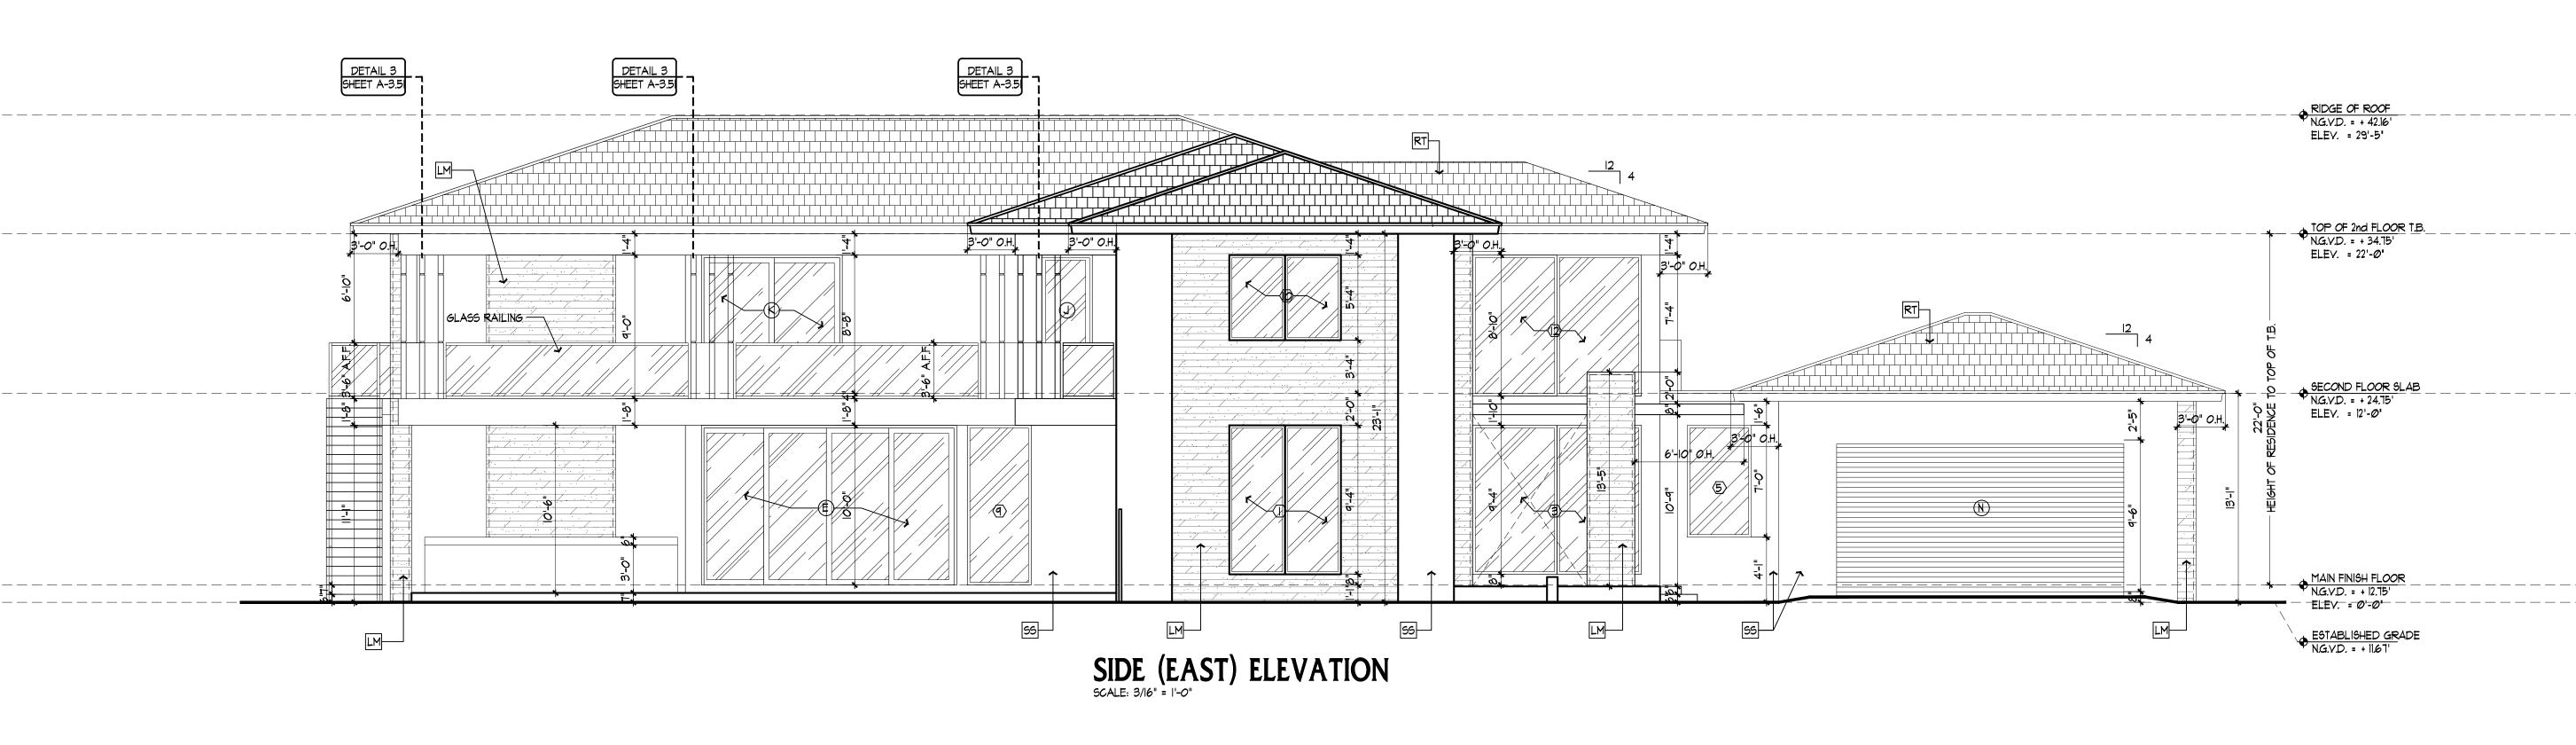

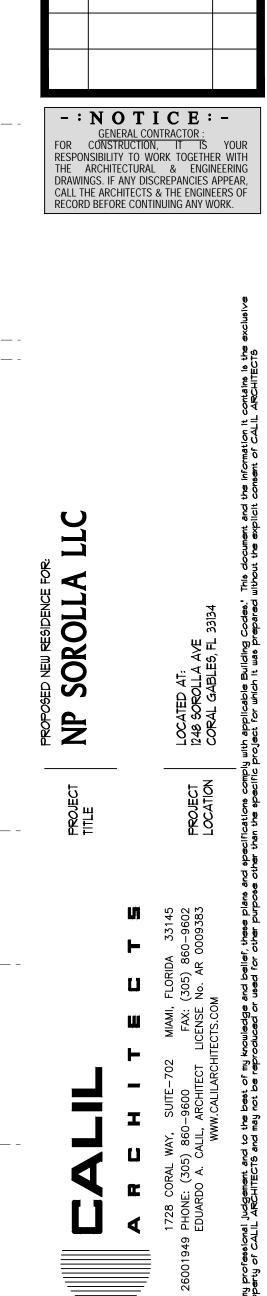


SHEET No.


A-3.02

DRAWN E.A.C. JR., EM.C.
CHECKED E.A.C.
DATE JULY '21
SCALE SHOWN
2021-017


ACCESS GATE NOTES R45Ø1.17.1.8 ACCESS GATES, WHEN PROVIDED, SHALL BE SELF-CLOSING AND SHALL COMPLY WITH THE REQUIREMENTS OF SECTIONS R4501.17.1.1 THROUGH R45Ø1.17.17 AND SHALL BE EQUIPPED WITH A SELF-LATCHING LOCKING DEVICE LOCATED ON THE POOL SIDE OF THE GATE. WHERE THE DEVICE RELEASE IS LOCATED NO LESS THAN 54 INCHES (1372 MM) FROM THE BOTTOM OF THE GATE, THE DEVICE RELEASE MECHANISM MAY BE LOCATED ON EITHER SIDE OF THE GATE AND SO PLACED THAT IT CANNOT BE REACHED BY A YOUNG CHILD OVER THE TOP OR THROUGH ANY OPENING

OR GAP FROM THE OUTSIDE. GATES THAT PROVIDE ACCESS TO THE SWIMMING POOL MUST OPEN OUTWARD AWAY FROM THE POOL. THE GATES AND BARRIER SHALL HAVE NO OPENING GREATER THAN 1/2 INCH (12.7 MM) WITHIN 18 INCHES (457 MM) OF THE RELEASE MECHANISM.

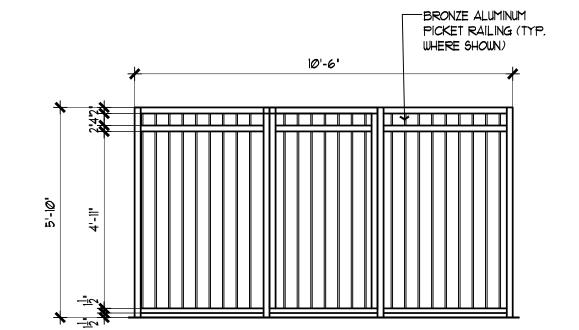


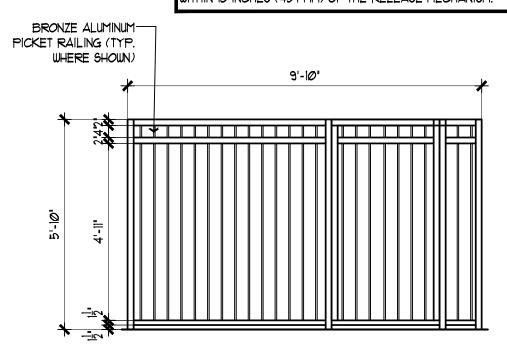




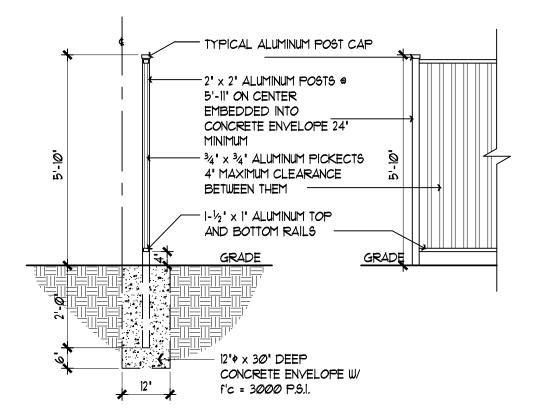


ALUMINUM PICKET FENCE DETAIL SCALE: 1/2" = 1'-0"

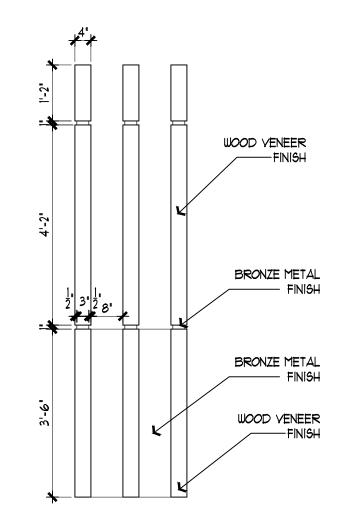




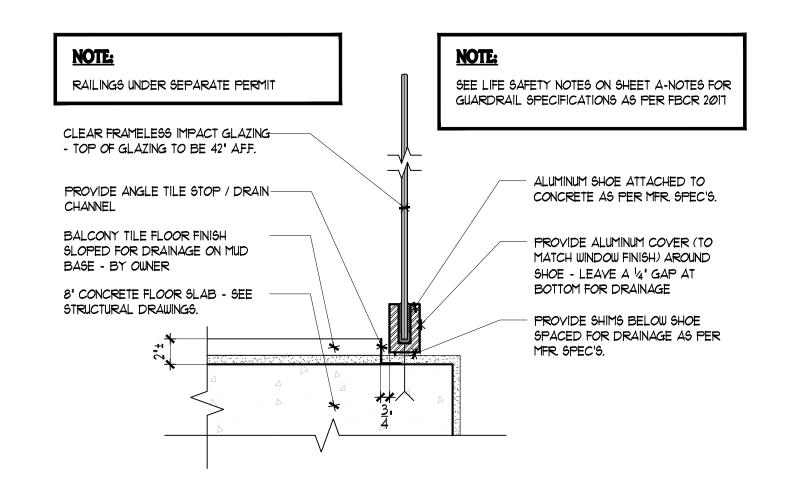

GUARDRAIL DETAIL SCALE: 1 1/2" = 1'-@"

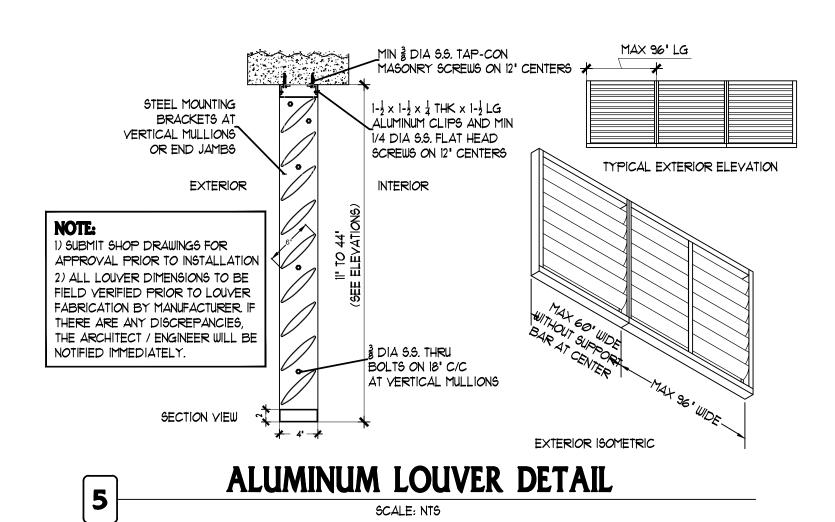

SCALE: NTS

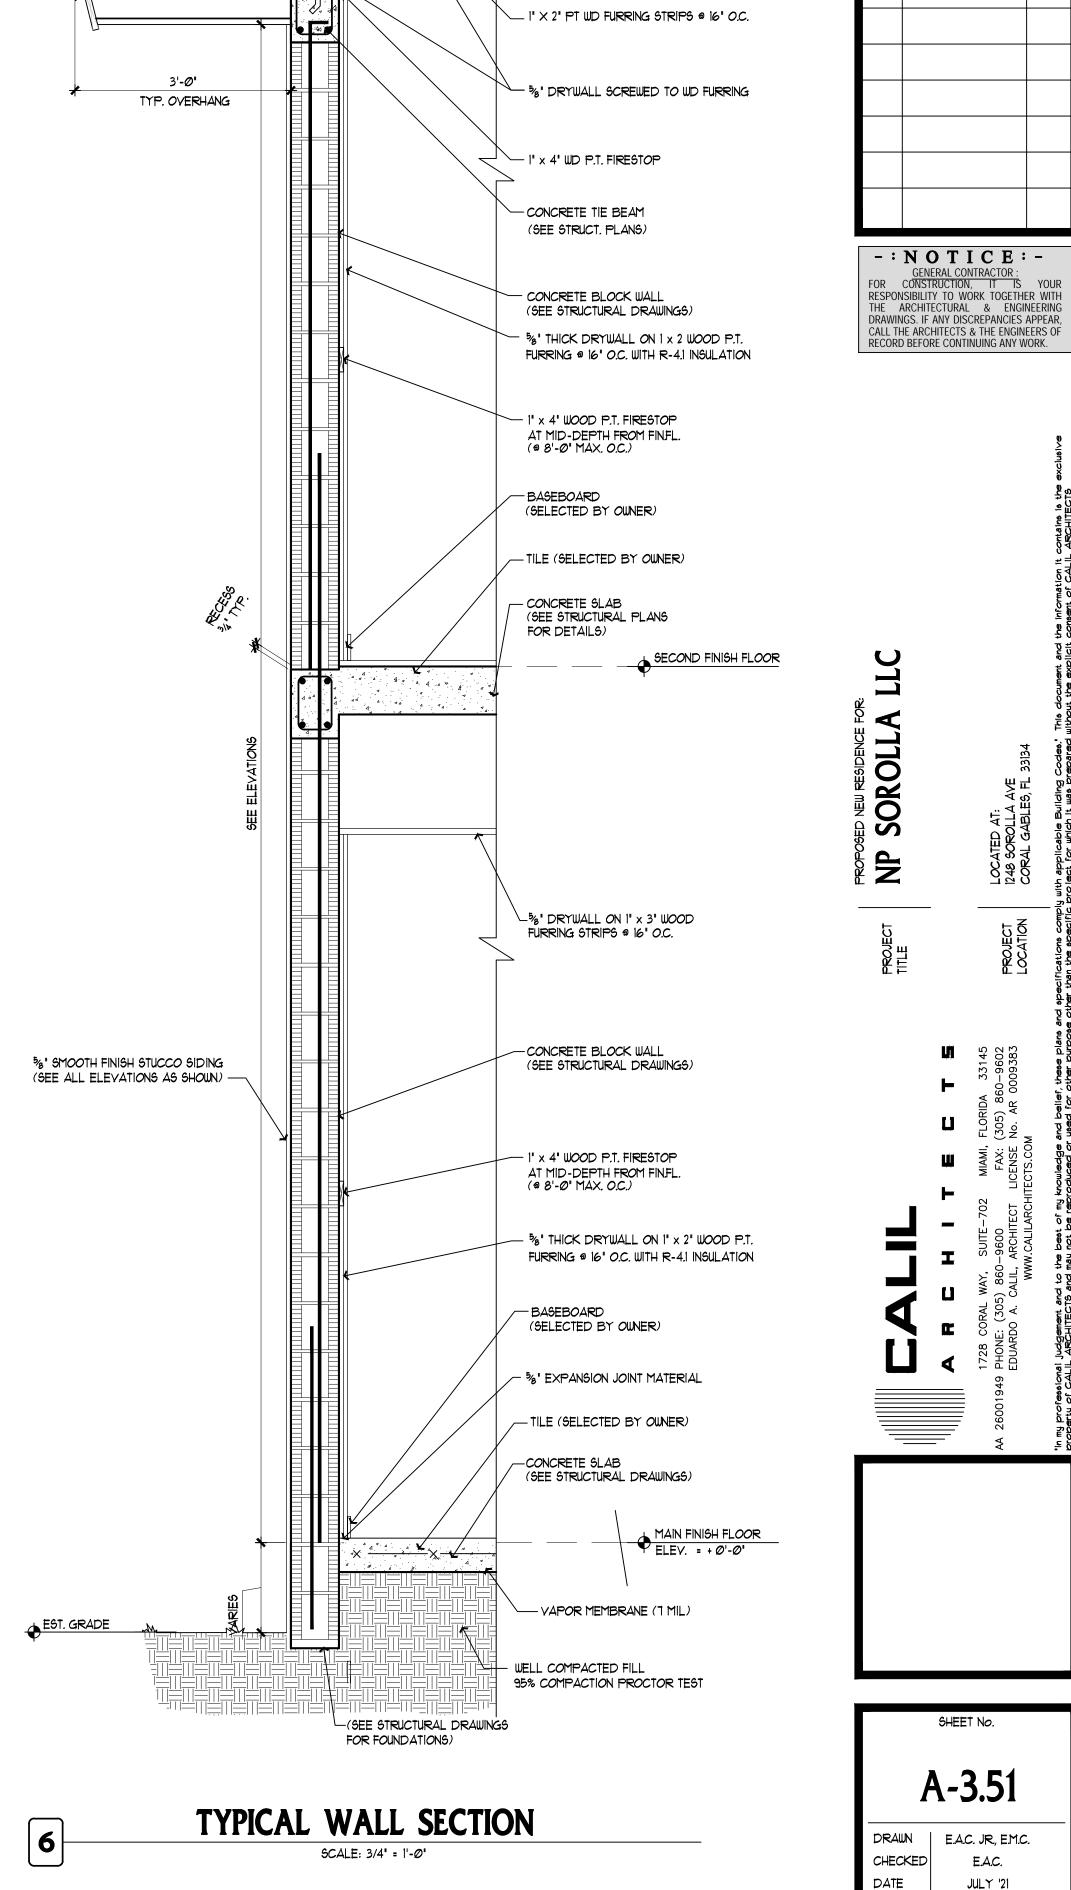

FLAT CEMENT ROOF TILES -

REVISIONS

SHEET No.

A-3.51

SCALE

JOB No.

E.A.C.

JULY '21

SHOWN

2**0**21-**01**7

- R-30 ICYNENE SPRAY FOAM INSULATION

TRUSSES @ 24" O.C. (BY OTHERS)

-PREFAB WOOD