

MAP OF BOUNDARY SURVEY


1522 Alegriano Avenue, Coral Gables Miami-Dade County, FL 33146 Folio # 03-4119-001-1170

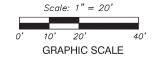


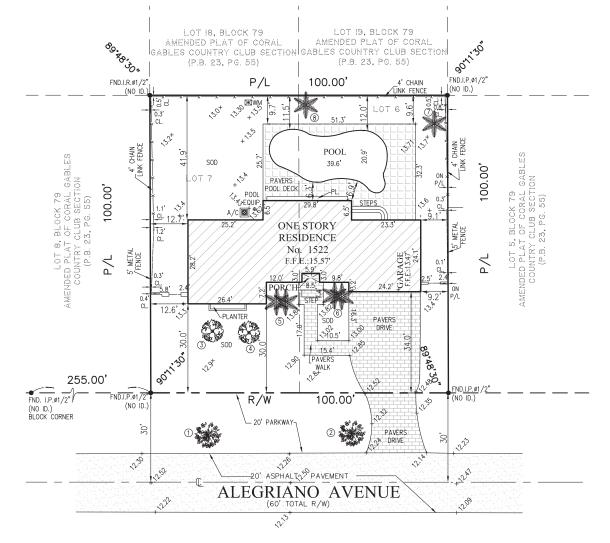



	TREE	TABLE		
No.	TREE NAME	DIAMETER	HEIGHT	SPREAD
1	OAK TREE	30"	30'	25'
2	OAK TREE	30"	30'	25'
3	TREE	7"	15'	10'
4	TREE	7"	15'	10'
5	2 PALM TREES	12"	15'	6'
6	2 PALM TREES	12"	15'	6'
7	PALM TREE	22"	20'	10'
8	PALM TREE	6"	25'	10'

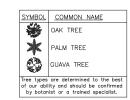

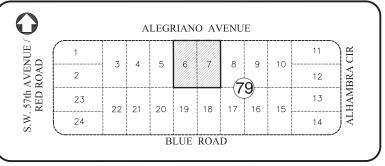

LOCATION SKETCH

SURVEYOR'S REPORT:

1. MAP OF BOUNDARY SURVEY, Fieldwork date of data acquisition: February 19th, 2021.

2. LEGAL DESCRIPTION:

Lots 6 and 7, Block 79, CORAL GABLES COUNTRY CLUB SECTION PART 5, according to the plat thereof, as recorded in Plat Book 23, at Page 55, of the Public Records of Miami-Dade County, Florida.

Containing 10,000 Square Feet or 0.23 Acres more or less by calculations.

4 ACCURACY:

The accuracy obtained by measurement and calculations of a closed geometric figure was found to exceed this requirement. Linear 1 foot in 7,500 feet.

5. DATA OF SOURCES:

HORIZONTAL CONTROL:

-The Legal Description was furnished by client.
-North Arrow as per Plat Book 23, Page 55, of the Public Records of Miami-Dade County, Florida. This line is considered well-established and monumented

Elevations are referred to N.G.V.D. 1929.

Benchmark used: City of Coral Gables Benchmark No. 112, Elevation=12.54' (N.G.V.D. 1929) located @ Alhambra Circle Alegriano Avenue S.W. COR PKBW POC FSW.

6. FLOOD INFORMATION:

By scale determination this property is located in Flood Zone X, as per Federal Emergency Management Agency (FEMA), NFIP Community Name: City of Coral Gables and Community Number 120639 Map/Panel Number 12086C0456, Suffix L, FIRM Panel Effective/Revised Date 09-11-2009.

7. LIMITATIONS:

No research was made for other instruments than the existing in the plat and provided by client. No determination was made as to how the site can be served with utilities. Fences and walls ownership by visual means only; legal ownership not determined No underground utilities and/or structures(foundations) was located within or abutting the Subject

SURVEYOR'S CERTIFICATION:

I certify: This Map of Boundary Survey meets all applicable requirements of the Florida Minimum Technical Standards as contained Chapter 5J—17. Unless indicated to the contrary, the measured distance and directions shown on the Map of Boundary Survey are the same as the deed distances and directions. Not valid without the signature and the original raised seal of Florida Licensed Surveyor and Mapper. Additions or deletions to Map of Boundary Survey by other than signing party or parties is prohibited without written consent of the signing party or parties.

ABBREVIATIONS & LEGEND Pg. Page ... R/W Right-of-Way

FND Found U.E. Utility Easement Center Line IP Iron Pipe IR Iron Rebar Temporary Benchmark Parkway Water Pump TBM N&D Nail & Disc PWY COL. Column

Sewer Manhole Telephone Manhole Water Meter

₩V Water Valve

Catch basin

Electric Box MLP Light Pole Utility Pole Concrete Light Pole

—×—×— Chain Link Fence - Metal or plasti Fence — DUL — Overhead



FormTech Land Surveying, Inc.

State of FlorIda LB # 7980 12209 S.W. 129th Court, Miami, Florida, 33186 Ph: (786)429-3034 (786)443-0285 (786)443-0678 www.formtechsurveyors.com_email-info@formtechsurveyors.com

Little Litte. Job # 21-02063 State of Florida LS # 6660

Page 1 of 1



Lizama Residence

1522 Alegriano Avenue, Coral Gables, FL 33146 BOA submission set

06.28.21

index of drawings

Tree Disposition Plan

A-00 Cover Sheet A-01 Zoning Legend and Diagrams A-02 Context Photos, L.O.I. & Reference Photos A-03 Context Map and Neighboring Residence Photos Existing Site Plan
Existing Floor Plan & Demo
Existing Elevations & Demo
Proposed Site Plan A-04 A-05 A-06 A-07 A-08 Proposed Floor Plan Proposed Elevations A-09 Proposed Elevations A-10 1 A-11 Proposed Roof Plan Renderings (Ă-12´ L-01

revision index

description

architect The Realization Group Architects AA26004002

Miami Office 632 Candia Ave Coral Gables, Florida 33155 tel. 305.284.7325

rtapanes@realizationgroup.com

m.e.p. engineering Guerrero / Gonzalez 780 tamiami canal rd. miami. fl 33144 305.262.3944

mike@guerrerogonzalezengineers.com

HTH Engineering 5112 NW 79th Ave, Unit 108 PH: 786.356.9606 admin@hth-engineering.com client Mr. & Mrs. Lizama 1522 Alegriano Ave Coral Gables, FL 33146

Scope of Work

- Remodel of Bedrooms
- Remodel of Bathrooms
- Expansion of Closets
- New Master Bedroom
- New Master Bathroom
- New Covered Terrace
- New Front Entrance Tower
- Relocation of the Front Door

Realization Group

AA26004002


Miami Office Architect of Record 632 Candia Ave Coral Gables, Florida 33134 305.975.9035

rtapanes@realizationgroup.com

Lizama Residence


522 Alegriano Avenue | Coral Gables, FL 33146

Pre-BOA: Zoning of 08-04-2021

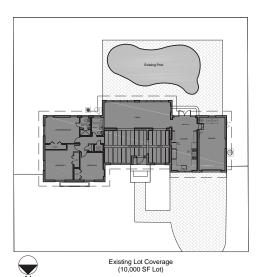


Max Ground Coverage Allowed for Main Building = 35% = 3,500 SF Max Ground Coverage Allowed for Main Building + Auxiliary Structure = 45% = 4,500 SF

Existing Ground Coverage for Main Building = 2,098 SF
Signal Space Space

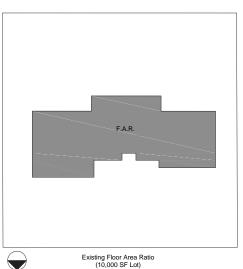


Max Floor Area Ratio Allowed = 4,150 SF


Existing Floor Area Ratio Allowed = 2,081 SF

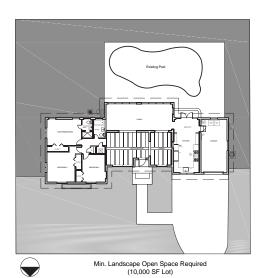


Min. Landscape Open Space Required = 40% Building Site = 4,000 SF Min. Landscape Open Space Required in Front Yard = 20% of the 40% = 800 SF Existing Landscape Open Space on Building Site = 5,464 SF
Existing Landscape Open Space in Front yard = 2,414 SF

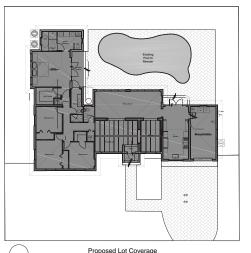

Proposed Lot Coverage (10,000 SF Lot) fround Coverage Allowed for Main Building = 35% = 3,500 SF fround Coverage Allowed for Main Building + Auxiliary Structure = 45% = 4,500 SF Proposed Ground Coverage for Main Building = 2,795 SF
Proposed Ground Coverage for Main Building + Auxiliary Structure = 3,389 SF

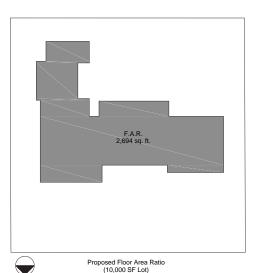


Max Floor Area Ratio Allowed = 4,150 SF Proposed Floor Area Ratio Allowed = 2,694 SF

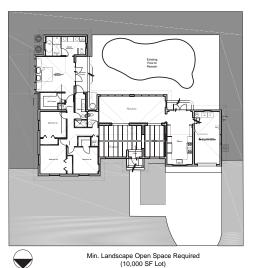

Min. Landscape Open Space Required = 40% Building Site = 4,000 SF Min. Landscape Open Space Required in Front Yard = 20% of the 40% = 800 SF Proposed Landscape Open Space on Building Site = 4,670 SF
Proposed Landscape Open Space in Front yard = 2,427 SF

Zoning: SFR - Single Family Residential	Required / Allowed	Existing	Proposed
Lot Occupation			
a. Lot area (sf)	5,000 Min.	10,000 SF	10,000 SF
b. Lot width	50 FT min.	100 FT	100 FT
c. Ground area coverage (Article 4. 4-7)	4,500 SF max. (Main Building + Accessory)	2,692 SF	3,389 SF
	Max. for Main Building = 35% = 3,500 SF	2,098 SF	2,795 SF
	Max. for Auxiliary Structures = 10% = 1,000 SF	594 SF	594 SF
d. Floor Area	4,150 SF max.	2081 SF	2,694 SF
5,000 9	SF or less - 48% 5,000 x 48% = 2,400 SF		
Next	5,000 SF - 35% 5,000 x 35% = 1,750 SF		
Remainder of the building	g site area- 30% 0 x 30% = 0 SF		
e. Density	One (1) principal building	1 Principal Building	3
Building Setbacks			
a. Front setback	25 ft	30.0'	30.0'
	1 - Interior Side Min. 5 ft. (20% of the total lot width, with a combined maximum of 20 feet shall be equalon both sisdes)	9.1' Right Side 12.50' Left Side	9.1' Right Side 11' Left Side
b. c. Rear	2 - Side Street 15 feet. 10 ft. If compatible with neighborhood character, the Board may recoomend	36.27'	10'
	varicances to allow a rear setback of 5 feet.		
Building Height			
a. Maximum height	2 Stories or 25 feet. Measure from finish floor to the tie-beam on the floor, excluding a raised floor of thirty (30) inches	12' - 10"	13' - 11"
Parking Requirements			
a. Single Family	One (1) parking space consisting of a roofed structure. Which utilized the same materials as the principle structure and that is a garage, carport, or porte-cochere	3 Spaces	3 Spaces
Landscape Requirements		5.454.55	4.670.65
a. Landscape Open Space	All buildings shall provide landscaped open space of not less than forty (40%) percent of the areas of the building site. At least twenty (20%) percent of the required forty (40%) of the landscape open space shall be located in the front yard area.	5,464 SF	4,670 SF
		F 464 6F	4.670 SF
	Minimum Required Landscape Open Space = 40% = 4,000 SF	5,464 SF	4,070 SF

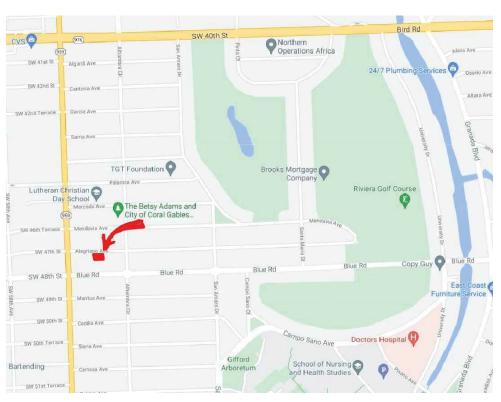

Location Map: nts



AA26004002

Miami Office Architect of Record 632 Candia Ave Coral Gables, Florida 33134 305.975.9035

rtapanes@realizationgroup.com

33146

Coral Gables, FL Residence Lizama

drawn by: designed by:

Alegriano Avenue

522

A-01

Board of Architects | 2021

Realization Group







Contextual Photo of Front of Residence








SW View










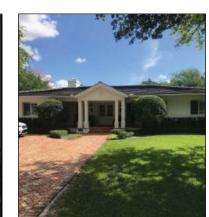

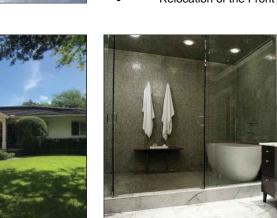

Letter of Intent:

This project is seeking to create an addition to the existing Single Family Residence in the South East Corner of the property to create a full on Master Suite inclusive of a covered terrace facing the existing pool. This project will enhance the front entrance by creating an entrance feature to clearly mark the front door.

- Remodel of Bedrooms
- Remodel of Bathrooms
- **Expansion of Closets**
- New Master Bedroom New Master Bathroom
- **New Covered Terrace**
- New Front Entrance Tower
- Relocation of the Front Door



revisions						




Realization Group


AA26004002

Miami Office Architect of Record 632 Candia Ave Coral Gables, Florida 33134 305.975.9035

rtapanes@realizationgroup.com

Lizama Residence
1522 Alegriano Avenue | Coral Gables, FL 33146

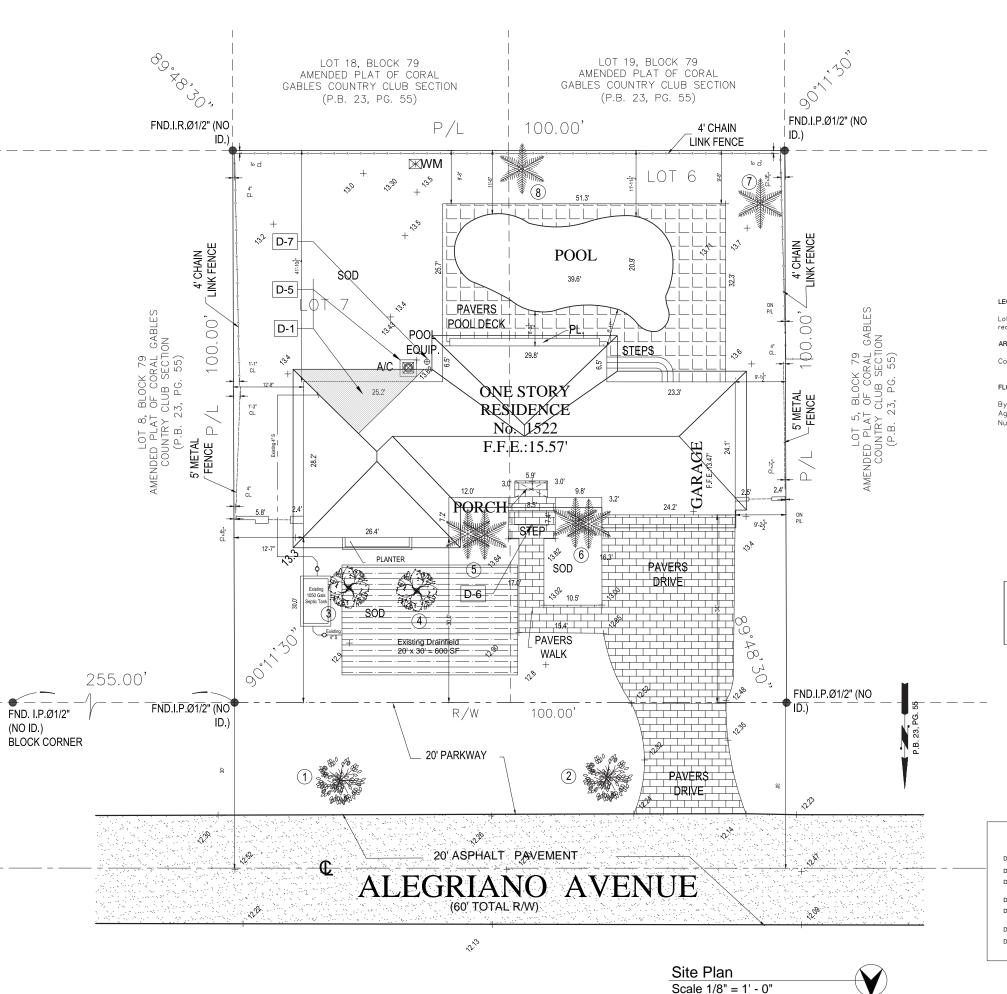

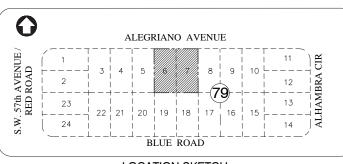

LOCATION SKETCH

1522 Alegriano Avenue, Coral Gables Miami-Dade County, FL 33146 Folio # 03-4119-001-1170

Lots 6 and 7, Block 79, CORAL GABLES COUNTRY CLUB SECTION PART 5, according to the plat thereof, as recorded in Plat Book 23, at Page 55, of the Public Records of Miami-Dade County, Florida

Containing 10,000 Square Feet or 0.23 Acres more or less by calculations.

FLOOD INFORMATION:

By scale determination this property is located in Flood Zone X, as per Federal Emergency Management Agency (FEMA), NFIP Community Name: City of Coral Gables and Community Number 120639 Map/Panel Number 12086C0456, Suffix L, FIRM Panel Effective/Revised Date 09–11–2009.

	TREE TABLE											
No.	TREE NAME	DIAMETER	HEIGHT	SPREAD								
1	OAK TREE	30"	30'	25'								
2	OAK TREE	30"	30'	25'								
3	TREE	7"	15'	10'								
4	TREE	7"	15'	10'								
5	2 PALM TREES	12"	15'	6'								
6	2 PALM TREES	12"	15'	6'								
7	PALM TREE	22"	20'	10'								
8	PALM TREE	6"	25'	10'								

at fin							
	OAK TREE						
*	PALM TREE						
	GUAVA TREE						

Α	Arc	Pg.	Page ABBRE	VIA	TIONS & LEG				Chain Link Fence
FND	Found	R/W	Right-of-Way	(m)	Unknown Manhole	Ħ	Fire Hydrant		Wood Fence
U.E.	Utility Easement	C "	Center Line	③	Sewer Manhole	E	Electric Box		Metal or plastic
IP	Iron Pipe	M	Monument Line	Ō	Telephone Manhole	⊠ MI	Light Pole		Fence
IR	Iron Rebar	ТВМ	Temporary	₩M	Water Meter	Ų			Overhead
N&D	Nail & Disc		Benchmark	_	water meter		Utility Pole	0.60	Utility line
COL.	Column	PWY W/P	Parkway Water Pump	₩V	Water Valve	CLP	Concrete Light Pole	40.	Spot Elevation
P.B.	PLat Book	ENC	Encroachment		Catch basin		Property Corner		opor corono

DEMOLITION NOTES

- D-1. Remove and prepare roof area for new piggyback roof
- D-2. Partition and Finish Surfaces to be removed and stripp
- D-4. Existing Windows and Doors to be removed
- D-5. Existing A/C Condensing Unit to be removed, stored and
- D-6. Remove Stoop / Concrete steps
- D-7. Exist. crawl space entrance to be relocated to east side of house

D-8. Pool Equipment to remain and protected

D-9. Remove toilet and bathtub. Remove al

D-12. Reserve

A-04

drawn by designed by:





Miami Office Architect of Record 632 Candia Ave Coral Gables, Florida 33134 305.975.9035


rtapanes@realizationgroup.com

33146

Residence Lizama

Coral Gables, FL

522 Alegriano Avenue

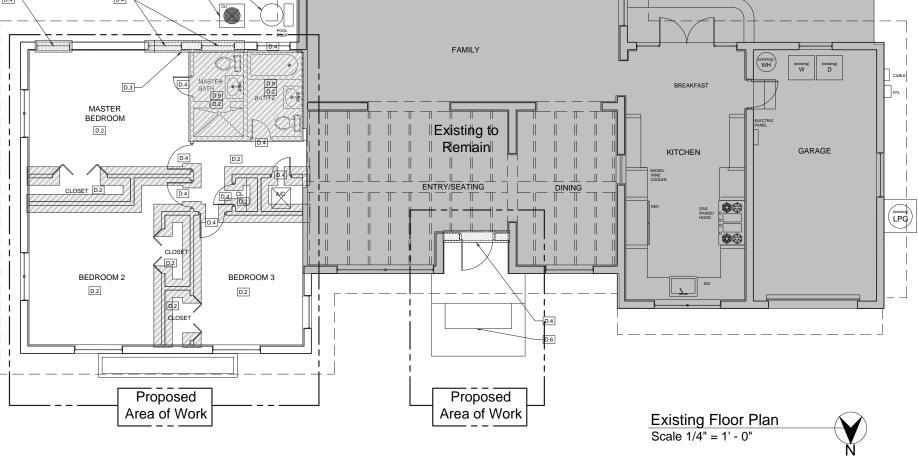

DEMOLITION NOTES

D-8. Pool Equipment to remain and protected.

D-9. Remove toilet and bathtub. Remove all bathroom finishes and lighting.

D-12. Reserve

D-1. Remove and prepare roof area for new piggyback roof.

D-2. Partition and Finish Surfaces to be removed and stripped

D-3. Demo exist. wall for new opening. Ref. rough opening from floor plan shown.

D-6. Remove Stoop / Concrete steps.

D-4. Existing Windows and Doors to be removed D-5. Existing A/C Condensing Unit to be removed, stored and relocated to new location as per Proposed Site Plan.

D-7. Exist. crawl space entrance to be relocated to east side of house



AA26004002

Miami Office Architect of Record 632 Candia Ave Coral Gables, Florida 33134 305.975.9035

rtapanes@realizationgroup.com

33146 Coral Gables, FL

Lizama Residence

drawn by: designed by:

522 Alegriano Avenue

DEMO WALL LEGEND

Existing walls to be demolished

Existing areas to be demolished

New Masonry Wall





AA26004002

Miami Office Architect of Record 632 Candia Ave Coral Gables, Florida 33134 305.975.9035

rtapanes@realizationgroup.com

33146


Coral Gables, FL

522 Alegriano Avenue

Lizama Residence

drawn by: designed by:



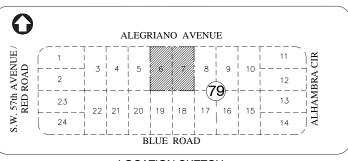

LOCATION SKETCH NOT TO SCALE

1522 Alegriano Avenue, Coral Gables Miami-Dade County, FL 33146 Folio # 03-4119-001-1170

EGAL DESCRIPTION:


Lots 6 and 7, Block 79, CORAL GABLES COUNTRY CLUB SECTION PART 5, according to the plat thereof, as recorded in Plat Book 23, at Page 55, of the Public Records of Miami-Dade County, Florida.

Containing 10,000 Square Feet or 0.23 Acres more or less by calculations.

FLOOD INFORMATION:

By scale determination this property is located in Flood Zone X, as per Federal Emergency Management Agency (FEMA), NFIP Community Name: City of Coral Gables and Community Number 120639 Map/Panel Number 12086C0456, Suffix L, FIRM Panel Effective/Revised Date 09–11–2009.



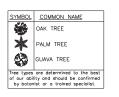

A	Arc	Pq.	Page ABBR	EVIA	TIONS & LEG	SEND	Chain Link Fence
FND	Found	R/W	Right-of-Way	(49)	Unknown Manhole	💢 Fire Hydrant	Wood Fence
U.E.	Utility Easement	G.	Center Line	(3)	Sewer Manhole	E Electric Box	
IP	Iron Pipe	M	Monument Line	Ō	Telephone Manhole	MLP Light Pole	Fence
IR	Iron Rebar	ТВМ	Temporary	₩M	Water Meter		Overhead
N&D	Nail & Disc	PWY	Benchmark	_	water weter	🗅 Utility Pole	. Utility line
COL.	Column	W/P	Parkway Water Pump	₩V	Water Valve	CLP Concrete Light Pole	e + Spot Elevation
P.B.	PLat Book	ENC	Encroachment		Catch basin	Property Corner	



AA26004002

Miami Office Architect of Record 632 Candia Ave Coral Gables, Florida 33134 305.975.9035

rtapanes@realizationgroup.com

ioo (gi cumzuo i gi cup.co

33146

Lizama Residence

Coral Gables, FL

Alegriano Avenue

date: 06-17
drawn by: RT
designed by: RT


revisions

Pre BOA: Zering commerts
08-04-2021

A-07

Board of Architects | 2021

Proposed Site Plan
Scale 1/8" = 1' - 0"

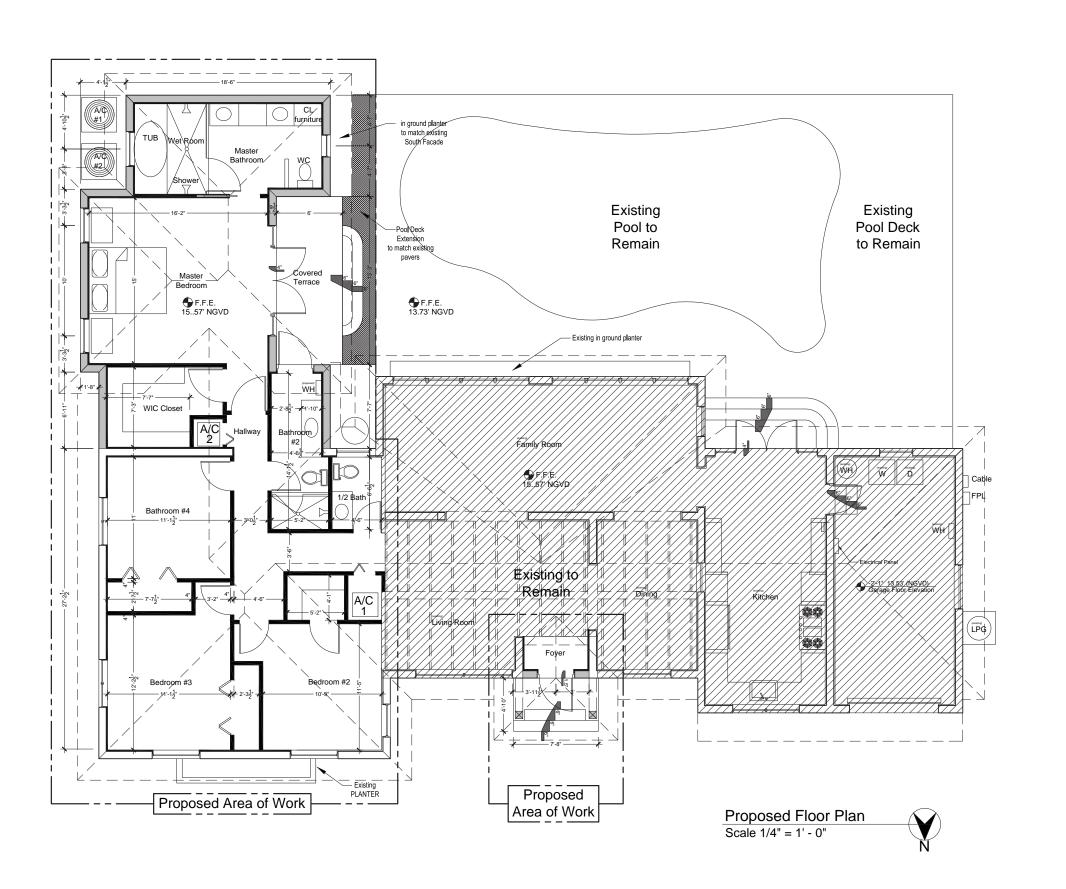



AA26004002


Miami Office Architect of Record 632 Candia Ave Coral Gables, Florida 33134 305.975.9035


rtapanes@realizationgroup.com

522 Alegriano Avenue | Coral Gables, FL Lizama Residence


drawn by: designed by:


Realization

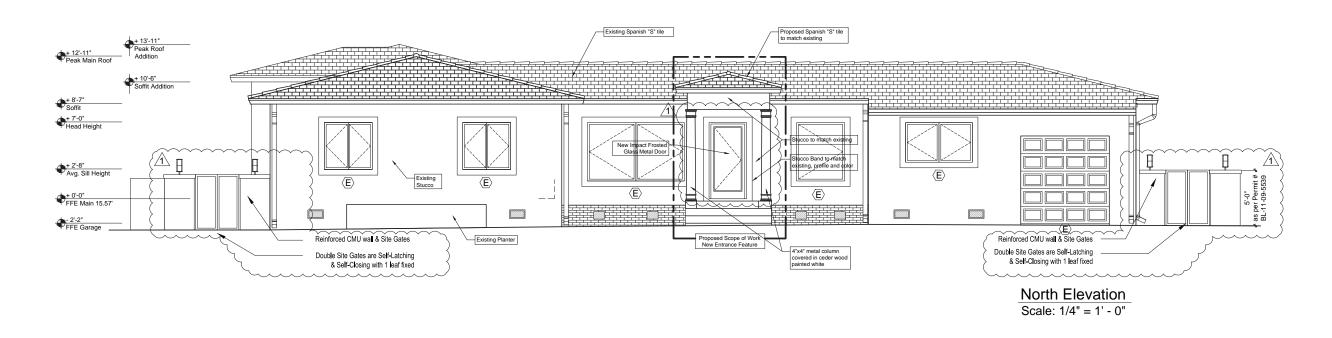

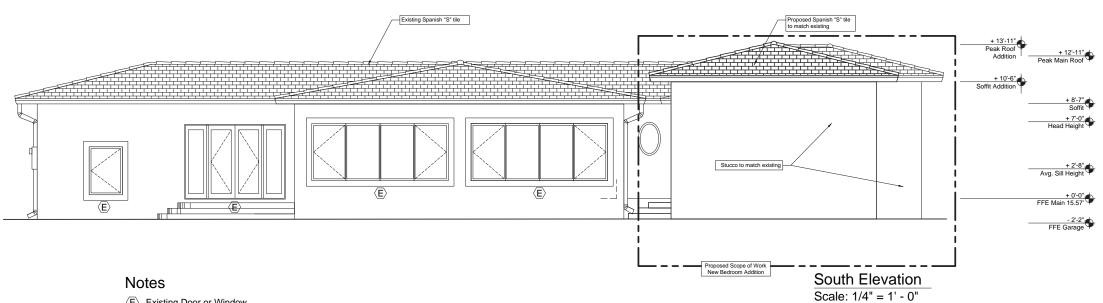

- ⟨E⟩ Existing Door or Window
- √ Existing Garage Vent

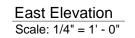

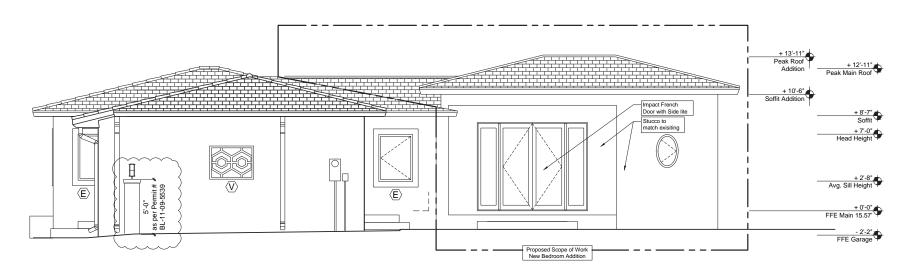

West Elevation
Scale: 1/4" = 1' - 0"

Notes

+ 8'-7" Soffit + 7'-0" Head Height

+ 2'-8" Avg. Sill Height


+ 0'-0" FFE Main 15.57"

FFE Garage

- (E) Existing Door or Window
- √ Existing Garage Vent

A-10

Proposed Elevations

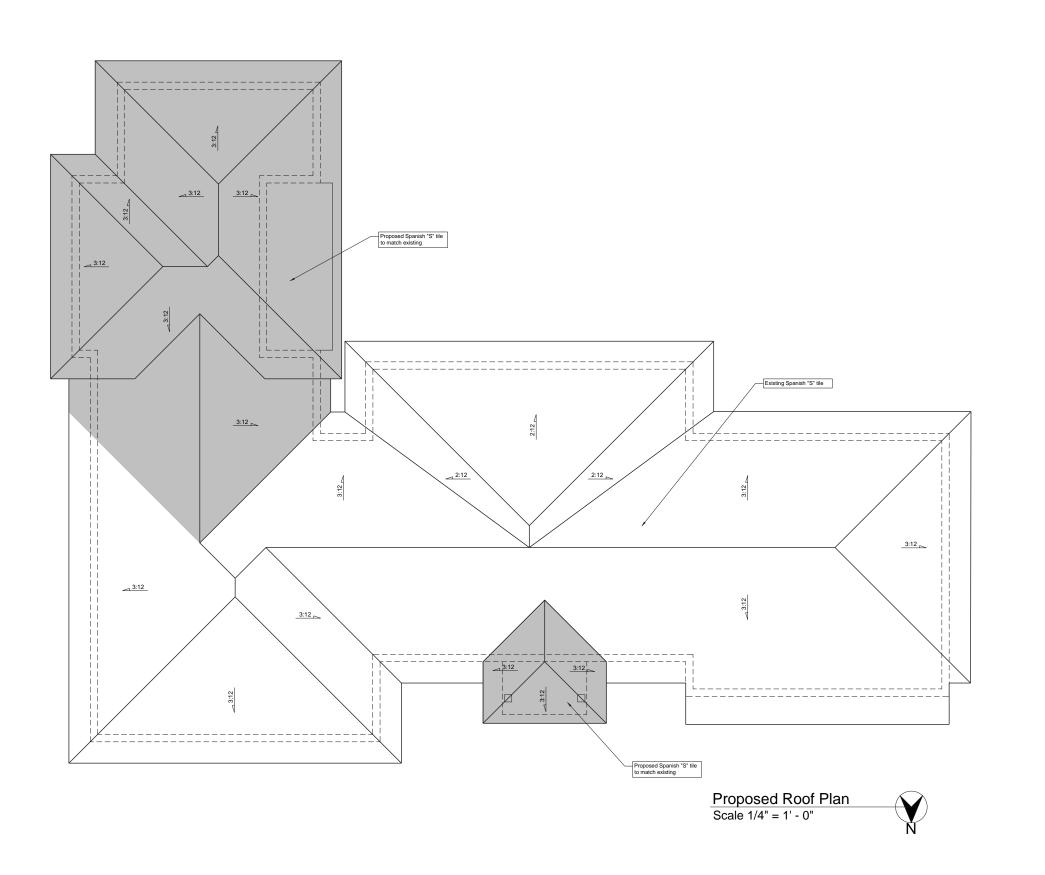



AA26004002

Miami Office Architect of Record 632 Candia Ave Coral Gables, Florida 33134 305.975.9035

rtapanes@realizationgroup.com

1522 Alegriano Avenue | Coral Gables, FL 33146 Lizama Residence

designed by:



Existing Front View




Proposed Front View



Existing Rear View



2 Proposed Rear View

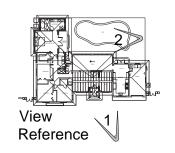




AA26004002


Miami Office Architect of Record 632 Candia Ave Coral Gables, Florida 33134 305,975,9035

rtapanes@realizationgroup.com

1522 Alegriano Avenue | Coral Gables, FL 33146 Lizama Residence

drawnby designed by:

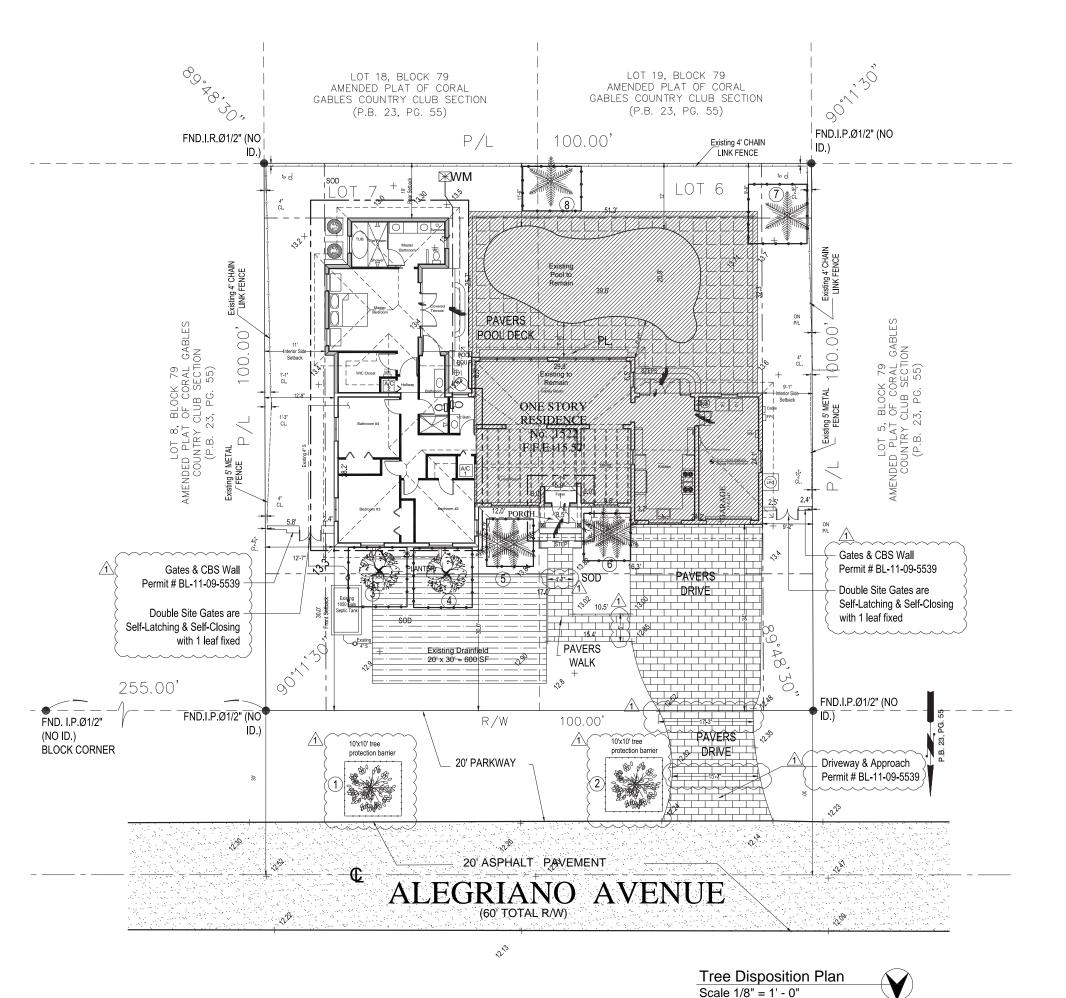

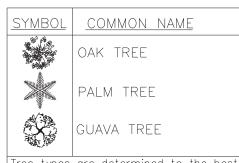

Tree types are determined to the best of our ability and should be confirmed by botanist or a trained specialist.

	TREE	TABLE		
No.	TREE NAME	DIAMETER	HEIGHT	SPREAD
1	OAK TREE	30"	30'	25'
2	OAK TREE	30"	30'	25'
3	TREE	7"	15'	10'
4	TREE	7"	15'	10'
5	2 PALM TREES	12"	15'	6'
6	2 PALM TREES	12"	15'	6'
7	PALM TREE	22"	20'	10'
8	PALM TREE	6"	25'	10'

Tree Protection Fence



AA26004002

Miami Office Architect of Record 632 Candia Ave Coral Gables, Florida 33134 305.975.9035

rtapanes@realizationgroup.com

33146 卍 Residence Gables, Coral Lizama Avenue

drawn by designed by:

Alegriano ,

Pre-BOA: Zoning cor 08-04-2021

L-01