Letter of Intent:

The San Vicente House is a Mediterranean-style patio home designed for the context of Coral Gables. It borrows from classic Mediterranean tropes (the atrium and courtyard, the representation of stone-focused materiality and the idea of a home designed for leisure and indoor-outdoor living). The home also functions as a creative and modern reiteration of the modern Mediterranean home, those mid-twentieth century villas that pioneered the functional-modern-amenity-laden Mediterranean home). Indeed, a Mediterranean architectural syntax was considered proto-modern in the early 20th century; the informal, functional, and climate-appropriate massing of this vernacular were prized by modernists. In all, the San Vicente House draws on earlier precedents yet offers a fresh interpretation of the patio home type.

The house is organized as two linear bars defining a series of courtyards between them. The front bar, comprising the living components of the home, is located behind a screen wall of oolitic rock, reiterating both its geological foundations and the tradition of oolitic rock in Coral Gables (found for example at the 1924 Venetian Pool and the adjacent 1936 Dean Parmelee Home). This front element identifies the house as more inwardly focused, while also screening the rear car port. The house opens more broadly toward the courts at the center, including a landscaped atrium. A velarium covers the outdoor dining area, dividing the landscaped atrium from the pool area. A drive court at the opposite end of the house allows recreational space and opens to the car port; it also provides a second entrance to the home.



AA26004002

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632 Candia Ave
Coral Gables, Florida 3313

rtananes@realizationgroup.com

Shulman+ Associates


Design Architect 100 NE 38th Street Miami, FL 33137 T 305.438.0609

Vicente Street Kesidence

date: 06-04-21
drawn by: S+A
designed by: S+A

San

revisions				
08-10-2021				

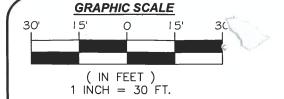

LEGAL DESCRIPTION:

LOTS 9, 10 AND 11, BLOCK 268, OF "REVISED PLAT OF CORAL GABLES RIMERA SECTION PART 11". ACCORDING TO THE PLAT THEREOF. AS RECORDED IN PLAT BOOK 28, AT PAGE 23, OF THE PUBLIC RECORDS OF MIAMI-DADE COUNTY, FLORIDA.

PROPERTY ADDRESS:

FOLIO NO. 03-4129-028-2360

6716 SAN VICENTE STREET. CORAL GABLES, FL 33146-3545

AREA OF PROPERTY: 15,750 SQUARE FEET AND/OR 0.362 ACRES MORE OR LESS.

CERTIFIED TO:

THIS BOUNDARY SURVEY HAS BEEN PREPARED FOR THE EXCLUSIVE USE OF THE ENTITIES NAME HEREON. THE CERTIFICATIONS DO NOT EXTEND TO ANY UNNAMED PARTIES.

- -LUIS ALEJANDRO ROJAS
- -MARIN, ELJAIEK, LOPEZ & MARTINEZ, P.L.
- -BRISAS LLC, A FLORIDA LIMITED LIABILITY COMPANY
- -FIRST AMERICAN TITLE INSURANCE COMPANY

SURVEYOR'S NOTES:

1.) THE ABOVE CAPTIONED PROPERTY WAS SURVEYED AND DESCRIBED BASED ON THE ABOVE LEGAL DESCRIPTION: PROVIDED BY CLIENT.

2.) THIS CERTIFICATION IS ONLY FOR THE LANDS AS DESCRIBED. IT IS NOT A CÉRTIFICATION OF TITLE, ZONING, EASEMENTS, OR FREEDOM OF ENCUMBRANCES. ABSTRACT NOT REVIEWED.

3.) THERE MAY BE ADDITIONAL RESTRICTIONS NOT SHOWN ON THIS BOUNDARY SURVEY THAT MAY BE FOUND IN THE PUBLIC RECORDS OF HIS COUNTY, EXAMINATION OF ABSTRACT OF TITLE WILL HAVE TO BE MADE TO DETERMINE RECORDED INSTRUMENTS, IF ANY AFFECTING THIS PROPERTY.

4.) ACCURACY: THE EXPECTED USE OF THE LAND, AS CLASSIFIED IN FLORIDA MINIMUM TECHNICAL STANDARDS (5J-17.51FAC), IS "RESIDENTIAL". THE MINIMUM RELATIVE DISTANCE ACCURACY FOR THIS TYPE OF BOUNDARY SURVEY IS 1 FOOT IN 7,500 FEET. THE ACCURACY OBTAINED BY MEASUREMENT AND CALCULATION OF A CLOSED GEOMETRIC FIGURE WAS FOUND TO EXCEED THIS REQUIREMENT.
5.) FOUNDATIONS AND/OR FOOTINGS THAT MAY CROSS BEYOND THE BOUNDARY LINES OF THE PARCEL HEREIN DESCRIBED ARE NOT SHOWN. TYPE OF SURVEY: BOUNDARY SURVEY

6.) TYPE OF SURVEY: BOUNDARY SURVET 7.) ELEVATIONS SHOWN HEREON ARE BASED ON TO THE NATIONAL GEODETIC

VÉRTICAL DATUM OF 1929 (N.G.V.D.29)

8.) ALL MEASUREMENTS ARE IN ACCORDANCE WITH THE UNITED STATES STANDARD U.S. FOOT 3.) CONTACT THE APPROPRIATE AUTHORITY PRIOR TO ANY DESIGN WORK ON

THE HEREIN DESCRIBED PARCEL FOR BUILDING AND ZONING INFORMATION. 10.) UNDERGROUND UTILITIES ARE NOT DEPICTED HEREON, CONTACT THE APPROPRIATE AUTHORITY PRIOR TO ANY DESIGN WORK OR CONSTRUCTION ON THE PROPERTY HEREIN DESCRIBED. SURVEYOR SHALL BE NOTIFIED AS TO ANY DEVIATION FROM UTILITIES SHOWN HEREON.

.) ENCUMBRANCES NOT SHOWN ON THE PLAT.

12.) THE WRITTEN CONSENT OF LANDMARK SURVEYING & ASSOCIATES, INC. UNDERGROUND PORTIONS OF FOOTING, FOUNDATIONS OR OTHER IMPROVEMENTS WERE NOT LOCATED.

13.) ONLY VISIBLE AND ABOVE GROUND ENCROACHMENTS LOCATED. 14.) WALL TIES ARE TO THE FACE OF THE WALL. 15.) FENCE OWNERSHIP NOT DETERMINED.

16.) BASIS OF BEARINGS REFERENCED TO LINE NOTED AS B.B.

17.) BOUNDARY SURVEY MEANS A DRAWING AND/OR GRAPHIC REPRESENTATION OF THE SURVEY WORK PERFORMED IN THE FIELD.

18.) NO IDENTIFICATION FOUND ON PROPERTY CORNERS UNLESS NOTED. 19.) THE SOURCES OF DATA USED FOR THE PREPARATION OF THIS BOUNDARY SURVEY IS "REVISED PLAT OF CORAL GABLES RIVIERA SECTION PART 11" RECORDED IN PLAT BOOK 28, AT PAGE 23.

) THIS MAP OF SURVEY IS INTENDED TO BE DISPLAYED AT A SCALE OF ONE INCH EQUALS 30 FEET OR SMALLER.

MAP OF BOUNDARY SURVEY



	TREE CHART						
NO.	COMMON NAME	DBH IN FEET	HEIGHT IN FEET	SPREAD IN FEET			
1	TREE	3.0	30.0	35.0			
2	PALM	1.0	25.0	10.0			
3	PALM	1.0	30.0	10.0			
4	PALM	1.0	20.0	10.0			
5	PALM	0.4	15.0	5.0			
6	PALM	1.5	15.0	10.0			
7	(5)PALM	0.4	20.0	5.0			
8	PALM	1.0	20.0	10.0			
9	PALM	2.5	35.0	15.0			
10	(2)PALM	0.4	10.0	5.0			
11	TREE	5.0	40.0	40.0			
12	PALM	1.0	10.0	5.0			
13	(2)PALM	1.0	10.0	5.0			
14	(5)PALM	0.4	20.0	5.0			
15	(2)PALM	0.4	15.0	5.0			
16	(2)PALM	1.0	15.0	5.0			
17	TREE	5.0	35.0	25.0			
18	TREE	1.0	20.0	20.0			

N-1 = A PORTION OF THE CHAIN LINK FENCE ALONG THE WEST BOUNDARY LINE, FALL OUTSIDE THE PROPERTY LINE.

LOCATION MAP

11 PL

VICENTE

OT REEL

ARTURO MENDICUTIA, P.S.M.

ARTURO MENDICUTIA, P.S.M.

P.S.M. NO. 5844—STATE OF FLORIDA

NOT VALID WITHOUT THE SIGNATURE AND THE ORIGINAL RAISED SEAL OF A FLORIDA

LICENSED SURVEYOR AND MAPPER. ADDITIONS OR DELETIONS TO SURVEY MAPS OR

REPORTS BY OTHER THAN THE SIGNING PARTY OR PARTIES IS PROHIBITED WITHOUT

WRITTEN CONSENT OF THE SIGNING PARTY OR PARTIES AND/OR NOT VALID WITHOUT AN AUTHENTIC ELECTRONIC SIGNATURE AND AUTHENTICATED ELECTRONIC SEAL.

FOR THE FIRM

SECTION 29, TOWNSHIP 54 SOUTH, RANGE 41 EAST LYING AND BEING IN DADE COUNTY FLORIDA (NOT TO SCALE)



1435 S.W. 87th AVENUE, SUITE "201" MAMI, FL 33174 PHONE: (305) 556-4002 FAX: (305) 556-4003 WWW.LMSURVEYING.COM EMAIL-REQUEST@LMSURVEYING.COM

SURVEYING & ASSOCIATES, INC LB No. 7633 PROFESSIONAL SURVEYORS AND MAPPERS

ABBREVIATIONS AND LEGEND:

=DENOTES AIR CONDITIONING UNIT
=DENOTES BASIS OF BEARINGS =DENOTES ASPHALT
=DENOTES PROPERTY LINE
=DENOTES PROPERTY LINE =DENOTES BENCH MARK
=DENOTES CONCRETE BLOCK STUCCO
=DENOTES CONCRETE
=DENOTES LIGHT POLE
=DENOTES CATCH BASIN
=DENOTES CENTERLINE
=DENOTES MONUMENT LINE
=DENOTES LAKE & MAINTENANCE
EASEMENT PARTIES FACELIERS
=DENOTES DRAINAGE EASEMENT =DENOTES DRILL HOLE
=DENOTES MEASURE
=DENOTES RECORD
=DENOTES WOOD POWER POLE
=DENOTES UTILITY EASEMENT
=DENOTES PLAT BOOK
=DENOTES PAGE =DENOTES PERMANENT CONTROL
POINT
=DENOTES POINT OF BEGINNING
=DENOTES TYPICAL
=DENOTES MEAN HIGH WATER LINE
=DENOTES WOOD FENCE
=DENOTES CHAIN LINK FENCE
=DENOTES IRON FENCE
=DENOTES FOUND IRON PIPE (NO ID.)
=DENOTES FOUND NAIL AND DISC
=DENOTES ASPHALT PAVEMENT
=DENOTES ELEVATIONS
=DENOTES BRICK

ALL BEARINGS AND DISTANCES SHOWN HEREON ARE RECORD AND MEASURED UNLESS OTHERWISE NOTED.

=DENOTES CONCRETE PAD

20					
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	OUND	ELEVATI	ON:	١	I/A
SURVEYOR'S CERTIFICATION: I HEREBY CERTIFY TO THE BEST OF MY KNOWEDGE AND BELIEF THAT THIS "MAP OF BOUNDARY SURVEY" IS	BC	DATE		AWN BY	SCALE
A TRUE AND CORRECT REPRESENTATION OF A SURVEY PREPARED UNDER MY DIRECTION. THAT IT MEETS THE STANDARDS OF PRACTICE AS SET FORTH BY THE STATE OF FLORIDA BOARD OF PROFESSIONAL LAND SURVEYORS IN CHAPTER 5J-17.050 THROUGH	OF	09-10-2020	J.F	EE	1"=30"
50-17.052 OF THE FLORIDA ADMINISTRATIVE/CODE AND ITS IMPLEMENTING LAW, PURSUANT TO CHAPTER 42.02, FLORIDA STATUTE.	PC	REVISION /	UPD	ATE OF	SURVEY
SCNED Churchelight FOR THE FIRM	A	DATE	T	DESCR	IPTION '

N/A

JOB No.

2009.0047



San Vicente Street Residence

Coral Gables

6716 San Vicente Street | Coral Gables, FL 33146

06.12.2021



New Single Family Residence



Location Map n.t.s.

Board of Architects Preliminary Approval Application June 12, 2021

A-00 COVER

A-01 ZONING LEGEND & DESIGN CONCEPT

A-02 DIAGRAMS & L.O.I

A-03 CONTEXT PHOTOS A-04 DEMOLITION PLAN

A-05 SITE PLAN

A-06 OVERALL FLOOR PLAN

A-07 FLOOR PLAN (PARTIAL) A-08 FLOOR PLAN (PARTIAL)

A-09 ROOF PLAN

A-10 OVERALL ELEVATIONS

A-11 FRONT ELEVATION A-12 REAR ELEVATION

A-13 SIDE ELEVATIONS A-14 SECTIONS

A-15 MATERIALITY & RENDERINGS

EXISTING LANDSCAPE PLAN

L-02 TREE DISPOSITION PLAN

Realization Group

AA26004002

Miami Office Coral Gables, Florida 33134

Shulman+ **Associates**

Design Architect

Mr. Luis Rojas

6716 San Vicente Street Coral Gables, FL 33146

Rafael Tapanes Architect of Record:

Owner:

The Realization Group, Inc

632 Candia Ave Coral Gables, FL 33134 305.284.7325

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Allan Shulman Design Archtiect:

Shulman + Associates 100 NE 38 Street Miami, FL 33137 305.438.0609

shulman-design.com AA26001090

MEP Engineer: Guerrero / Gonzalez

Engineers

780 Tamiami Canal Rd,

Miami, FL 33144 305.262.3944

Structural Engineer: HTH Engineers

8201 NW 64th St Miami, FL 33166

786.612.4017

A-00


Board of Architects | 2021

date: 06-04-21

08-10-2021

drawn by: S+A


designed by: S+A

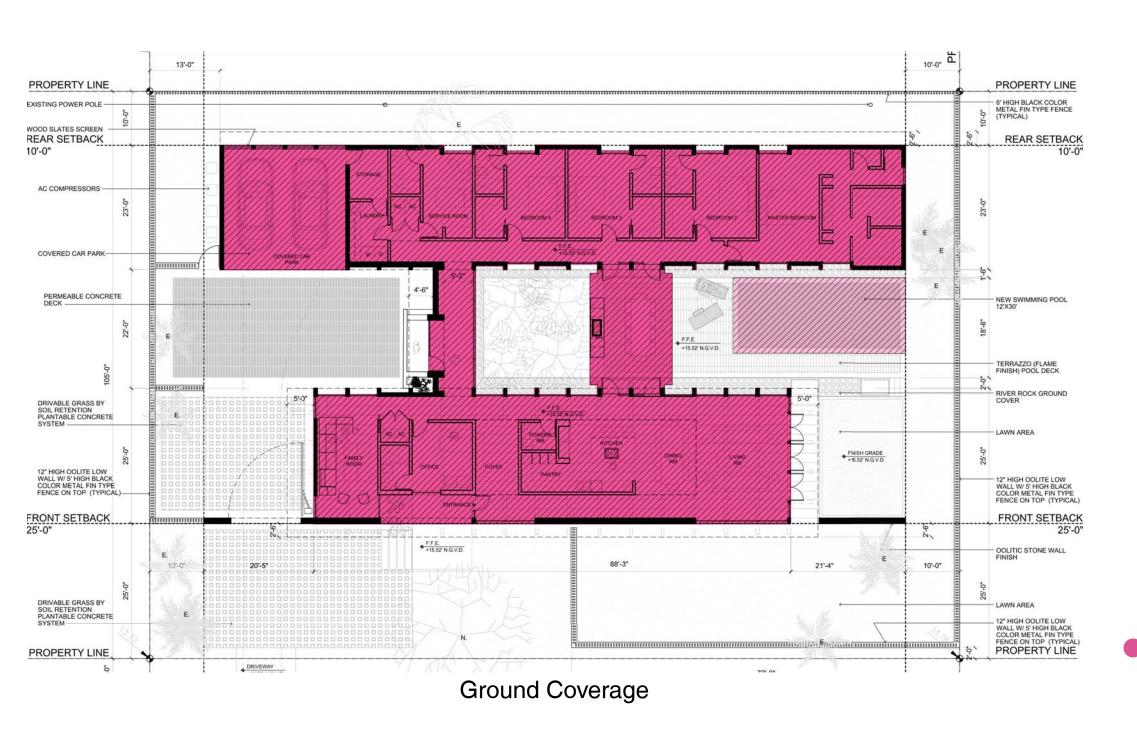

PROPERTY LINE PROPERTY LINE 6' HIGH BLACK COLOR METAL FIN TYPE FENCE (TYPICAL) EXISTING POWER POLE — WOOD SLATES SCREEN — REAR SETBACK 10'-0" REAR SETBACK 10'-0" AC COMPRESSORS -COVERED CAR PARK-PERMEABLE CONCRETE DECK — TERRAZZO (FLAME FINISH) POOL DECK DRIVABLE GRASS BY SOIL RETENTION PLANTABLE CONCRETE SYSTEM 12" HIGH OOLITE LOW WALL W/ 5' HIGH BLACK COLOR METAL FIN TYPE FENCE ON TOP (TYPICAL) FRONT SETBACK 25'-0" FRONT SETBACK 25'-0" PROPERTY LINE

Floor Area Ratio

DRIVEWAY +13.52' N.G.V.D.

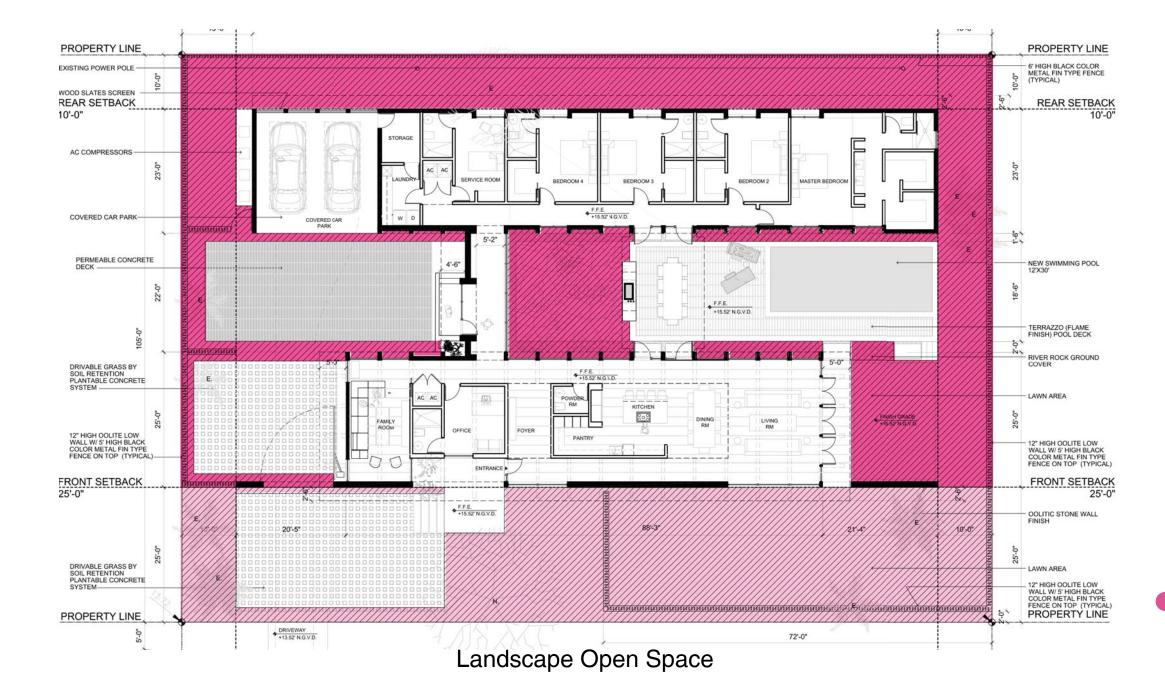


MAX. GROUND COVERAGE ALLOWED FOR MAIN BUILDING = 35% = 5,512 SF MAX. GROUND COVERAGE FOR MAIN BUILDING+ AUXILIARY STRUCTURES = 45% = 7,087 SF PROPOSED GROUND COVERAGE FOR MAIN BUILDING= 5,488 SF

PROPOSED GROUND COVERAGE FOR MAIN BUILDING + AUXILIARY STRUCTURE = 5,936 SF

MAX.FLOOR AREA RATIO ALLOWED = 5,875 SF PROPOSED FLOOR AREA RATIO = 4,667 SF

MIN. LANDSCAPED OPEN SPACE REQUIRED = 40% BUILDING SITE = 6,300 SF MIN. LANDSCAPED OPEN SPACE REQUIRED IN FRONT YARD= 20% OF THE 40% = 1,260 SF + PROPOSED LANDSCAPED OPEN SPACE ON BUILDING SITE = 6,801 SF PROPOSED LANDSCAPED OPEN SPACE IN FRONT YARD = 2,837 SF

Zoning: SFR - Single-Family Residential	Required / Allowed	Existing	Proposed
Lot occupation			
a. Lot area (sf)	15,750 SF (as per survey)	15,750 SF	15,750 SF
b. Lot width	50 FT min.	150 FT	150 FT
c. Ground area coverage (Article 4. 4-7)	7,087 sf max. (Main bulding + Accessory)		5,936 SF
	Max. for Main Building = 35% = 5,512 SF		5,488 SF
	Max for Auxiliary Structures = 1,571 SF		448 SF
d. Floor Area	5,875 sf max.		4,667 SF
5,000 SF or less - 48%	$5,000 \times 48\% = 2,400 \text{ sf}$		
Next 5,000 SF - 35%	$5,000 \times 35\% = 1,750 \text{ sf}$		
Remainder of the building site area - 30%	5,750 x 30% = 1,725 sf		
e. Density	One (1) principal building		1 Principal Building
Building setbacks			
a. Front setback	25 ft		25 ft.
b. Side setback			10 ft.
b.1 - Interior side	15 ft. (20% of the total lot width, with a combined maximum of 20 feet shall be equal on both sides)		
b.2-Side street	15 feet.		
c. Rear	10 ft. If compatible with neighborhood character, the Board may recommend varicances to allow a rear setback of 5 feet.		10 ft.
Building height			
a Maximum halant	2 Stories or 25 feet. Measured from finish floor to the tie-beam on the to floor of thirty (30) inches.	16'-6"	
Parking requirements			
a. Single Family	One (1) parking space consisting of a roofed structure, which utilized the principle structure and that is a garage, carport, or porte-cochere.	2 spaces	
Landscape requirements			
a. Landscape Open Space	All buildings shall provide landscaped open space of not less than forty the building site. At least twenty (20%) percent of the required forty (40° space shall be located in the front yard area	6,801 ft	
	Minimum Required Landscaped Open Space = 40% = 6,300 SF		6,801 ft
Minimum Required Landscape Open Space on Front yard 20% of 40% = 1,260 SF			2,837 ft

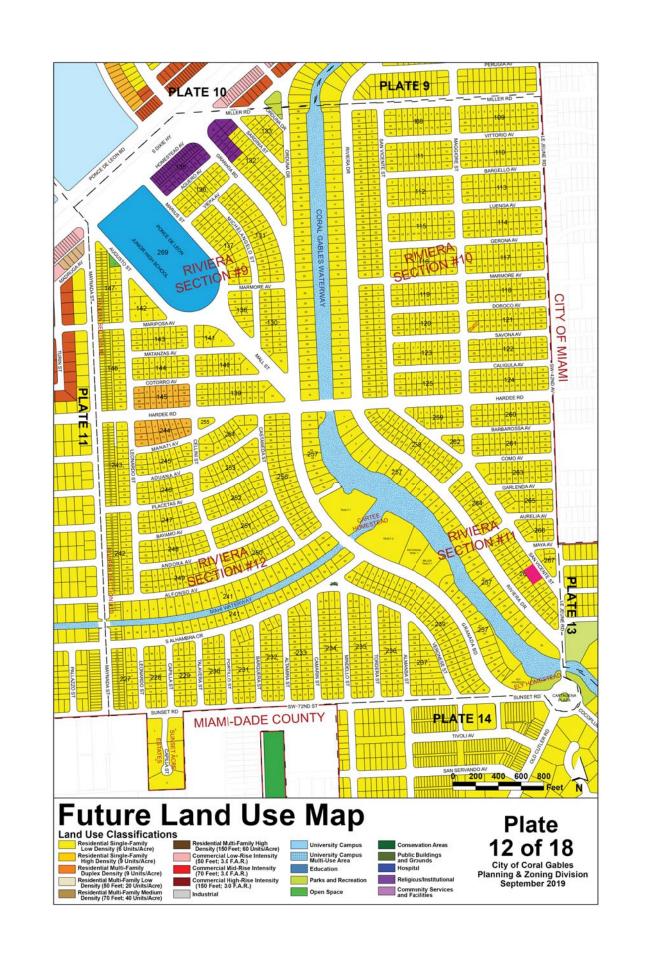



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Vic

d a t e: 06-04-21 drawn by: S+A

designed by: S+A

San

revisions 08-10-2021

A-01

d a t e: 06-04-21

08-10-2021

A-02

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designed by: S+A

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Coral Gables, Florida 33134

The San Vicente House is a Mediterranean-style patio home designed for the context of Coral Gables. It borrows from classic Mediterranean tropes (the atrium and courtyard, the representation of stonefocused materiality and the idea of a home designed offers a fresh interpretation of the patio home type. for leisure and indoor-outdoor living). The home also functions as a creative and modern reiteration of the modern Mediterranean home, those mid-twentieth century villas that pioneered the functional-modernamenity-laden mediterranean home). Indeed, a Mediterranean architectural syntax was considered

proto-modern in the early 20th century; the informal, functional, and climate-appropriate massing of this vernacular were prized by modernists. In all, the San Vicente House draws on earlier precedents yet

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of oolitic rock in Coral Gables (found for example at the 1924 Venetian Pool and the adjacent 1936 Dean Parmelee Home). This front element identifies the house as more inwardly focused, while also screening the rear car port. The house opens more broadly toward the courts at the center, including a landscaped atrium. A velarium covers the outdoor dining area, dividing the landscaped atrium from the pool area. A drive court at the opposite end of the house allows recreational space and opens to the car port; it also provides a second entrance to the home.




















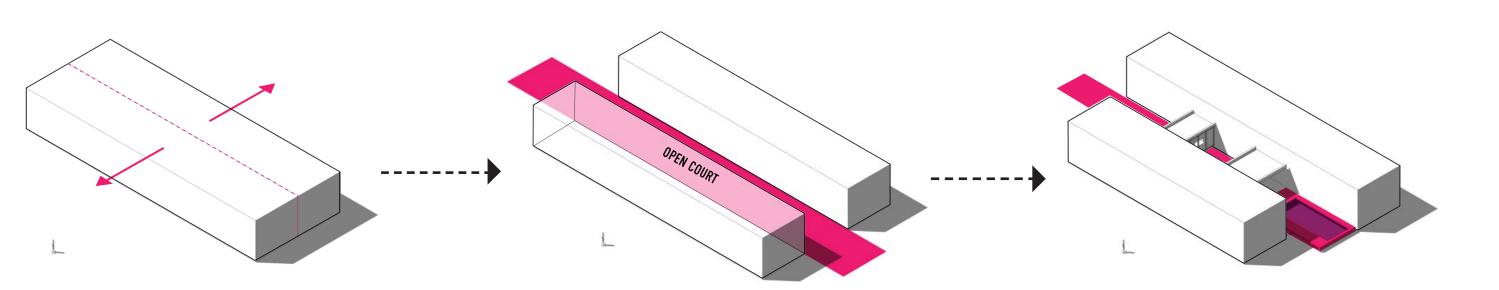

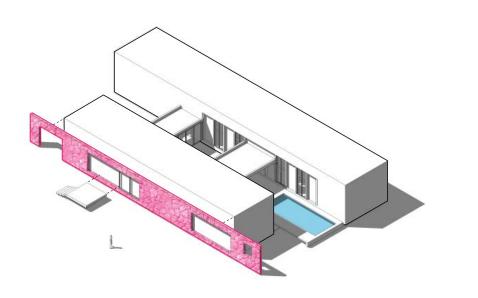

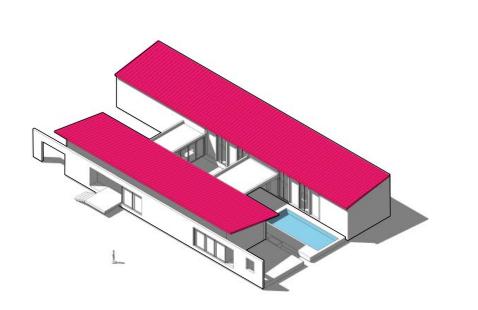

OOLITE WALL SCREEN ALONG STREET

HOME DIVIDED TO PROVIDE OPEN COURTYARD (BI-NUCLEAR SCHEME)

COURT DIVIDED TO PROVIDE PATIOS

ATRIUM TYPE ROOFS















Realization

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08-10-2021


designed by: S+A


A-03





Context Photos of Neighbors

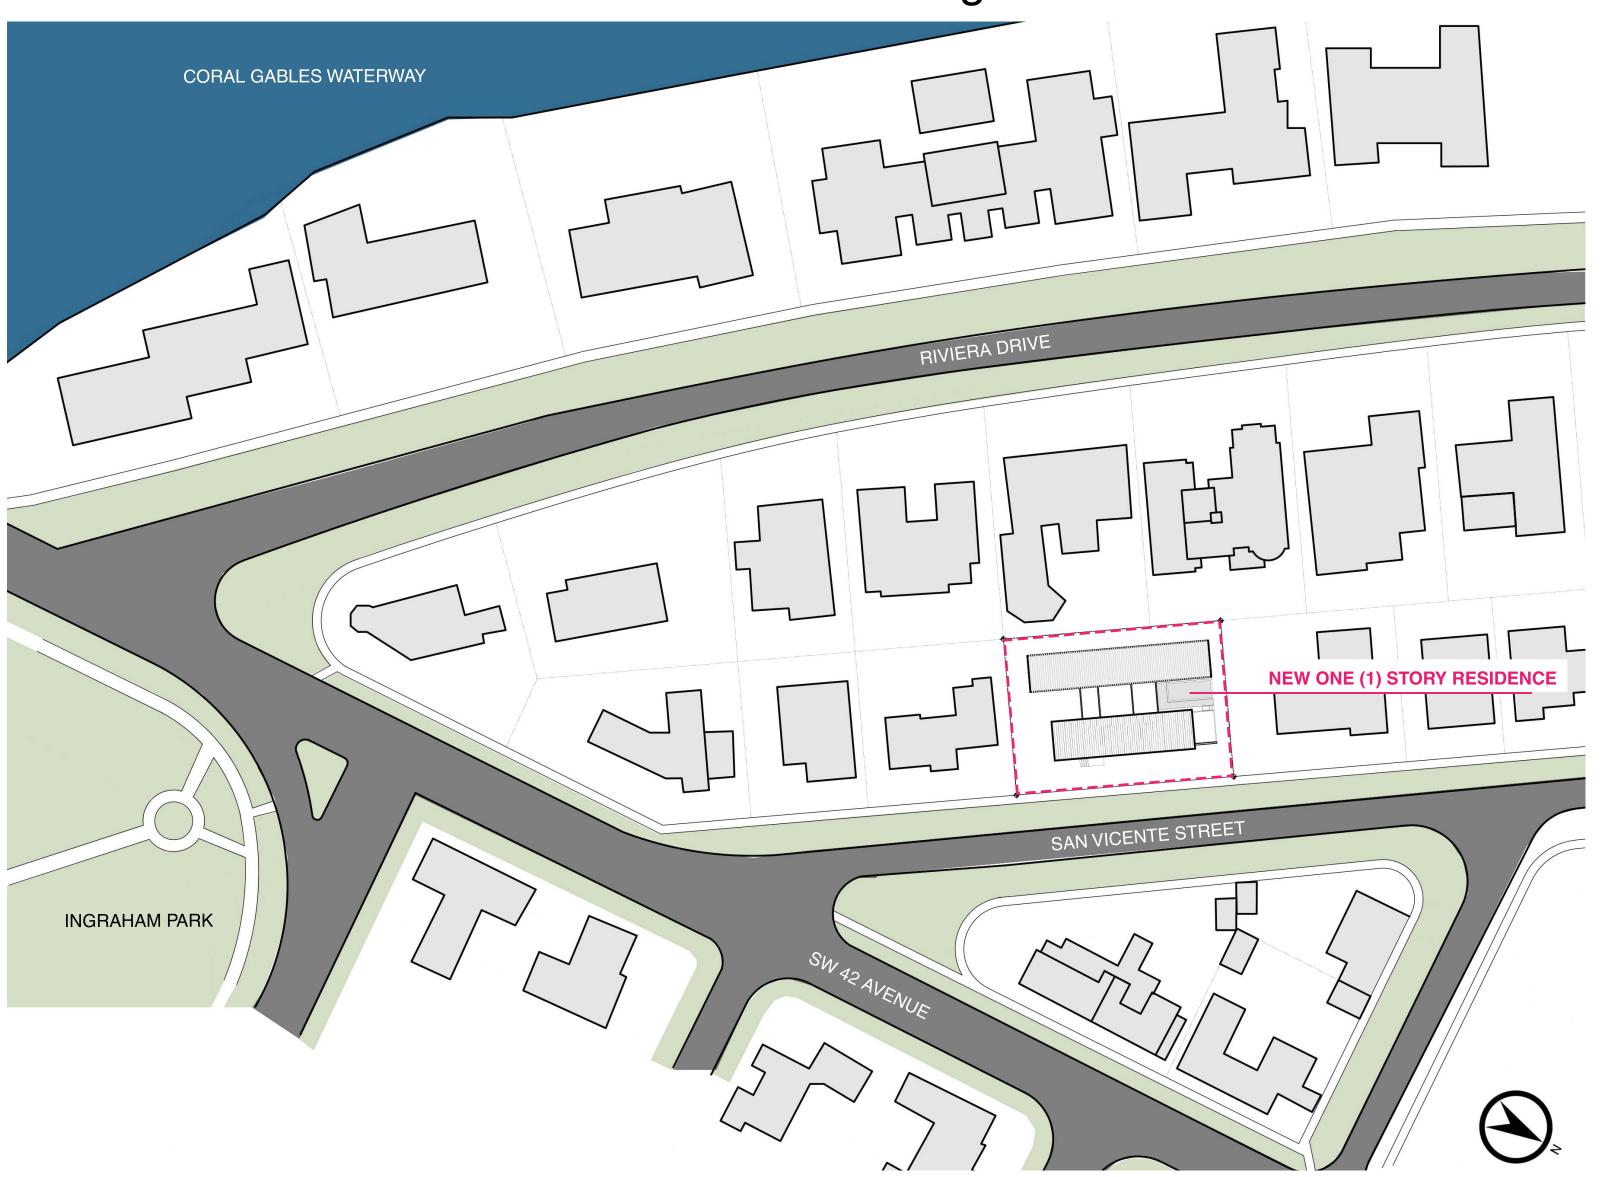

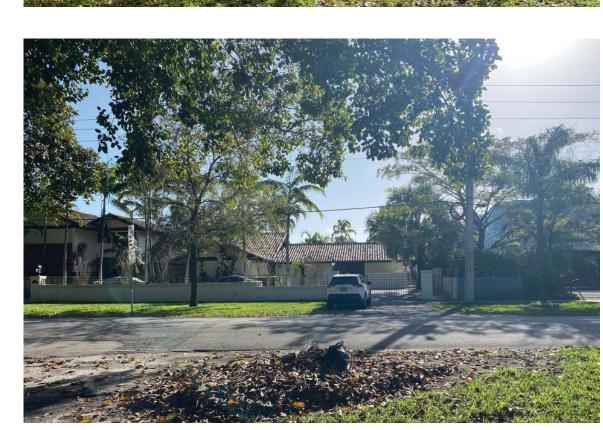











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Vicente San

d a t e: 06-04-21 drawn by: S+A designed by: S+A

revisions 08-10-2021

A-04

Existing Site Plan | Demo Plan

Scale: NTS

PROPERTY OWNER TO EXCAVATE, DE-COMPACT, REGRADE TO A CONCAVE PROFILE TO RETAIN WATER RUNOFF, THEN Max. Ground Coverage allowed (Main bldg): 5,513 sf REPLANT WITH SOD OR OTHER NON-WOODY Max. Ground Coverage allowed (Main bldg + auxiliary): 7,087 sf GROUNDCOVERS THAT WILL BE MAINTAINED BY THE PROPERTY OWNER Proposed Ground Coverage for Main Building (carport included): 5,505 sf LESS THAN 24" IN HEIGHT AT THE END OF 13'-0" PROPERTY LINE PROPERTY LINE 6' HIGH BLACK COLOR METAL FIN TYPE FENCE (TYPICAL) **EXISTING POWER POLE** WOOD SLATES SCREEN REAR SETBACK 10'-0" REAR SETBACK 10'-0" AC COMPRESSORS BEDROOM 4 BEDROOM 2 POOL EQUIPMENT 6' TALL SELF CLOSING-SELF F.F.E. +15.52' N.G.V.D. 1 (CAR PORT) LATCHING GATE CONCRETE PAVING **NEW SWIMMING POOL** (14B) SHADED AREA REPRESENTS +15.52' N.G.V.D. 2B TERRAZZO (FLAME FINISH) POOL DECK CONCRETE BAND PAVING AT DRIVEWAY – RIVER ROCK GROUND PERMEABLE CONCRETE PAVERS DRIVEWAY BY LAWN AREA POWDER SOIL RETENTION INC. KITCHEN FINISH GRADE +15.52 N.G.V.D. 12" HIGH OOLITE LOW RM WALL W / BLACK COLOR ALUMINUM FIN TYPE (STUDY FOYER 12" HIGH OOLITE LOW WALL W/ 5' HIGH BLACK FENCE ON TOP (TYPICAL)-6' TOTAL **COLOR METAL FIN TYPE** FENCE HÉIGHT -FENCE ON TOP (TYPICAL) | ENTRANCE | FRONT SETBACK FRONT SETBACK 25'-0" 25'-0" CONCRETE BAND
PAVING AT DRIVEWAY ~~~~~ ◆ F.F.E. +15.52' N.G.V.D. DRIVEWAY OOLITIC STONE CLAD) +13.52' N.G.V.D. WALL FINISH - THIS SEGMENT OF THE WALL 88'-3" 20'-5" SCREENS THE POOL PERMEABLE CONCRETE PAVERS DRIVEWAY BY $_{ au}$ SOIL RETENTION INC. ر LAWN AREA CONCRETE BAND 12" HIGH OOLITE LOW WALL PAVING AT DRIVEWAY W / BLACK COLOR (AND WALKWAY — 🔑 ALUMINUM FIN TYPE FENCE ON TOP (TYPICAL)-6' TOTAL (10' x 10'\ FENCE HÈIGHT Visibility PROPERTY LINE PROPERTY LINE Triangle 5' WIDE CONCRETE 5' WIDE CONCRETE SIDEWALK 72'-0" SIDEWALK _ SHADED AREA 13'-8" 11'-0" REPRESENTS WALKWAY TO SIDEWALK DRIVEWAY +13.52' N.G.V.D. CENTER LINE

Site Plan
Scale 1/8" = 1' - 0"



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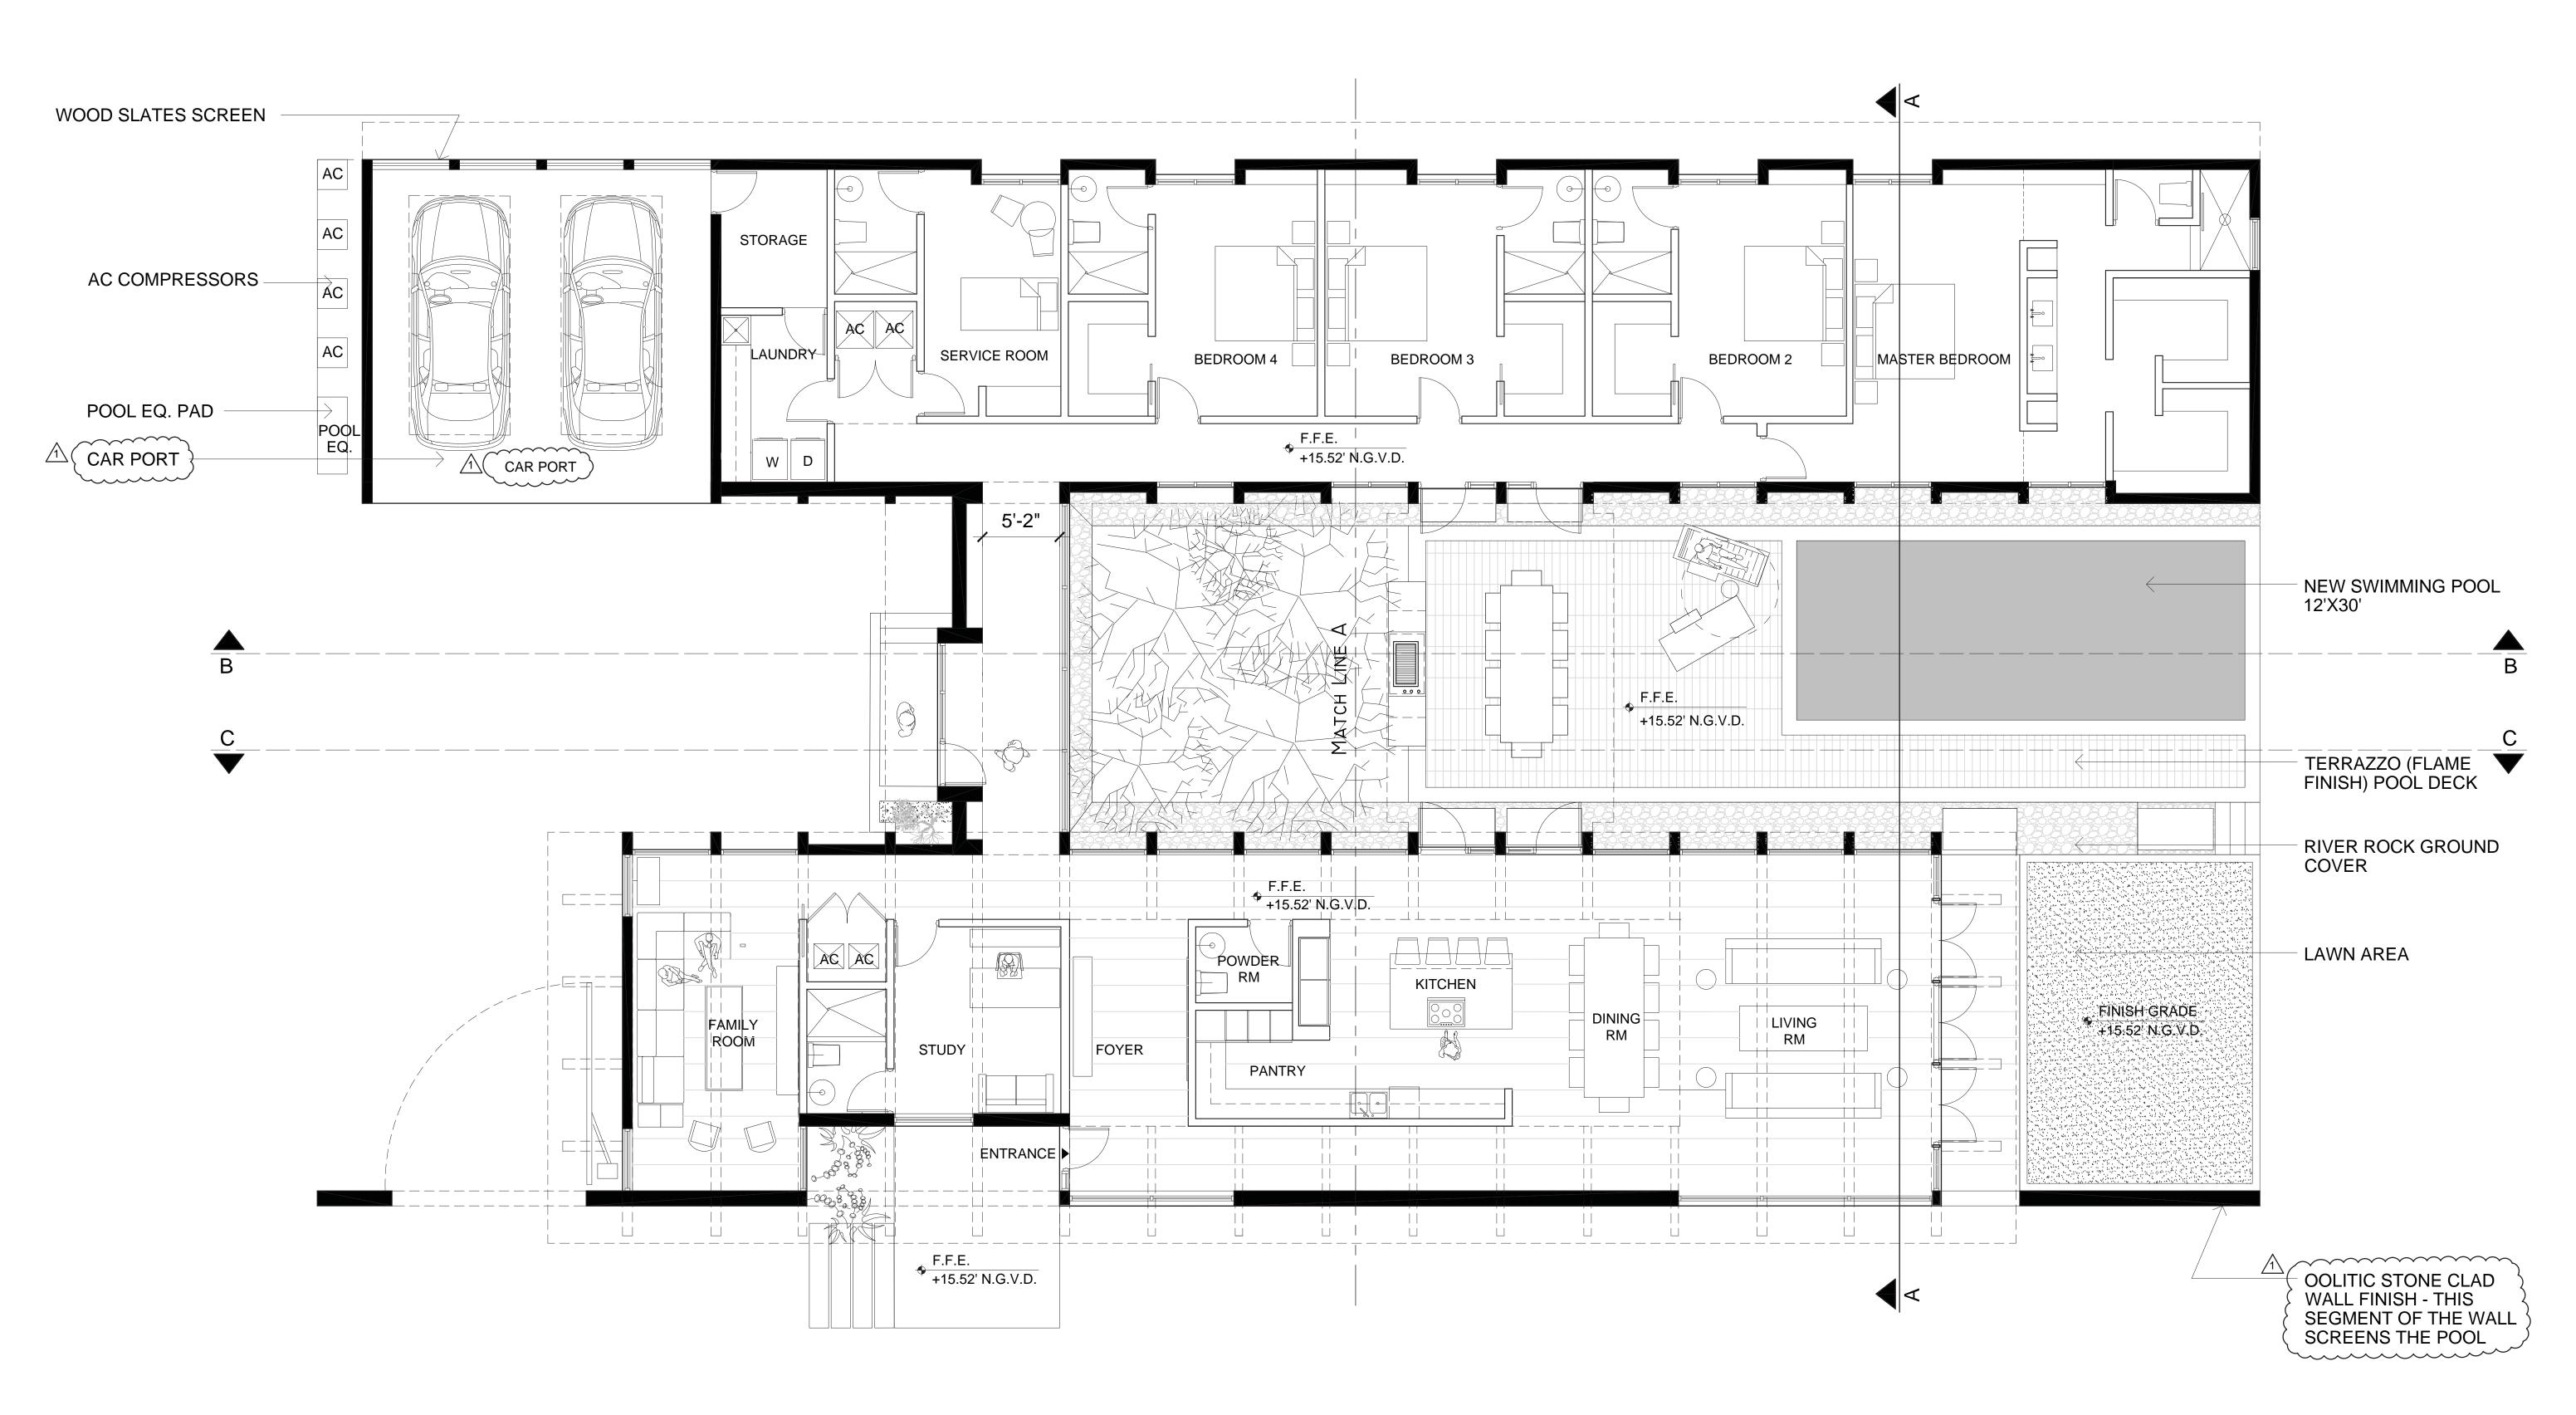
an Vicente Street Residenc

date: 06-04-21
drawn by: S+A
designed by: S+A

revisions

08-10-2021

A-05



Realization Group

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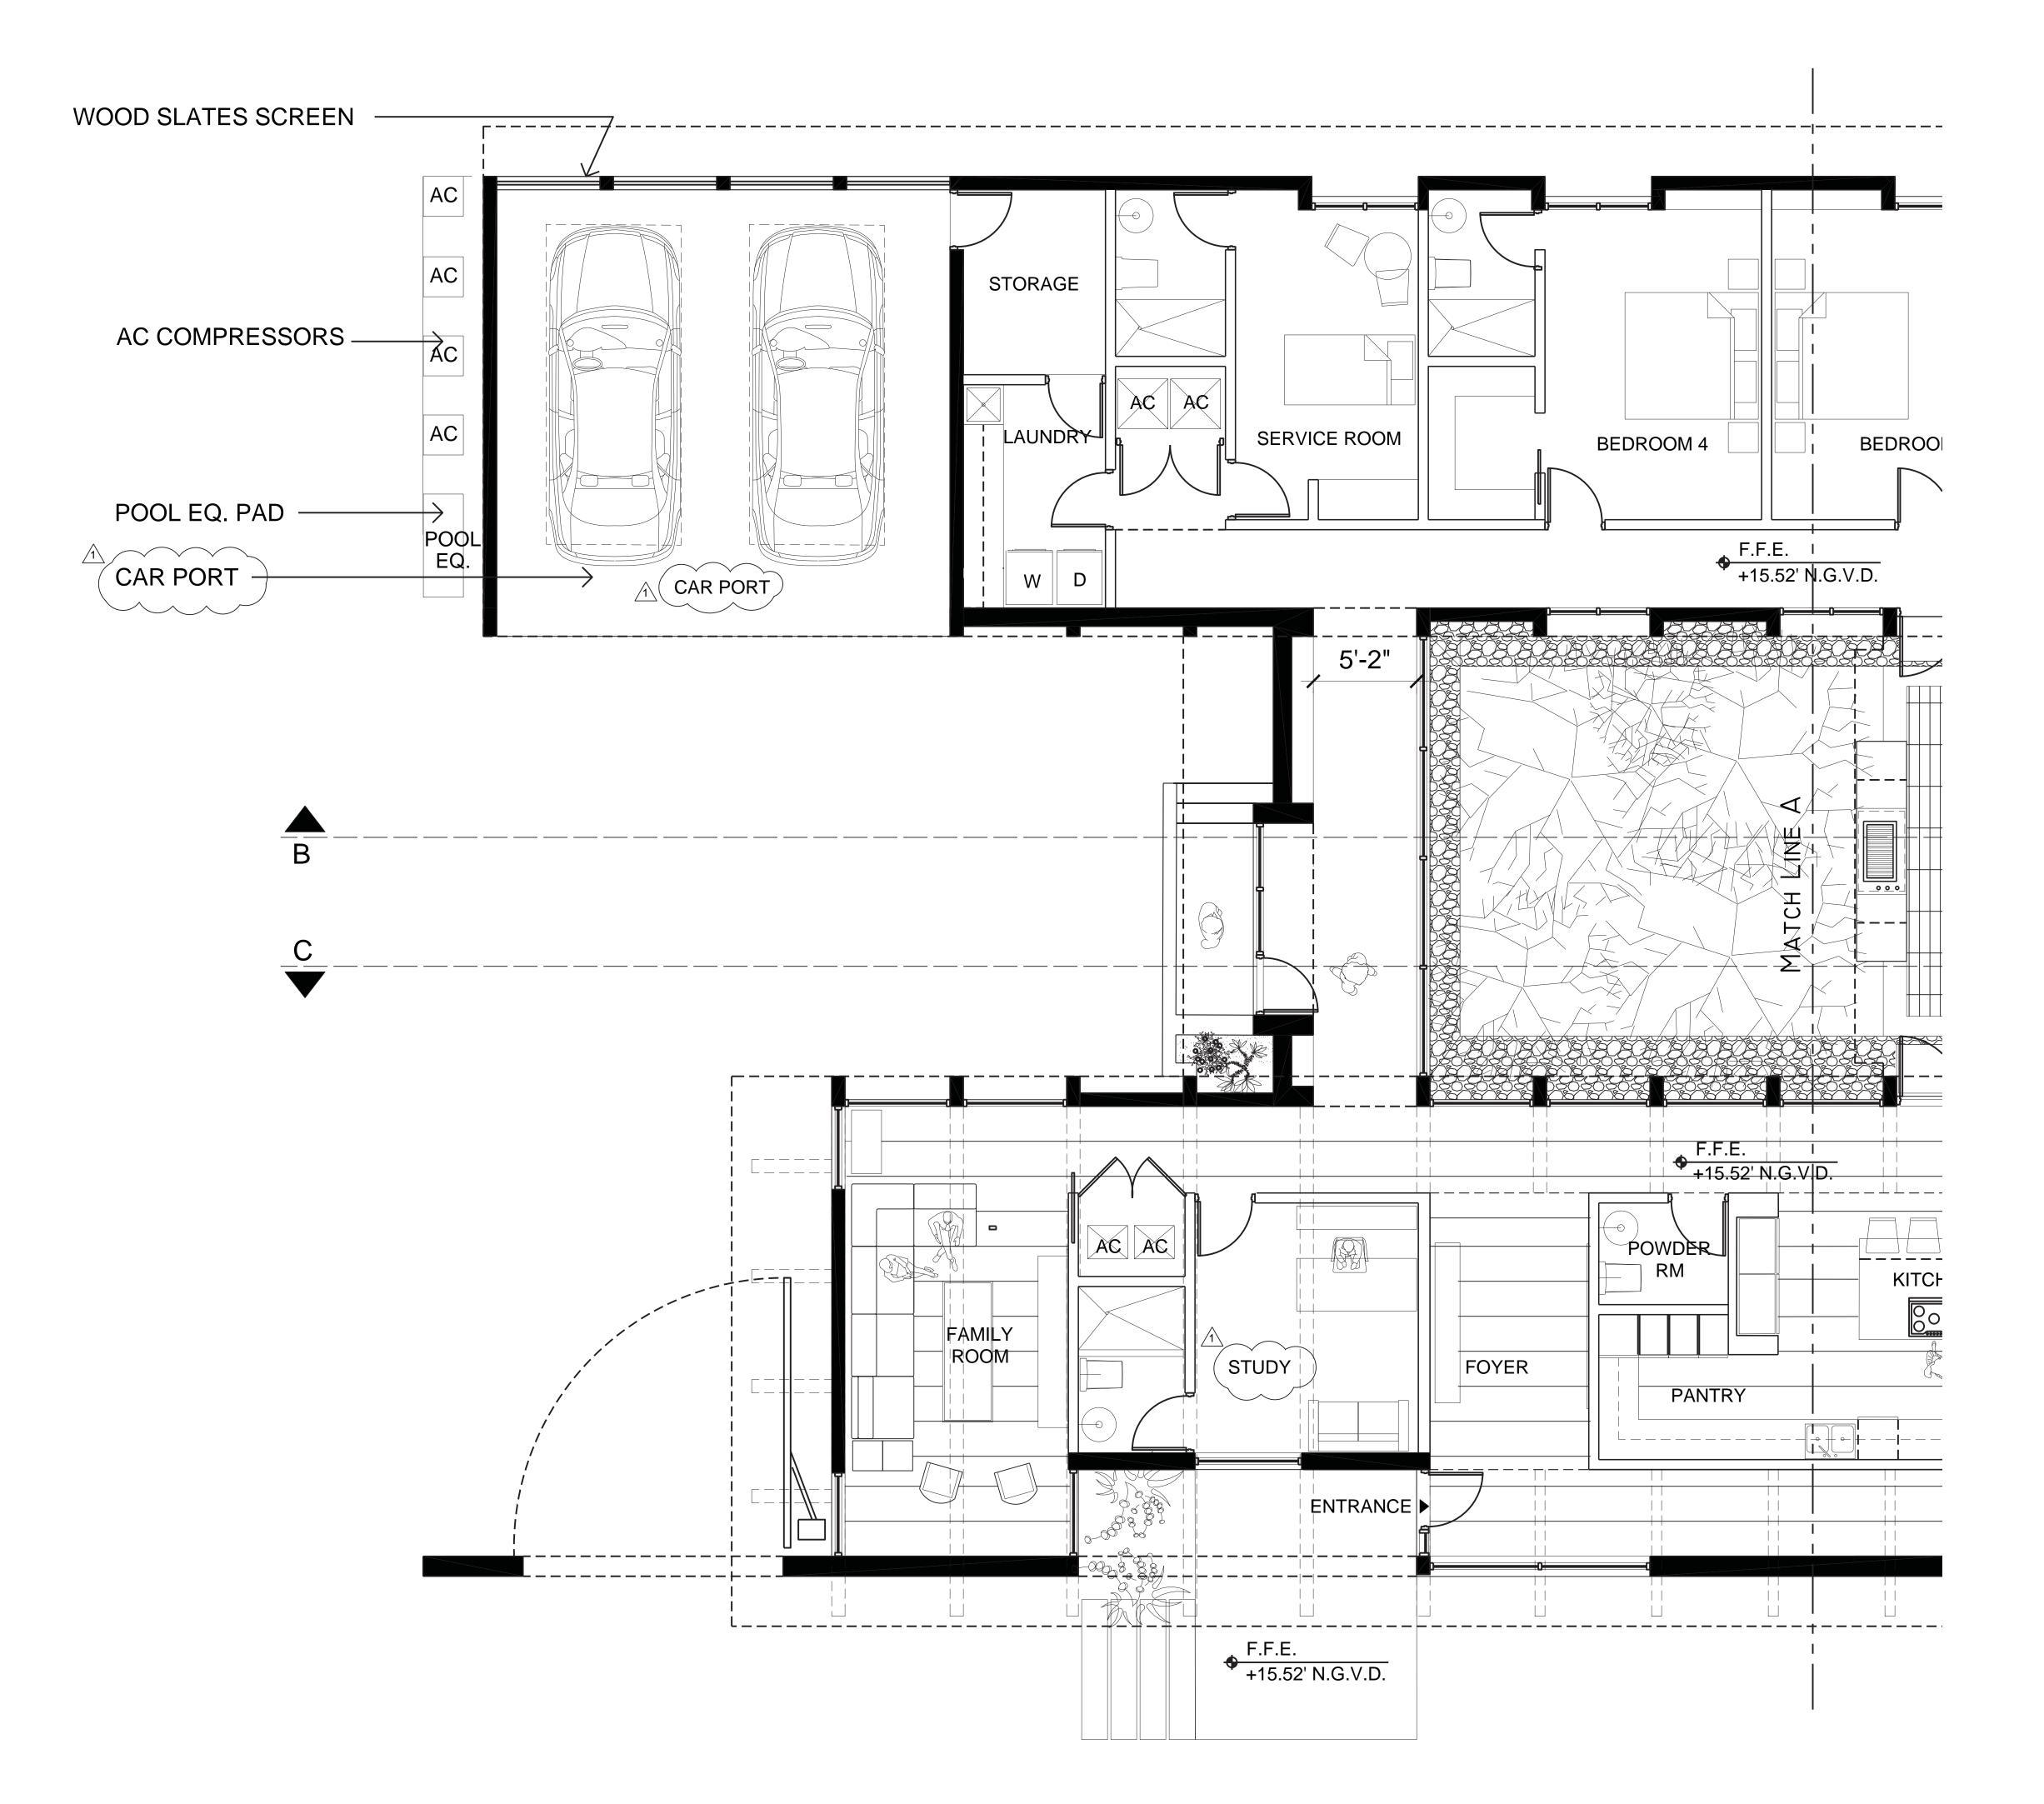
d a t e: 06-04-21 drawn by: S+A designed by: S+A

revisions 08-10-2021

A-06

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Overall Floor Plan Scale 3/16" = 1' - 0"



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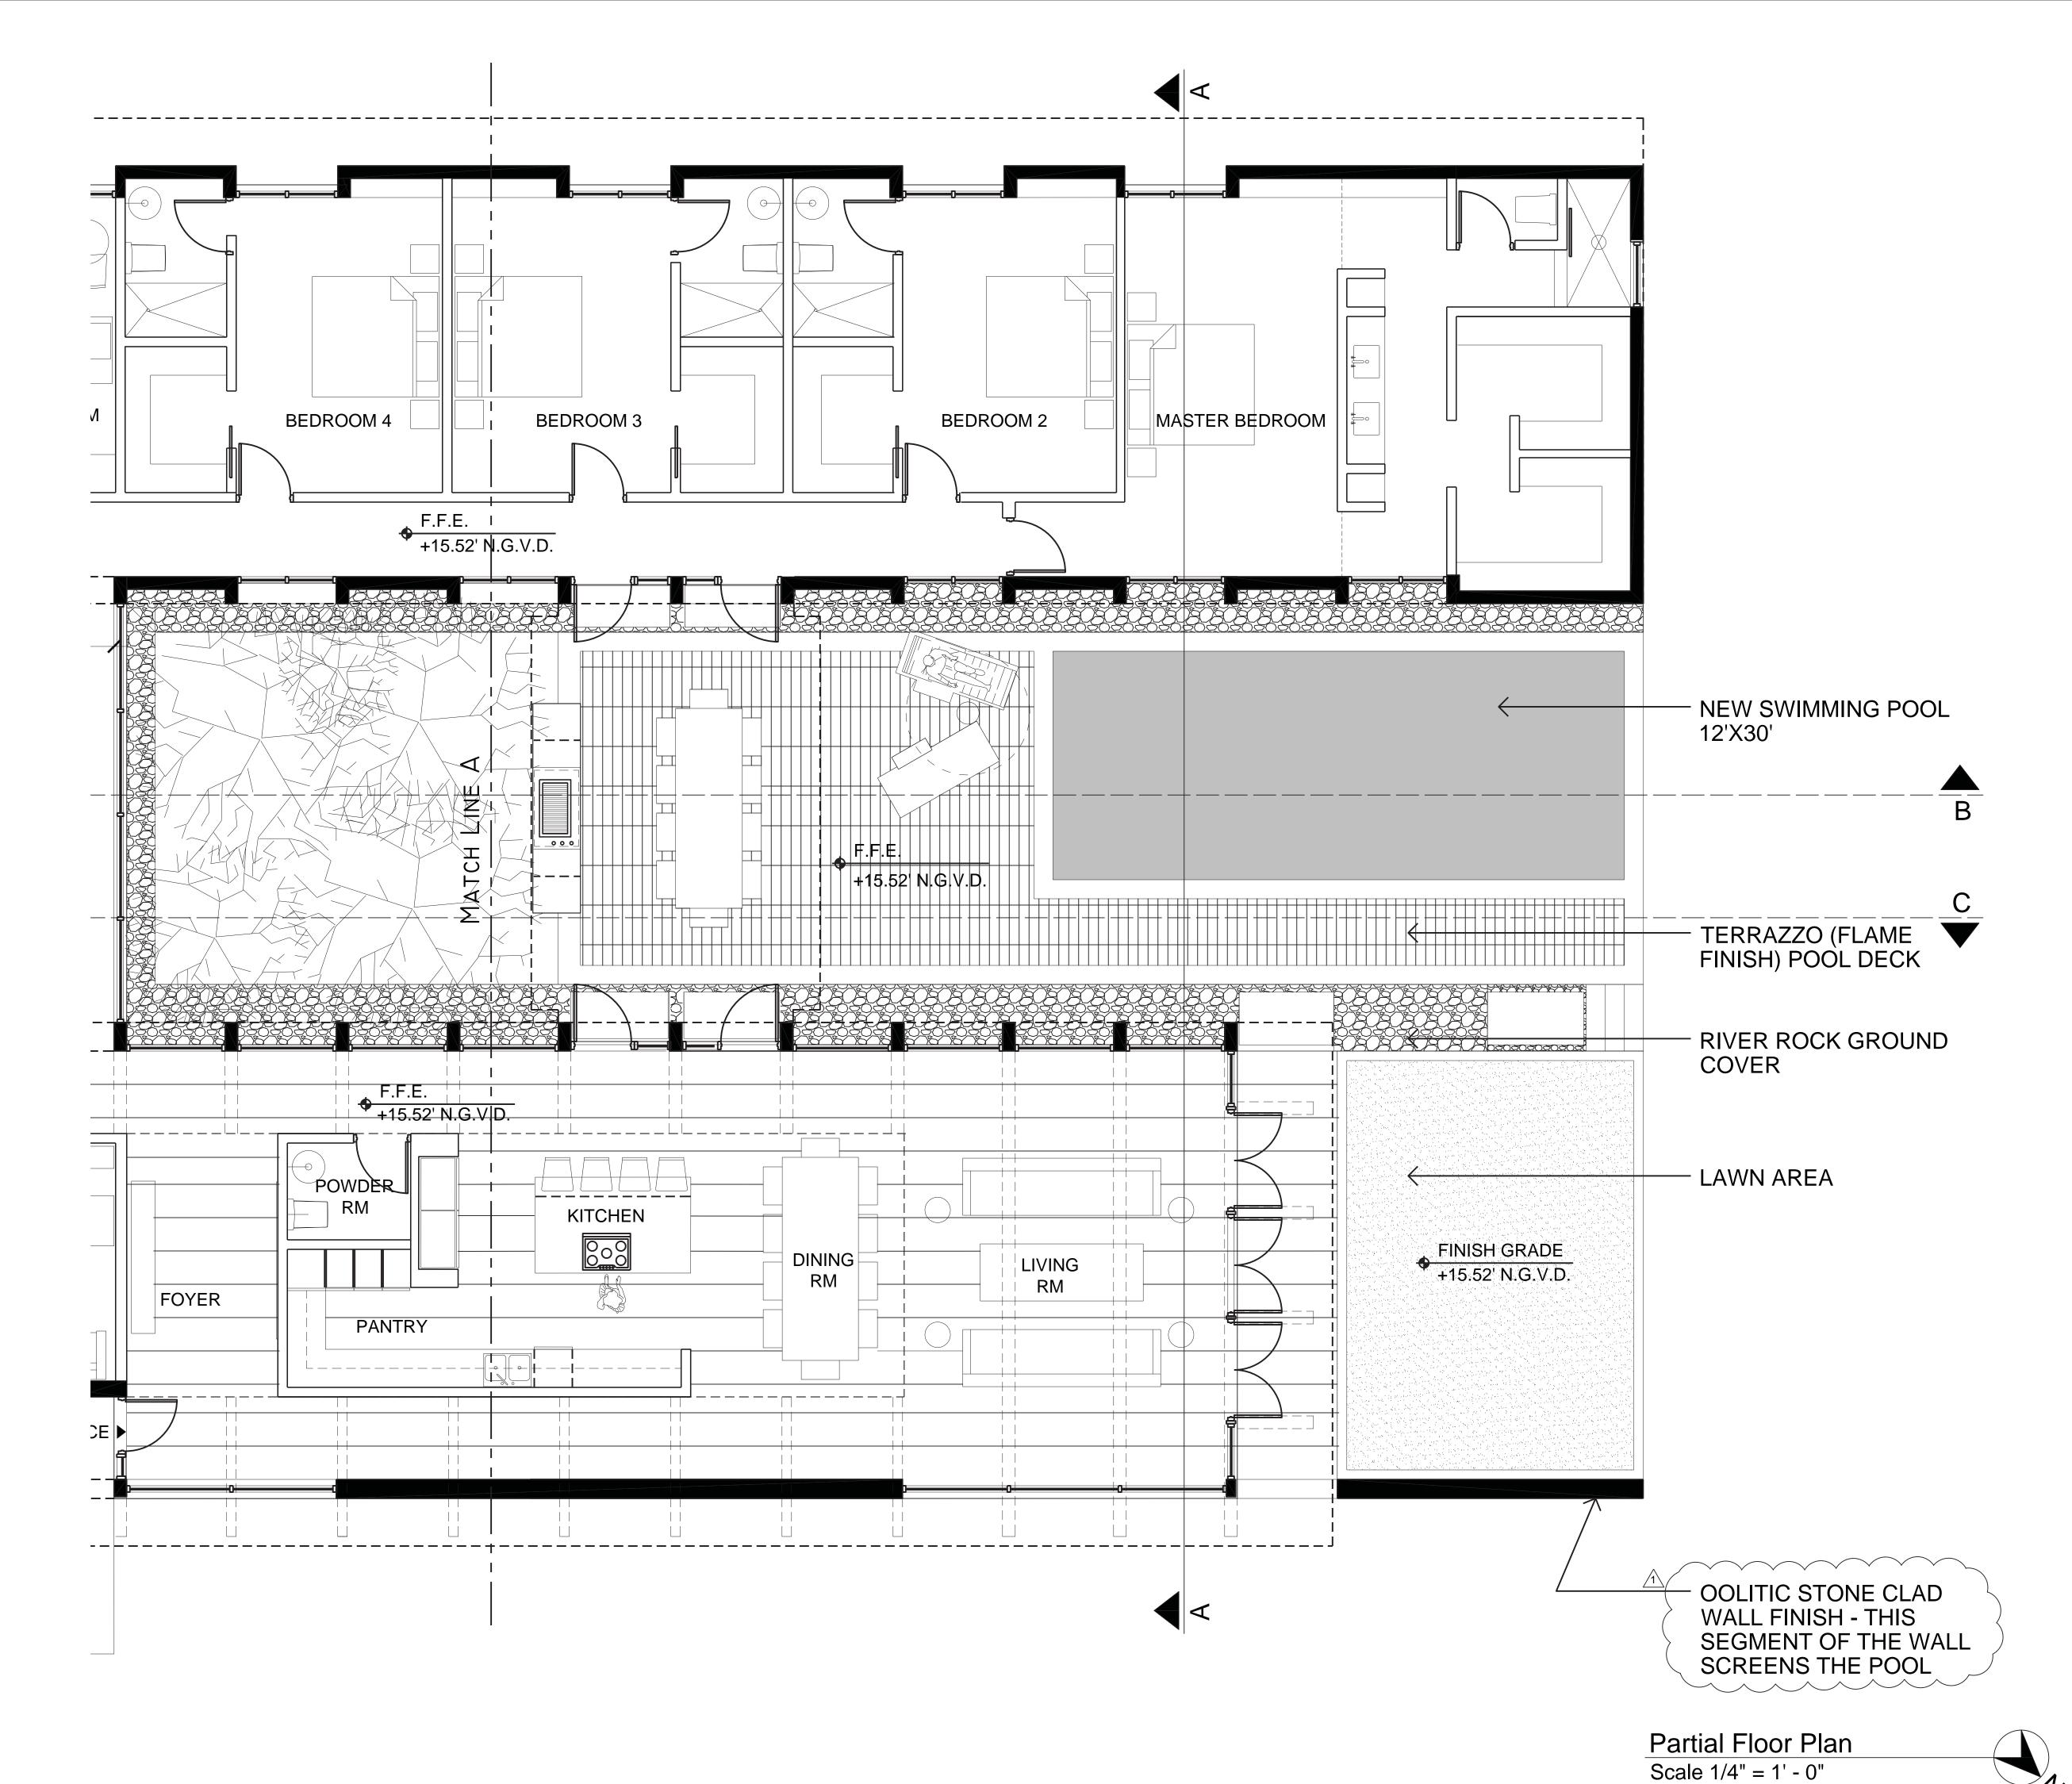
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San Vicente Street | Coral Gables Fl. 33140

date: 06-04-21
drawn by: S+A
designed by: S+A

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AA26004002

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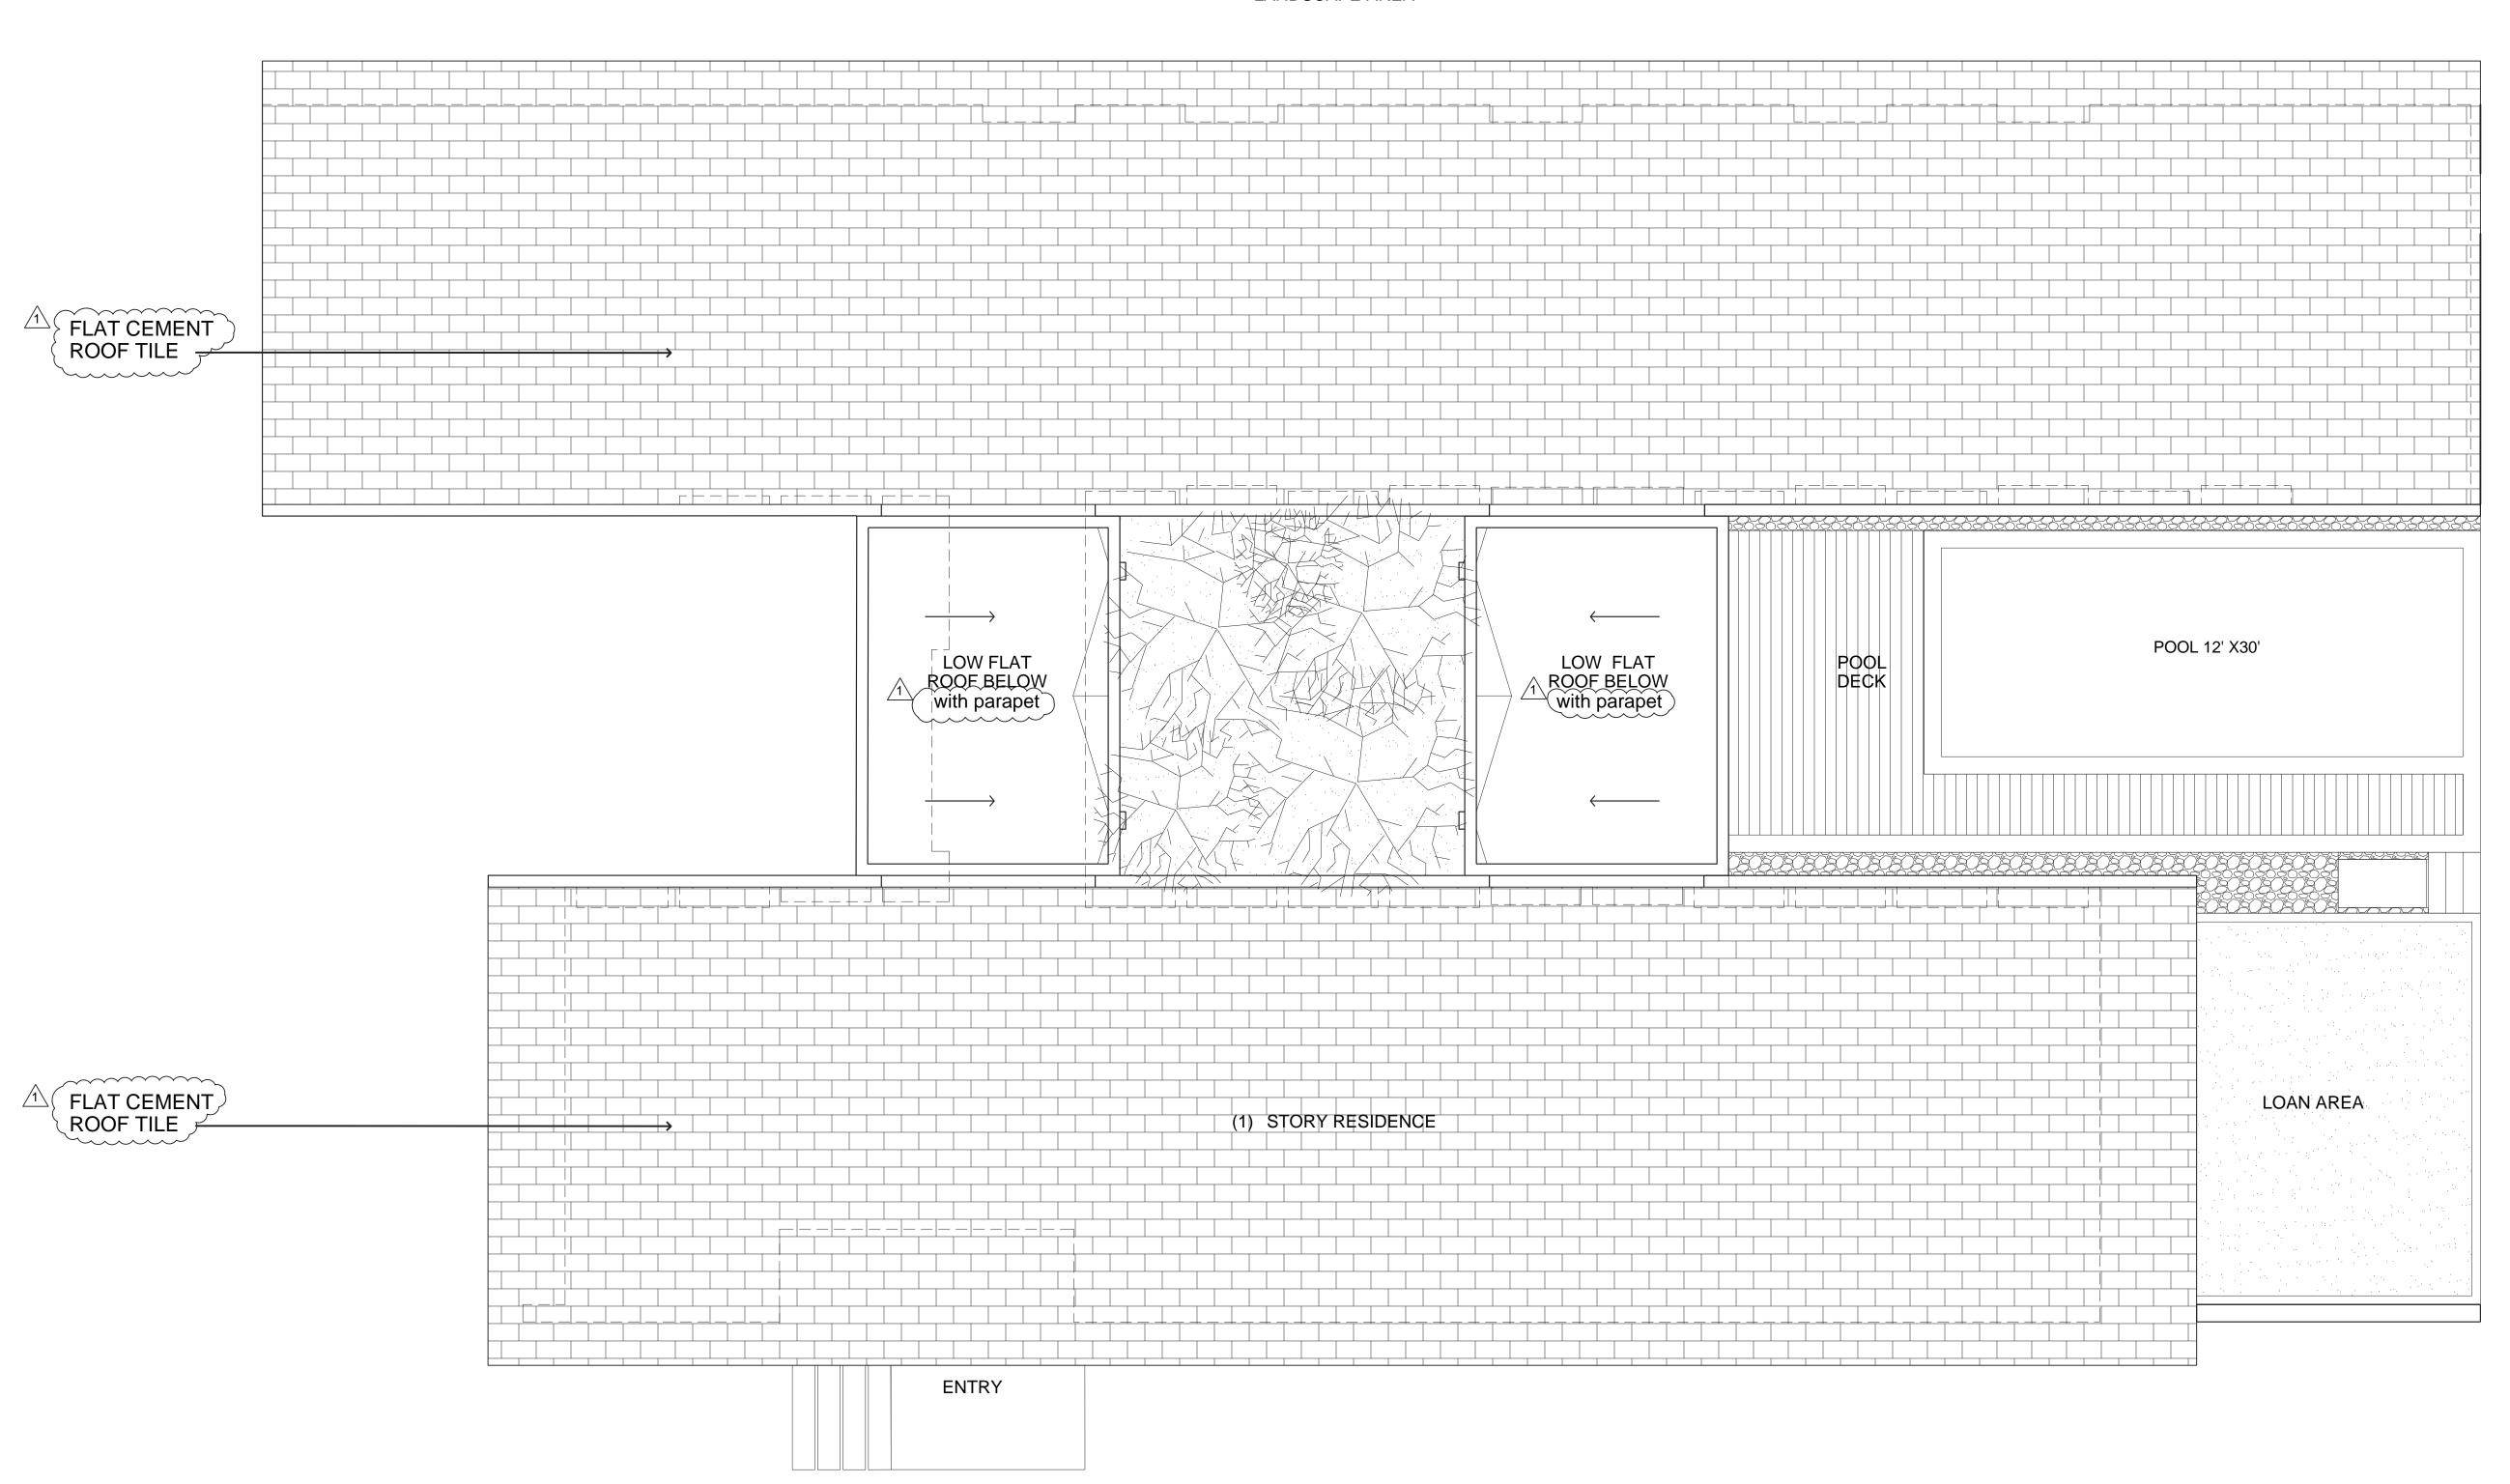
Coral Gables, FL 3314

San Vicente Street Re

date: 06-04-21
drawn by: S+A
designed by: S+A

A-08

LANDSCAPE AREA



Realization Group

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Residence


Vicente


San


d a t e: 06-04-21 drawn by: S+A designed by: S+A


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A-09



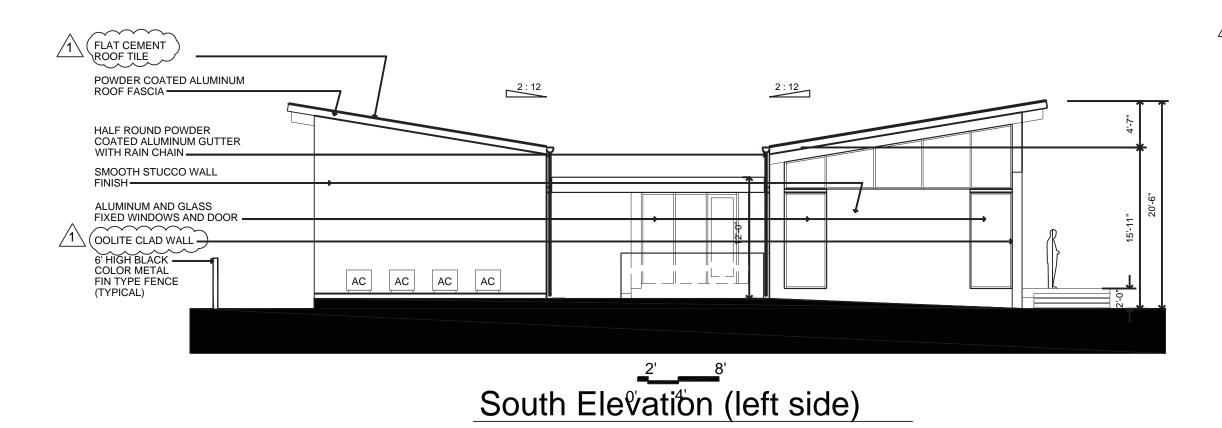

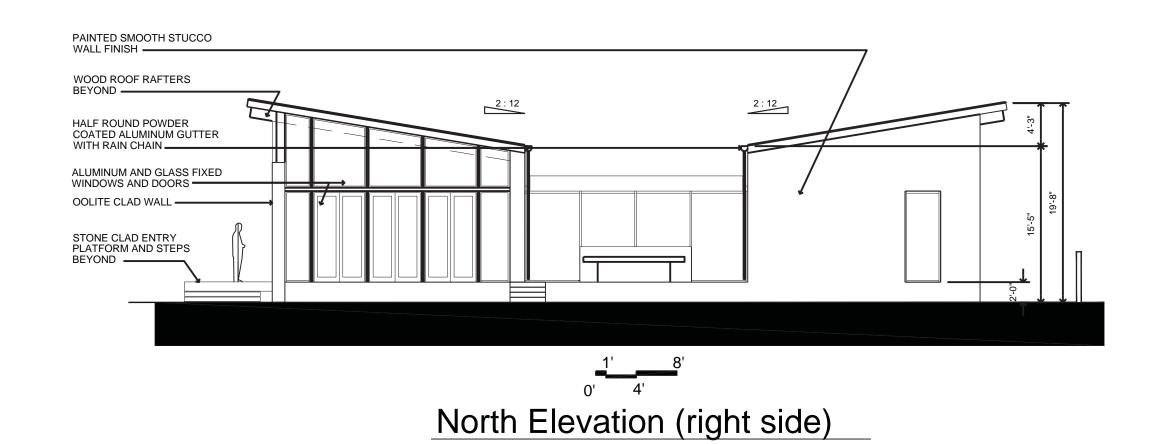

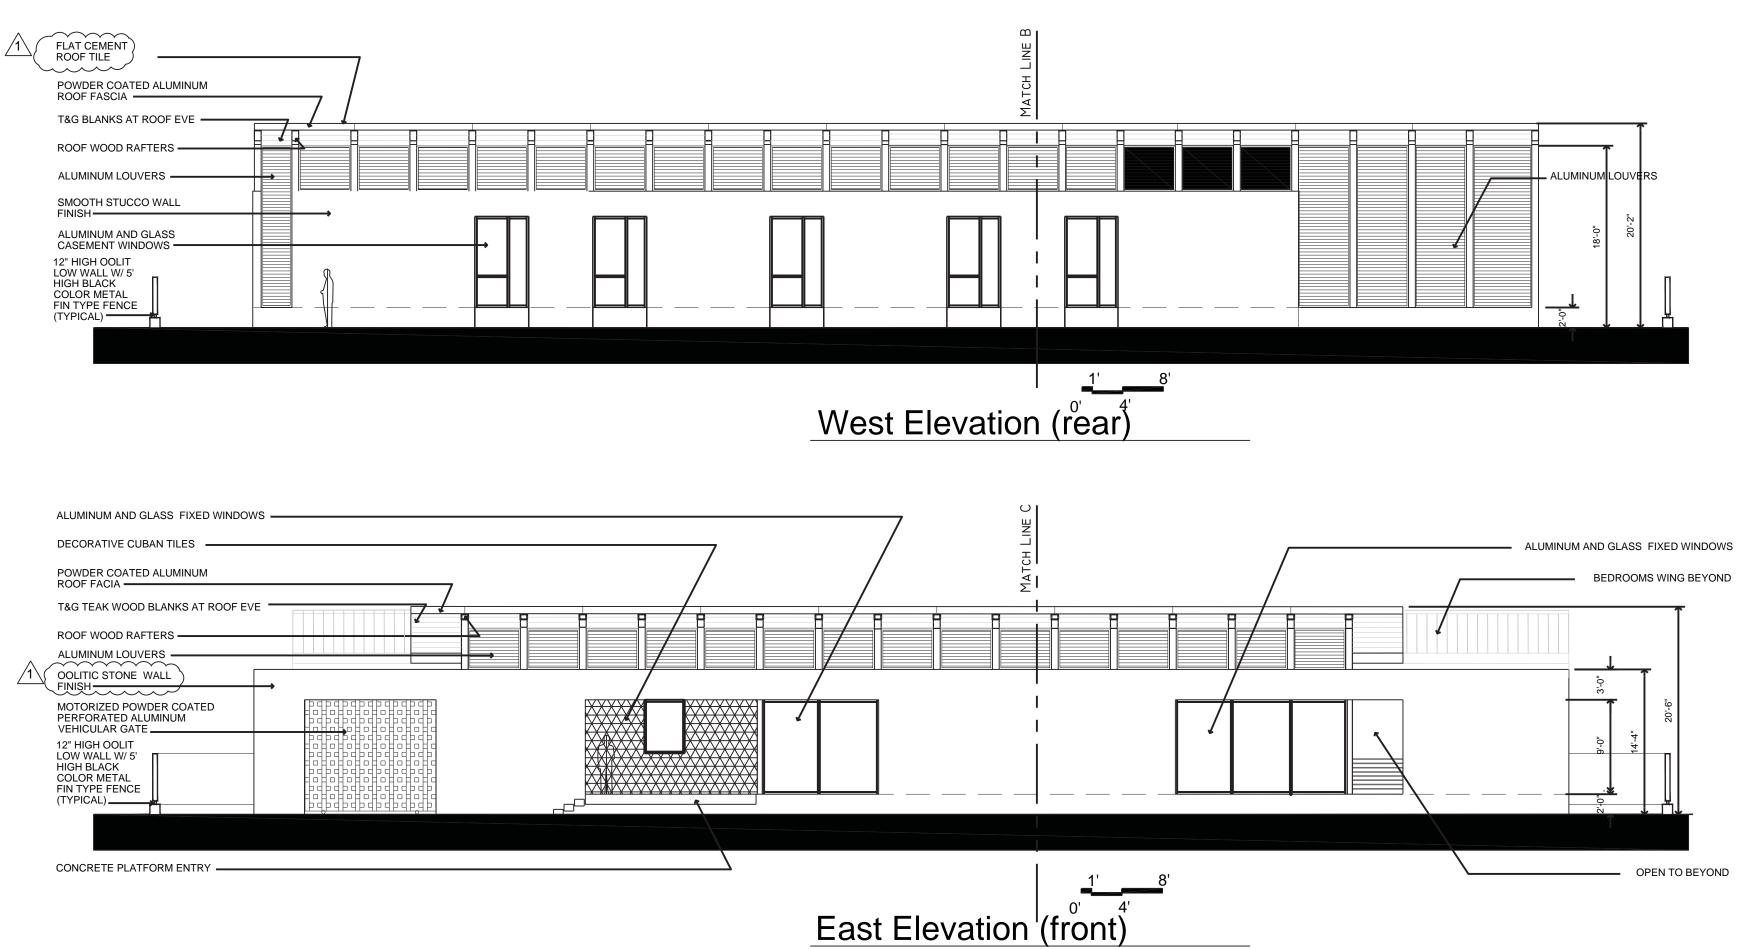

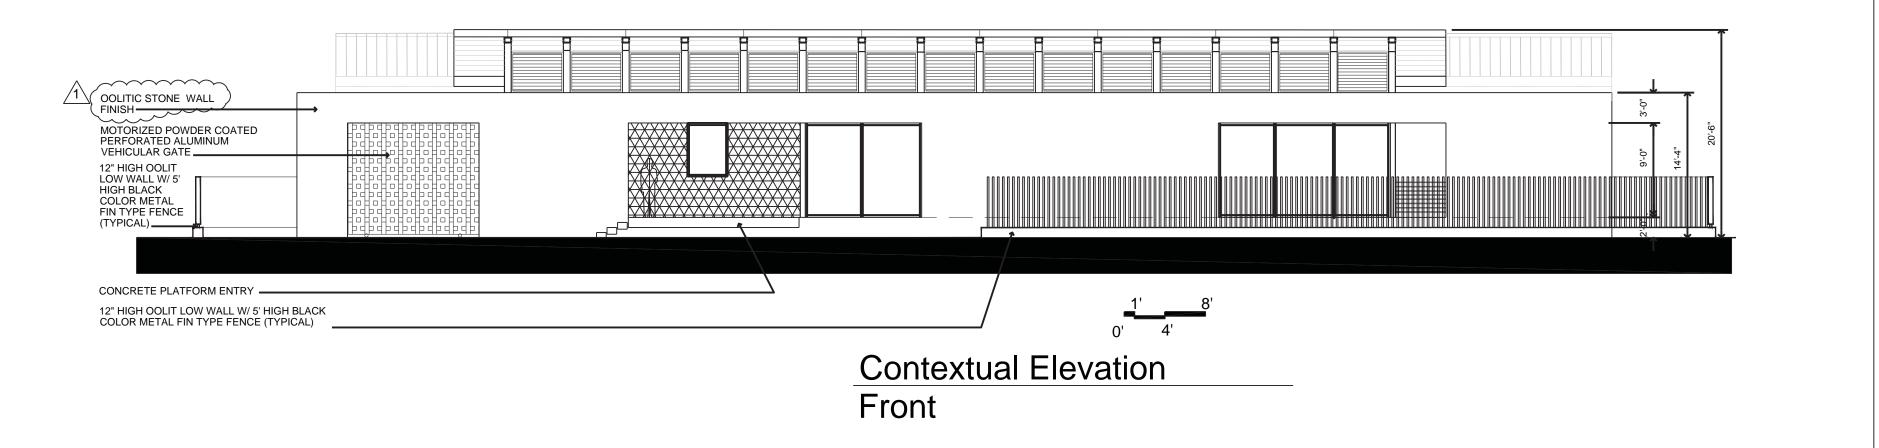AA26004002

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Street Residence
Coral Gables, FL 33146

San Vicente Street Re

6 San Vicente Street | Coral Gable

date: 06-04-21
drawn by: S+A
designed by: S+A

A-10

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Overall Elevations
Scale NTS



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t Residence Gables, FL 33146

San Vicente Street | Coral Gables, FL


date: 06-04-21
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designed by: S+A

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Scale 1/4" = 1' - 0"



West Elevation (Rear)
Scale 1/4" = 1' - 0"

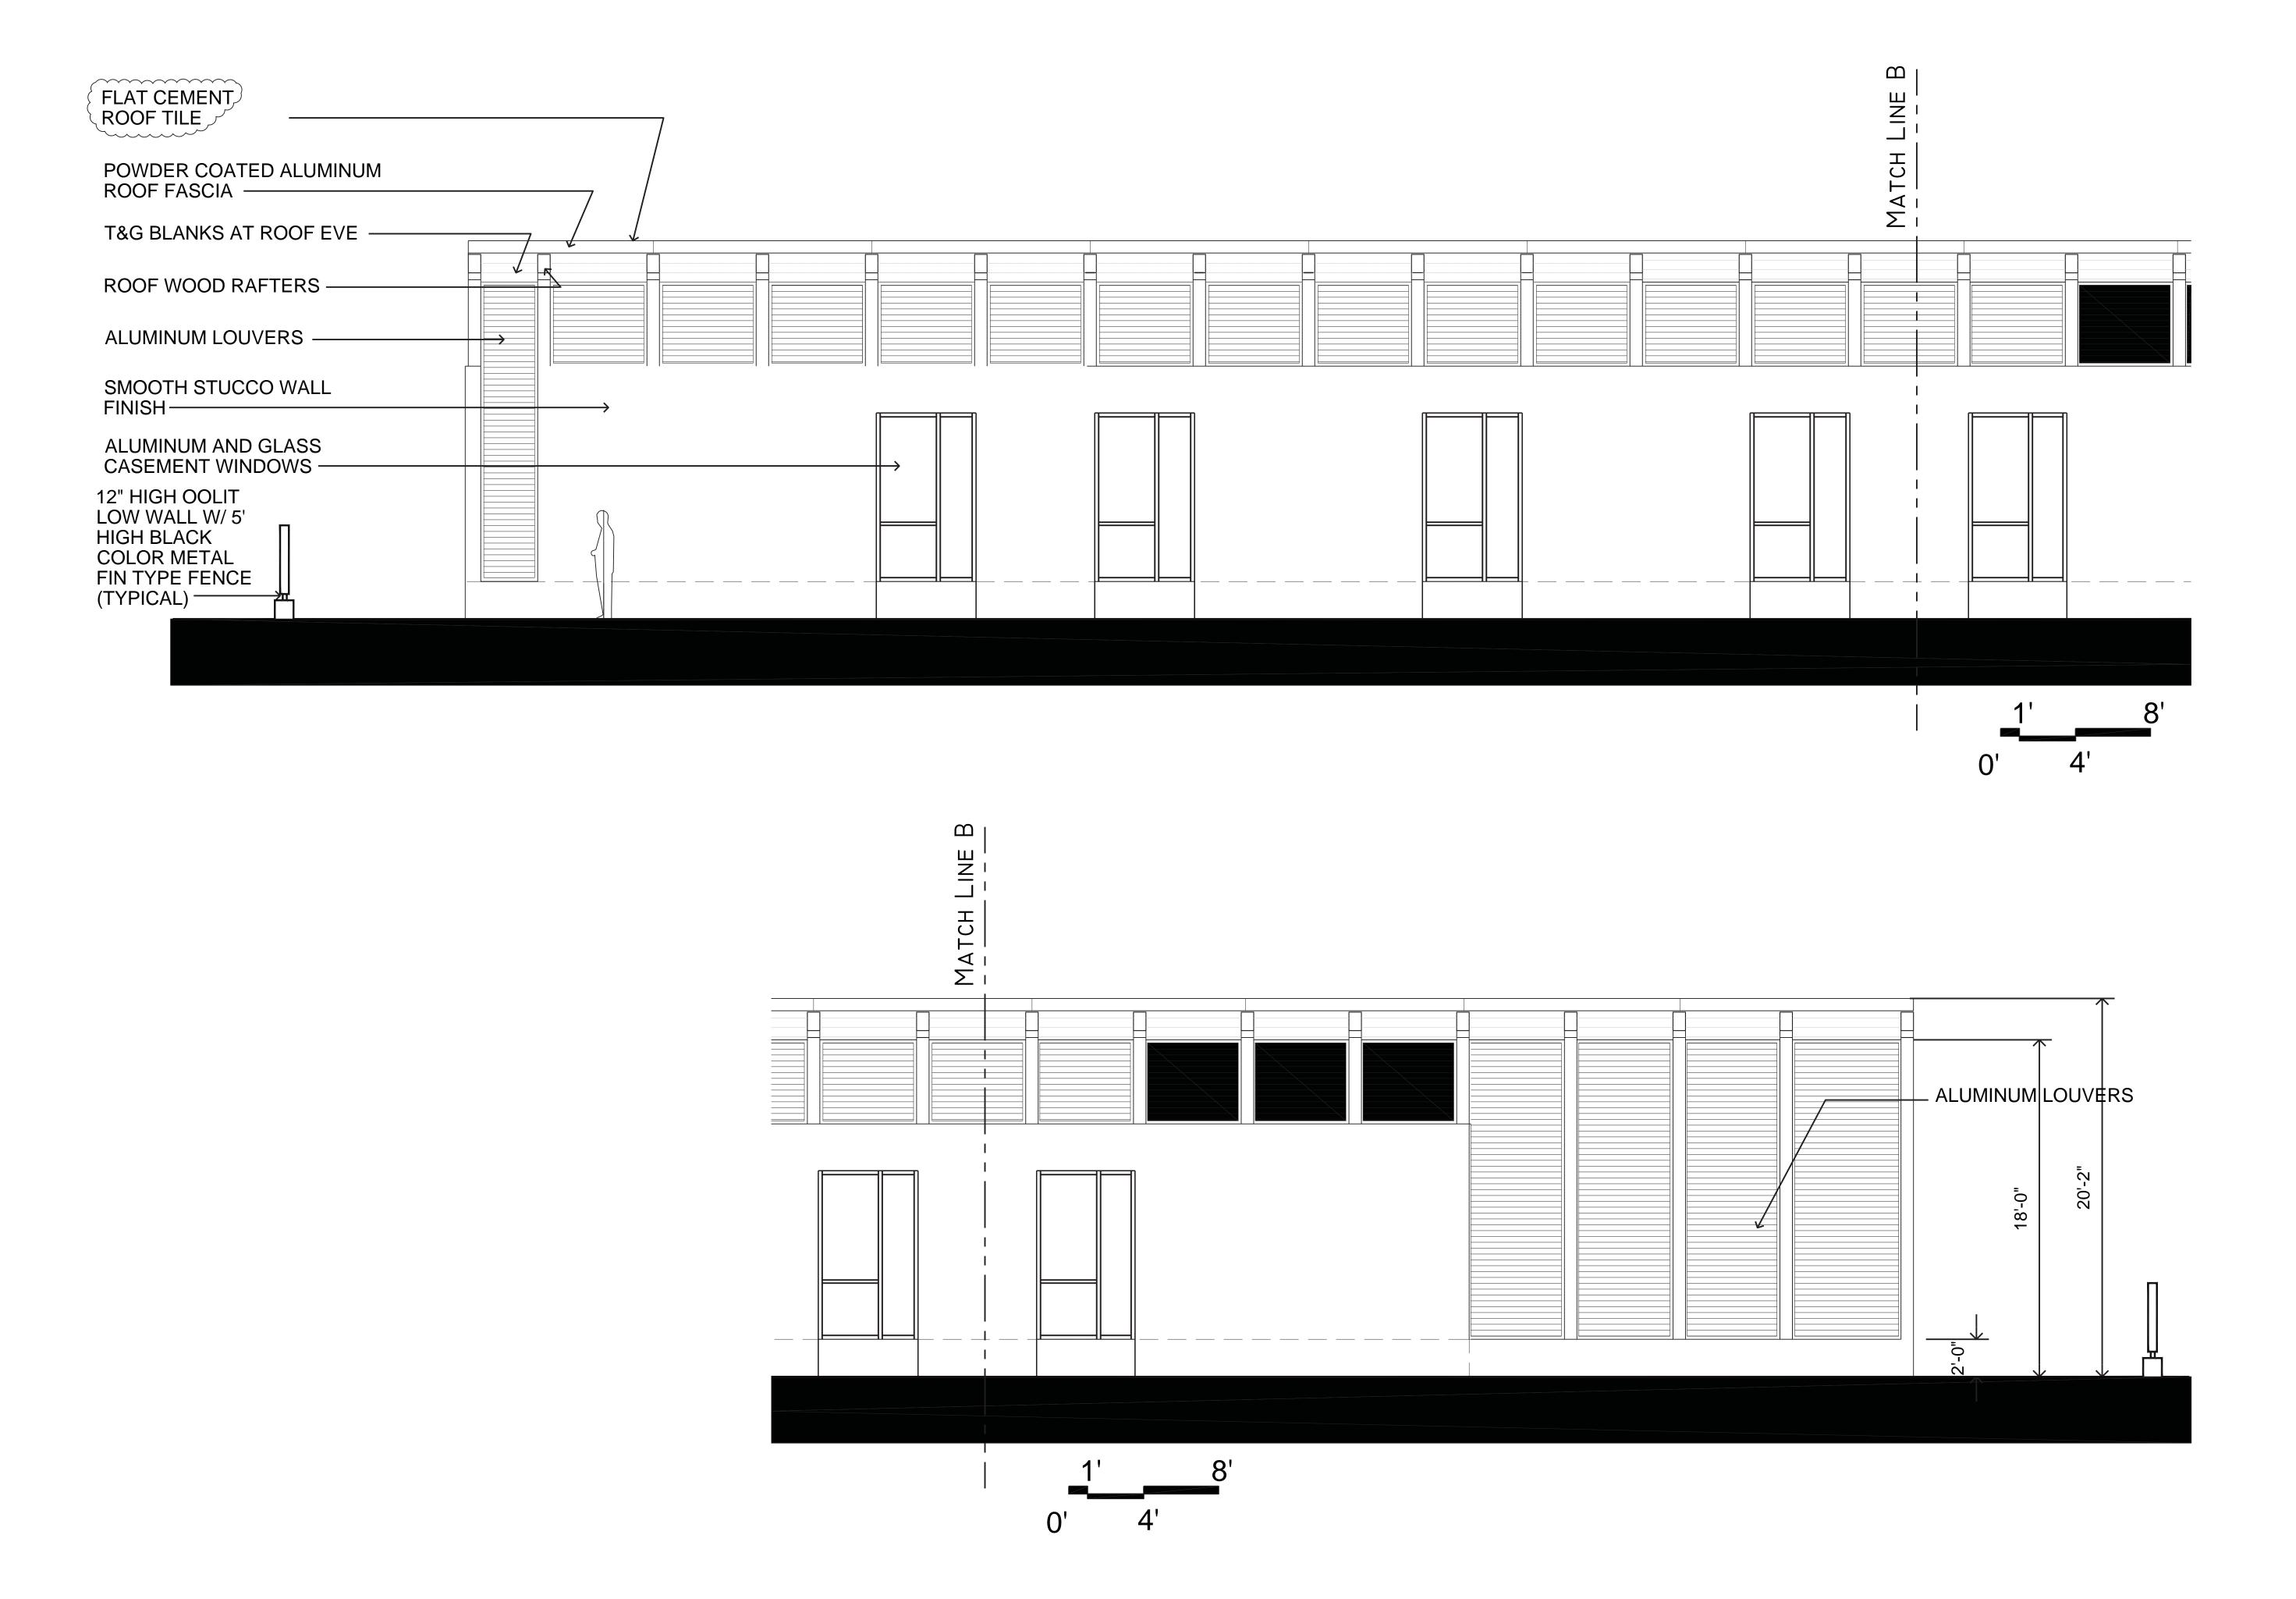

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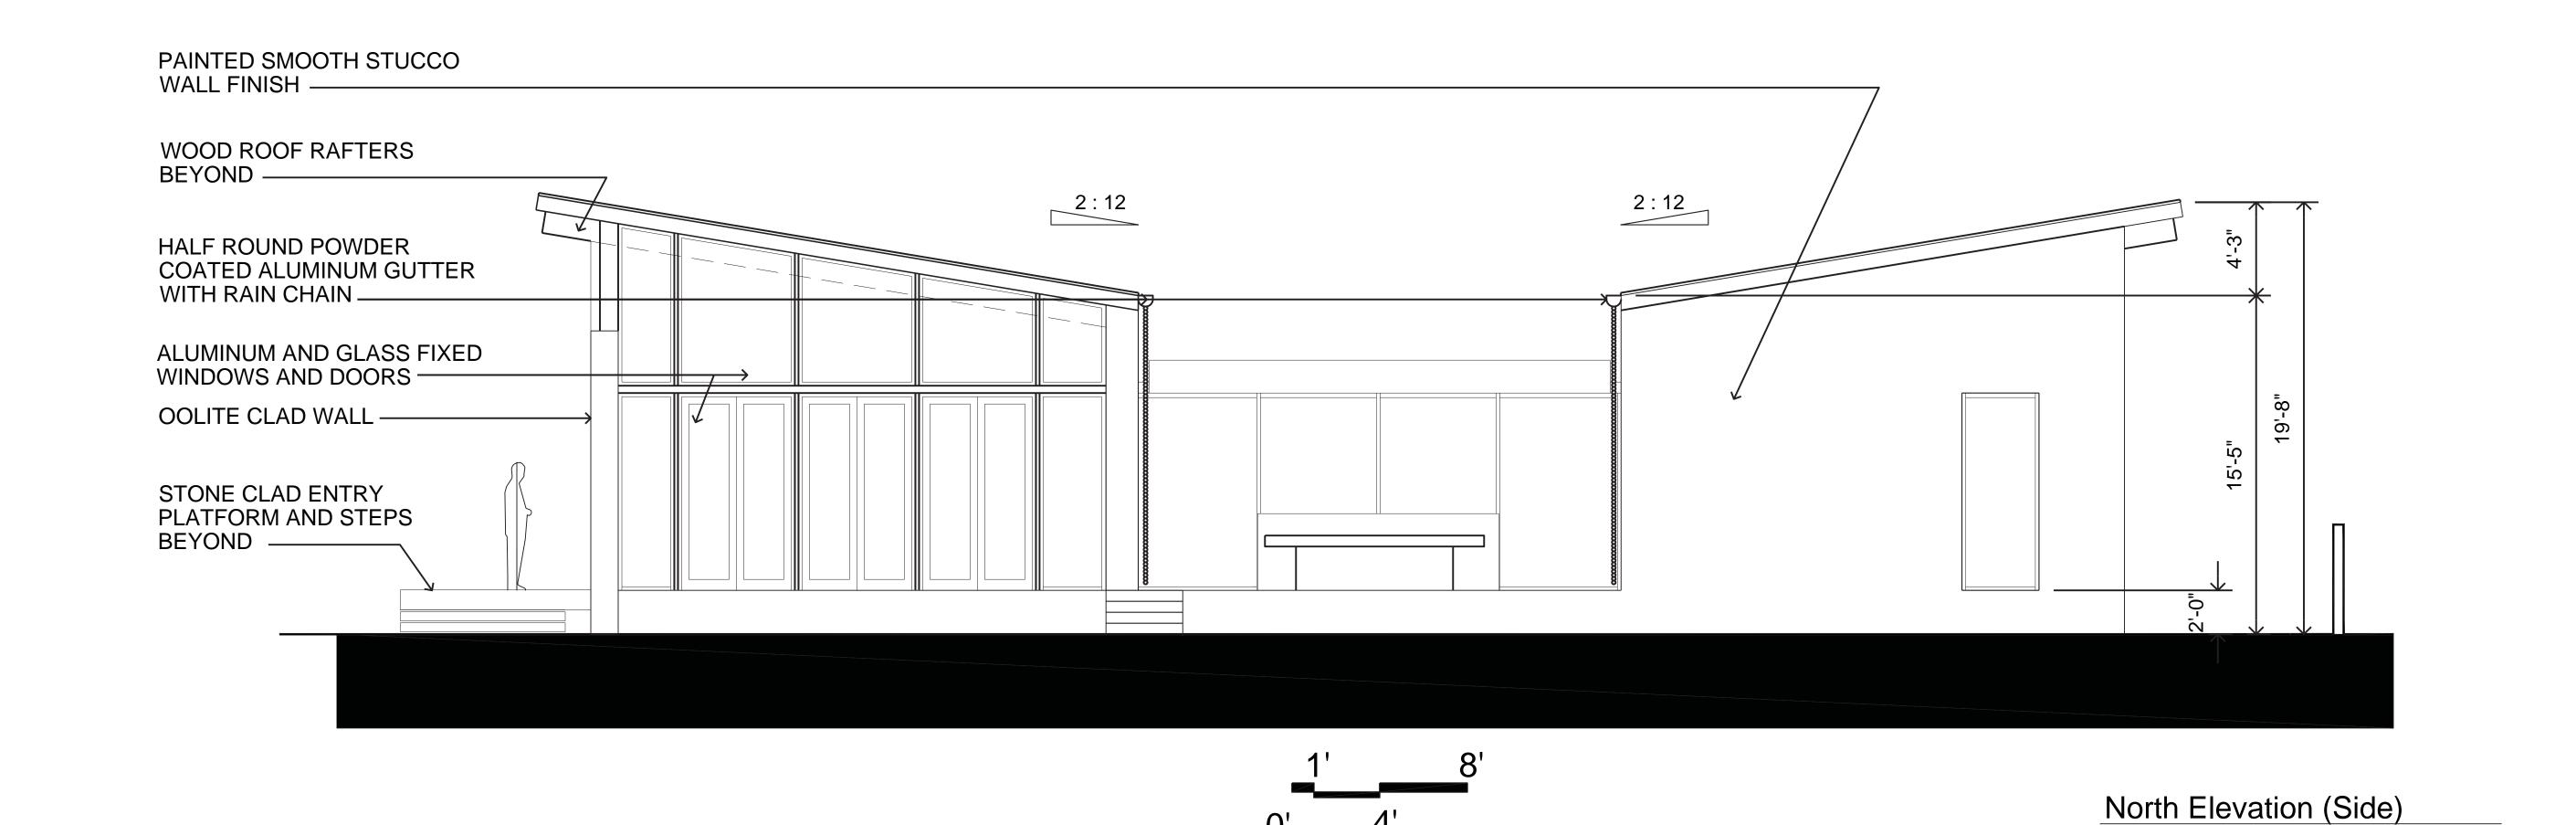
Residence

Vicente San

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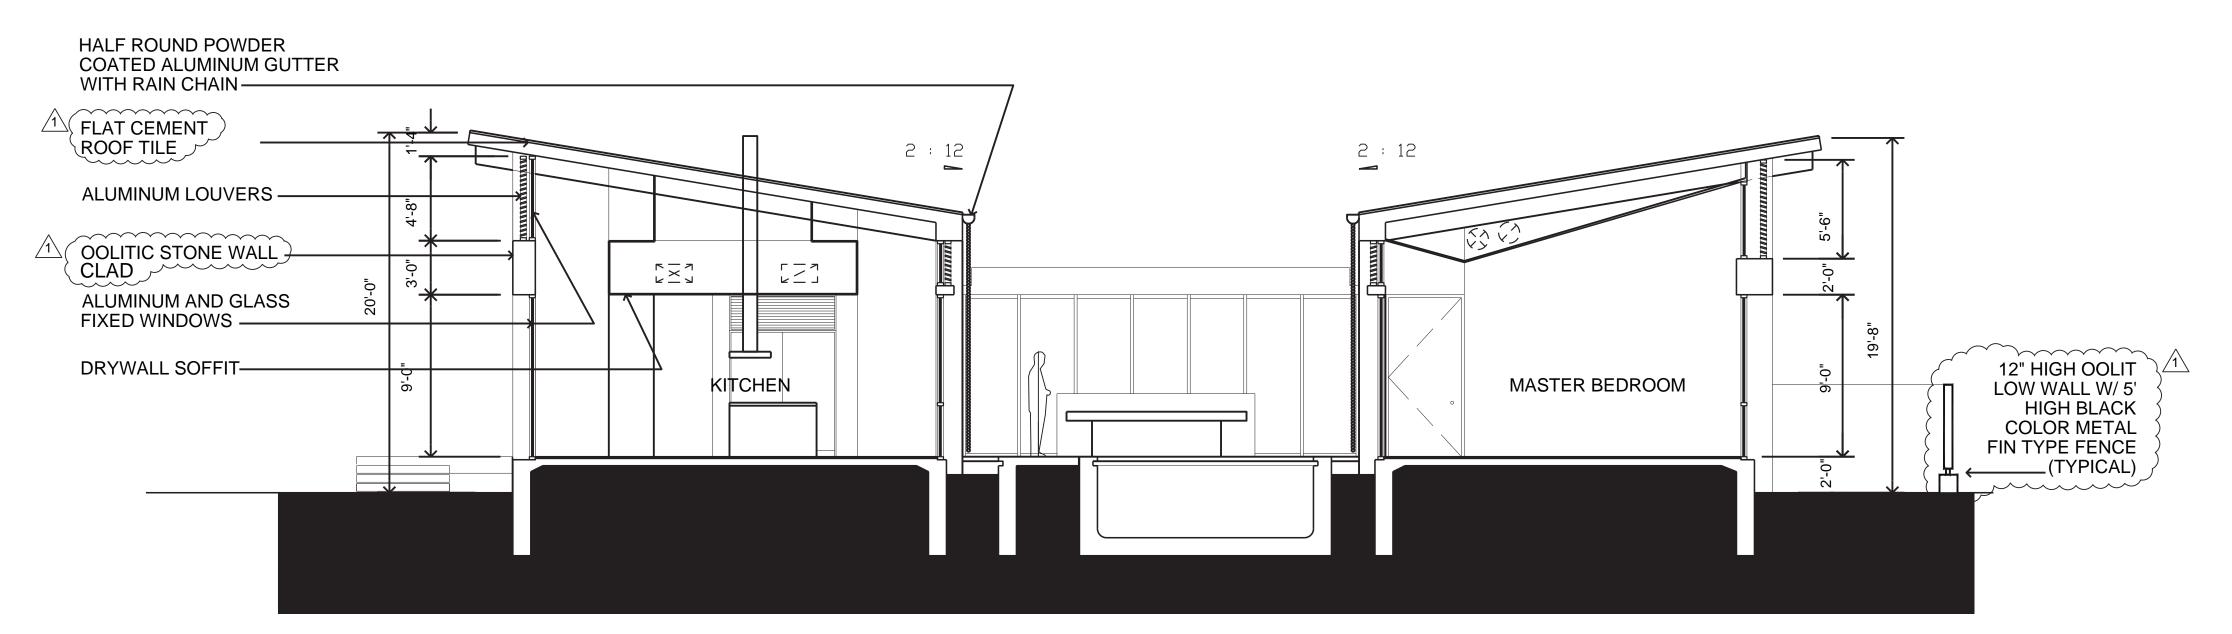
an Vicente Street | Coral Gables, FL 331

date: 06-04-21
drawn by: S+A
designed by: S+A


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08-10-2021

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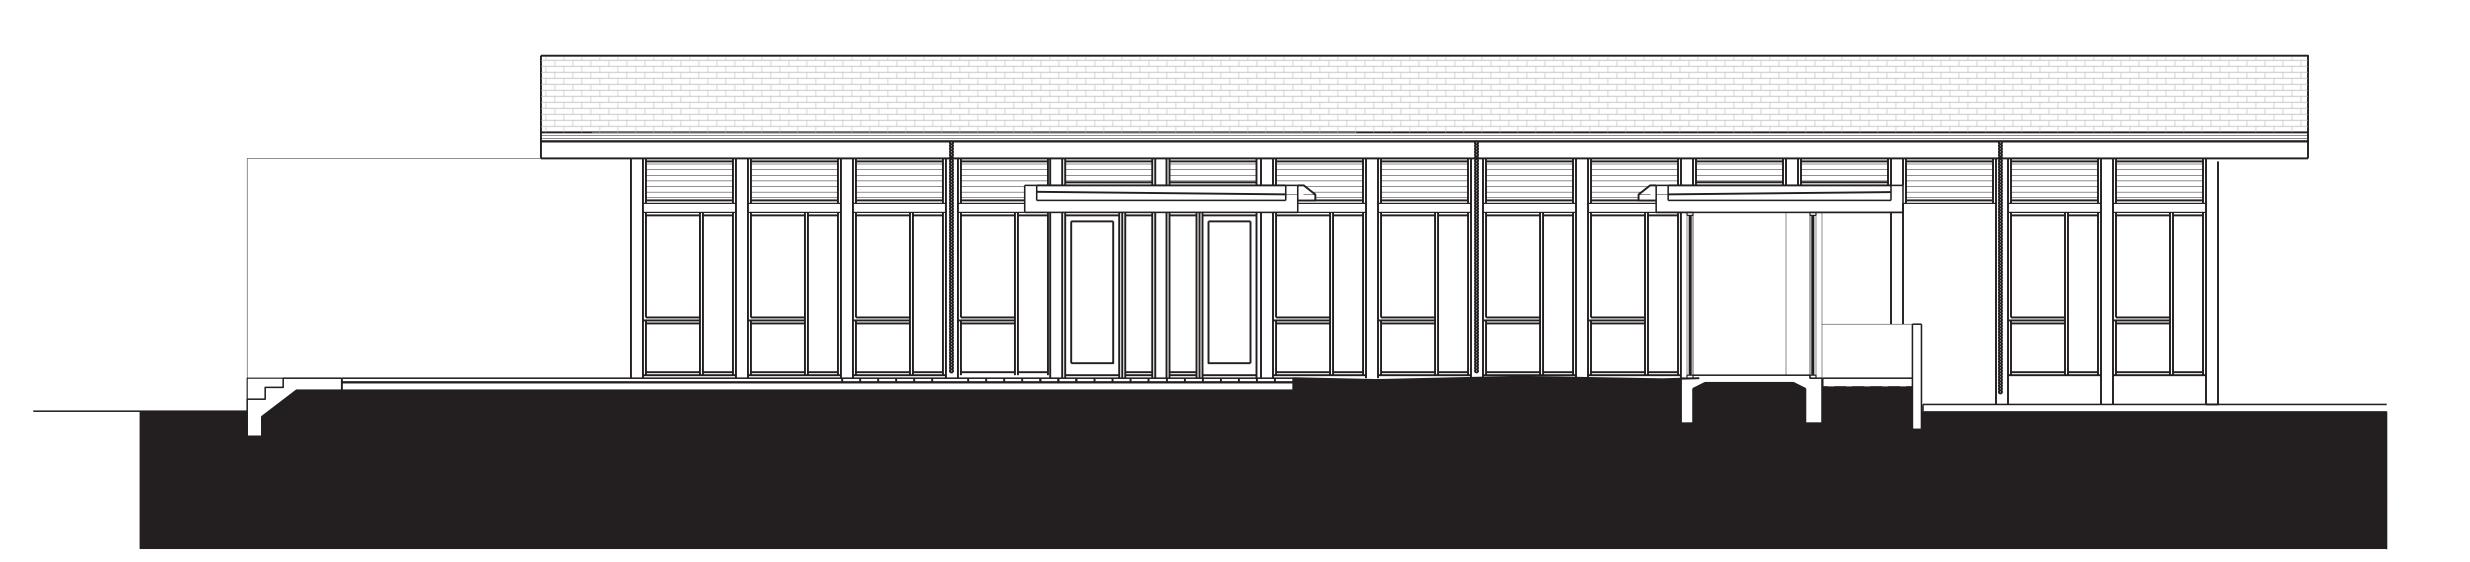
Scale 1/4" = 1' - 0"



Section A
Scale 3/16" = 1' - 0"

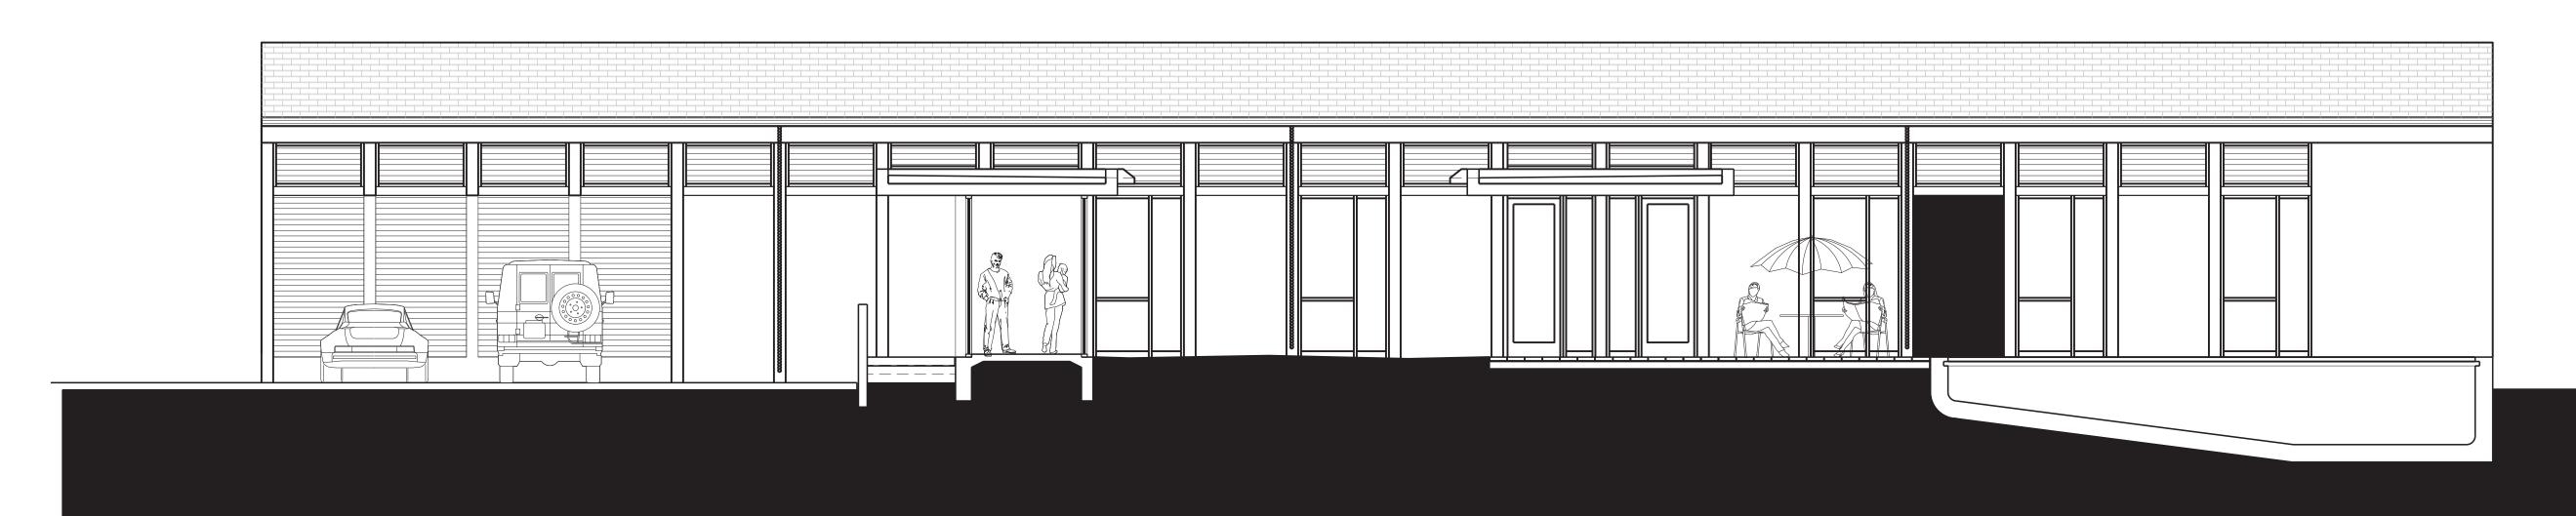

Section B Scale 3/16" = 1' - 0"



Section C Scale 3/16" = 1' - 0"

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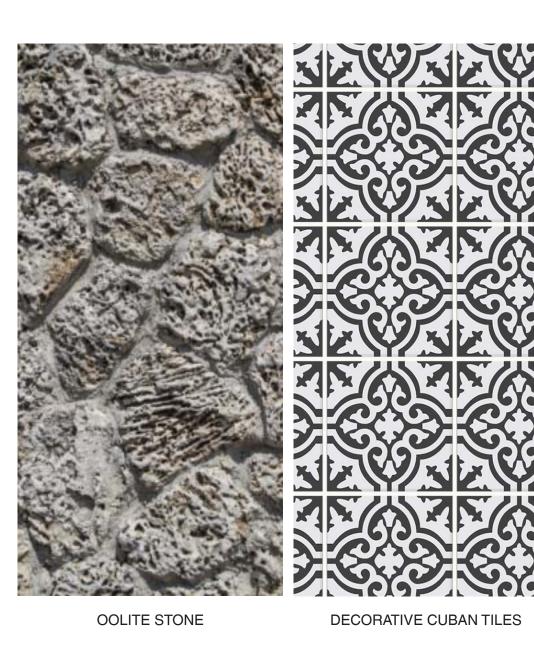
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d a t e: 06-04-21 drawn by: S+A designed by: S+A


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WHITE SMOOTH STUCCO









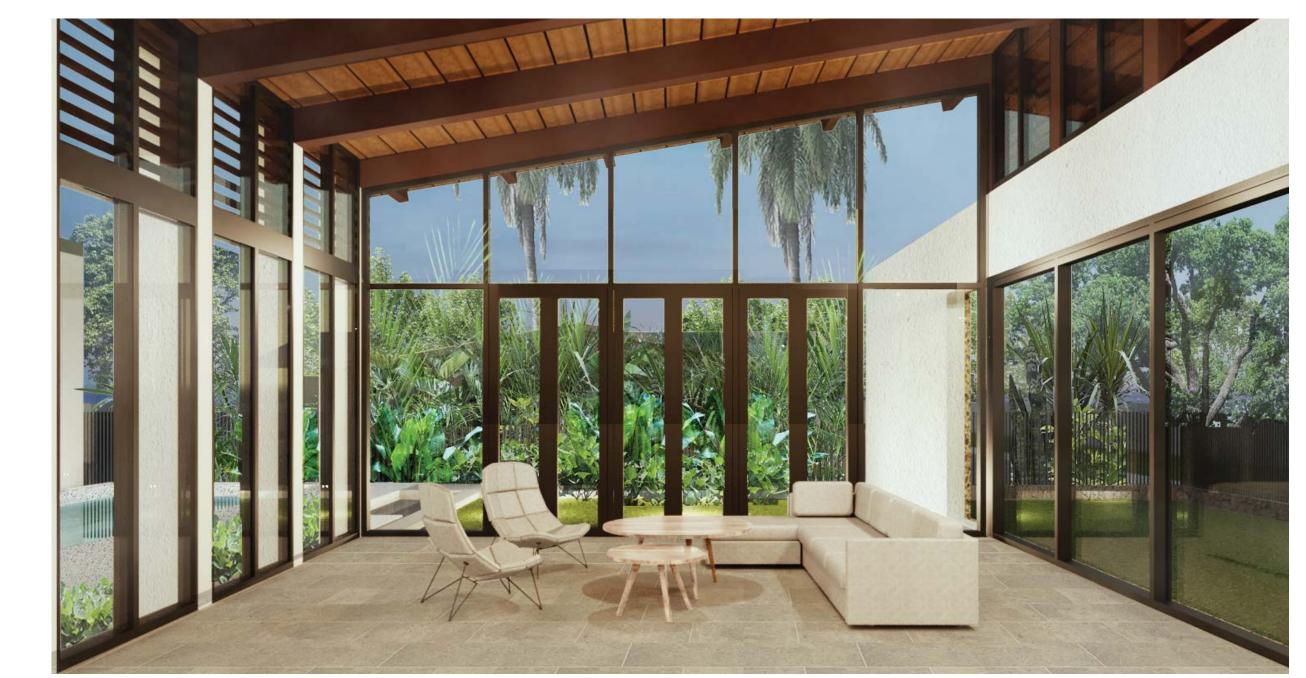







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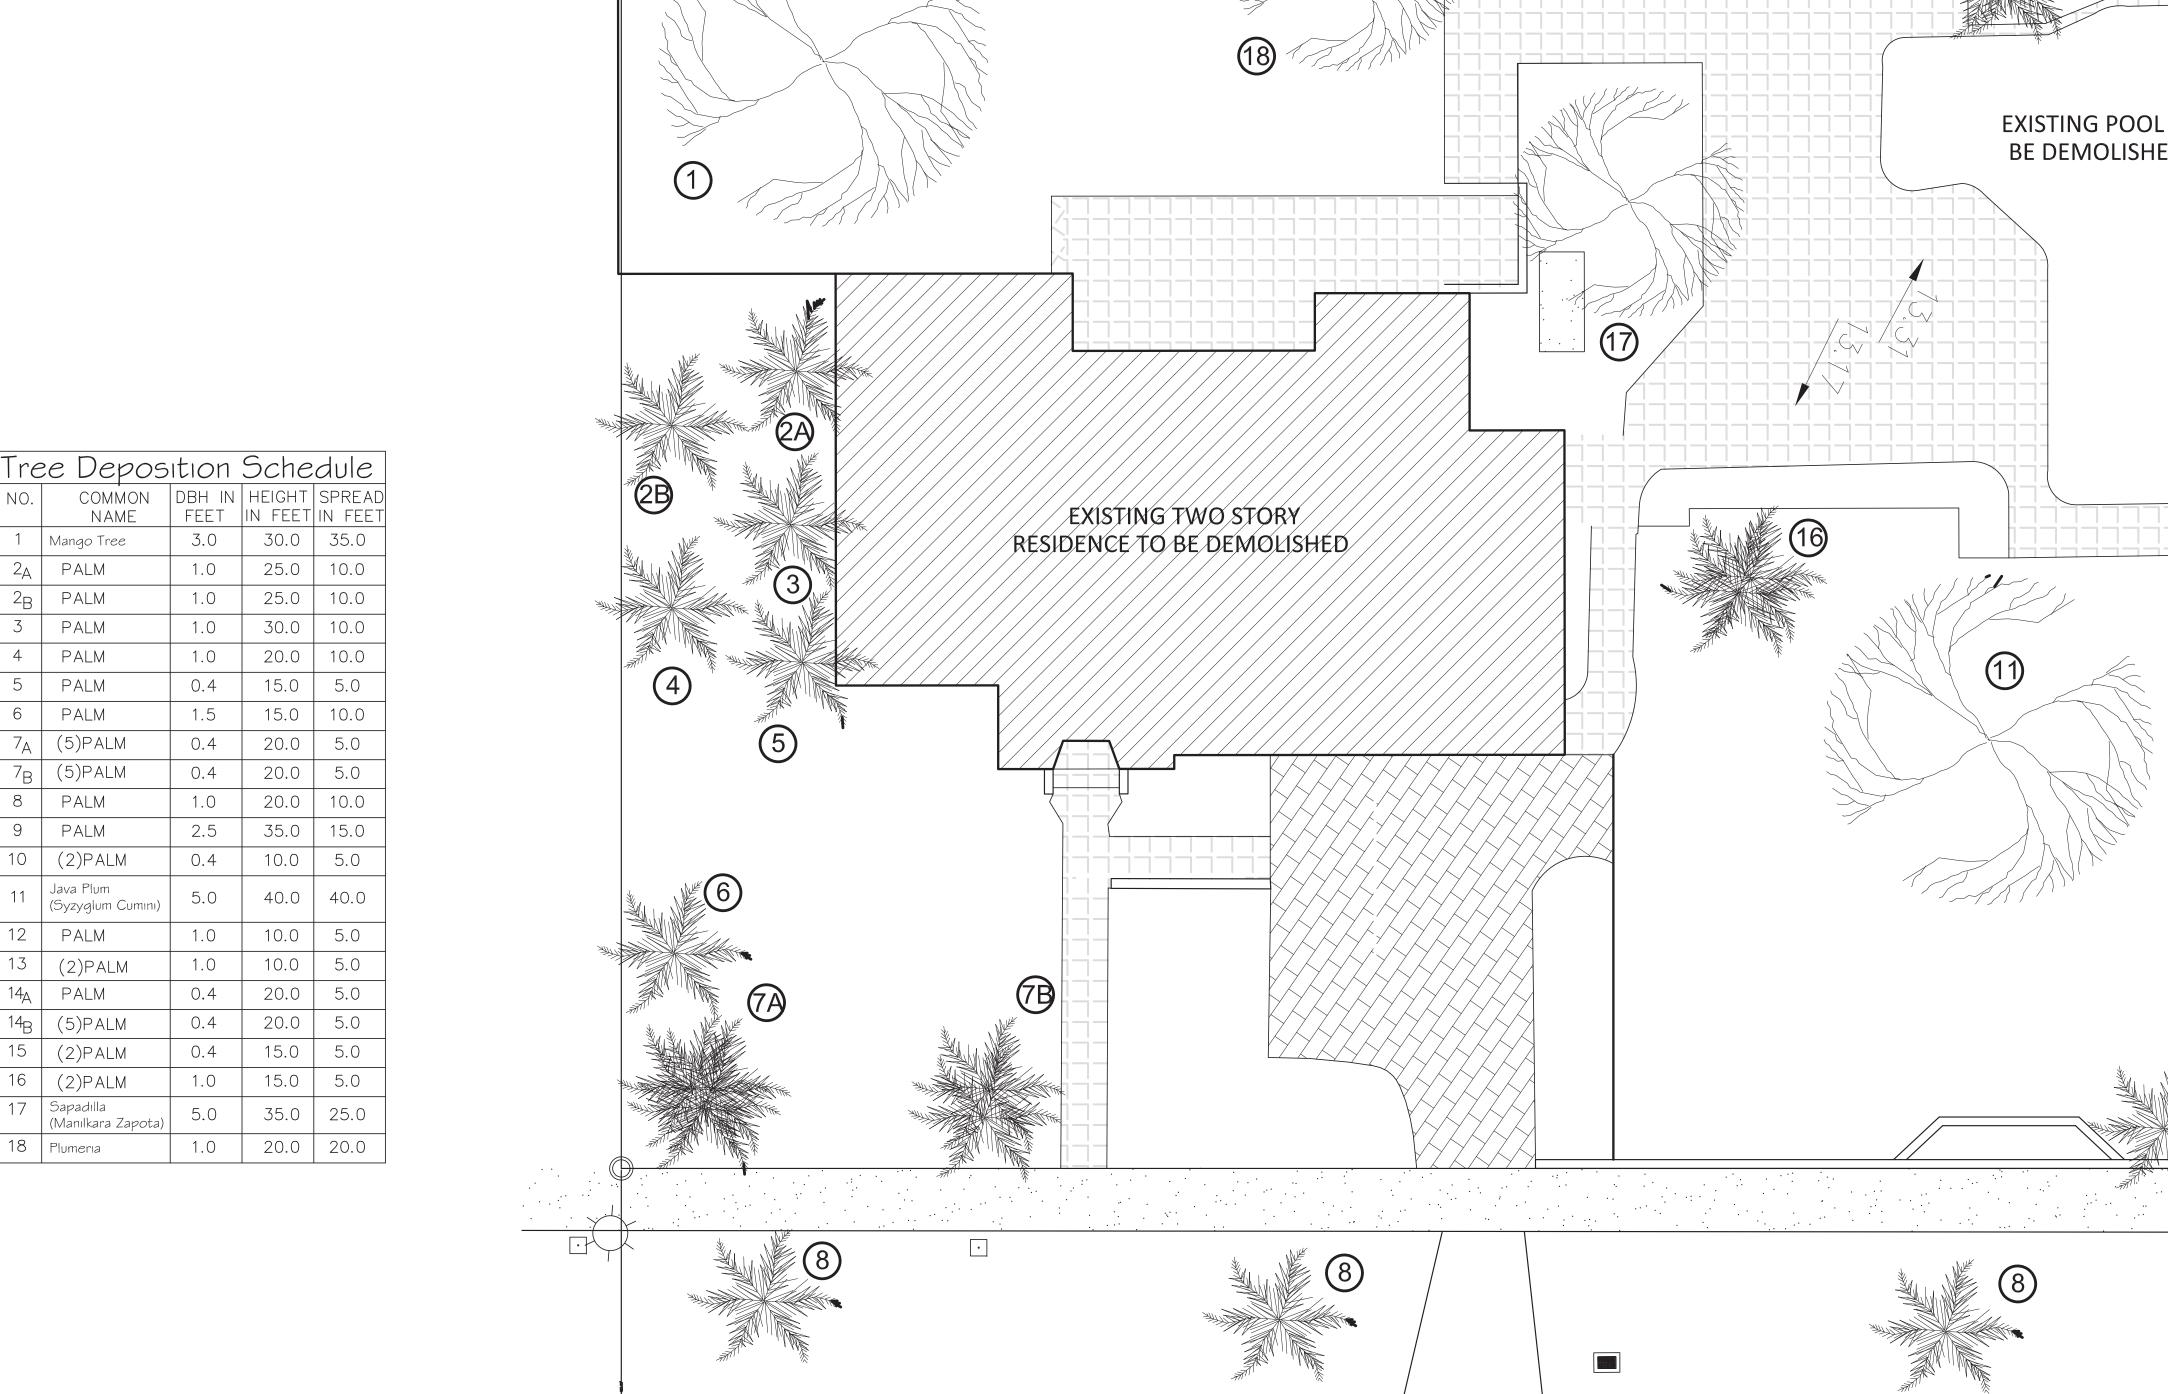
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A-15



Yes

Yes

Yes

Yes

Mango Tree

PALM

PALM

2_B PALM

3 PALM

4 PALM

6 PALM

7_A (5)PALM

7_B (5)PALM

8 PALM

9 PALM

10 (2)PALM

12 PALM

14_A PALM

13 (2)PALM

14_B (5)PALM

15 (2)PALM

16 (2)PALM

18 Plumeria

17 Sapadılla (Manılkara Zapota)

Java Plum (Syzyglum Cumını)

1.0

1.0

1.0

1.0

0.4

1.5

0.4

1.0

2.5

5.0

1.0

1.0

0.4


0.4

1.0

5.0

1.0

40.0

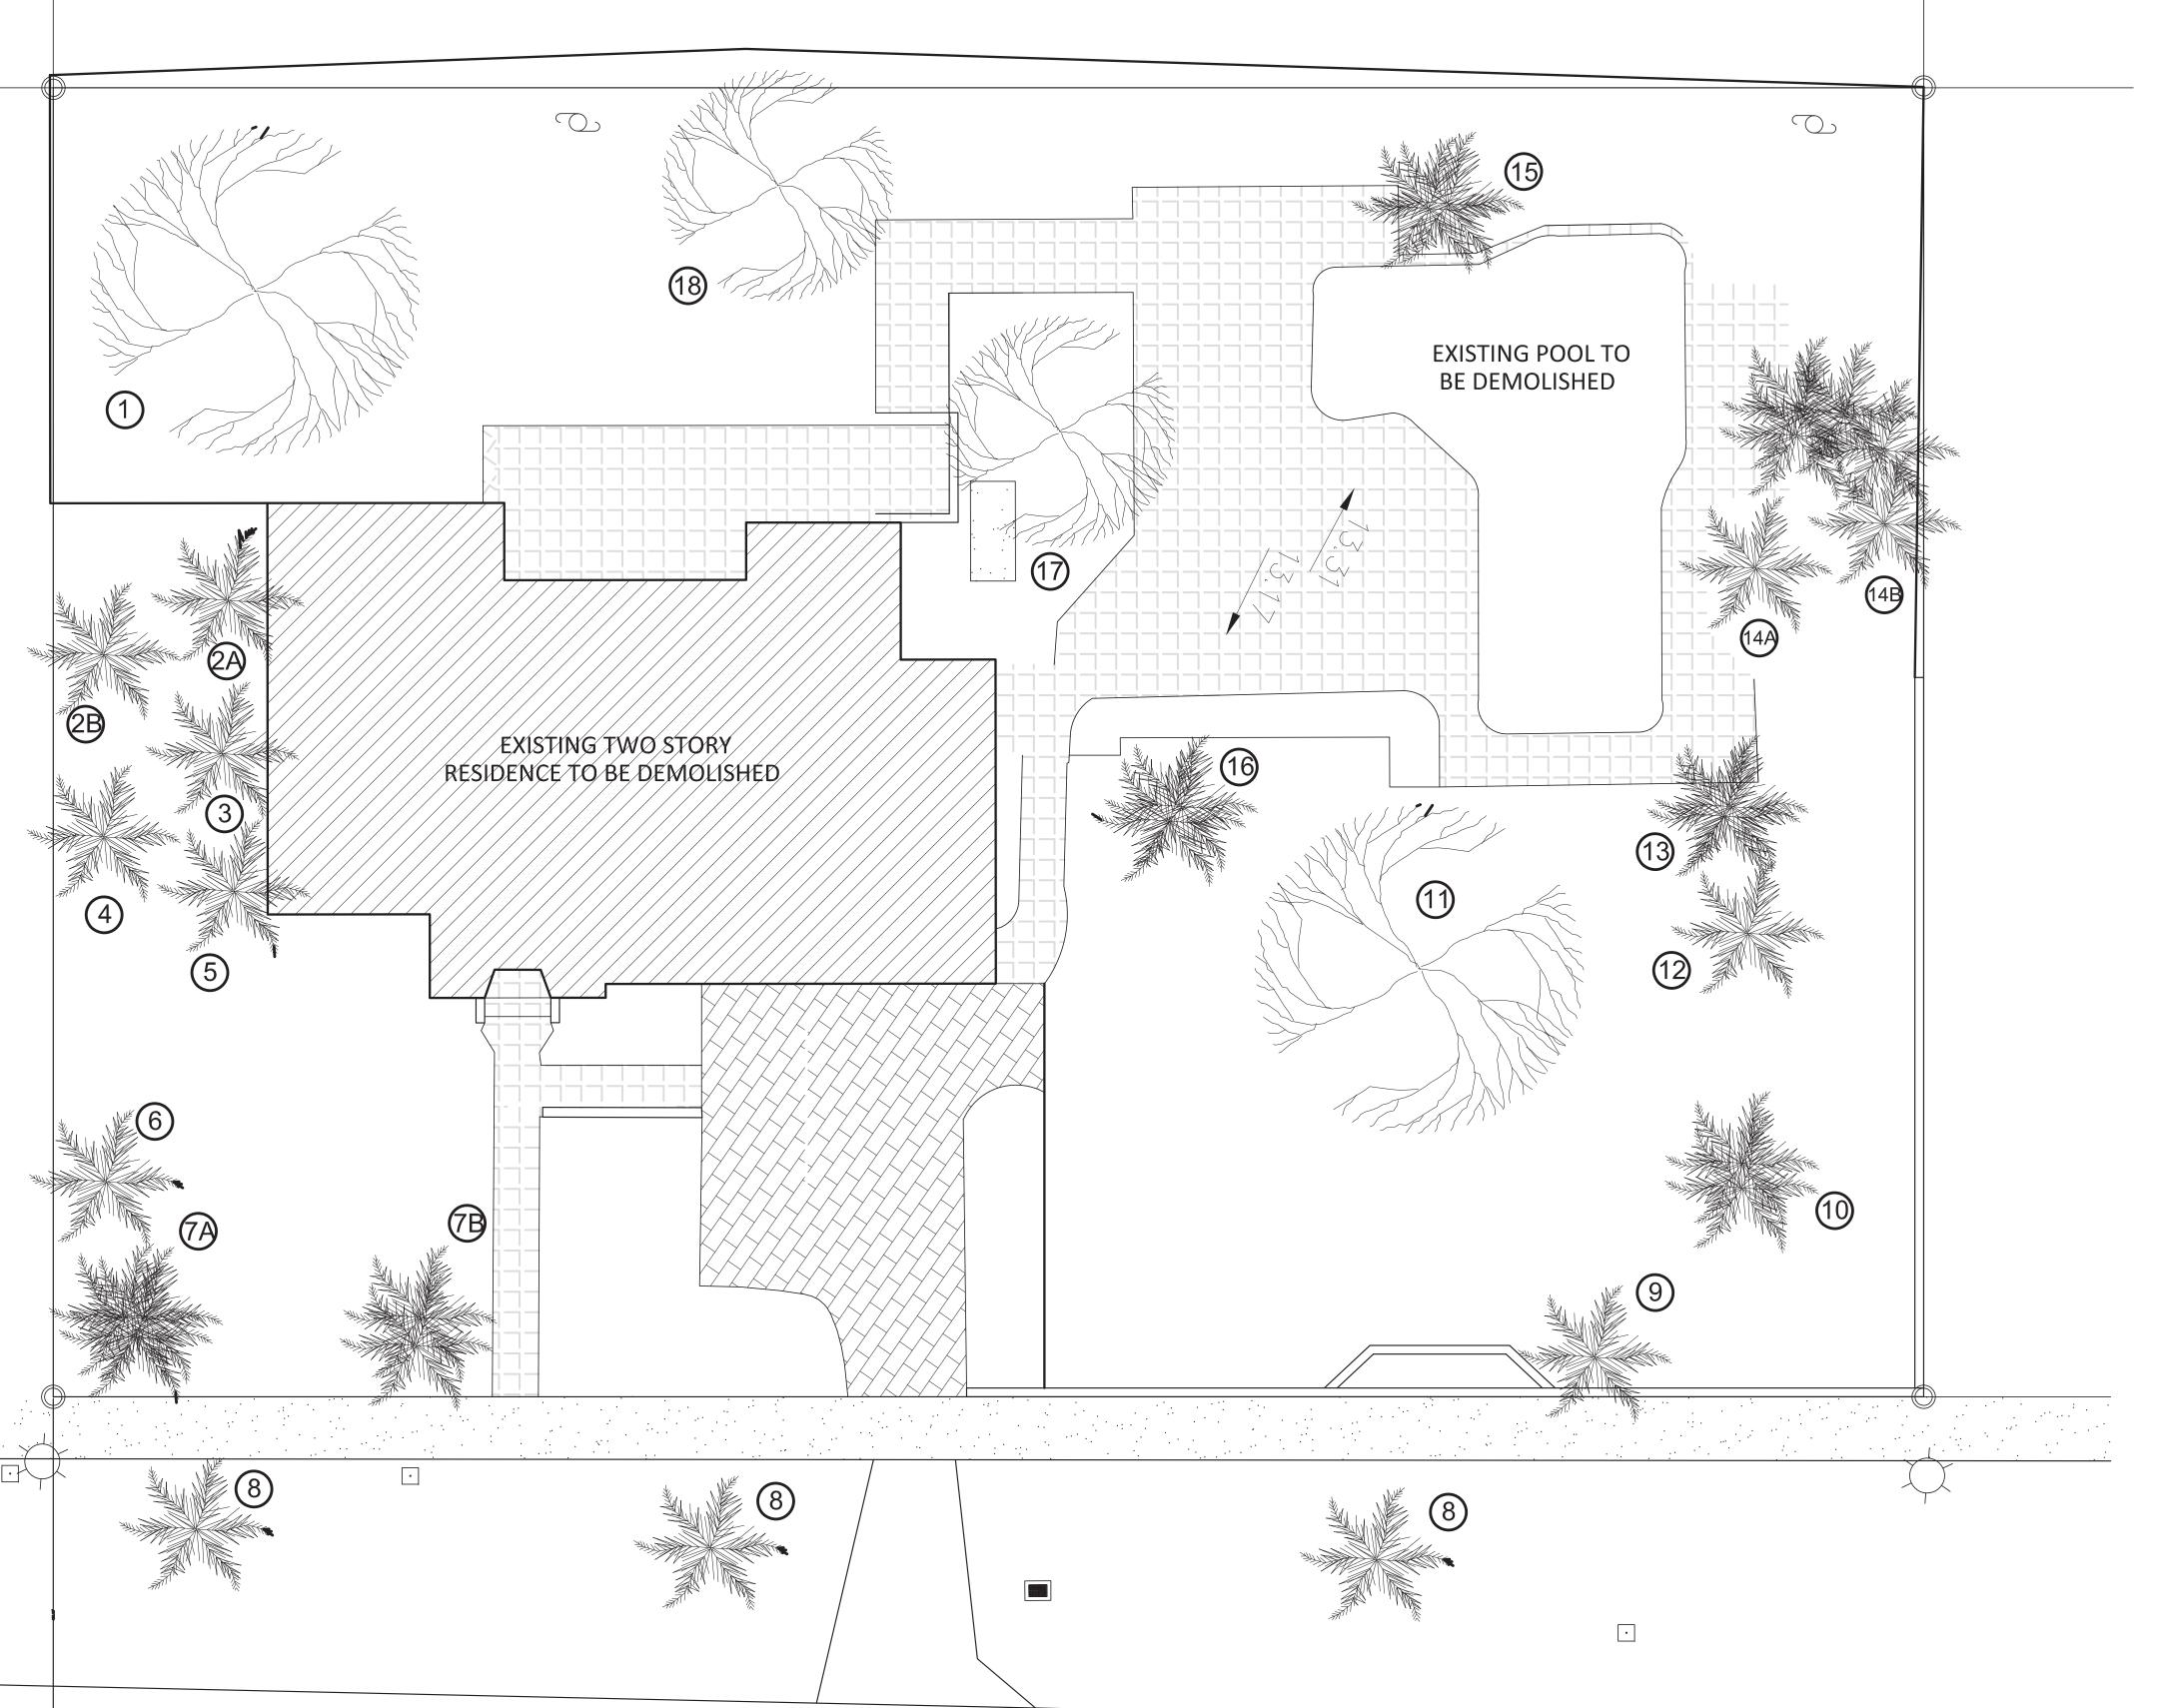

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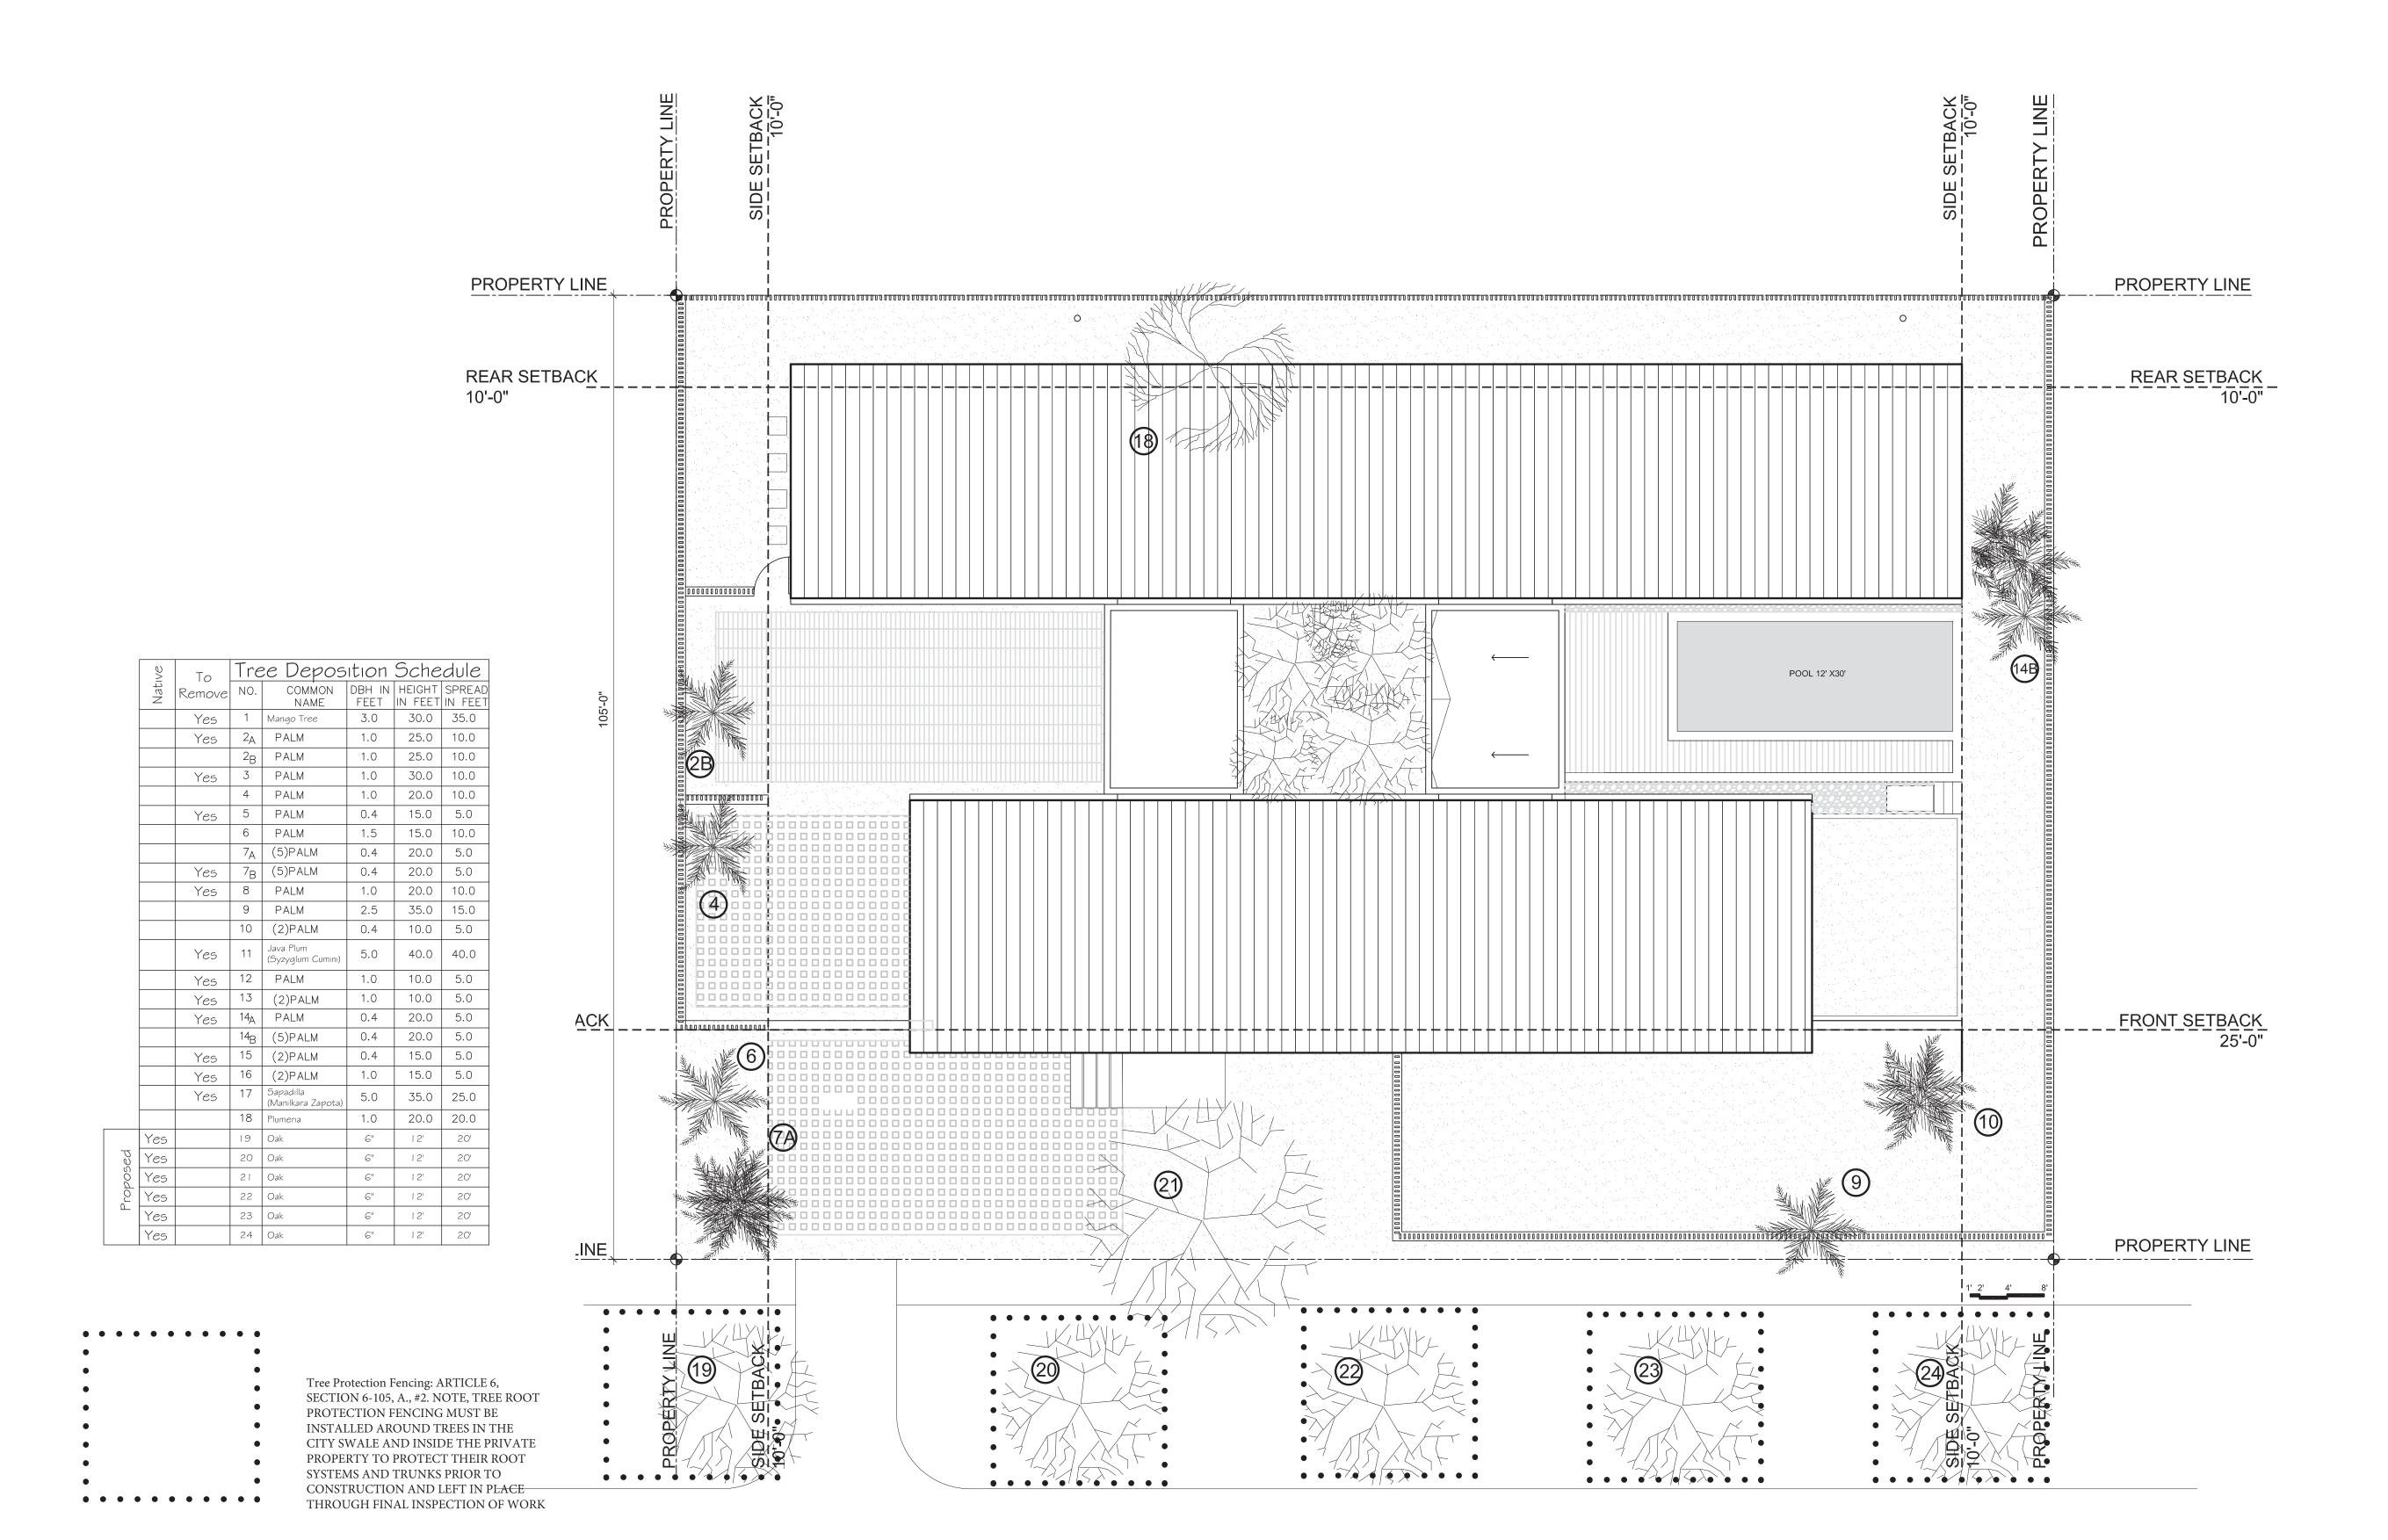
Residence Vicente San

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L-01

Existing Landscape Plan



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L-02