
#### **Architectural Style Statement**


The concept for the proposed remodeling is based on the response of the architectural lines from the existing construction (A). The transition between the new and the existing is achieved through an architectural element defined as a "Portico" (B), which becomes the focal point of the entrance. This "Portico" is created with a new architectural feature wall, which becomes a statement on its own, both for its height and for the usage of a noble cladding material – such as stone. The wall height is greater than the existing top beam, to create a visual bridge between the existing one-story house and the two-story addition. A concrete canopy is used to highlight both the access and the horizontality of the proposed architectural style.

For the two stories addition (C) an architectural volume of pure and simple lines is proposed, recreating cubic architectural style and clean proportions – which is emphasized by using smooth stucco painted in white color. The existing Red Barrel tile will replace with a new flat tile grey color as shown

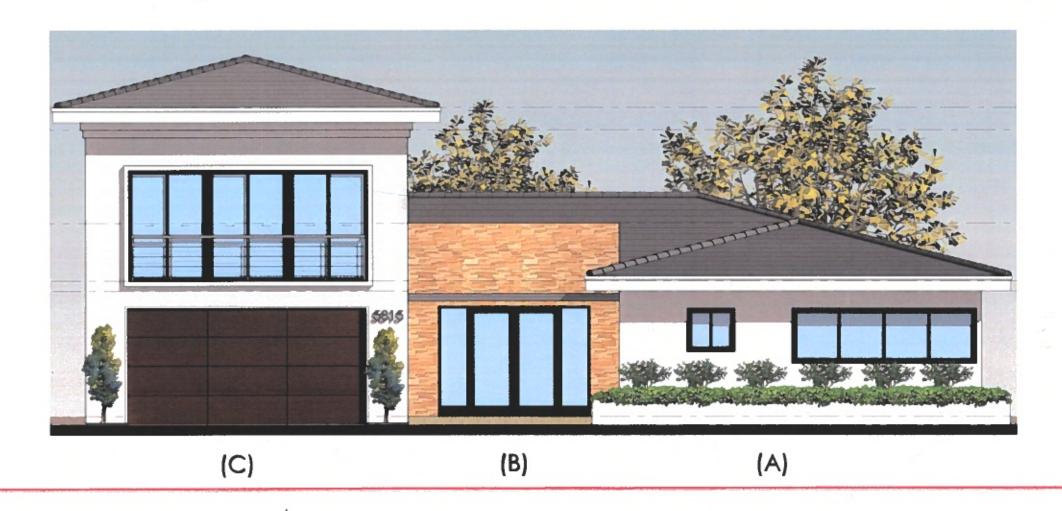





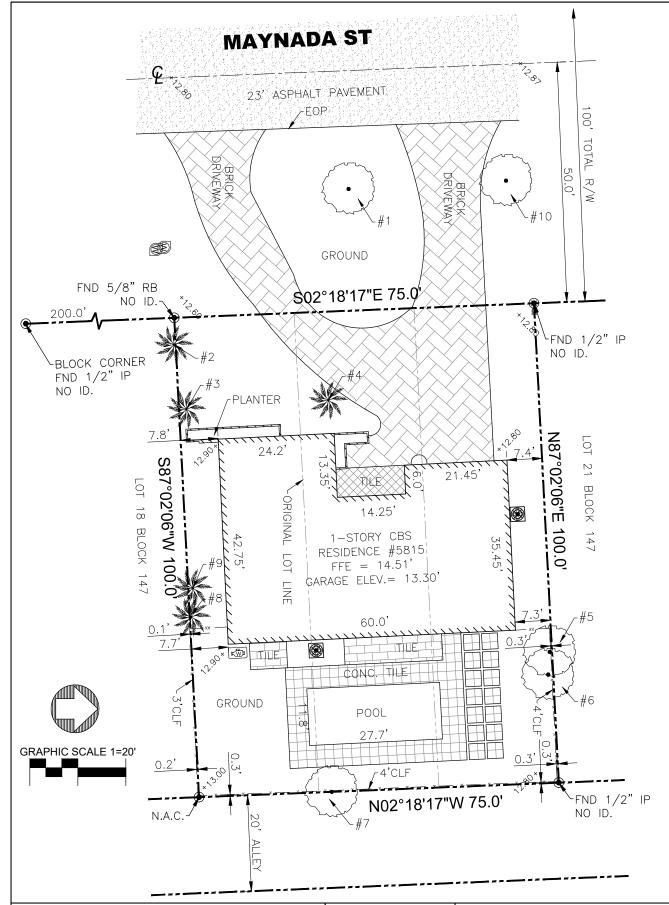

## **BOUNDARY SURVEY**

#### **PROPERTY ADDRESS**

5815 MAYNADA ST, MIAMI, FL 33145

#### PREPARED FOR:

CHRISTIAN A SAPORTA DIANA P CABANZO

#### **LEGAL DESCRIPTION:**

LOT 19, 20 AND 20-A BLOCK 147 OF "CORAL GABLES RIVIERA SEC PT 8", ACCORDING TO THE PLAT THEREOF AS RECORDED IN PLAT BOOK 25 PAGE 55 OF THE PUBLIC RECORDS OF MIAMI-DADE COUNTY, FLORIDA.

#### **SURVEYOR'S NOTES:**

- 1. NO UNDERGROUND PORTIONS OF FOOTINGS, FOUNDATIONS. CONTACT APPROPRIATE AUTHORITY PRIOR TO ANY DESIGN WORK OR CONSTRUCTION.
- 2. LEGAL DESCRIPTION WAS PROVIDED BY CLIENT. NO TITLE SEARCH WAS MADE. EXAMINATION OF ABSTRACT OF TITLE MUST BE MADE TO DETERMINE RECORDED INSTRUMENTS, IF ANY, AFFECTING PROPERTY BESIDES THOSE NOTED.
- 3. NOT VALID WITHOUT THE SIGNATURE AND ORIGINAL RAISED SEAL OF A FLORIDA LICENSED SURVEYOR AND MAPPER.
- 4. TYPE OF SURVEY: TREE SURVEY
- 5. RECORD & MEASURED VALUES ARE IN ACCORDANCE UNLESS OTHERWISE IS NOTED.
- 6. BEARINGS SHOWN HEREON ARE BASED ON AN ASSUMED VALUE OF SO2°18'17"E FOR THE WEST LINE OF BLOCK 147 OF "CORAL GABLES RIVIERA SEC PT 8" PLAT BOOK 25 PAGE 55 OF THE PUBLIC RECORDS OF MIAMI-DADE COUNTY, FLORIDA..
- 7. THE CERTIFICATE DOES NOT EXTEND TO ANY UNNAMED PARTY
- 8. SHOWN ELEVATIONS ARE REFERRED TO THE NATIONAL GEODETIC VERTICAL DATUM (NGVD) OF 1929. BENCH MARK USED CG-22, ELEVATION: 11.31' (NATIONAL GEODETIC VERTICAL DATUM 1929).
- 9. FIELD WORK DATE: 08.01.2020

#### **SYMBOLS & ABBREVIATIONS**

CBS = CONCRETE BLOCK STRUCTURE; CL = CENTER LINE; CLF = CHAIN LINK FENCE; EOP = EDGE OF PAVEMENT; FND= FOUND; I.D.= IDENTIFICATION; IF = IRON FENCE; IP = IRON PIPE; NAC = NOT ACCESSIBLE CORNER; RB = REBAR; R/W= RIGHT OF WAY; SWK = SIDEWALK; UE = UTILITY EASEMENT



A/C UNIT

TREE



PALM TREE
WATER PUMP

— - <del>E</del>

CENTER LINE

CHAIN LINK FENCE

IRON FENCE

RIGHT OF WAY LINE

**DTE:** SYMBOLS SHOWN IN SURVEY DRAWINGS ARE NOT TO SCALE AND SHALL NOT BE USED TO SIZE SUCH ELEMENTS.

TREE INFORMATION									
TREE #	NAME	DBH (INCH)	HEIGHT (FEET)	SPREAD (FEET)	TREE #	NAME	DBH (INCH)	HEIGHT (FEET)	SPREAD (FEET)
1	LIVE OAK TREE	17	35	30	6	LIVE OAK	19	45	30
2	SABAL PALM	12	20	12	7	FICUS BENJAMINA	4	18	10
3	TWO QUEEN PALMS	8 & 7	28	20	8	QUEEN PALM	10	35	20
4	QUEEN PALM	10	30	18	9	QUEEN PALM	8	30	18
5	LIVE OAK TREE	14 & 8	35	25	10	LIVE OAK TREE	18		

TREE INFORMATION WAS PROVIDED BY:
JOE R. RODRIGUEZ, ARBORCARE INC.
ISA—CERTIFIED ARBORIST FL— 124A/TRAQ
LIAF—CERTIFIED LANDSCAPE INSPECTOR #171

#### TREE SURVEY

5815 MAYNADA ST MIAMI, FLORIDA 33146 FOLIO: 03-4130-003-0090 CARDINAL SURVEYORS CO.

#### SURVEYOR'S CERTIFICATE:

I HEREBY CERTIFY: THAT THE SKETCH OF THIS TREE SURVEY WAS PREPARED UNDER MY SUPERVISION AND THAT MEETS THE STANDARDS OF PRACTICE SET FORTH BY THE FLORIDA BOARD OF PROFESSIONAL SURVEYORS AND MAPPERS IN CHAPTER 5J-17.050 OF THE FLORIDA ADMINISTRATIVE CODE PURSUANT TO SECTION 475 OF THE FLORIDA STATUTES AND THAT THE SKETCH THEREON IS TRUE AND CORRECT TO THE BEST OF MY KNOWLEDGE AND BELIEF. SUBJECT TO NOTES AND ANNOTATIONS SHOWN HEREON.



### FERNANDO FERNANDEZ PROFESSIONAL SURVEYOR AND MAPPER

LICENSE LS 6765 STATE OF FLORIDA 1397 WEST 63 STREET, HIALEAH, FLORIDA 33012 CELL PHONE (786) 631 7053

EMAIL: fernandezpsm@gmail.com

Date: 08.02.2020

# Saporta Residence

5815 Maynada Street Coral Gables

# Color Photos

































ST-1 SMOOTH STUCCO COLOR: SW 6070 HERON PLUME BY SHERWIN WILLIAMS OR SIMILAR



PT-1 PAINTED ROOF TILE COLOR: WINDSPRAY BY SHIELDCOAT OR SIMILAR



GL-1 CLEAR GLASS



ALM-1 ALUMINUM WINDOW FRAME

COLOR: BLACK ANODIZED



**SV-1 STONE VENEER**COLOR: STACK STONE WALL
CLADDING



ALM-2 ALUMINUM GARAGE DOOR COLOR: BROWN




International Group Consultants The Professional Network


1508 NE 105 Street Miami Shores, Florida 33138 PH. 786.251.1954


# BOARD OF ARCHITECTS REVIEW APPLICATION SAPORTA RESIDENCE REMODELING - ADDITION


5815 MAYNADA STREET CORAL GABLES, FL. 33146 -2653

# PROPERTY INFORMATION

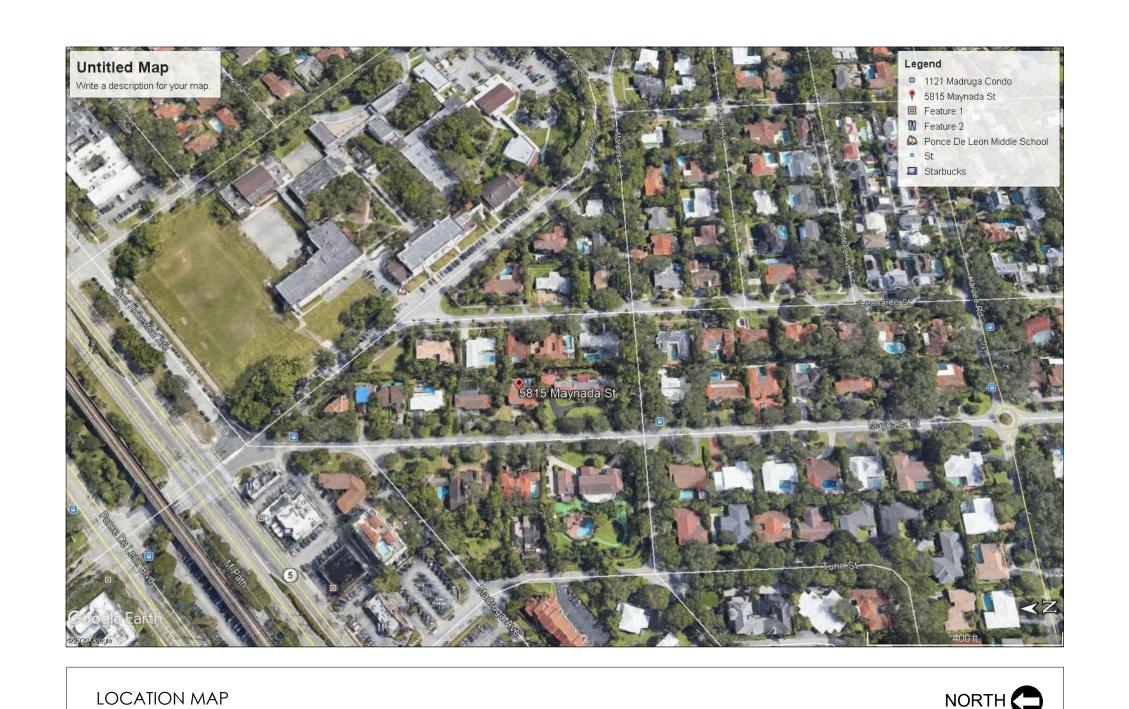

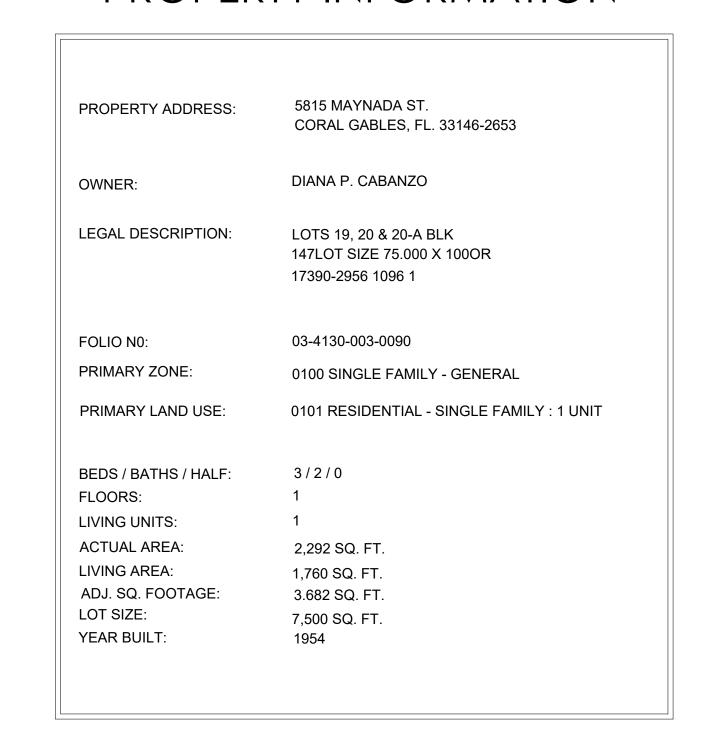

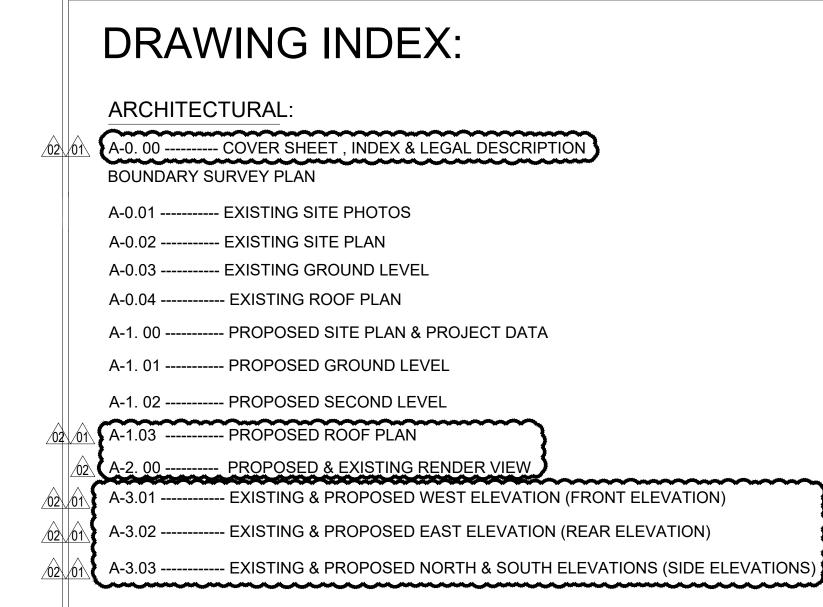


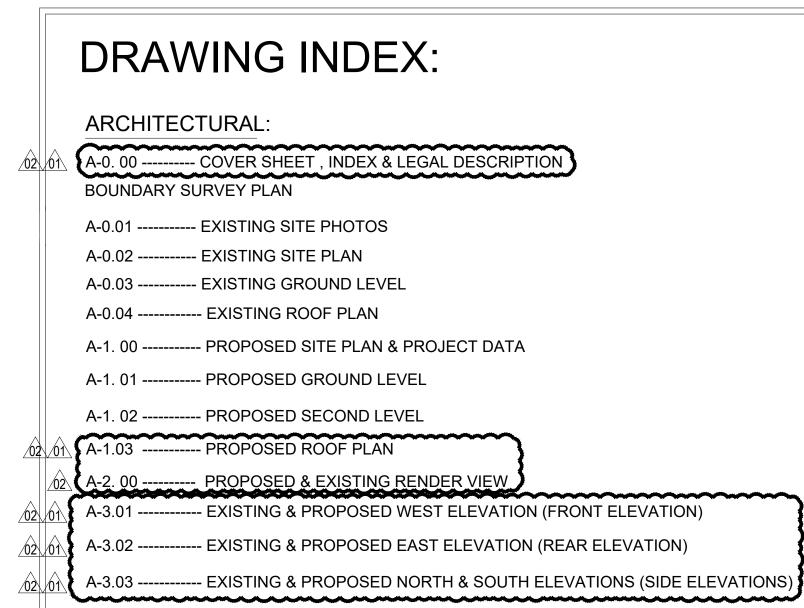



ARCHITECT: LUIS E. URIARTE

18100 Atlantic Boulevard Sunny Isle Beach, FL 33160 Cell. 786.290.9807 Email: invusa@live.com

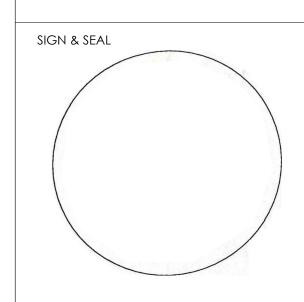

FLA. REG# AR 94107

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FOR USE ON, AND IN CONNECTION WITH, THE SPECIFIED
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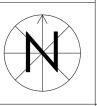
PROJECT IDENTIFICATION

Saporta Residence 5815 Maynada Street Coral Gables FL. 33162-2924

12-20-2020 ZONING COMMENTS 04-30-2021 BUILDING COMMENTS PROJECT NUMBER 052320-01 DRAWN BY COPYRIGHT LEU ARCHITECTS, 2021 03.18.2021 SHEET TITLE

ISSUE DATES

COVER SHEET










PROJECT SITE - EXISTING STRUCTURE

# PROJECT LOCATION

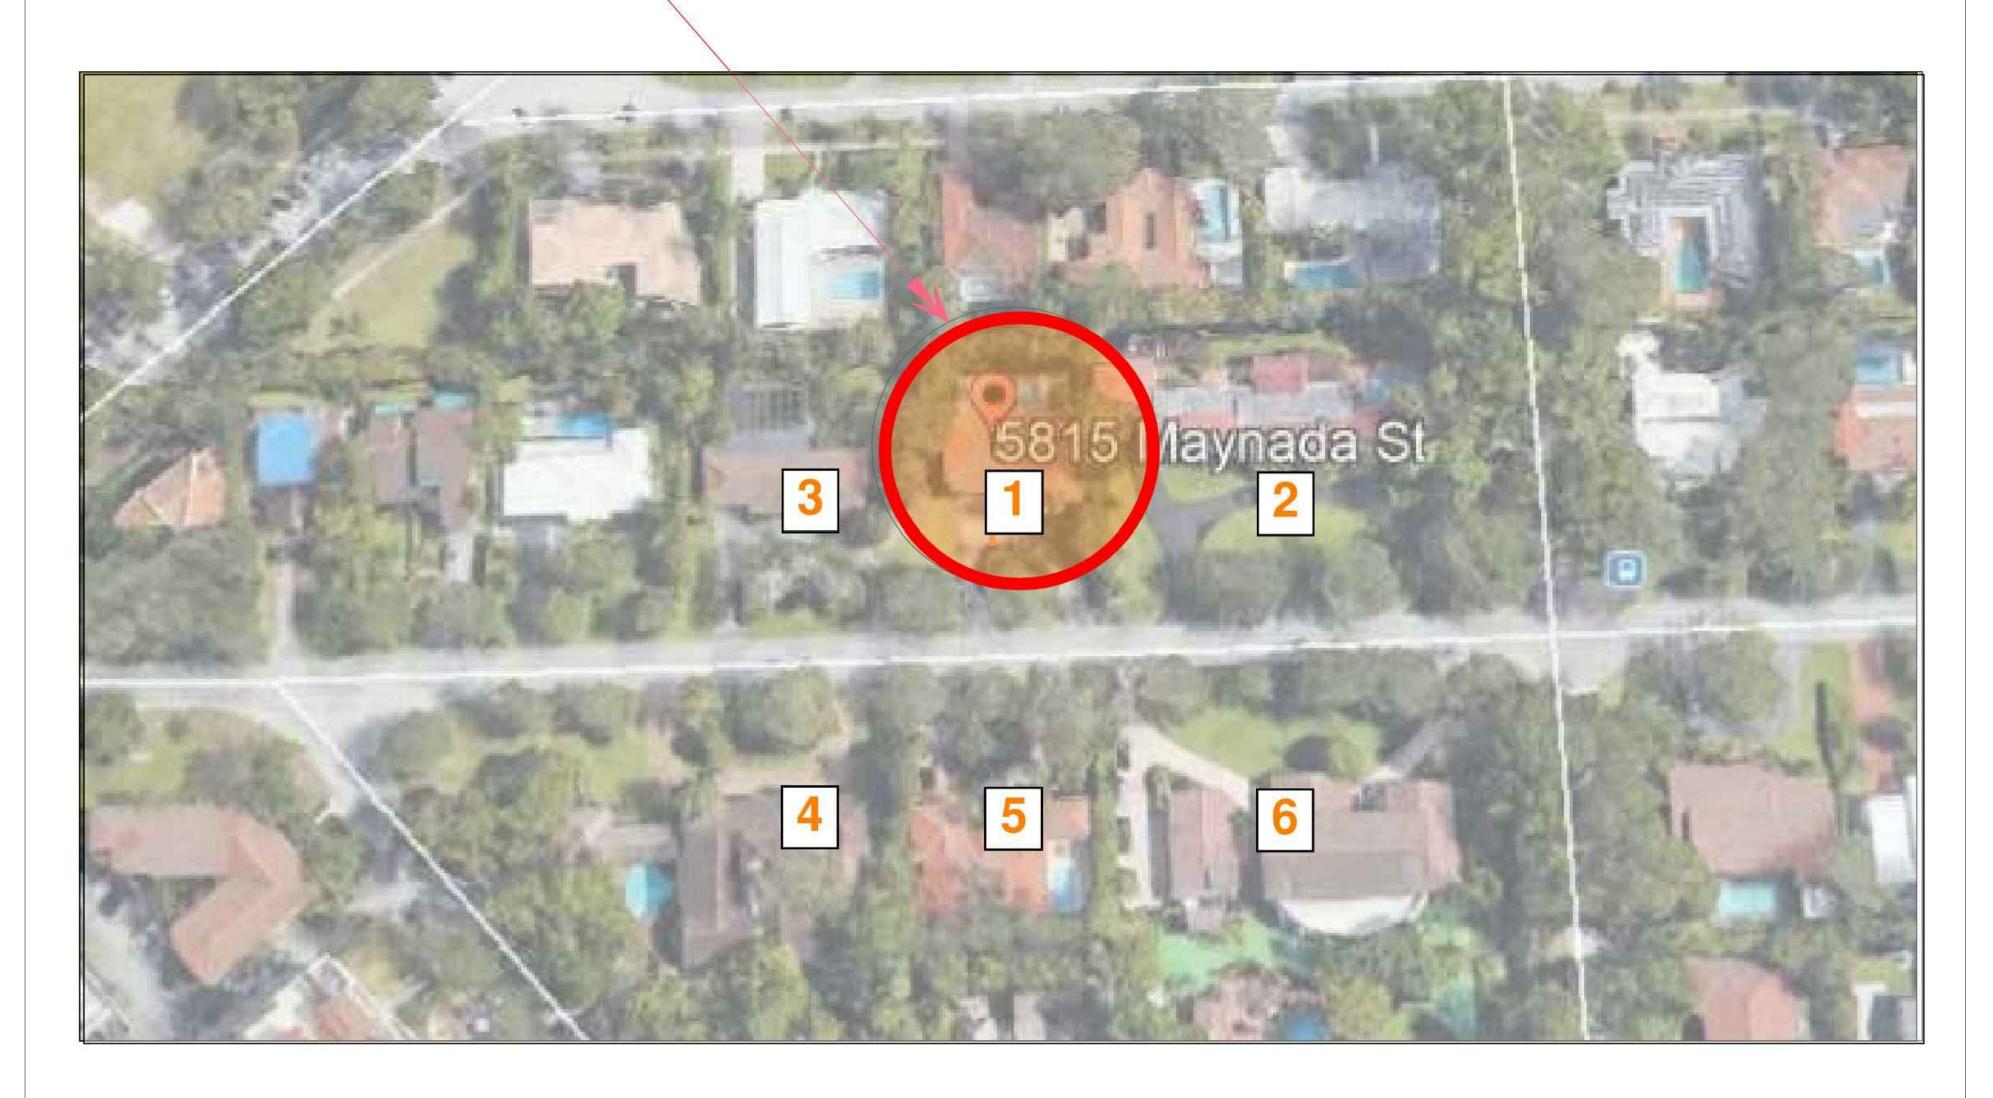








**NEIGHBORHOOD STRUCTURES** 

## ARCHITECT: LUIS E. URIARTE

18100 Atlantic Boulevard Sunny Isle Beach, FL 33160 Cell. 786.290.9807 Email: invusa@live.com

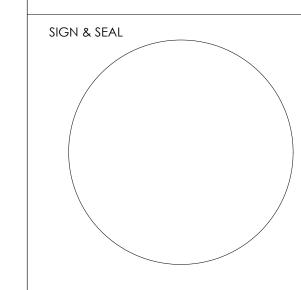

Luis Uriarte FLA. REG# AR 94107

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PROJECT IDENTIFICATION

Saporta Residence 5815 Maynada Street Coral Gables FL. 33162-2924

ISSUE DATES

PPO IFCT NILIMAR

PROJECT NUMBER

DRAWN BY

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SCALE:

SHEET TITLE

EXISTING SITE PHOTOS


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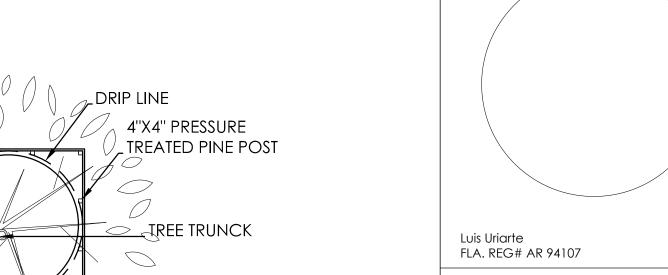
## LEGAL DESCRIPTION

LOT 19, LOT 20 AND LOT 20-A, IN BLOCK 147, OF CORAL GABLES RIVIERA SECTION PART EIGHT, ACCORDING TO THE PLAT THEREOF, AS RECORDED IN PLAT BOOK 25, PAGE 55, OF THE PUBLIC RECORDS OF MIAMI-DADE COUNTY, FLORIDA.

# ARCHITECT:

LUIS E. URIARTE


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6"x6"x6" WIRE MESH

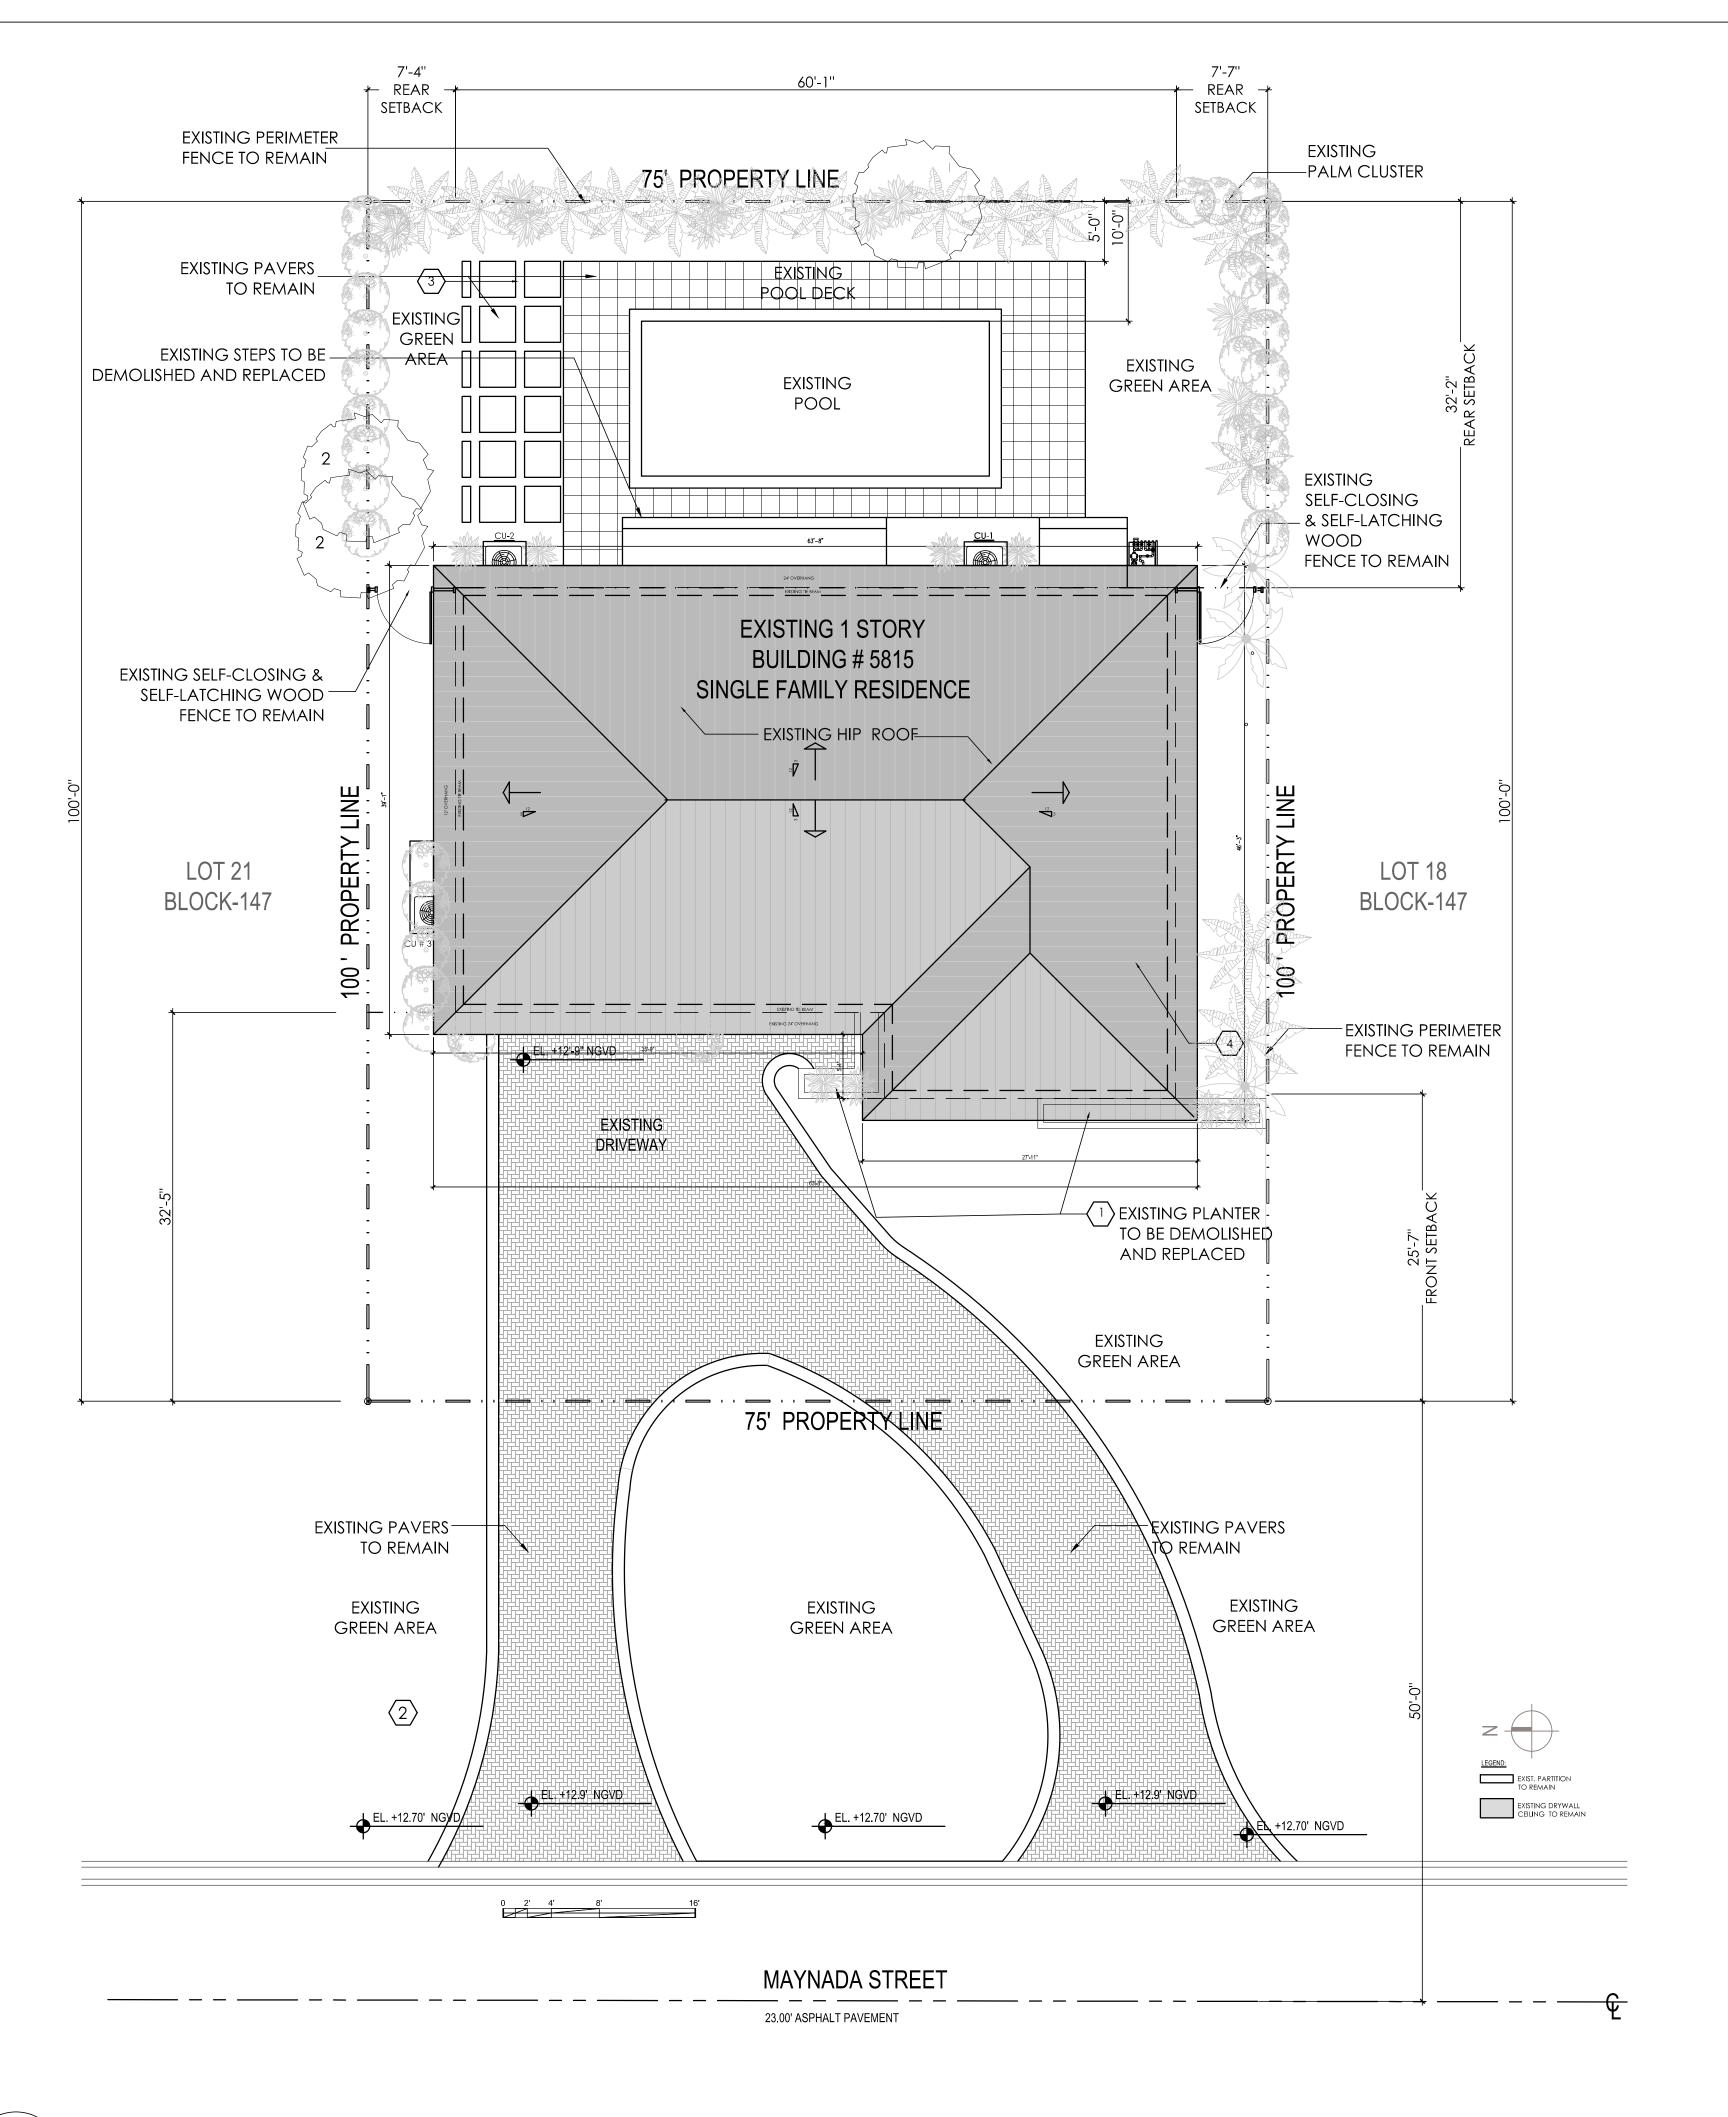ATTACHED TO EACH POST

### WOOD BARRIER DETAIL PLAN



## WIRE MESH BARRIER DETAIL
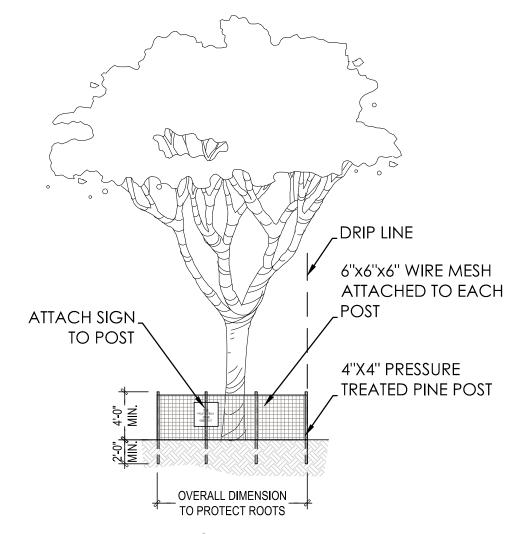
## TREE PROTECTION FENCE NOTES:


- 1. ALL PLANTS DESIGNATED TO BE SAVED SHALL BE PROTECTED BY FENCING, AS ILLUSTRATED.
- 2. INSTALL TREE PROTECTION FENCE AT TREE DRIP LINE OR AT EDGE OF DISTURBED AREA, PRIOR TO COMMENCEMENT OF CONSTRUCTION.
- 3. SPACE TREE PROTECTION ZONE SIGNS A MINIMUM OF ONE EVERY 300 FEET. THE SIZE OF EACH SIGN MUST CONTAIN THE FOLLOWING LANGUAGE IN BOTH ENGLISH AND SPANISH:
- "TREE PROTECTION ZONE, KEEP OUT" 4. THERE SHALL BE NO STORAGE OF MATERIAL WITHIN THE BOUNDARIES OF THE TREE
- 5. TREE PROTECTION FENCING SHALL BE MAINTAINED THROUGHOUT THE DURATION OF THE PROJECT.

PROTECTION FENCING.



KEY NOTES:

- $\langle 1 \rangle$  EXISTING BUILDING FOOTPRINT (EXTERIOR PERIMETER WALL LINE)
- EXISTING TREE TO BE PROTECTED DURING DEMOLITION & CONSTRUCTION. REFER TO TREE PROTECTION DETAIL. A2/A-0.02
- $\sqrt{3}$  PORTION OF ROOF TO BE DEMOLISHED
- (4) ROOF TILE TO BE REPLACED

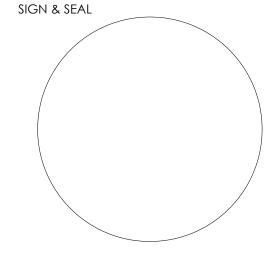

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The Professional Network 1508 NE 105 Street Miami Shores,

International Group Consultants

Florida 33138 PH. 786.251.1954

PROJECT IDENTIFICATION

Saporta Residence 5815 Maynada Street Coral Gables FL. 33162-2924

ISSUE DATES


PROJECT NUMBER 052320-01 DRAWN BY CL COPYRIGHT LEU ARCHITECTS, 2021 03.18.2021

SHEET TITLE


SCALE:

EXISTING SITE PLAN

SHEET NUMBER

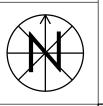


1/8" = 1'-0"

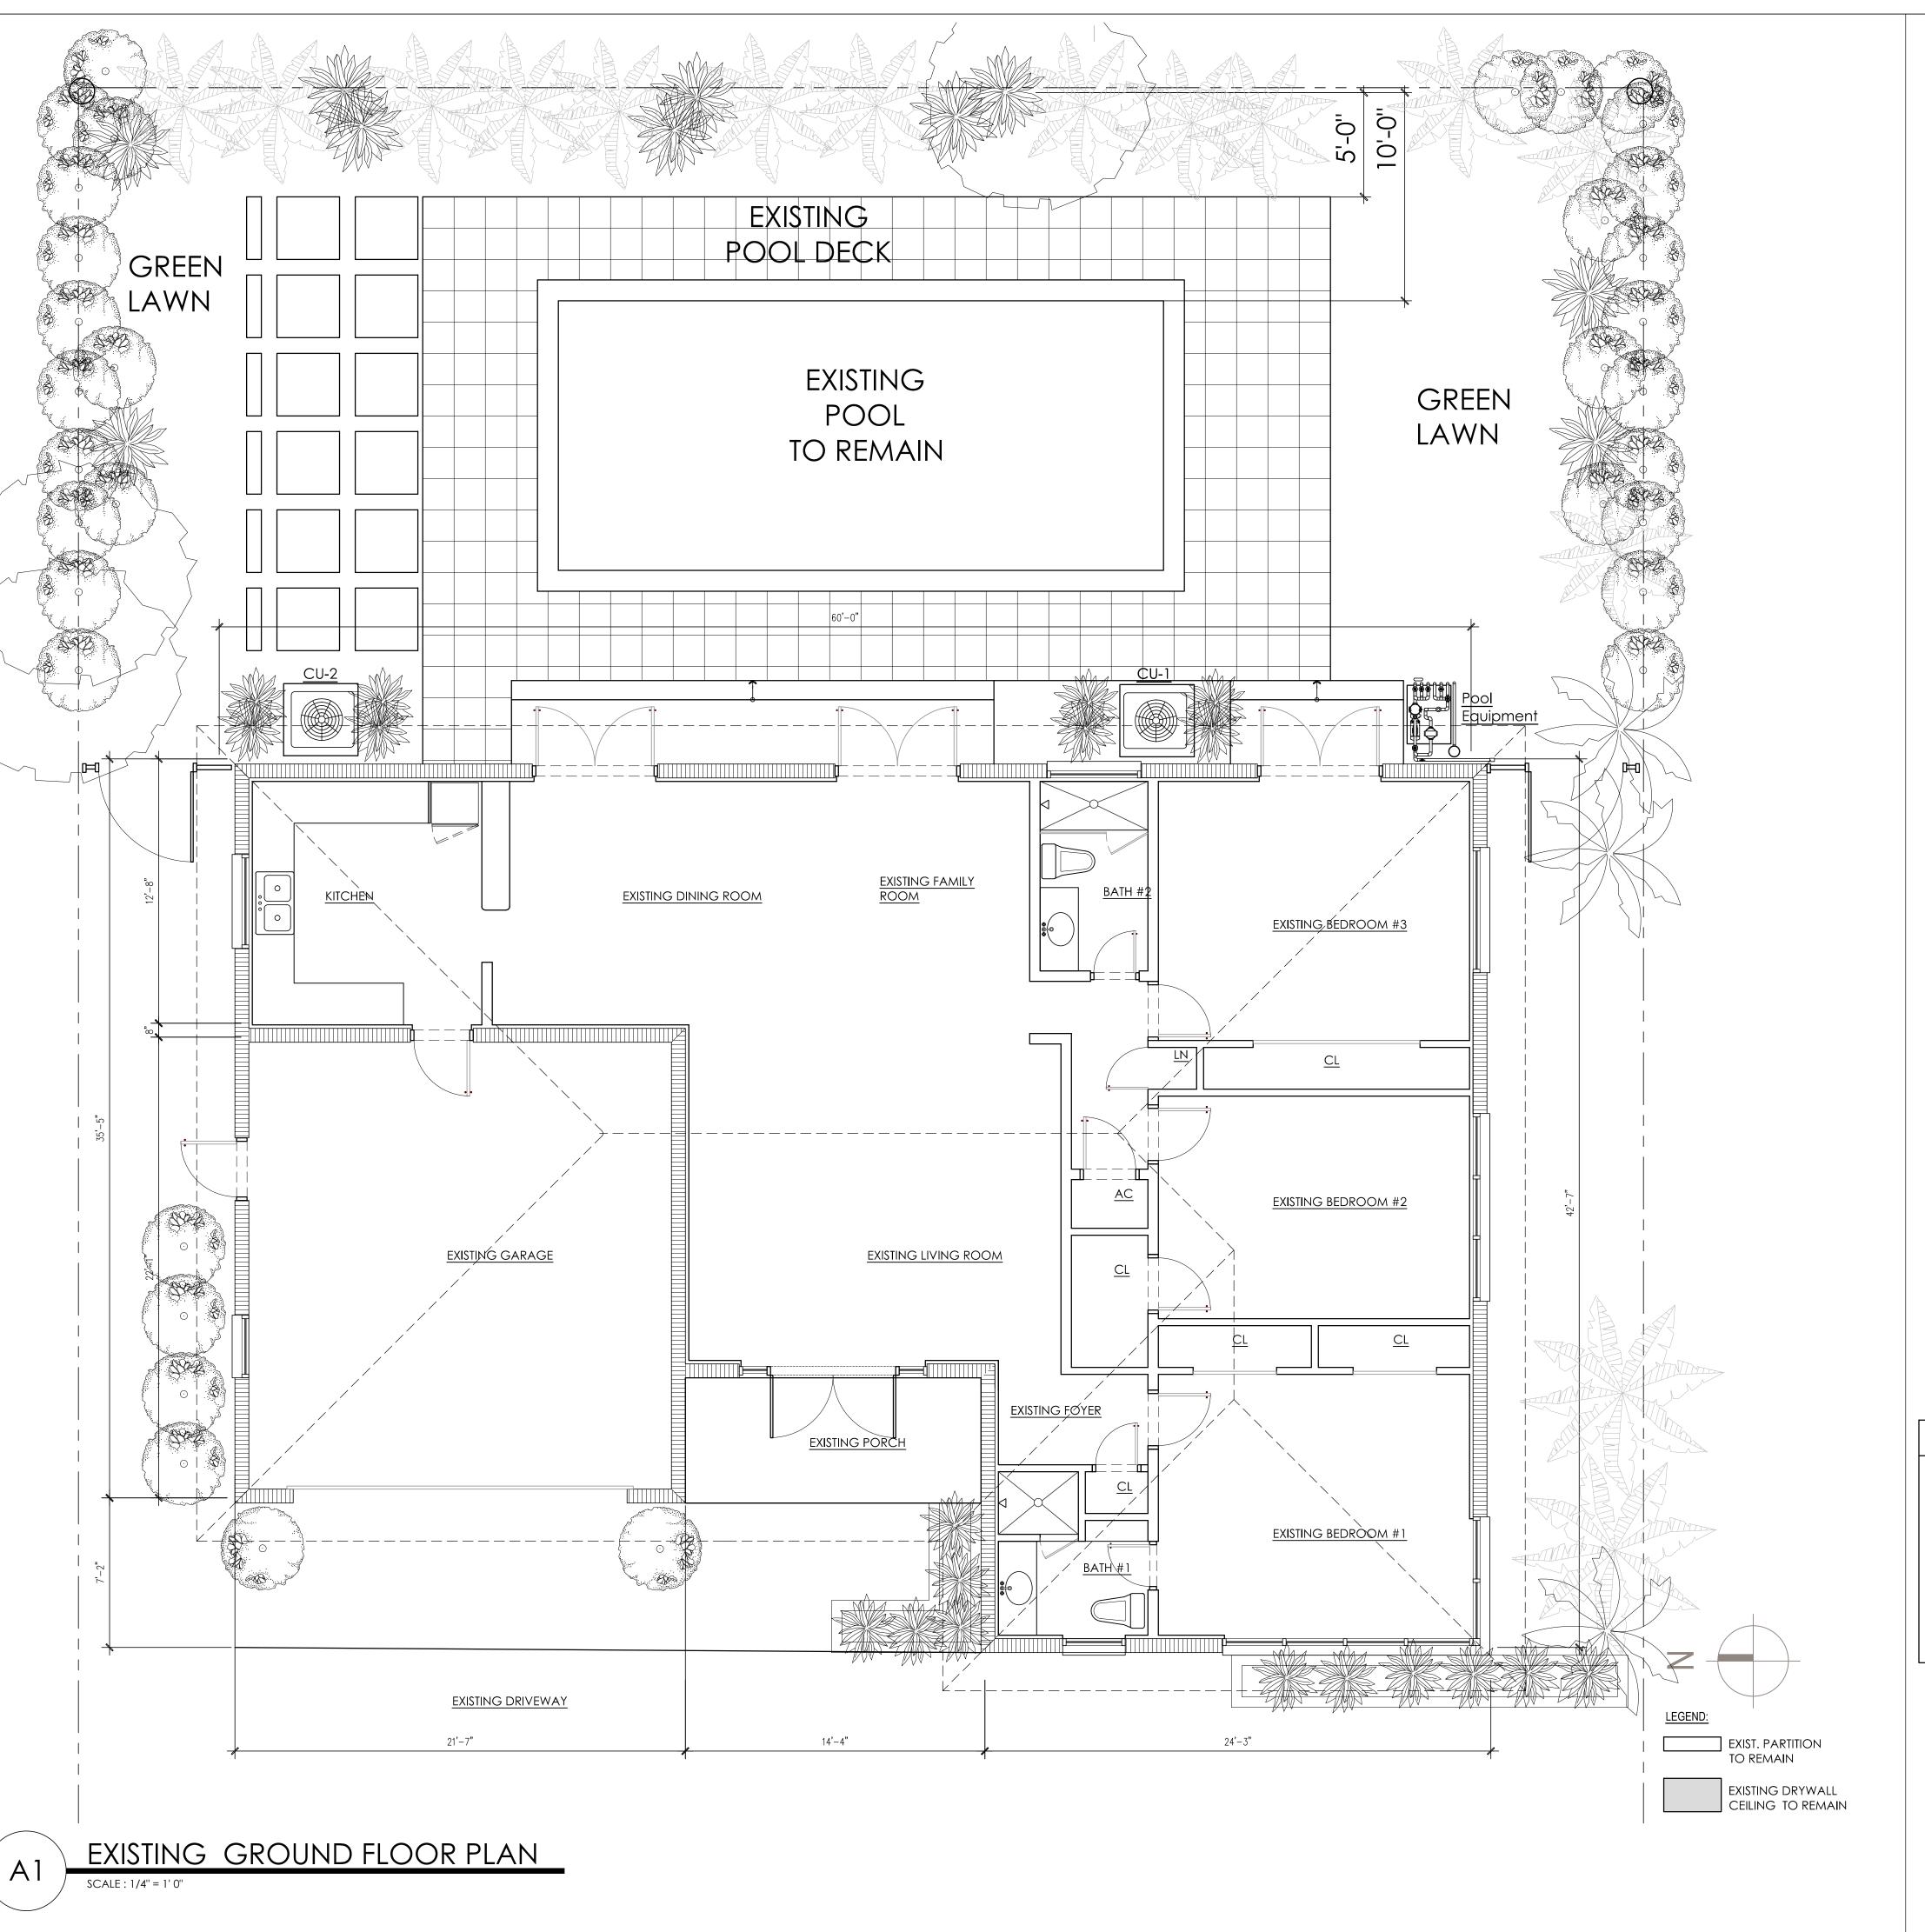

# NEW CONSTRUCTION NOTES:

- GC AND SUBCONTRACTORS ARE RESPONSIBLE TO REPORT IN WRITING TO DESIGNER OF ANY AND ALL DISCREPANCIES IN PLANS/ DETAILS BEFORE COMMENCEMENT OF WORK
- GC TO COORDINATE DISPOSING OF ALL MATERIALS & DEBRIS
- ALL STRUCTURAL & LOAD BEARING WALLS TO REMAIN
- GC RESPONSIBLE FOR LAYING OUT DIMENSIONS PRIOR TO BUILDING TO **ENSURE EXACTNESS**
- GC TO PROVIDE LEVEL 4 TO LEVEL 5 FINISH ON ALL EXISTING AND NEW DRYWALL
- ALL DIMENSIONS GIVEN ARE FROM FINISH FACE TO FINISH FACE
- GC TO PATCH, REFINISH, AND REPAIR AS NEEDED IN INTERIOR SPACE, BOTH DUE TO DEMOLITION AND EXISTING CONDITIONS
- GC TO MEET AND/OR EXCEED LOCAL BUILDING CODE REQUIREMENTS; ALSO FOLLOW 'MODEL ENERGY CODE' OR INTERNATIONAL CONSERVATION CODE
- BUILDER TO USE LOCCALLY PRODUCED 'GREEN' BUILDING MATERIALS WHERE POSSIBLE; ALSO USE LOW/NO VOC EMISSION BUILDING PRODUCTS, VERIFY WITH INTERIOR DESIGNER
- NEW WALLS TO BE CONSTRUCTED WITH MIN R-4.1 VALUE FOR INSULATION AND ACOUSTICS IN PLUMBING WALLS; USE MOISTURE RESISTANT USG HUMITEK  $\frac{5}{8}$  GYPSUM BOARD OVER METAL STUDS AT 16" O.C.
- 11. LOCATION OF INTERIOR PARTITIONS AND ROOM NAMES SHOWN ON THE FLOOR PLAN REFLECT PROPOSED ROOM USES
- 12. ALL GLASS FRAMELESS SHOWER ENCLOSURES (TO BE TEMPERED SAFETY GLASS) AND APPLIED MIRRORS TO BE PROVIDED BY GC--REFER TO SCHEDULE FOR SPECIFICATIONS
- 13. GC TO PROVIDE PROPER CEILING/WALL SUPPORT FOR ALL SHOWER ENCLOSURES, NEW LIGHT FIXTURES WHERE SPECIFIED
- 14. INSTALL NEW PLATES, OUTLETS, SWITCHES, ETC
- ALL FINISHES TO BE SMOOTH, PAINT READY
- ALL WALL FINISHES IN WET AREA TO BE MOUNTED ON WATER RESISTANT CEMENT BOARD
- PAINT WALLS, CEILINGS AND MOLDINGS THROUGHOUT
- INSTALL NEW BASEBOARDS THROUGHOUT
- LOCATION OF INTERIOR PARTITIONS & ROOM NAMES SHOWN ON FLOOR PLAN, REFLECT PROPOSED ROOM USES
- WINDOW SILLS TO REFINISHED WITH DRYWALL AND SQUAREDEDGE
- GC TO REINFORCE WALL WITH  $\frac{3}{4}$ " PLYWOOD WHERE IS INDICATED AND COORDINATED WITH CARPENTER.
- 22. ALL THRESHOLD WILL NOT EXCEED ½" MAXIMUMS SHALL COMPLY WITH FBC 2017 5TH EDITION, SECTION 1008.
- PROVIDE WALL TILES IN BATHROOM WET AREAS TO 70" ABOVE FLOOR IN COMPLIANCE WITH FBC § R307 § 1210.3.
- INTERIOR FINISHED FLOOR AT THE REQUIRED EGRESS DOOR SHALL NOT TO BE MOREE THAN 1  $\frac{1}{2}$  INCHES LOWER THAN THE TOP OF THRESHOLD. FBC 2017 6TH EDITION R311.3.1.

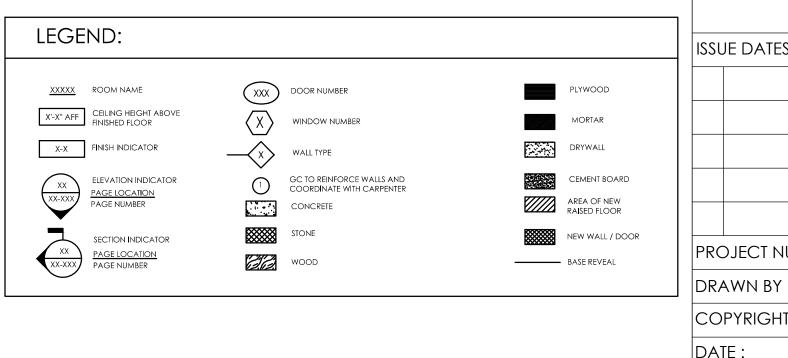

OUT OF SCOPE NEW C.M.U EXIST. C.M.U. TO REMAIN NEW PARTITION

EXIST. PARTITION WALL TYPE SECTION

EXISTING DRYWALL

SCALE: EXIST. PARTITION TO REMAIN

CEILING TO REMAIN

GROUND FLOOR PLAN

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SHEET NUMBER

ARCHITECT:

Cell. 786.290.9807

SIGN & SEAL

FLA. REG# AR 94107

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DIMENSIONS. CONTRACTOR SHALL VERIFY AND BE RESPONSIBLE OR DIMENSIONS AND CONDITIONS OF THE JOB AND LEU ARCHITECT BE NOTIFIED IN WRITING OF ANY VARIATION FROM THE DIMENSIONS, CONDITIONS AND SPECIFICATIONS

International Group Consultants

1508 NE 105 Street Miami Shores,

The Professional Network

PROJECT IDENTIFICATION

Coral Gables

FL. 33162-2924

ISSUE DATES

PROJECT NUMBER

SHEET TITLE

EXISTING

Saporta Residence

5815 Maynada Street

Florida 33138 PH. 786.251.1954

APPEARING ON THESE PLANS (c) 2021.

LUIS E. URIARTE

18100 Atlantic Boulevard Sunny Isle Beach, FL 33160


Email: invusa@live.com




052320-01

03.18.2021

1/4" = 1'-0"

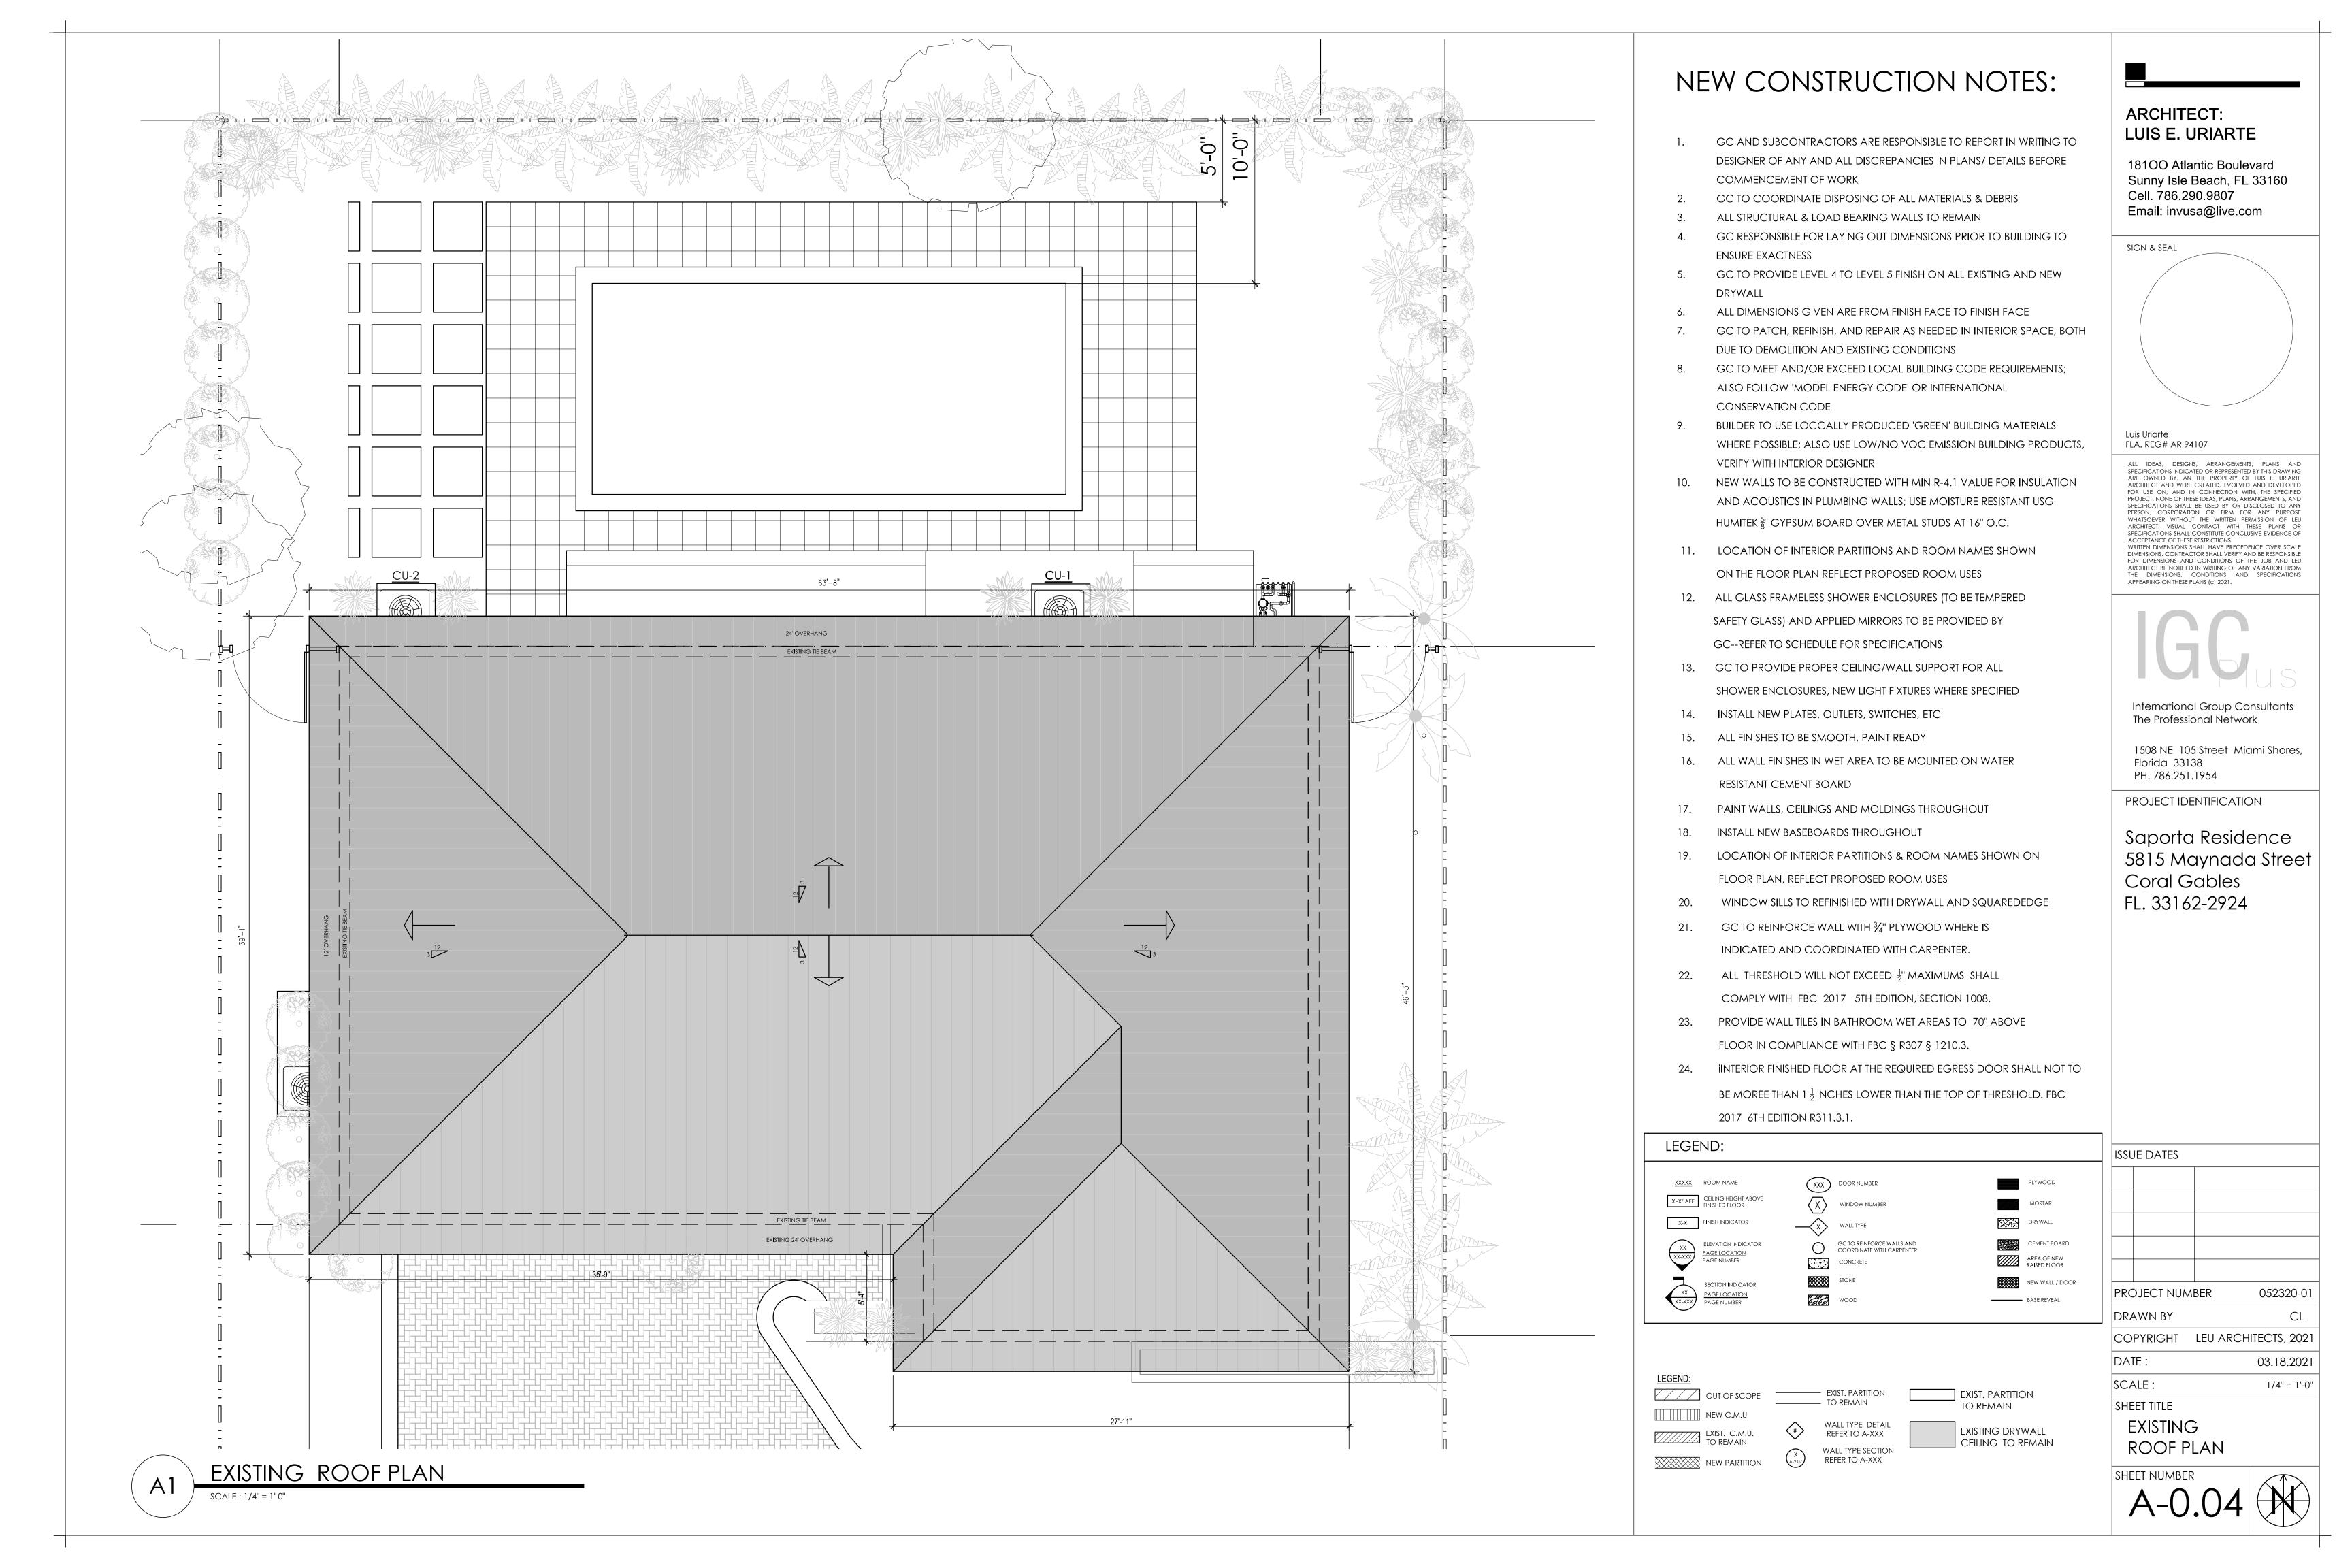

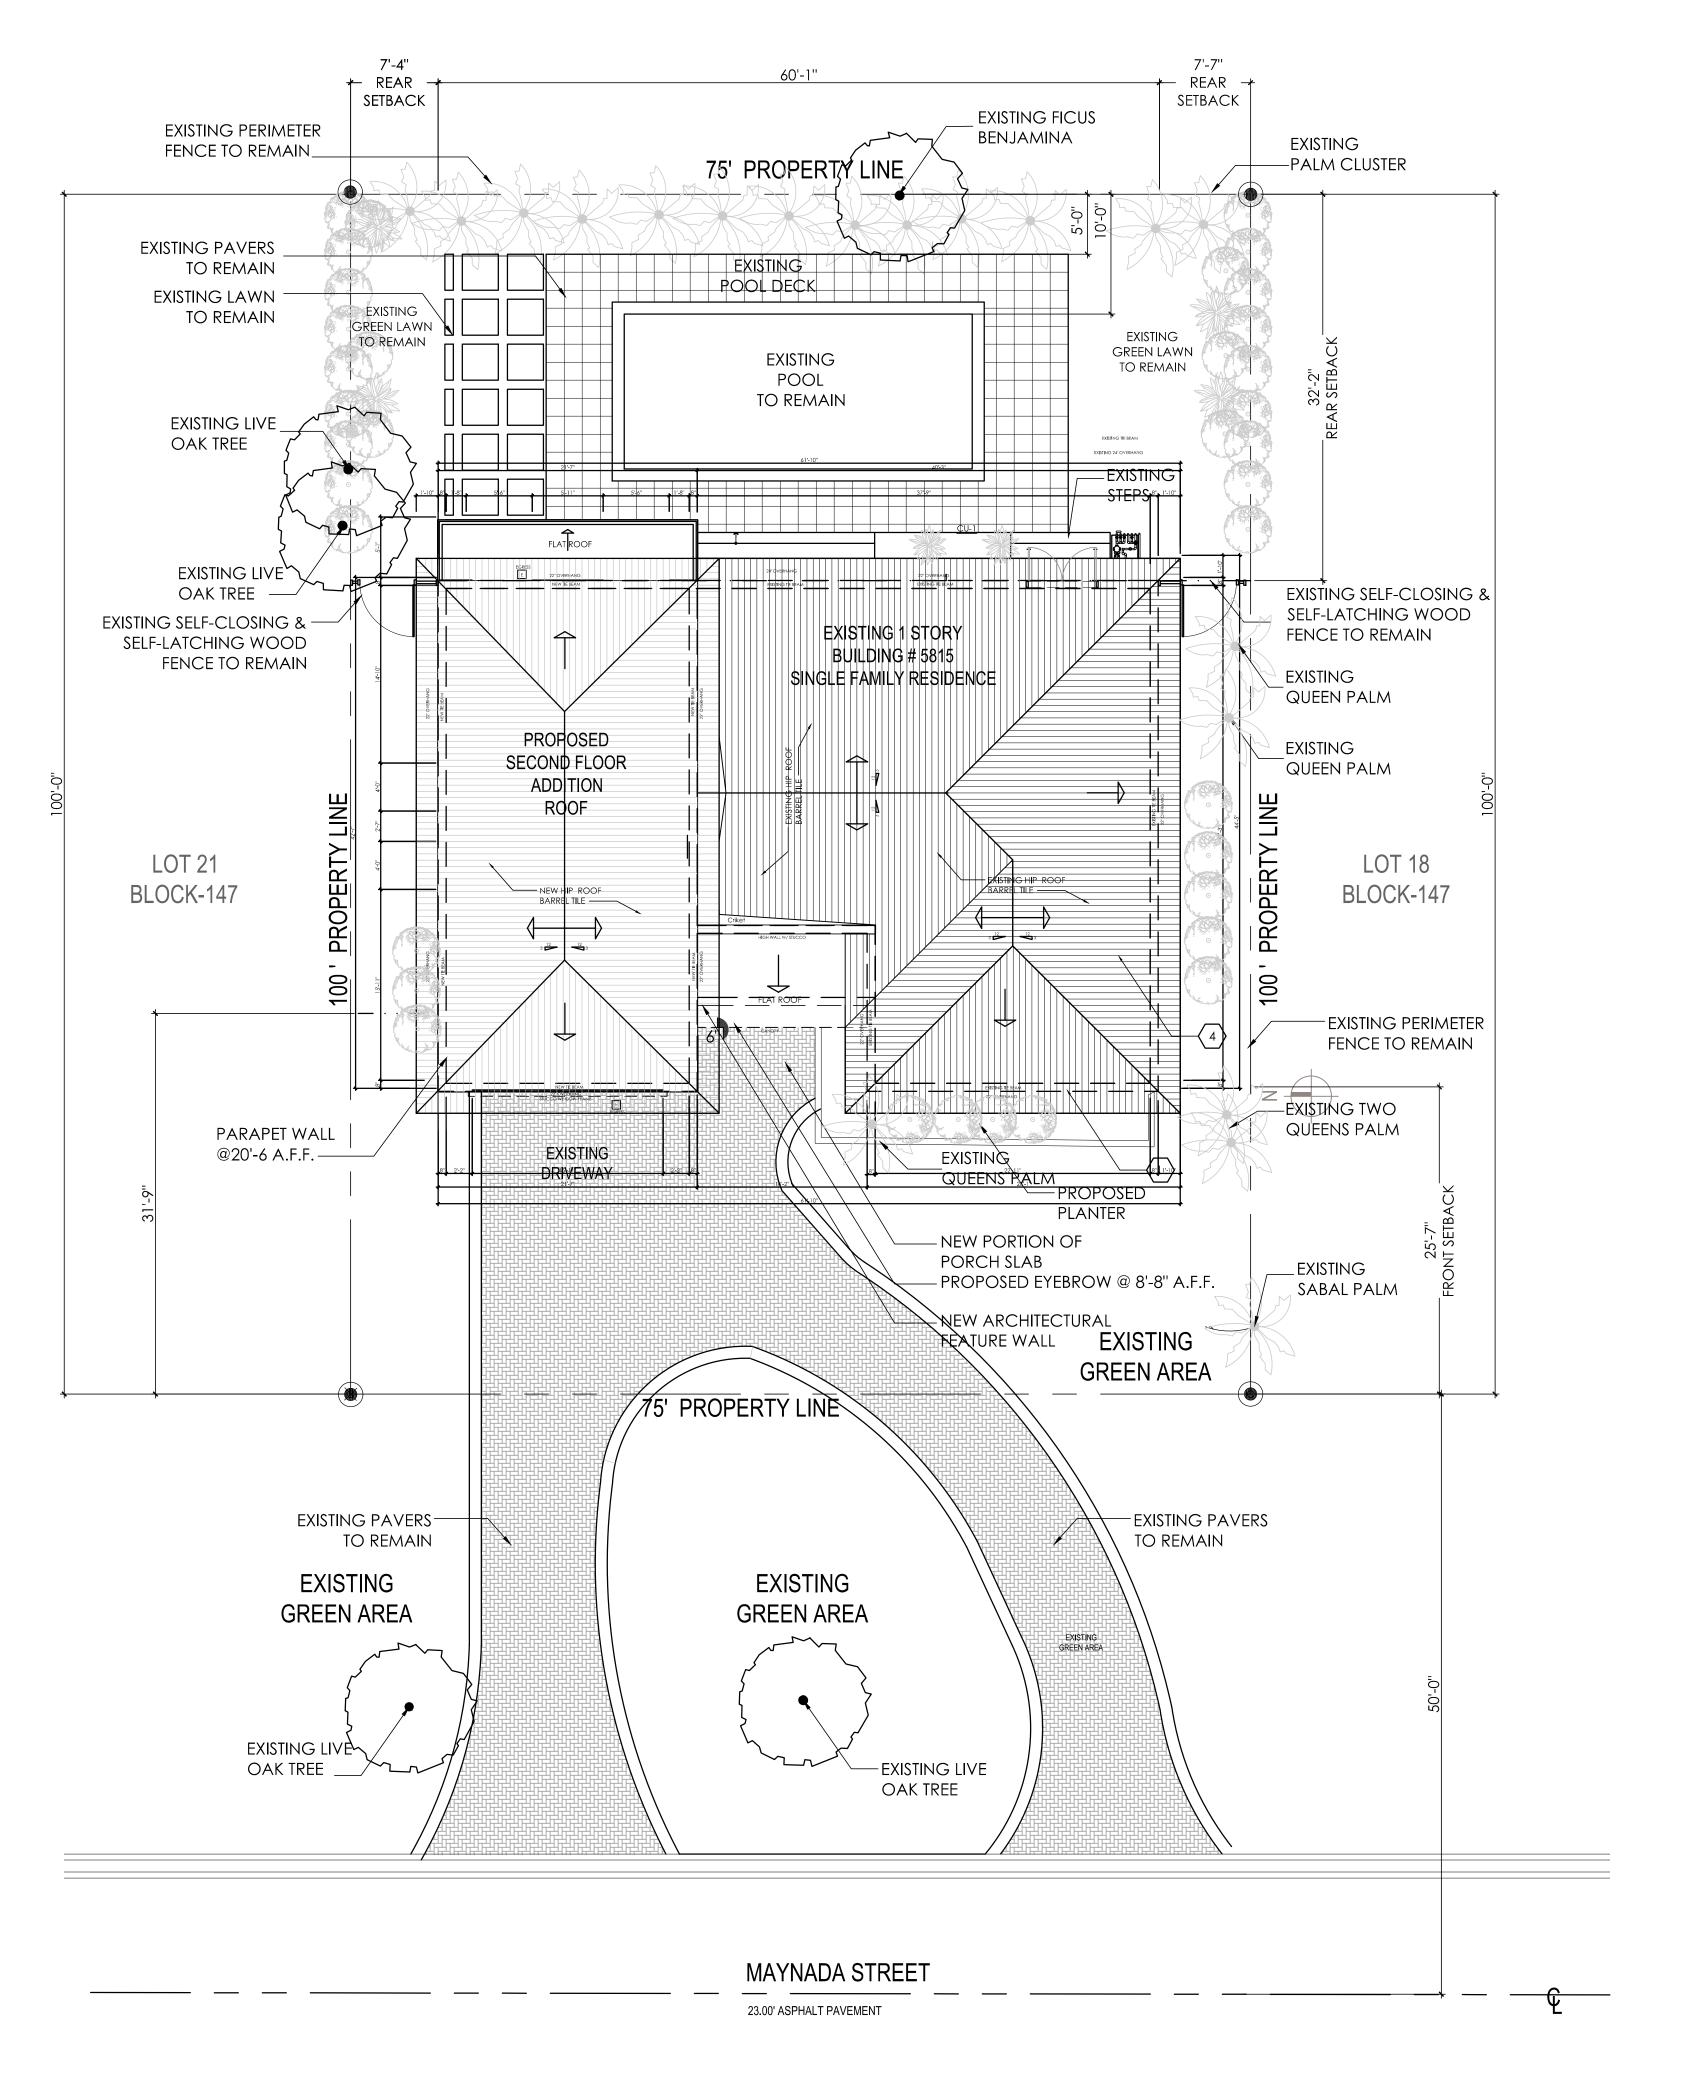

## **ZONING DATA**

A. CURRENT USE OF PROPERTY

B. LAND USE DESIGNATION

SINGLE-FAMILY SFR - RESIDENTIAL SINGLE-FAMILY

SFR

C. ZONING DESIGNATION / REZONING REQUEST

**EXISTING** 

PROPOSED

SFR

D. WATER / WASTEWATER

SERVICE PROVIDER

E. SITE AREA / LOT SIZE:

CITY OF CORAL GABLES  $100' \times 75' = 7,500 \text{ SQ.FT.}$ 

F. FLOOR FOOTPRINT COVERAGE (MAX. OF 35%) ALLOWED 2,625 SQ.FT. 2,213 SQ.FT. 2,370 SQ.FT.

EXISTING PROPOSED

G. FLOOR AREA RATIO (F.A.R.) CALCULATIONS: 0.438533 FOR BUILDING SITE AREA OF

EXISTING

PROPOSED 2.217 SQ.FT @ Ground Level 835 SQ.FT @ 2nd. Level

ALLOWED: 3,600.00 SQ.FT.

5,000 SQ.FT. OR LESS MAX. OF 48%

2,270 SQ.FT. 3,052 SQ.FT

3,524.50 SQ.FT. 3,251.00 SQ.FT.

\*THE DETERMINATION OF A BUILDING'S FLOOR AREA RATIO SHALL EXCLUDE THE FOLLOWING:

a. THE THICKNESS OF EXTERIOR WALLS, MEASURED FROM THE INTERIOR FACE OF THE STRUCTURE.

H. PARKING REQUIREMENTS NOT APPLICABLE.

**PROPOSED** EXISTING I. BUILDING HEIGHT 1 STORY ALLOWED: TWO (2) STORIES OR (2) STORIES 14 FEET HEIGHT TWENTY-FIVE (25) FEET 21 FEET HEIGHT

J. SETBACKS REQUIRED PROPOSED FRONT SETBACK 25 FEET 25 FEET SIDE SETBACK \*\* 7.5 FEET 7.5 FEET 7.5 FEET SIDE SETBACK \*\* 7.5 FEET REAR SETBACK 10 FEET 32.2 FEET

\*\*SIDE SETBACK -20% OF THE TOTAL LOT WIDTH, COMBINE MAX. OF (20) FEET ON BOTH SIDES

K. LANDSCAPE REQUIREMENTS OPEN SPACE CALCULATIONS

EXISTING PROPOSED 2,213.00 SQ.FT. 2,370.00 SQ.FT. BUILDING FOOTPRINT AREA: 1,879.00 SQ.FT. DRIVEWAYS, WALKWAYS, 1,762.50 SQ.FT. POOL DECK

3,975.50 SQ.FT. 4,249.00 SQ.FT. TOTAL IMPERVIOUS AREA:

**OPEN SPACE** (TOTAL PERVIOUS AREA):

LANDSCAPE OPEN SPACE ALL BUILDING SITES SHALL PROVIDE LANDSCAPED

OPEN SPACE OF NO LESS THAN 40% OF THE AREA OF THE BUILDING SITE. 3,000 SQ.FT. MIN REQUIRED - 3,251.00 SQ.FT. PROVIDED

L. OPEN SPACE FRONT YARD

20% MINIMUM LANDSCAPE REQUIREMENT (3,000 x 20%) 600 SQ.FT. MIN REQUIRED - 1,122.5 SQ.FT. PROVIDED

EXISTING PROPOSED DRIVEWAY (IMPERVIOUS AREA) 1,056.0 SQ.FT. 953.5 SQ.FT. 1,276.0 SQ.FT. 1,122.5 SQ.FT. OPEN SPACE (LANDSCAPE AREA) FRONT YARD AREA (25' X 75') 1,875 SQ.FT. 1,875.0 SQ.FT.

M. APPLICABLE CODES

(a) FLORIDA BUILDING CODE, 6TH EDITION (F.B.C. 2017) RESIDENTIAL (b) FLORIDA FIRE PREVENTION CODE, 6TH EDITION (F.F.P.C. 2017) W / LOCAL

AMENDMENTS.

(c) CITY OF CORAL GABLES ZONING CODE.

OCCUPANCY CLASSIFICATION (FBC SEC. 310): RESIDENTIAL R-3. TYPE OF CONSTRUCTION (FBC SEC. 601 TABLE 601): TYPE IIIA CONSTRUCTION NOT SPRINKLER

NUMBER OF STORIES (F.B.C. SECTION503 TABLE 504.3 & TABLE 504.4): MAX. HEIGHT ALLOWED 65 FT. - 4 STORIES BUILDING HEIGHT: 21'-0" A.F.F. ADDITION

CODE DATA

KEY NOTES:

 $\langle 1 \rangle$  EXISTING BUILDING FOOTPRINT (EXTERIOR PERIMETER WALL LINE)

EXISTING TREE TO BE PROTECTED DURING DEMOLITION & CONSTRUCTION. REFER TO TREE PROTECTION DETAIL. A2/A-0.02


 $\sqrt{3}$  PORTION OF ROOF TO BE DEMOLISHED

(4) ROOF TILE TO BE REPLACED

ARCHITECT:

LUIS E. URIARTE

18100 Atlantic Boulevard Sunny Isle Beach, FL 33160 Cell. 786.290.9807 Email: invusa@live.com

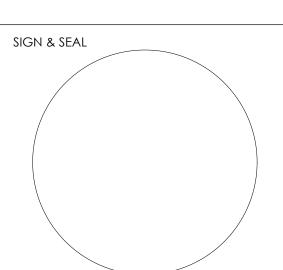

Luis Uriarte FLA. REG# AR 94107

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International Group Consultants The Professional Network

1508 NE 105 Street Miami Shores, Florida 33138 PH. 786.251.1954

PROJECT IDENTIFICATION

Saporta Residence 5815 Maynada Street Coral Gables FL. 33162-2924

**ISSUE DATES** 

PROJECT NUMBER 052320-01 DRAWN BY COPYRIGHT LEU ARCHITECTS, 2021

03.18.2021 SCALE: 1/8" = 1'-0"

SHEET TITLE PROPOSED


SITE PLAN

SHEET NUMBER




PROPOSED SITE PLAN

SCALE: 1/8" = 1'0"

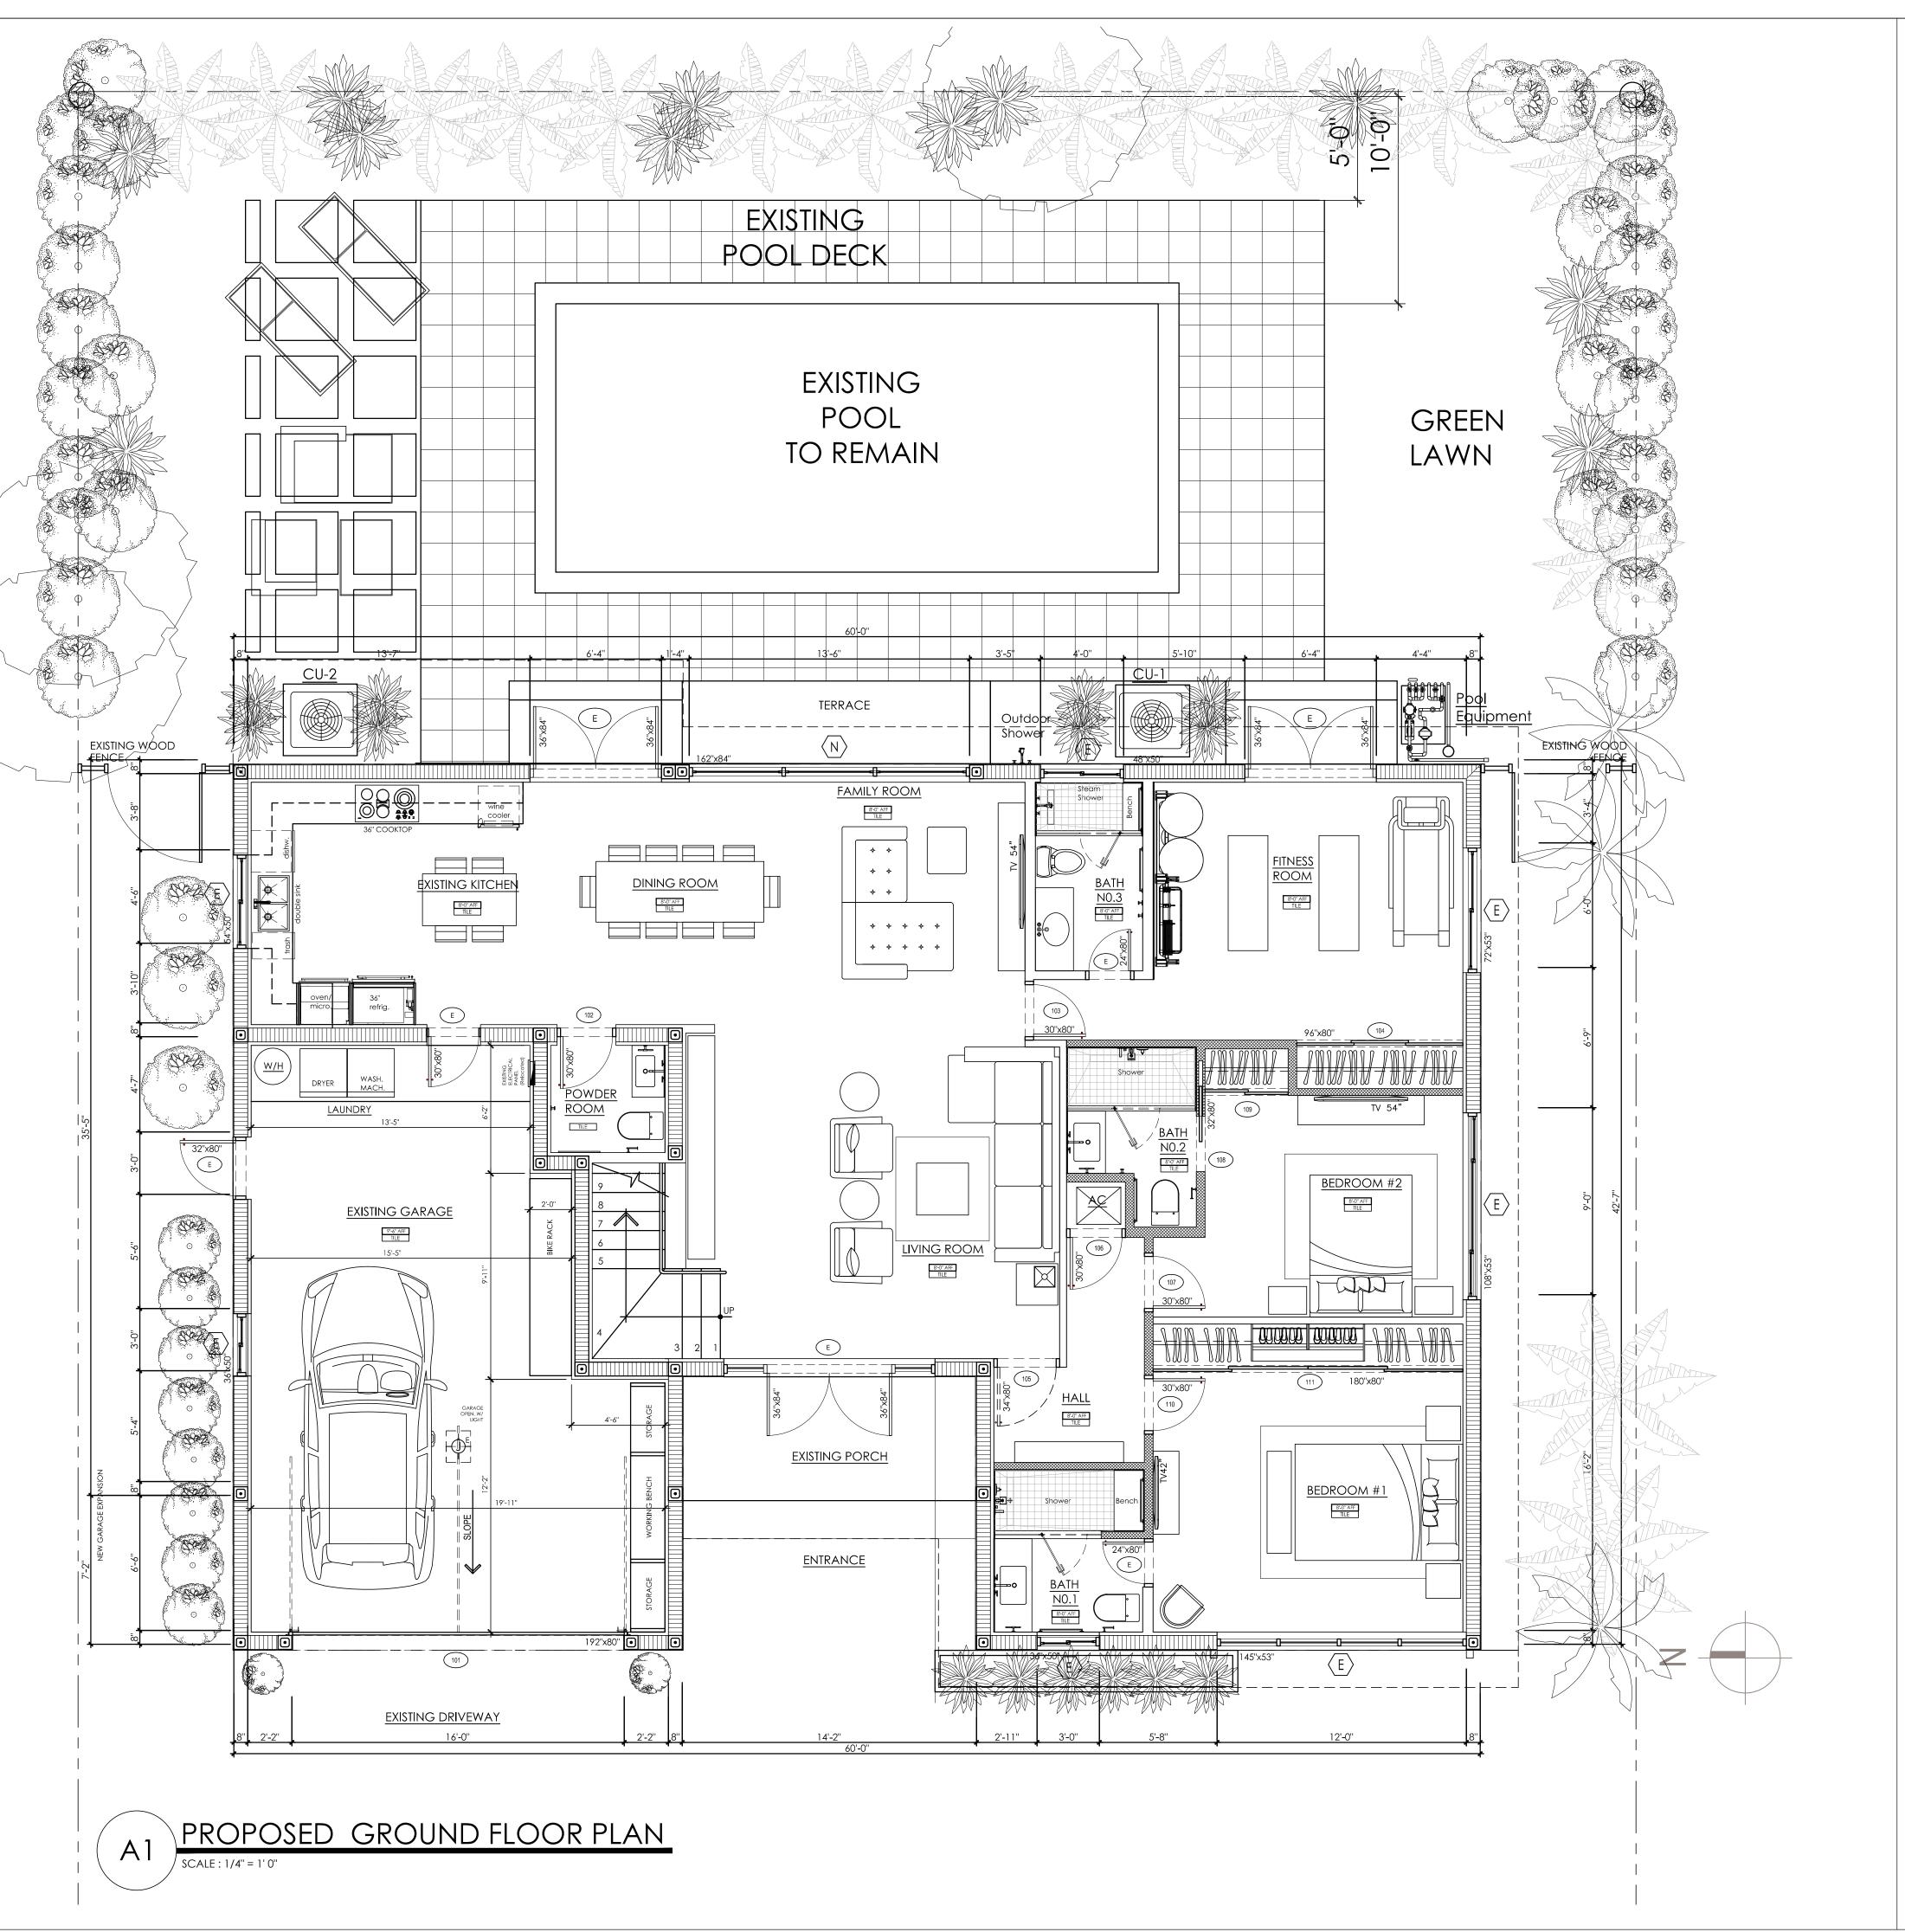

## NEW CONSTRUCTION NOTES:

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- ALL STRUCTURAL & LOAD BEARING WALLS TO REMAIN
- GC RESPONSIBLE FOR LAYING OUT DIMENSIONS PRIOR TO BUILDING TO **ENSURE EXACTNESS**
- GC TO PROVIDE LEVEL 4 TO LEVEL 5 FINISH ON ALL EXISTING AND NEW DRYWALL
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OUT OF SCOPE NEW C.M.U EXIST. C.M.U.
TO REMAIN NEW PARTITION

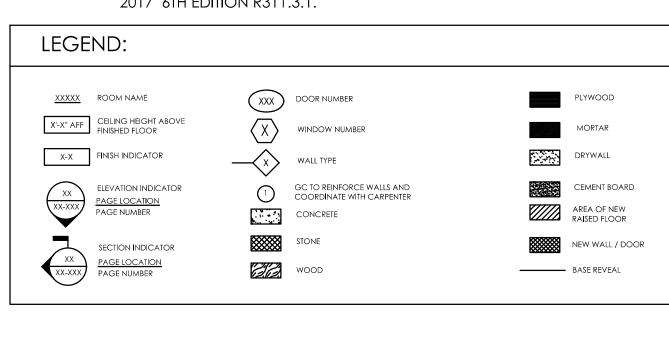EXIST. PARTITION

WALL TYPE SECTION

EXIST. PARTITION TO REMAIN EXISTING DRYWALL

CEILING TO REMAIN

SCALE: SHEET TITLE

PROPOSED GROUND FLOOR PLAN

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SHEET NUMBER

ARCHITECT:

Cell. 786.290.9807

SIGN & SEAL

FLA. REG# AR 94107

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International Group Consultants

1508 NE 105 Street Miami Shores,

The Professional Network

PROJECT IDENTIFICATION

Coral Gables

FL. 33162-2924

ISSUE DATES

PROJECT NUMBER

DRAWN BY

Saporta Residence

5815 Maynada Street


Florida 33138 PH. 786.251.1954

APPEARING ON THESE PLANS (c) 2021.

LUIS E. URIARTE

18100 Atlantic Boulevard Sunny Isle Beach, FL 33160


Email: invusa@live.com

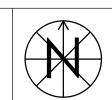

052320-01

03.18.2021


1/4" = 1'-0"

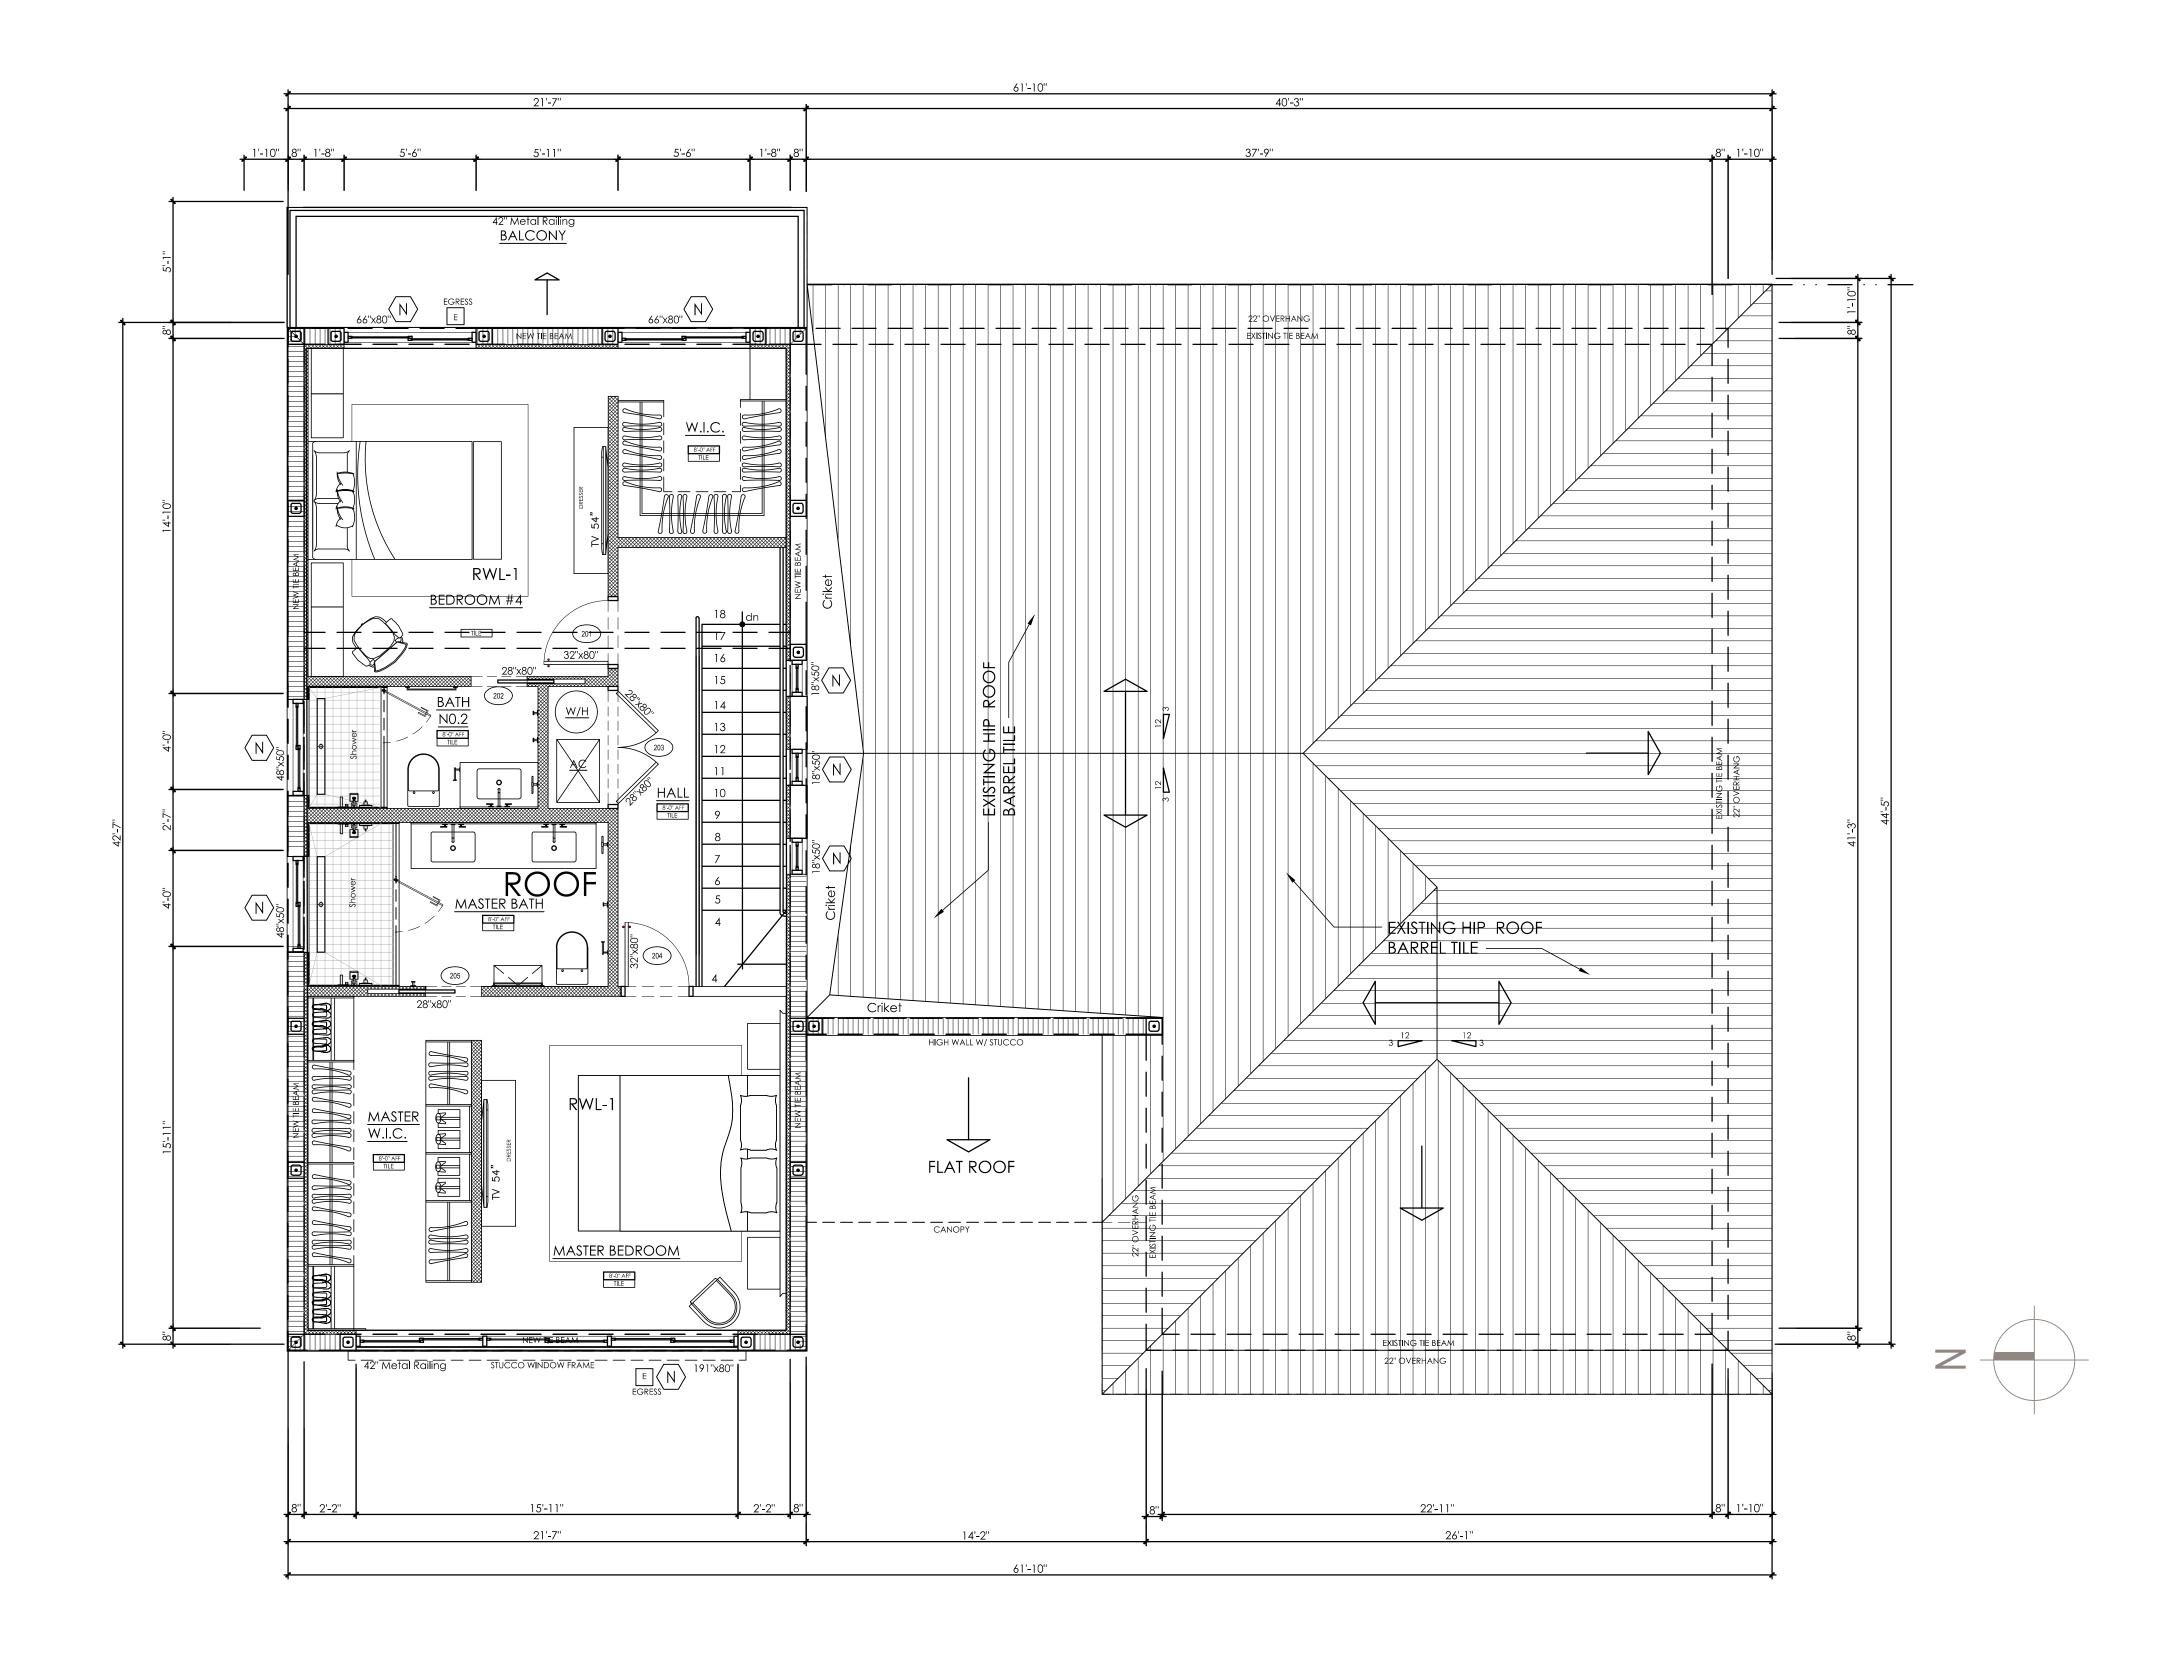

# PROPOSED SECOND FLOOR PLAN SCALE: 1/4" = 1'0"

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OUT OF SCOPE NEW C.M.U EXIST. C.M.U. TO REMAIN NEW PARTITION


EXIST. PARTITION

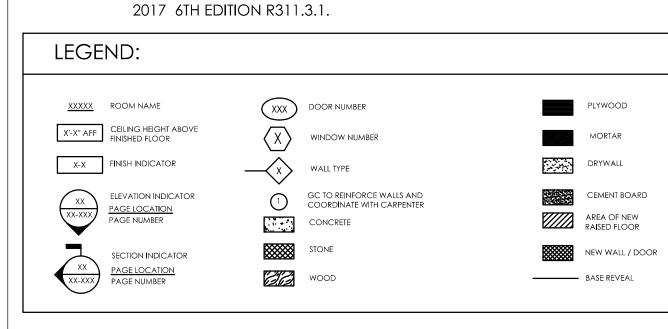WALL TYPE SECTION

EXIST. PARTITION TO REMAIN

EXISTING DRYWALL CEILING TO REMAIN ARCHITECT: LUIS E. URIARTE

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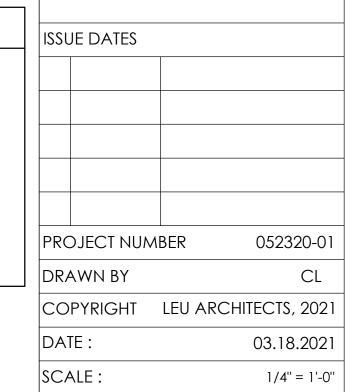
The Professional Network

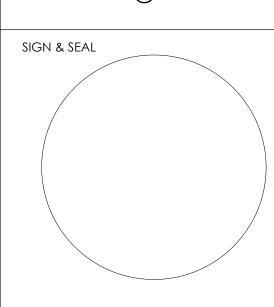International Group Consultants

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PROJECT IDENTIFICATION

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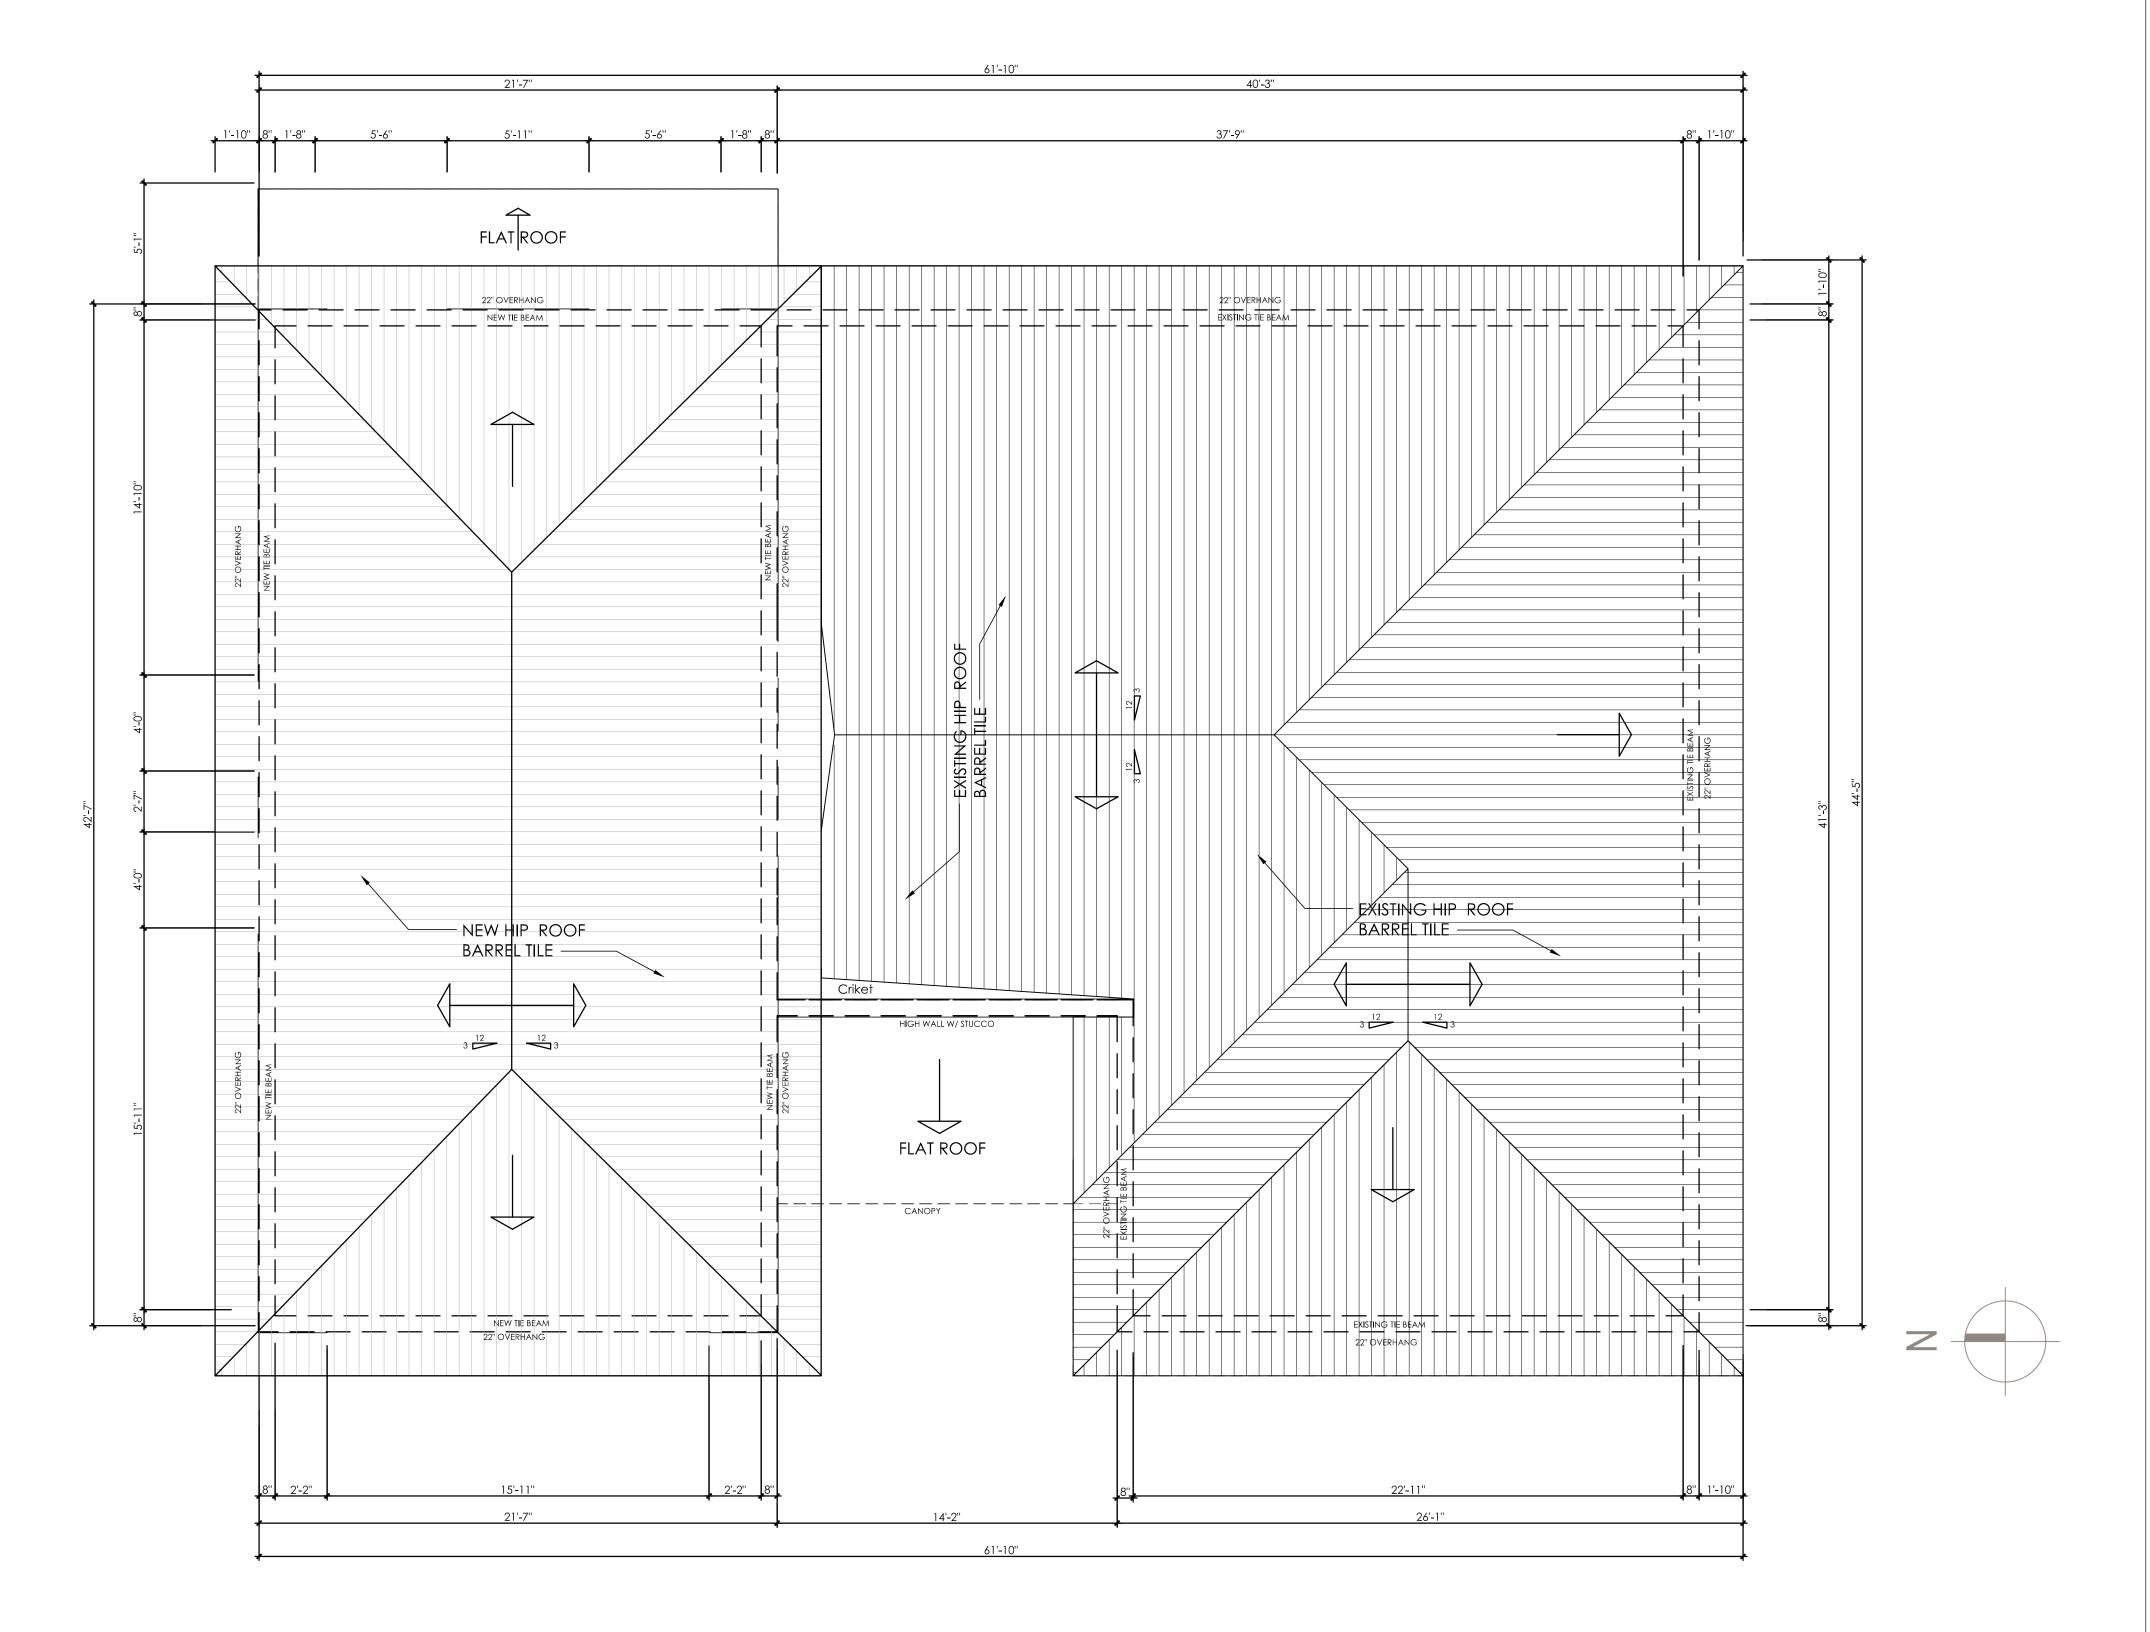


PROPOSED SECOND FLOOR PLAN

SHEET NUMBER


SHEET TITLE





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OUT OF SCOPE NEW C.M.U EXIST. C.M.U. TO REMAIN NEW PARTITION

----- EXIST. PARTITION

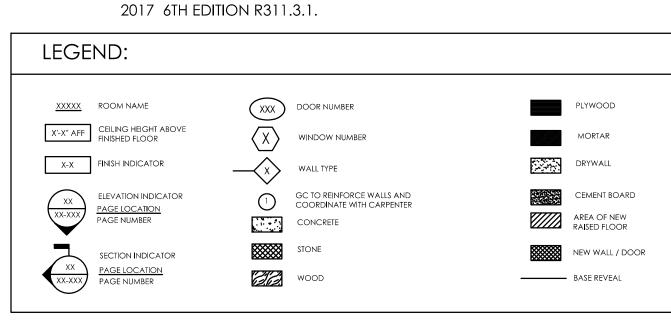WALL TYPE SECTION

EXISTING DRYWALL CEILING TO REMAIN

EXIST. PARTITION TO REMAIN

SHEET TITLE PROPOSED **ROOF PLAN** 

PROJECT NUMBER

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DRAWN BY

SCALE:

052320-01

03.18.2021

1/4" = 1'-0"


ISSUE DATES

SHEET NUMBER



ARCHITECT: LUIS E. URIARTE

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PROJECT IDENTIFICATION

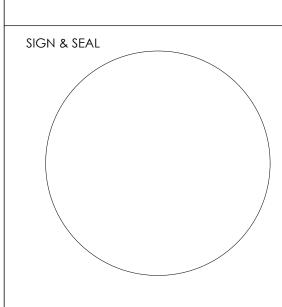Saporta Residence 5815 Maynada Street Coral Gables FL. 33162-2924





Existing View - 1










Proposed View - 2

ARCHITECT:

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SIGN & SEAL



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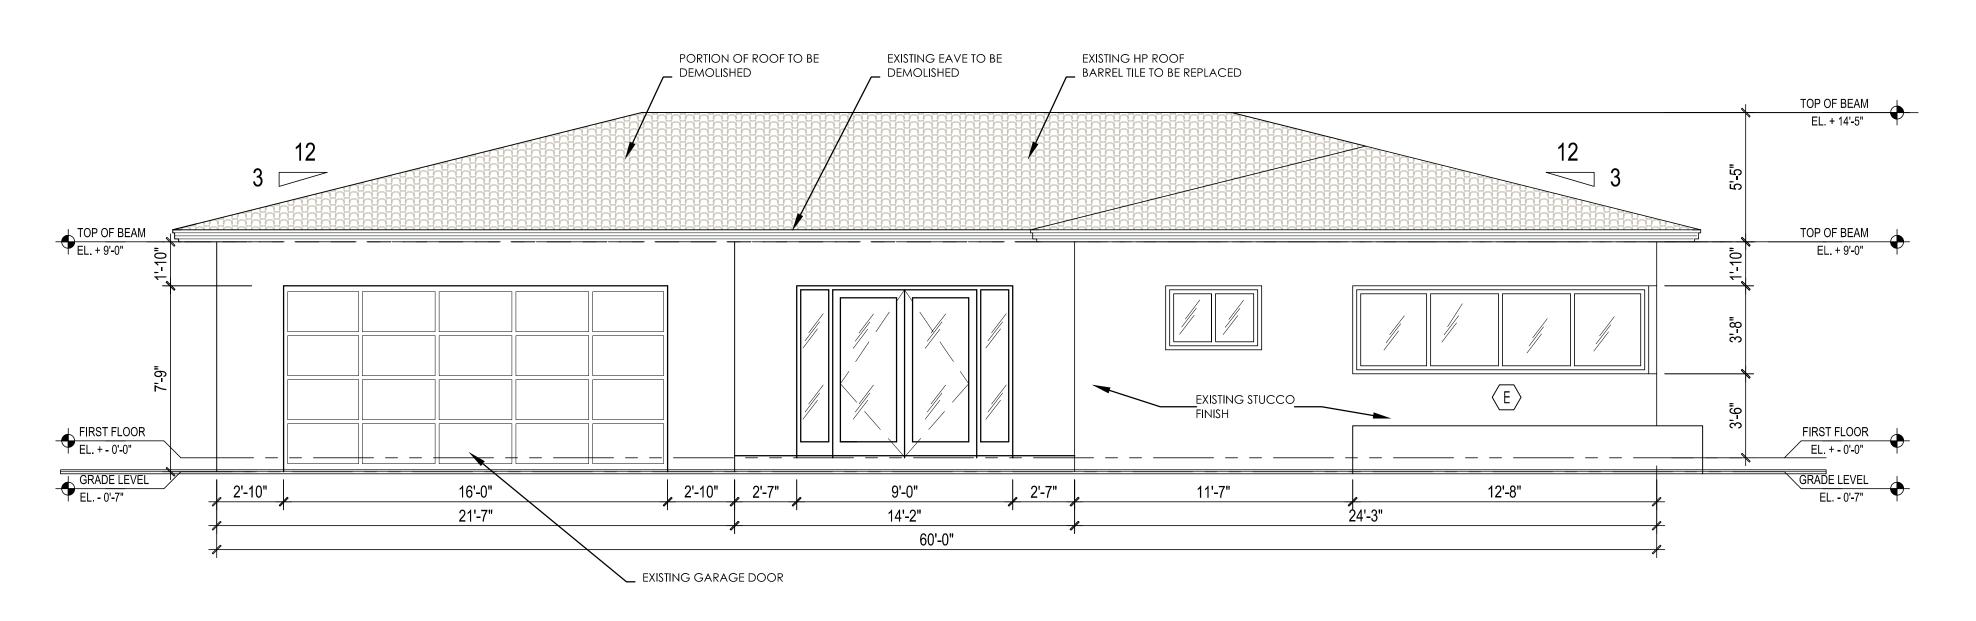
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03.18.2021

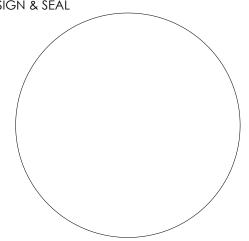EXISTING & PROPOSED RENDER VIEWS


A- 2.00





1 EXISTING WEST ELEVATION

SCALE: 1/4" = 1'-0"

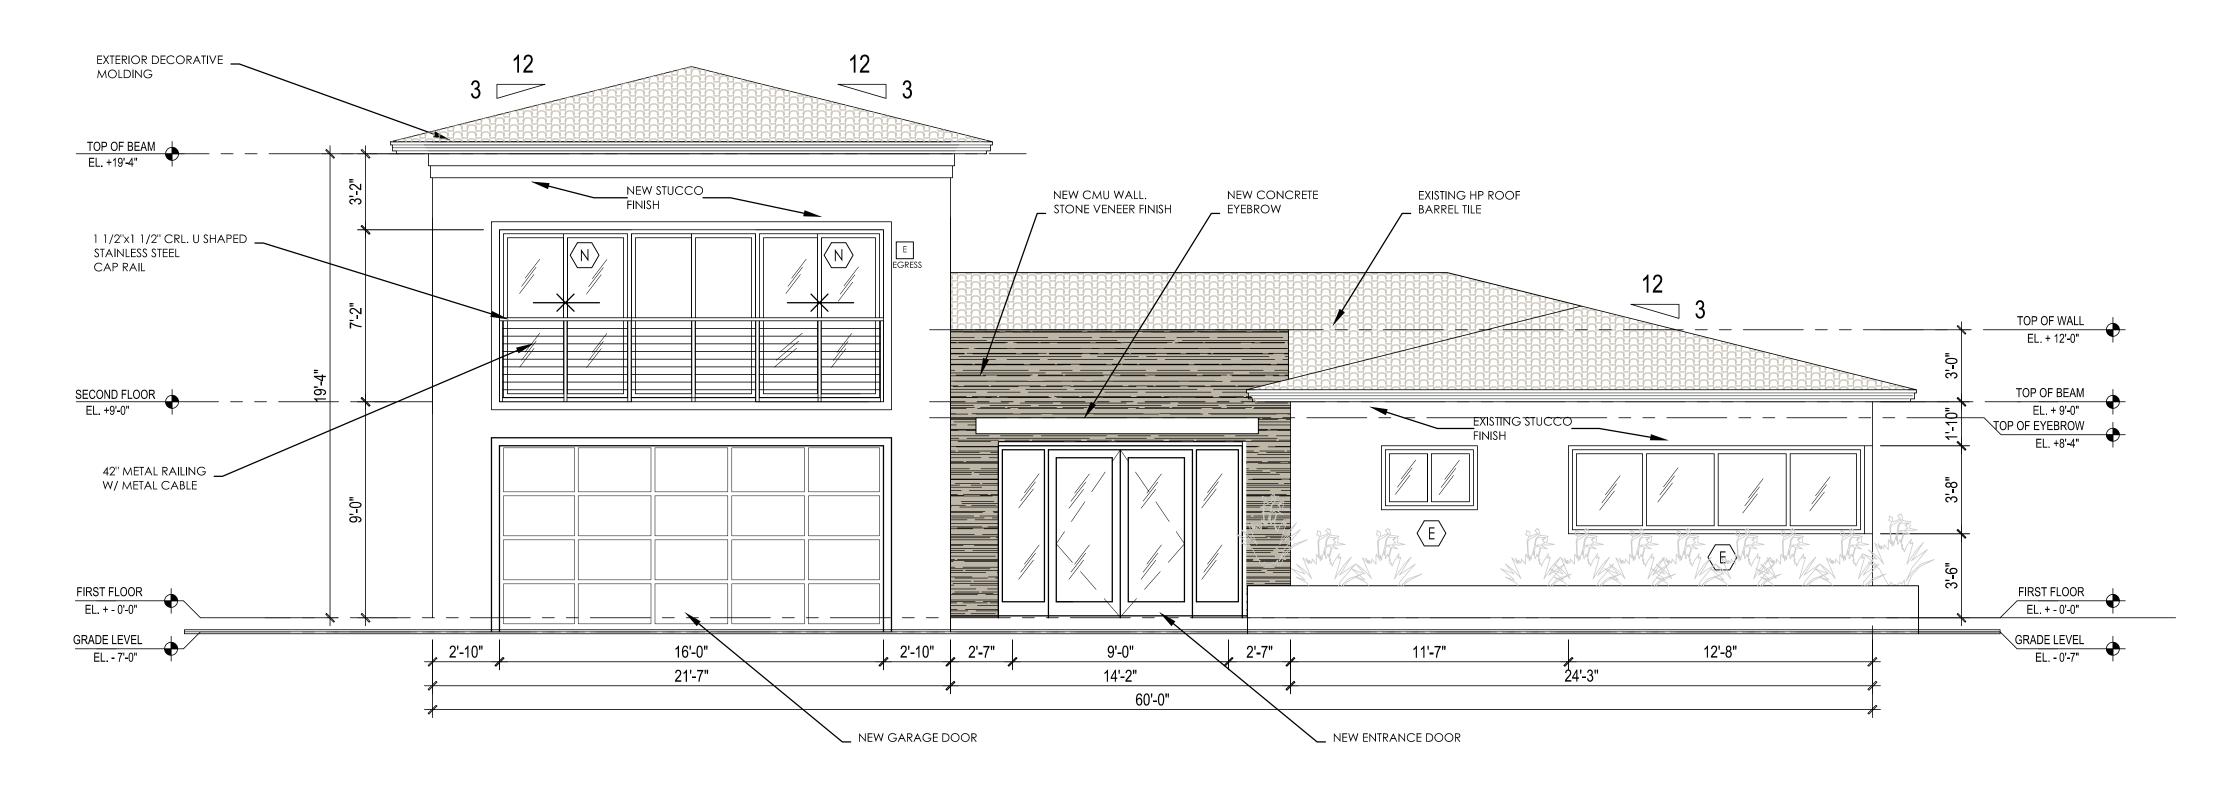


PROPOSED WEST ELEVATION

SCALE: 1/4" = 1'-0"

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ISSUE DATES

12-20-2020 ZONING COMMENTS

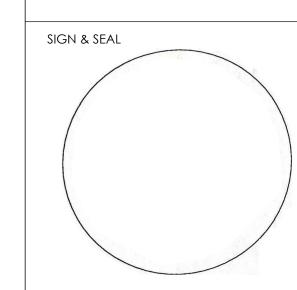04-30-2021 BUILDING COMMENTS

PROJECT NUMBER 052320-01

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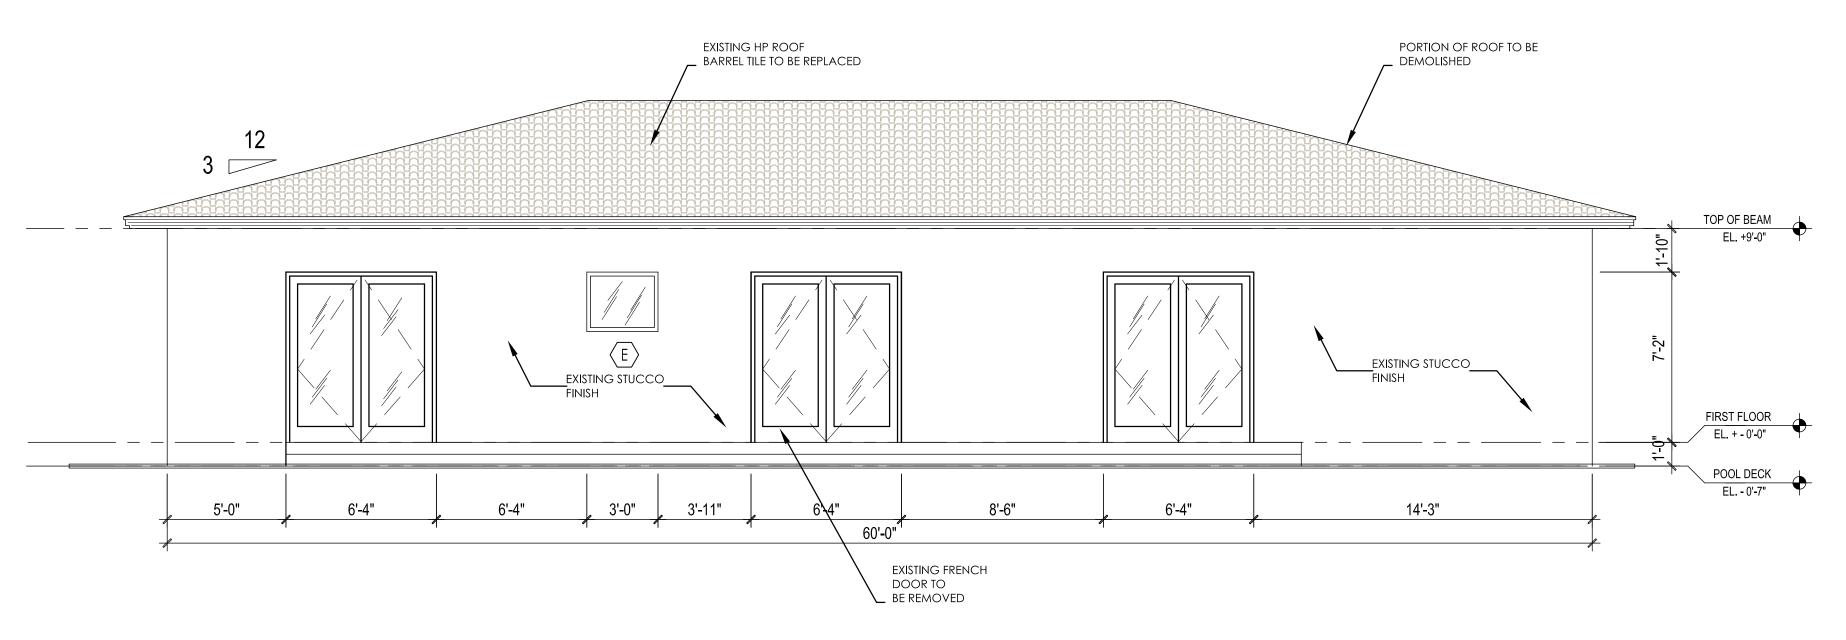
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SHEET TITLE

EXISTING & PROPOSED EXTERIOR ELEVATIONS

SHEET NUMBER
A-3.01






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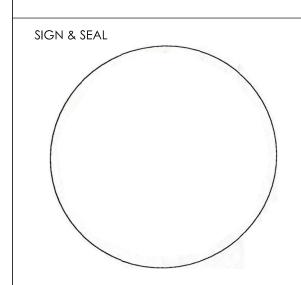
SCALE: 1/4" = 1'-0"

PROPOSED EAST ELEVATION

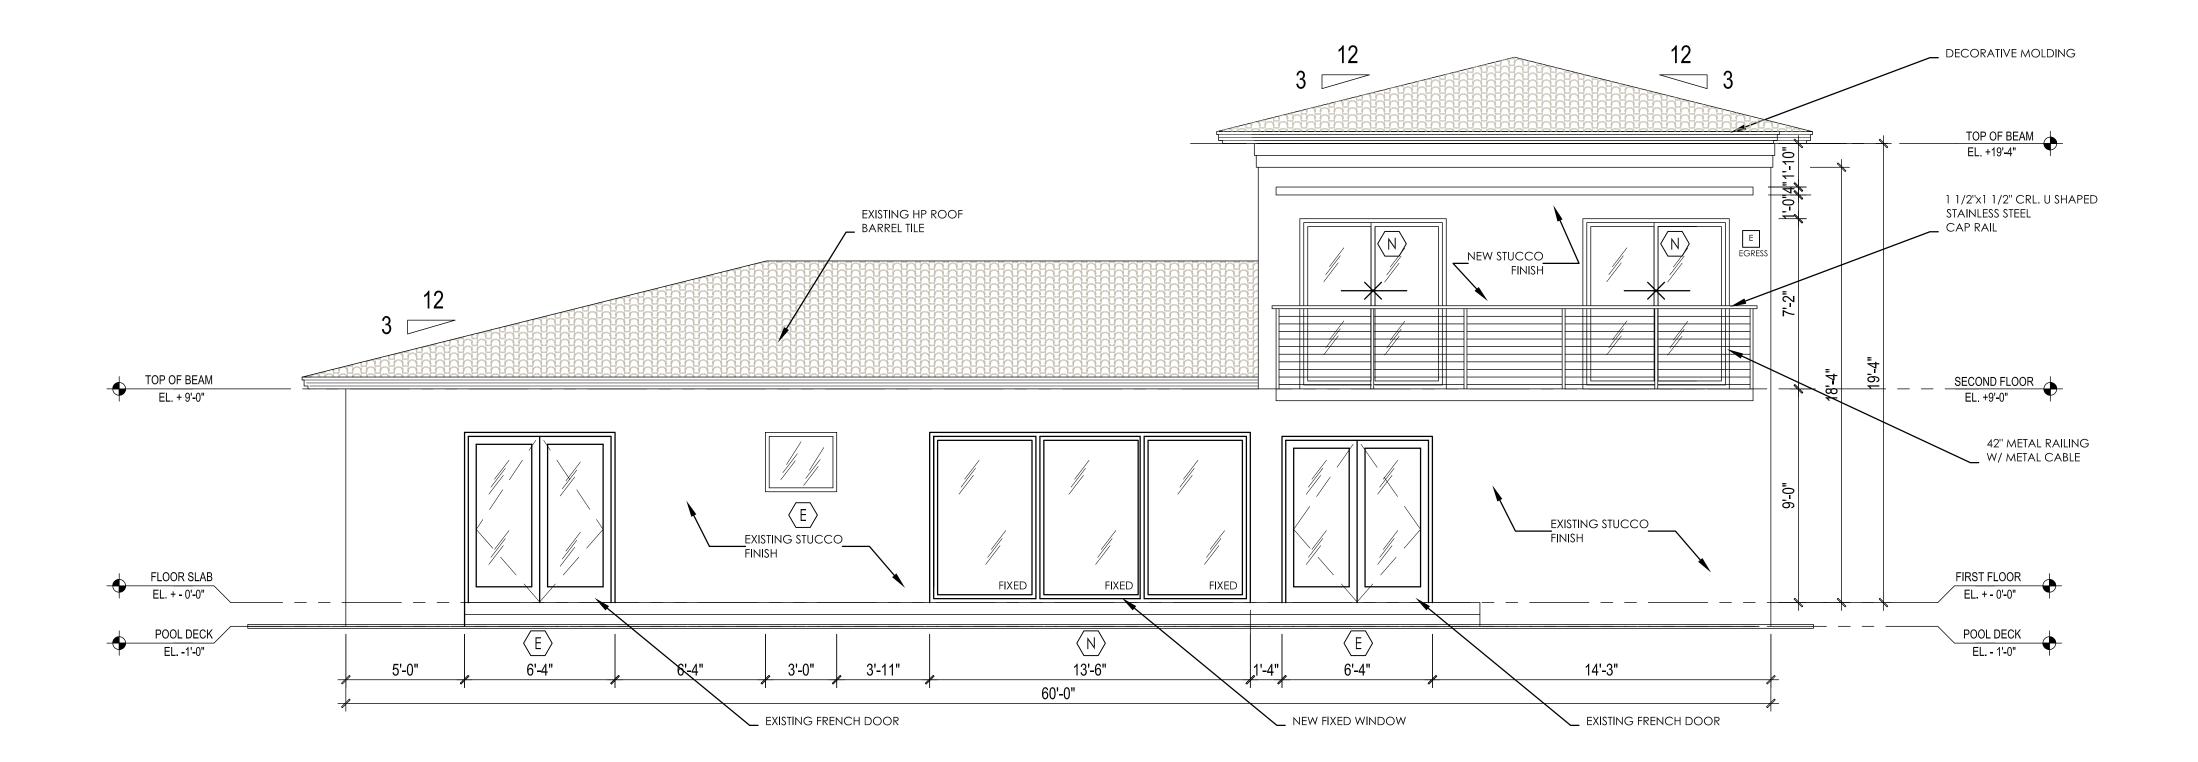

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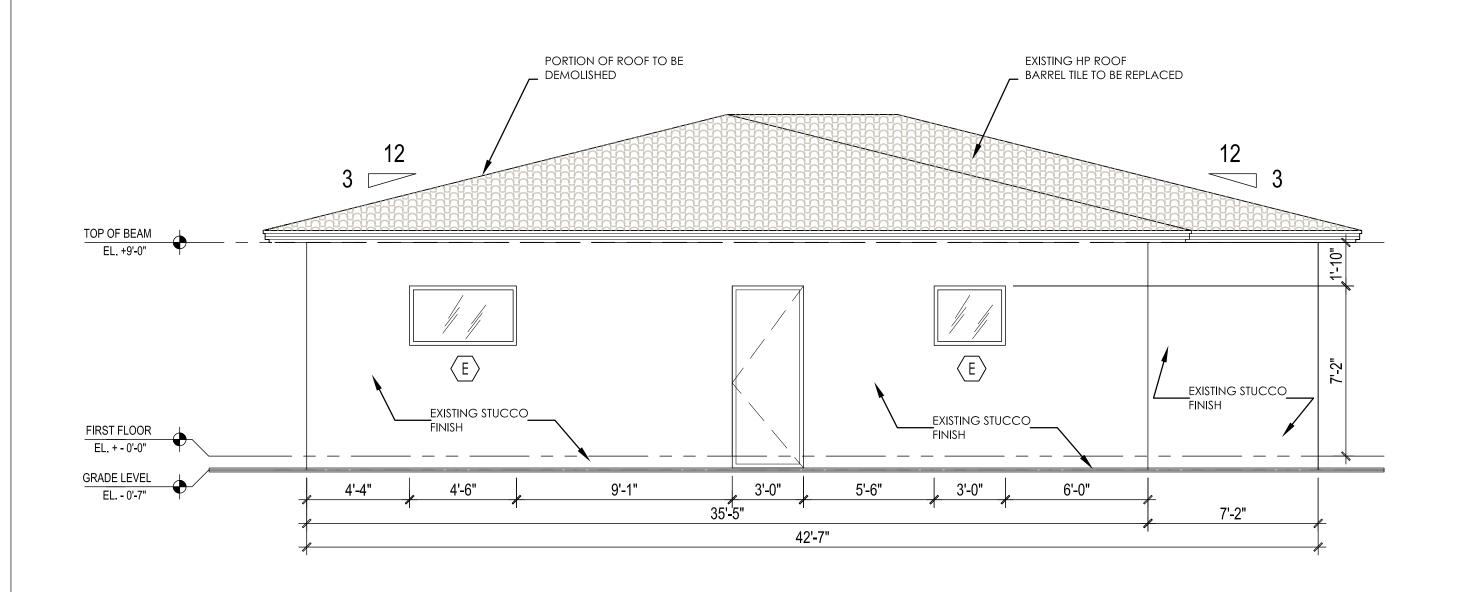
SHEET TITLE

EXISTING & PROPOSED EXTERIOR ELEVATIONS

SHEET NUMBER

A-3.02





3 12 3 TOP OF BEAM
EL. +9-0'

EXISTING STUCCO
FINISH

EXISTING STUCCO
FINISH


FIRST FLOOR
EL. +9-0'
FINISH


GRADE LEVEL
EL. -0-7'

42-7'

# 1 EXISTING NORTH ELEVATION SCALE: 1/4" = 1'-0"

3 EXISTING SOUTH ELEVATION SCALE: 1/4" = 1'-0"

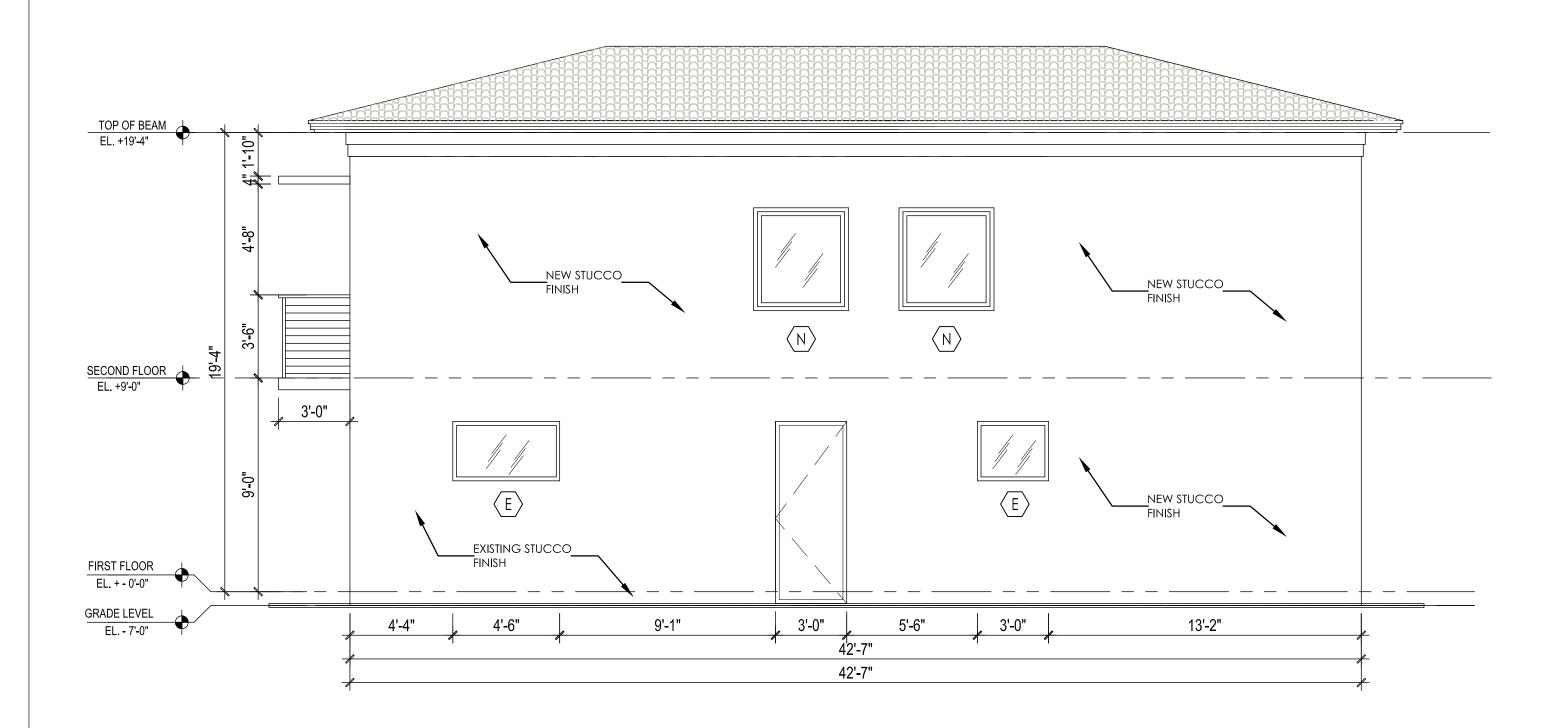

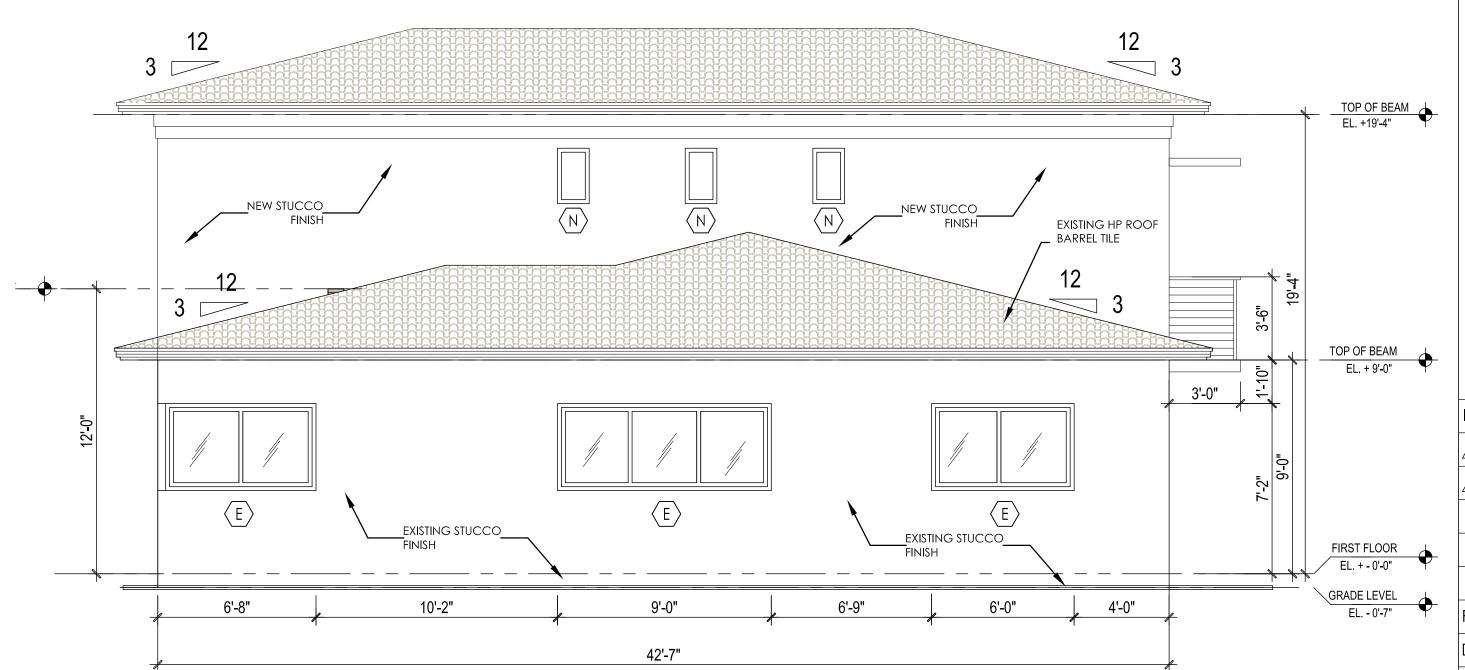

PROPOSED NORTH ELEVATION

SCALE: 1/4" = 1'-0"


PROPOSED SOUTH ELEVATION

SCALE: 1/4" = 1'-0"

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IGG Hus

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PROJECT IDENTIFICATION

Saporta Residence 5815 Maynada Street Coral Gables FL. 33162-2924

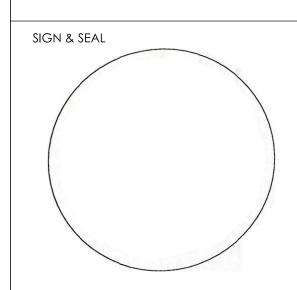ISSUE DATES

 ⚠
 12-20-2020
 ZONING COMMENTS

 ⚠
 04-30-2021
 BUILDING COMMENTS

PROJECT NUMBER 052320-01
DRAWN BY CL

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DATE: 03.18.2021

SCALE: AS SHOWN

SHEET TITLE

EXISTING & PROPOSED EXTERIOR ELEVATIONS

SHEET NUMBER

A-3.03