### CMA Design Studio, Inc.

ARCHITECTURE PLANNING INTERIOR DESIGN



1. 6925 SUNRISE CT. (NORTH OF PROPERTY)



2. 6938 SUNRISE CT. (SOUTH OF PROPERTY)



3. 6922 SUNRISE CT. (NORTH WEST OF PROPERTY)



4. 6934 SUNRISE CT. (WEST OF PROPERTY)



5. 6941 SUNRISE CT. (SOUTH OF PROPERTY)



6. 6946 SUNRISE CT. (SOUTH EAST OF PROPERTY)



SUNRISE COURT - NEIGHBORHOOD CONTEXT MAP

# CMA Design Studio, Inc. ARCHITECTURE PLANNING INTERIOR DESIGN

Shaner Residence 6935 Sunrise Court, Coral Gables, 33133

#### **Location Map**:



# CMA Design Studio, Inc.

ARCHITECTURE PLANNING INTERIOR DESIGN



6935 SUNRISE COURT - PARTIAL FRONT (EAST)



6935 SUNRISE COURT – PARTIAL FRONT (EAST)



6935 SUNRISE COURT - REAR SEAWALL (NORTH )



6935 SUNRISE COURT – FROM REAR (NORTH WEST)



6935 SUNRISE COURT – SEAWALL (SOUTH)



6935 SUNRISE COURT – REAR (SOUTH WEST)

# SHANER RESIDENCE

# 6935 SUNRISE COURT CORAL GABLES, FLORIDA 33133

100% DESIGN DEVELOPMENT B.O.A PRELIMINARY SET JUNE 2021

CMA Design Studio, Inc.

ARCHITECTURE

**PLANNING** 

**INTERIOR DESIGN** 

232 Andalusia Avenue Suite 101 · Coral Gables, Florida 33134 · T: 305.448.4200 · F: 305.448.4215

OWNER'S SIGNATURE, 100% D.D.

DATE

OWNER'S SIGNATURE AT 100% DESIGN DEVELOPMENT ACKNOWLEDGES THAT OWNER IS SATISFIED AND APPROVES THE DESIGN OF THE PROJECT AND THAT CMA DESIGN STUDIO SHALL PROCEED WITH THE CONSTRUCTION DOCUMENTS PHASE.

\*IF OWNER SHOULD DECIDE TO MAKE ANY ADDITIONAL DESIGN CHANGES DURING THE CONSTRUCTION DOCUMENT PHASE, WILL BE CONSIDERED ADDITIONAL SERVICES AND BILLED ACCORDINGLY.

Lynsie Christine Conn FL Architect AR99059 AA26000730 SHEET NO.:

G1.0

SURVEY

# INDEX OF DRAWINGS

	ARCH	ITECTURAL DRAWINGS	LANDS	SCAPE DRAWINGS
		COVER	LCVR	COVER
		INDEX	L001	GENERAL SITE NOTES
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	R2.0	EXTERIOR RENDERING	L101	TREE DISPOSITION PLAN & SCHEDULE
	R3.0	EXTERIOR RENDERING	L300	MATERIALS PLAN
	R4.0	EXTERIOR RENDERING	L700	PLANTING SCHEDULE & NOTES
	R5.0	EXTERIOR RENDERING	L701	TREE & PALM PLANTING PLAN
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	R8.0	EXTERIOR RENDERING		
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	A5.0	FRONT & REAR ELEVATIONS		
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	A6.0	BUILDING SECTIONS		
	A6.1	BUILDING SECTIONS		
	A7.0	WALL SECTION		
	A7.1	WALL SECTION		
	A7.2	WALL SECTION		
χ }	A7.4	WALL SECTION }		
}	A7.8	WALL SECTION		

A10.0 DOOR & WINDOW SCHEDULES





SHEET NO.:



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1 EXTERIOR RENDERING

SHEET NO.:

1 EXTERIOR RENDERING



SHEET NO.:



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AA26000730

SHEET NO.:

**ZONING LEGEND** NET SITE AREA (LOT SIZE): 13,770 SQ.FT. SFR - SINGLE FAMILY - GENERAL

PROPERTY ADDRESS

CORAL GABLES, FL 33156

LEGAL DESCRIPTION

SUNRISE HARBOUR REV PL PB 65-22

"AE"- BASE FLOOD ELEVATION 11'-0" + 1'-0"

6935 SUNRISE CT,

LOT 43 BLK 2

LOT SIZE 13,600 SQ.FT

FOLIO NUMBER

FEMA FIRM ZONE

FIRST FLOOR: 3041 SF


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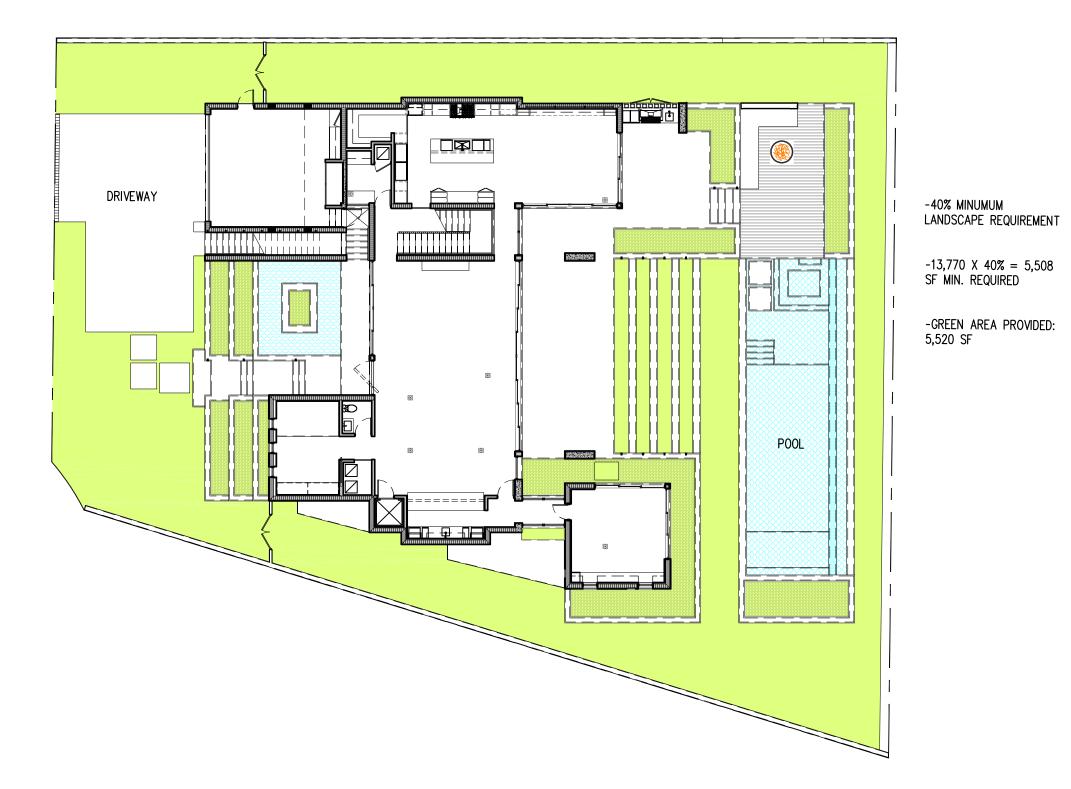
DRIVEWAY


STR - SHAGEL LAMIET - GENERAL		
SETBACKS:	REQUIRED	PROVI
FRONT SETBACK:	25'-0"	25'
REAR SETBACK:	35'-0"	35'
SIDE SETBACK (NORTH):	10'-0"	10'
SIDE SETBACK (SOUTH):	10'-0"	10'
MAX. HT. ABOVE ESTABLISHED GRADE B.F. +1' (TOP FLOOR TOP OF TIE BEAM)	25'-0"	23'

F.A.R. PERMITTED (LOT SIZE 13,770): 48% FOR FIRST 5,000 S.F.: 2,400 S.F 35% FOR SECOND 5,000 S.F.: 1,750 S.F 30% FOR BALANCE OF AREA (3,770 S.F.): 1,131 S.F TOTAL PERMITTED: 5,281 S.F TOTAL PROVIDED: 5,273 S.F \*. F.A.R. INCLUDES GARAGES AT 100%

LOT COVERAGE PERMITTED: (35%): 4,819 S.F.	PROV: 4,315 S.F.
LOT COVERAGE PERMITTED: (45%) POOL,WATER GAR.: 6,196 S.F.	PROV: 5,356 S.F
LANDSCAPE OPEN SPACE: (PROVIDE MIN.40%) :5,508 SF	PROV: 5,520 S.F.
FRONT YARD LANDSCAPING (PROV. MIN.20% OF 2,031 S.F.):	PROV: 1,114 S.F.




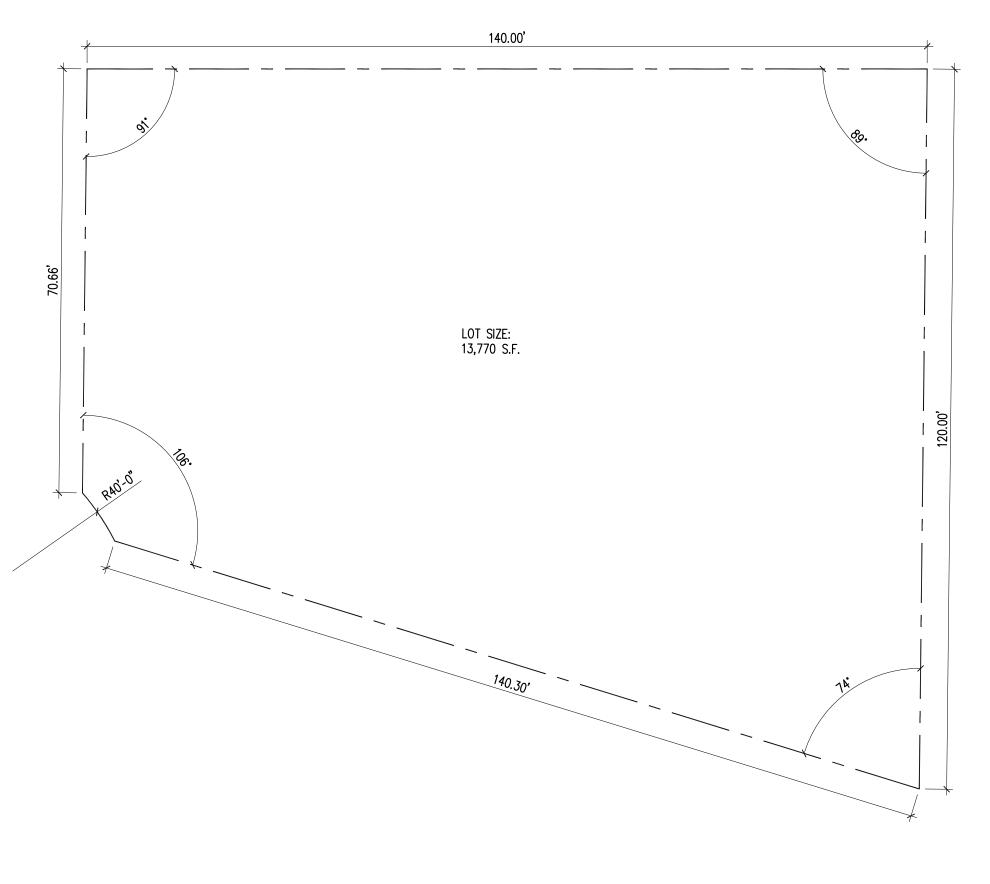

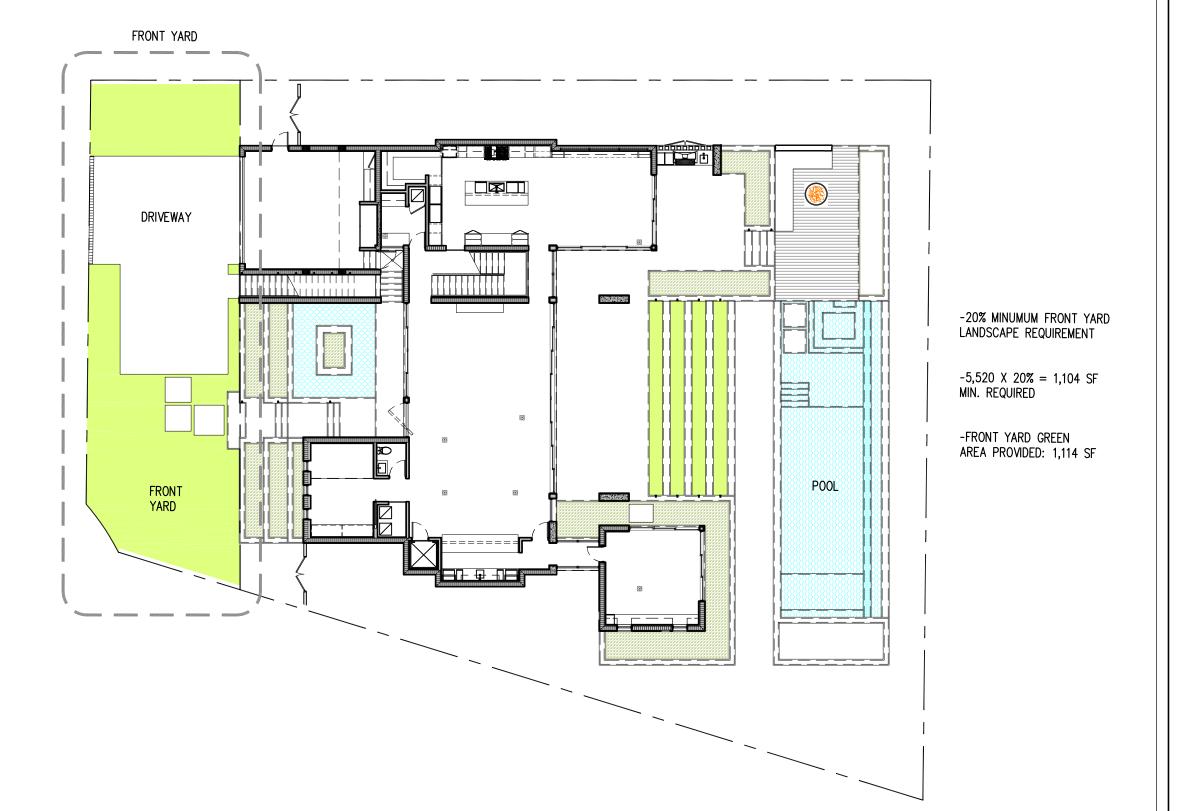


1/16" = 1'-0"




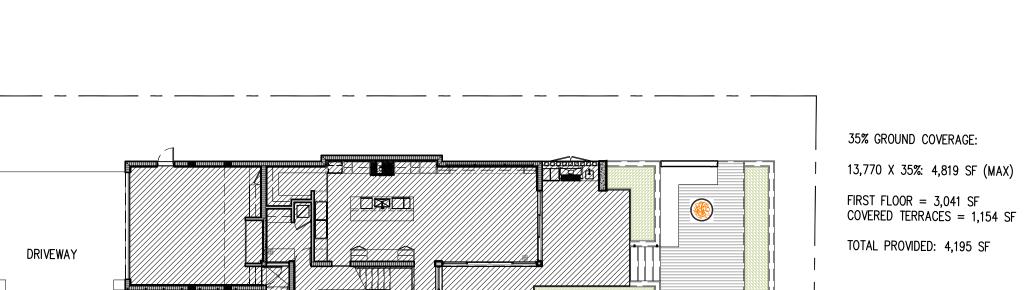

2 40% LANDSCAPE MINIMUM

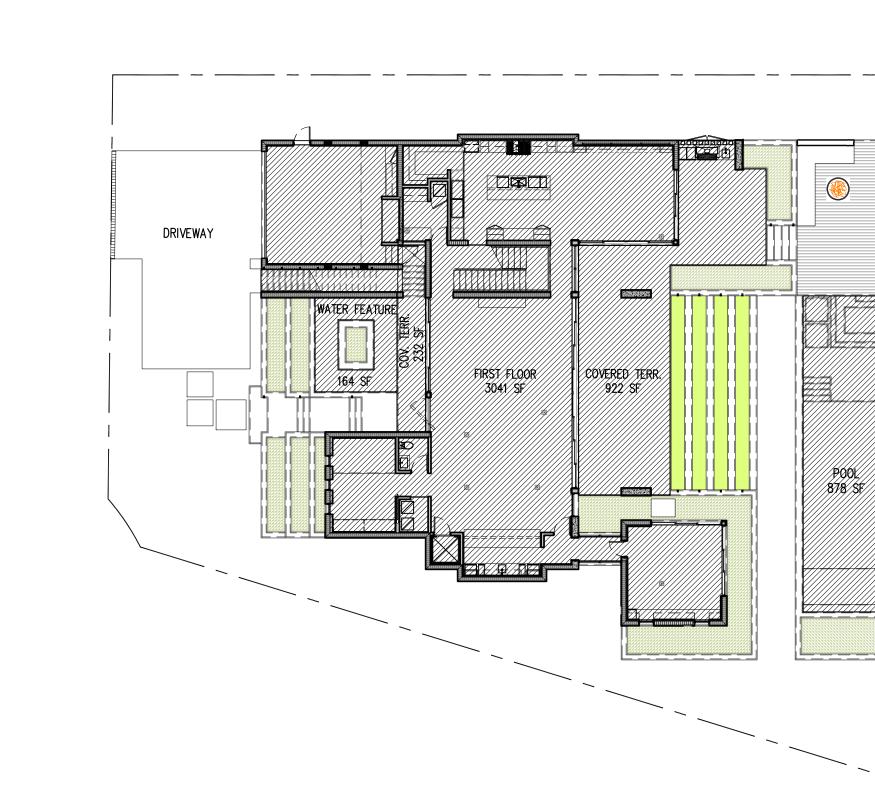


20% FRONT LANDSCAPE MIN.

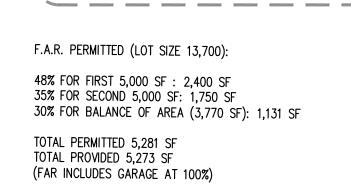

SECOND FLOOR

SECOND FLOOR (A): 1,992 SF

SECOND FLOOR (B): 240 SF

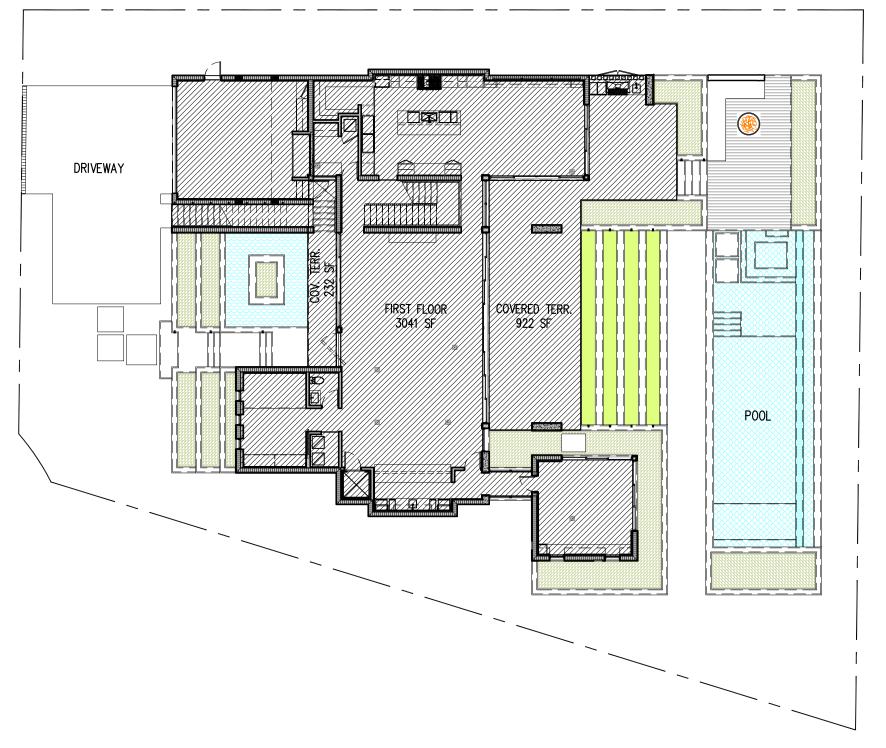

6 45% GROUND COVERAGE

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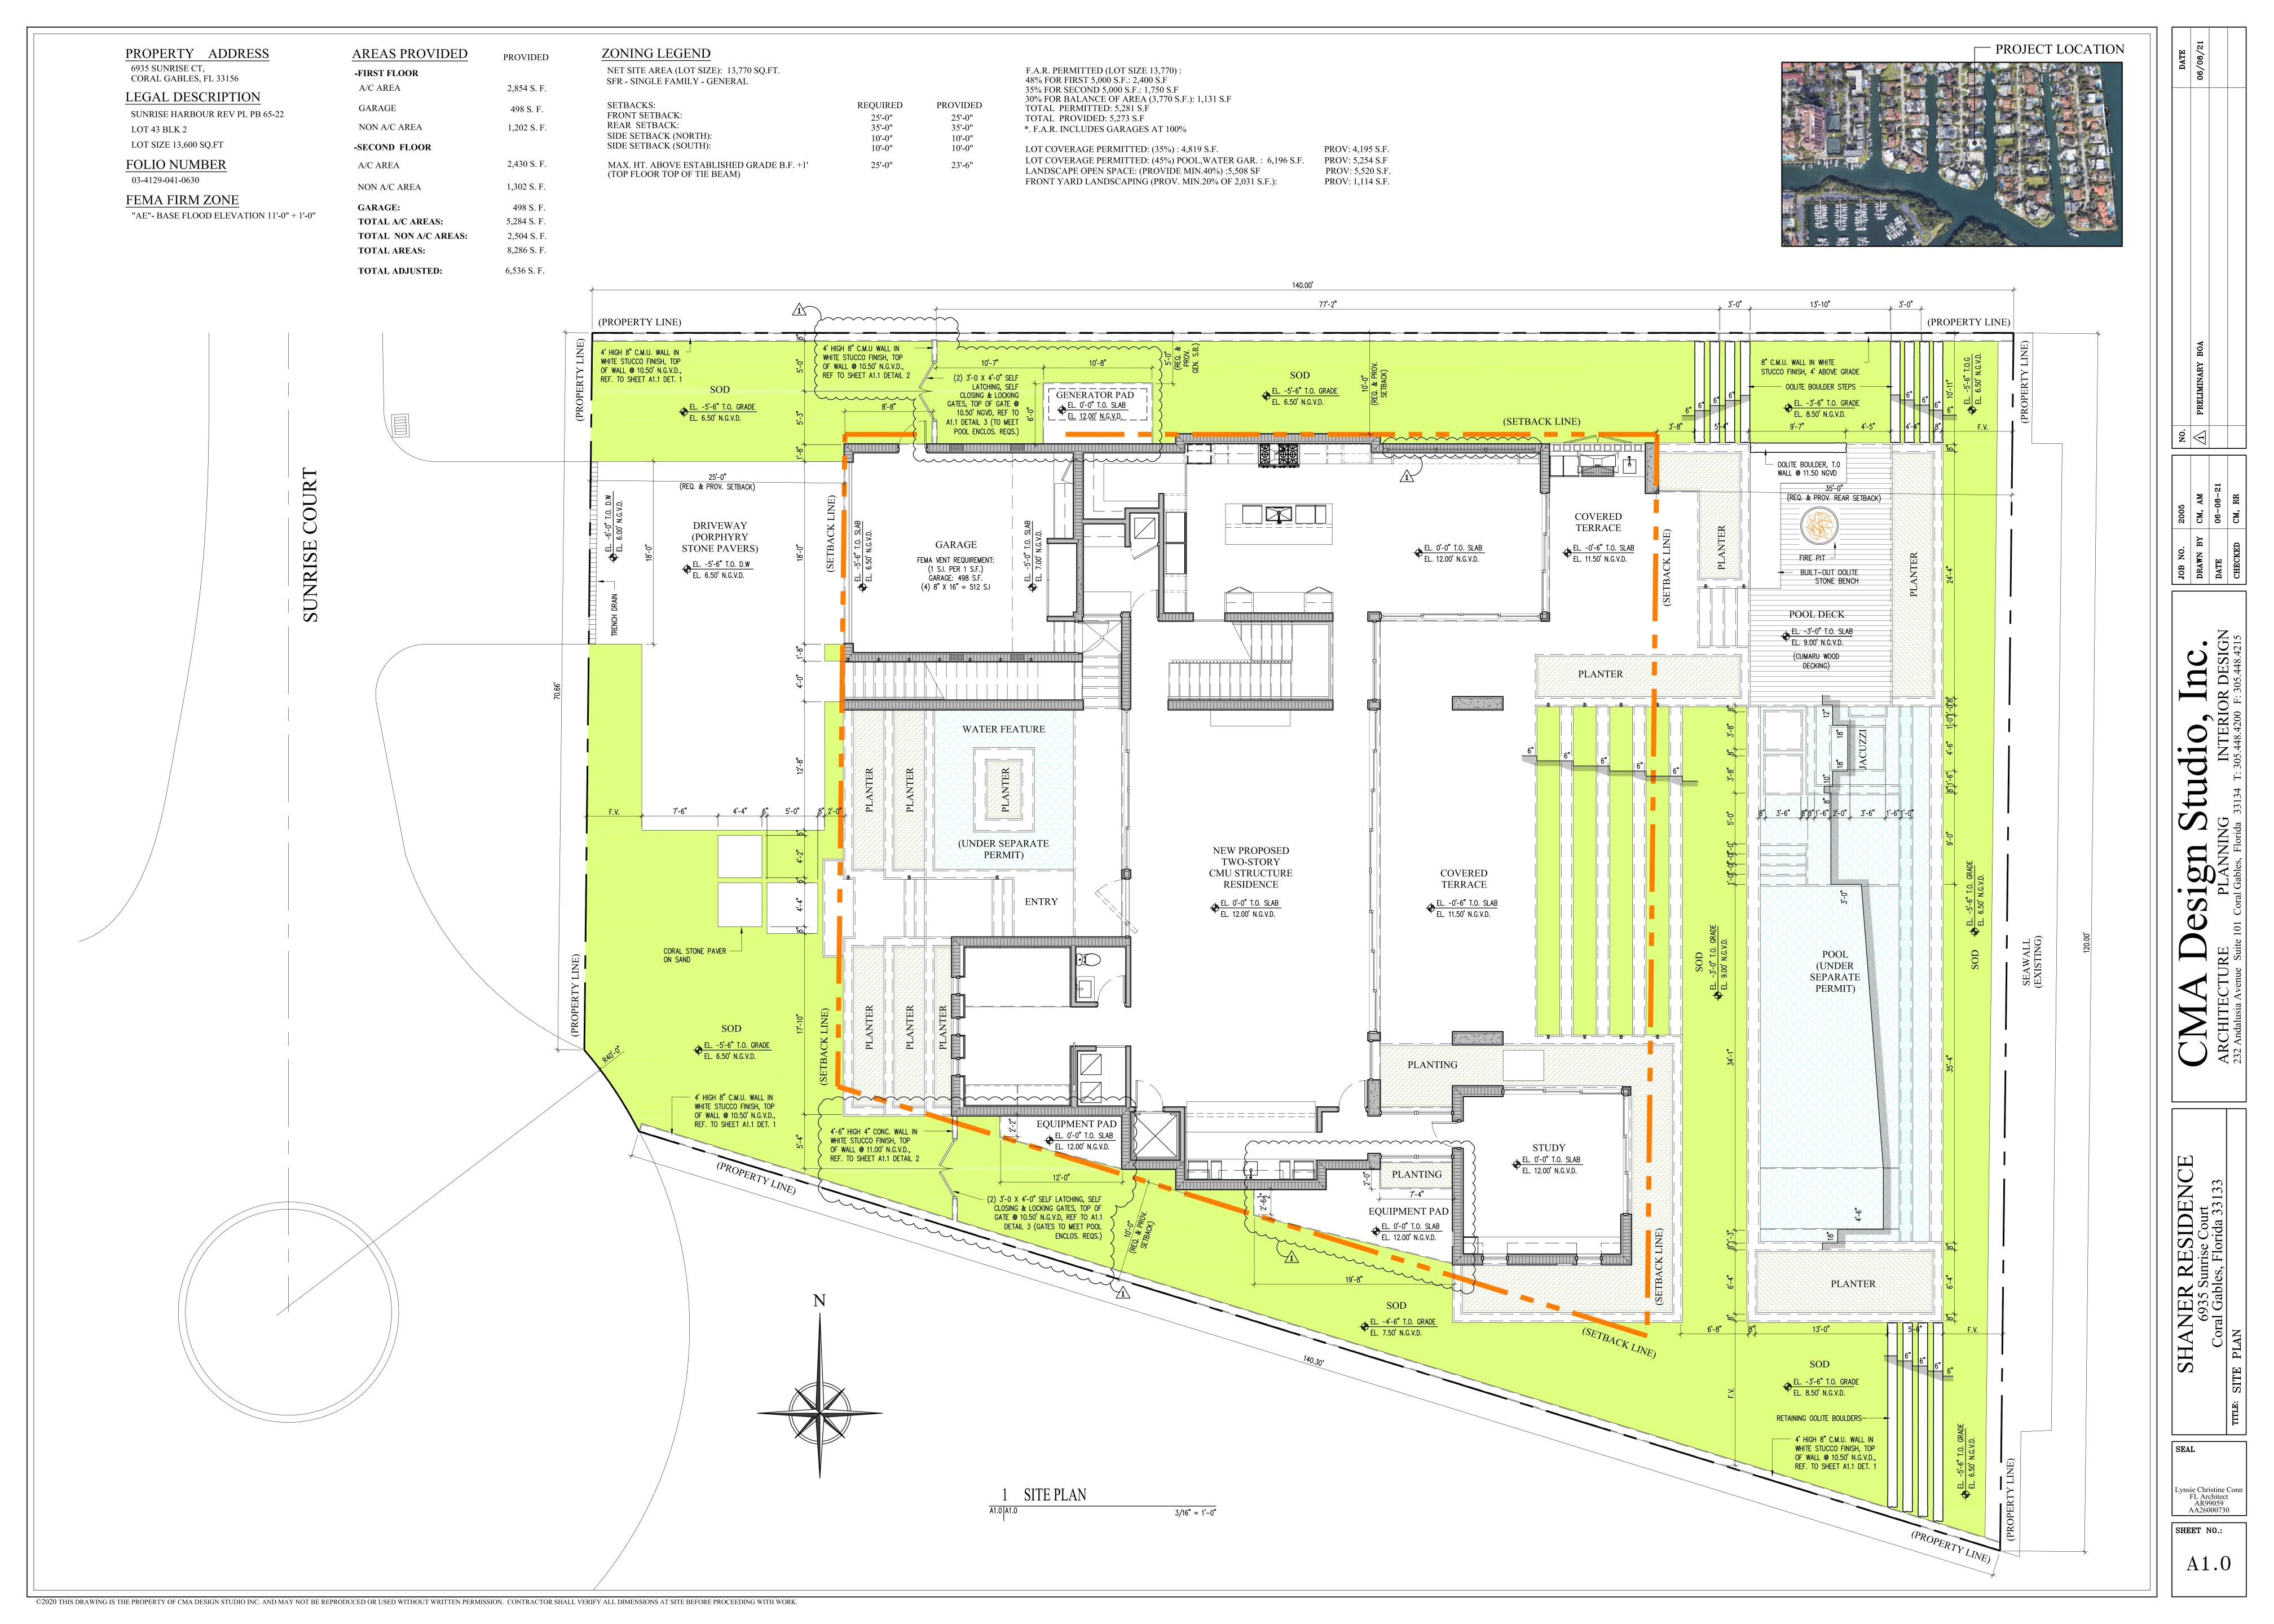
5 35% GROUND COVERAGE


45% GROUND COVERAGE:

13,770 X 45%: 6,196 SF (MAX)

FIRST FLOOR = 3,041 SF COVERED TERRACES = 1,154 SF POOL = 878 SF WATER FEATURE = 164 SF

TOTAL PROVIDED: 5,254 SF



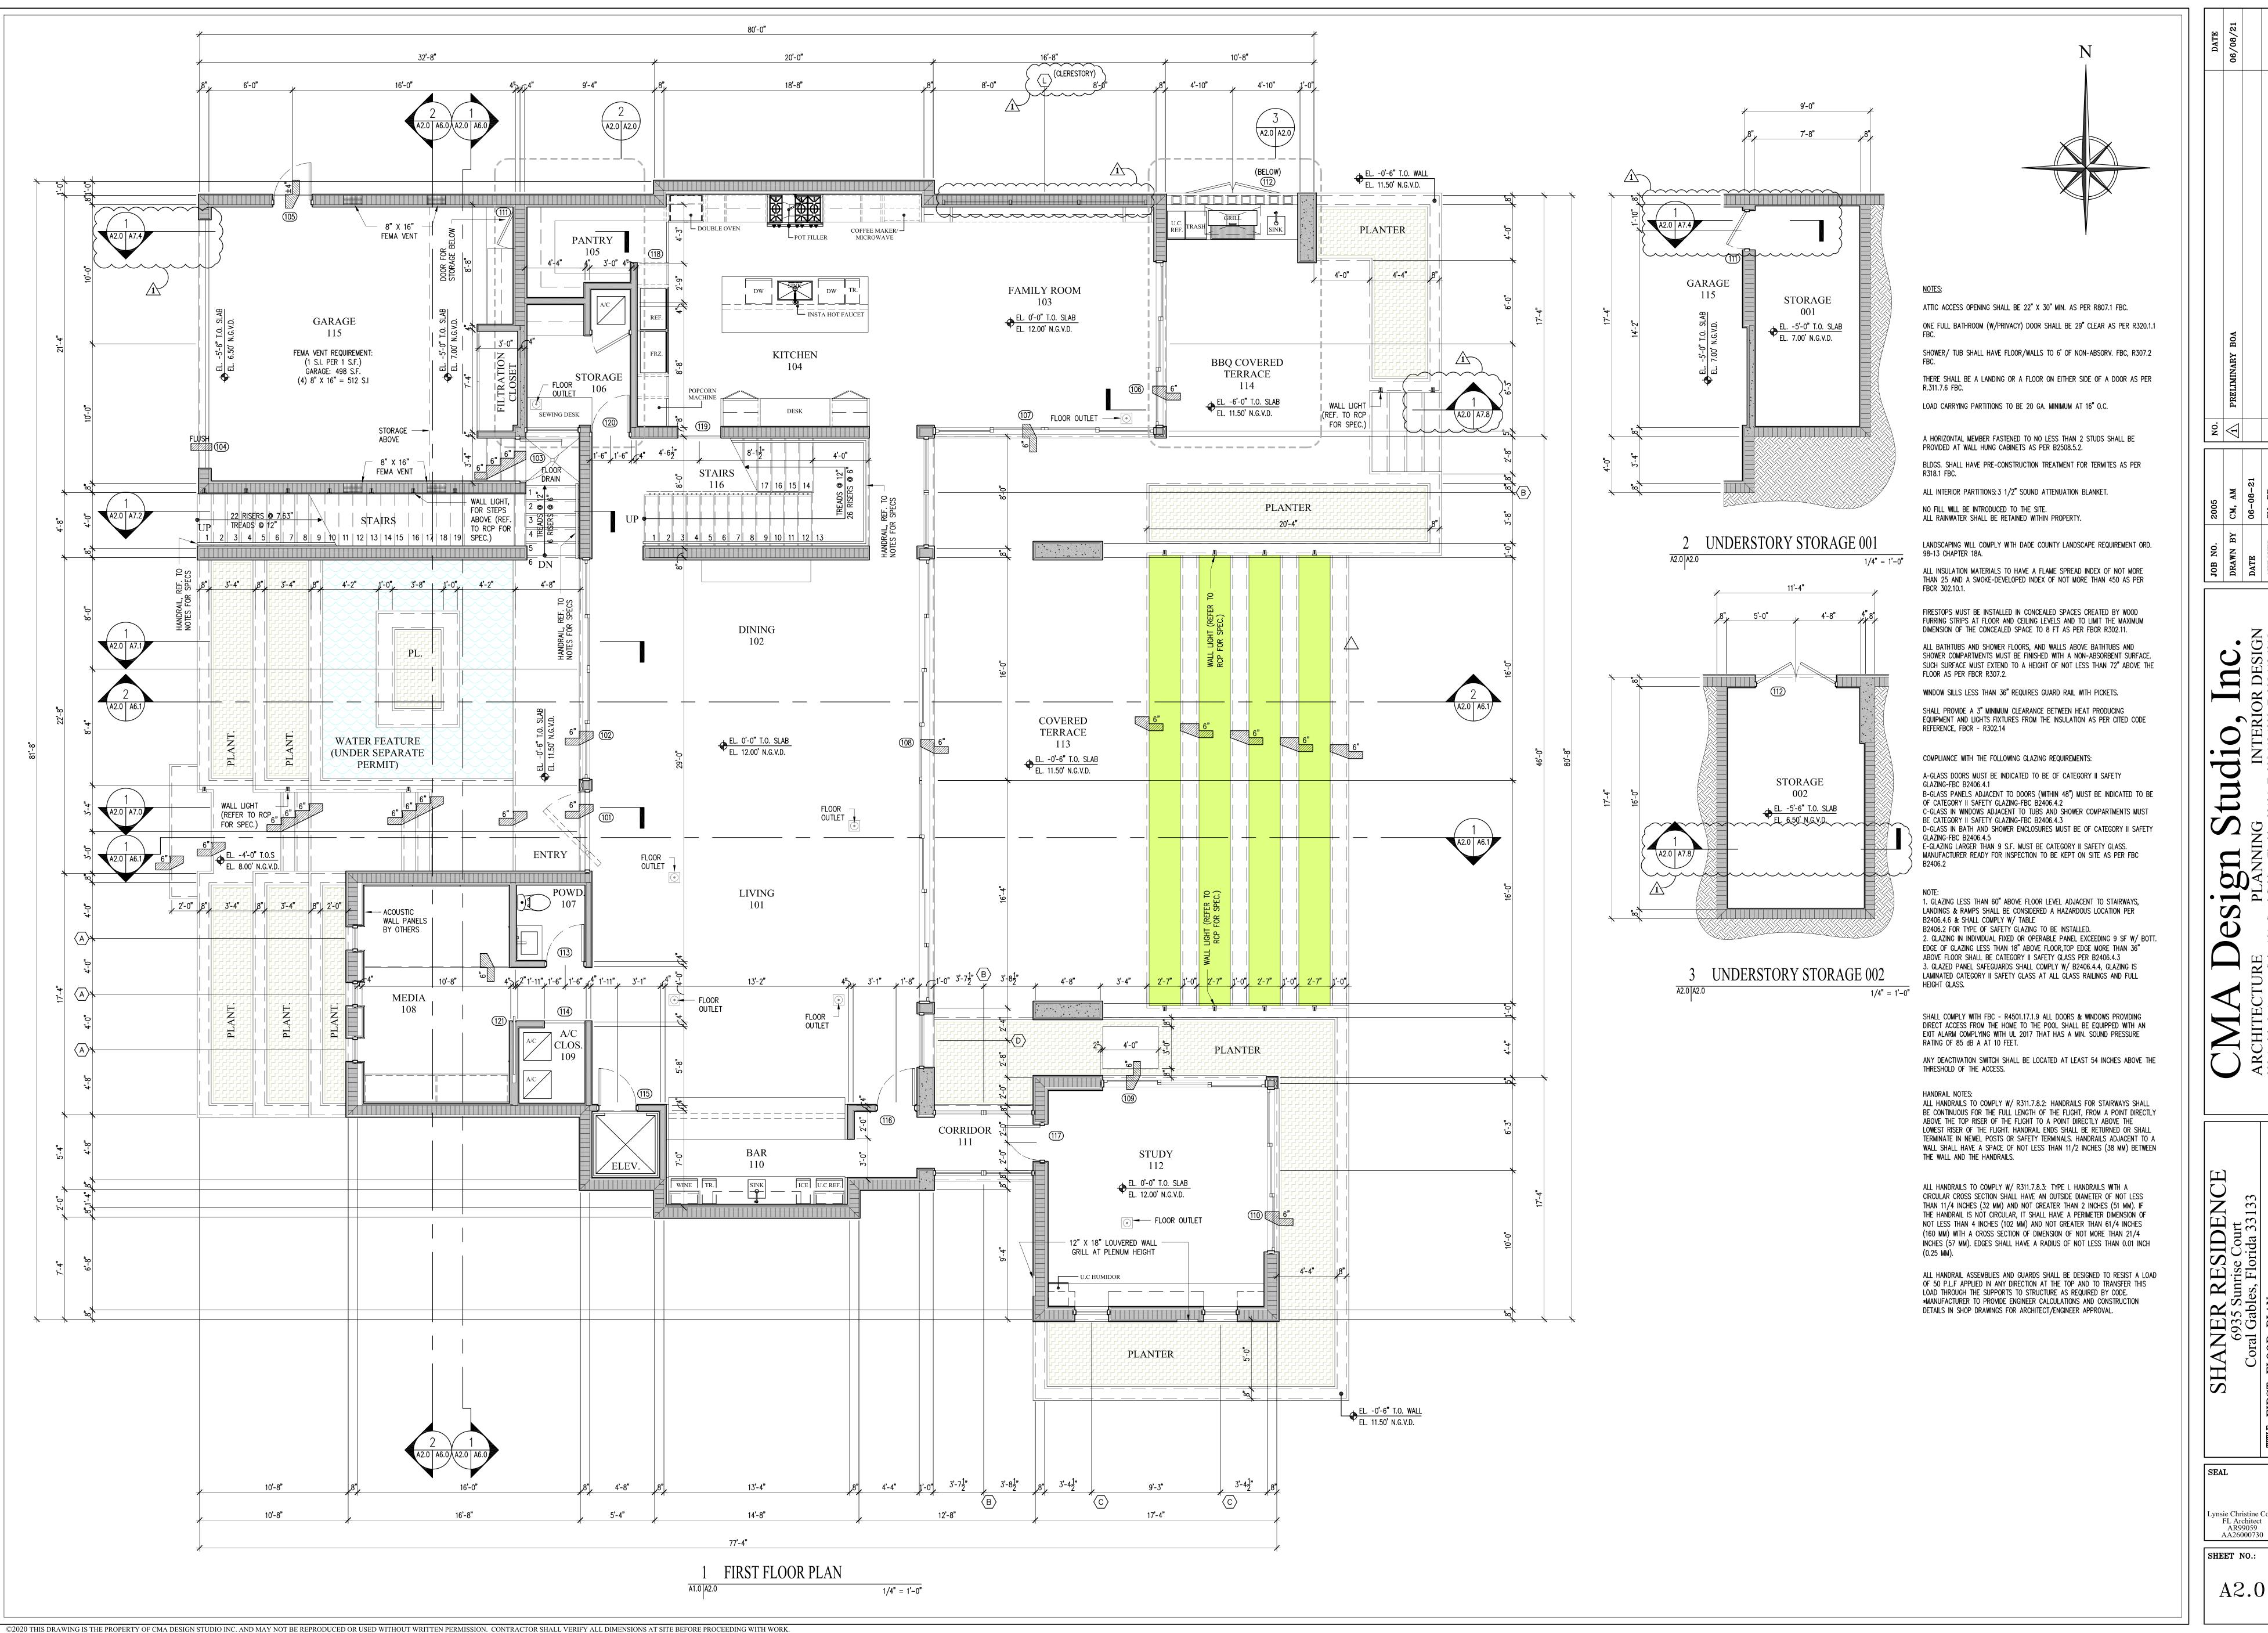

RIOR F. 2


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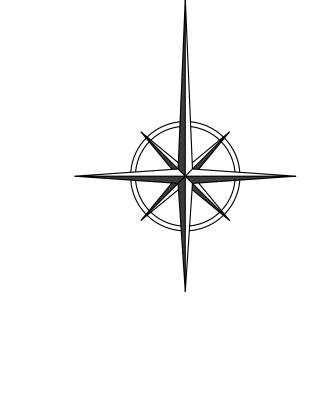
NO.

RIOR F. 200 F. 3

7 X 4.30

AA26000730



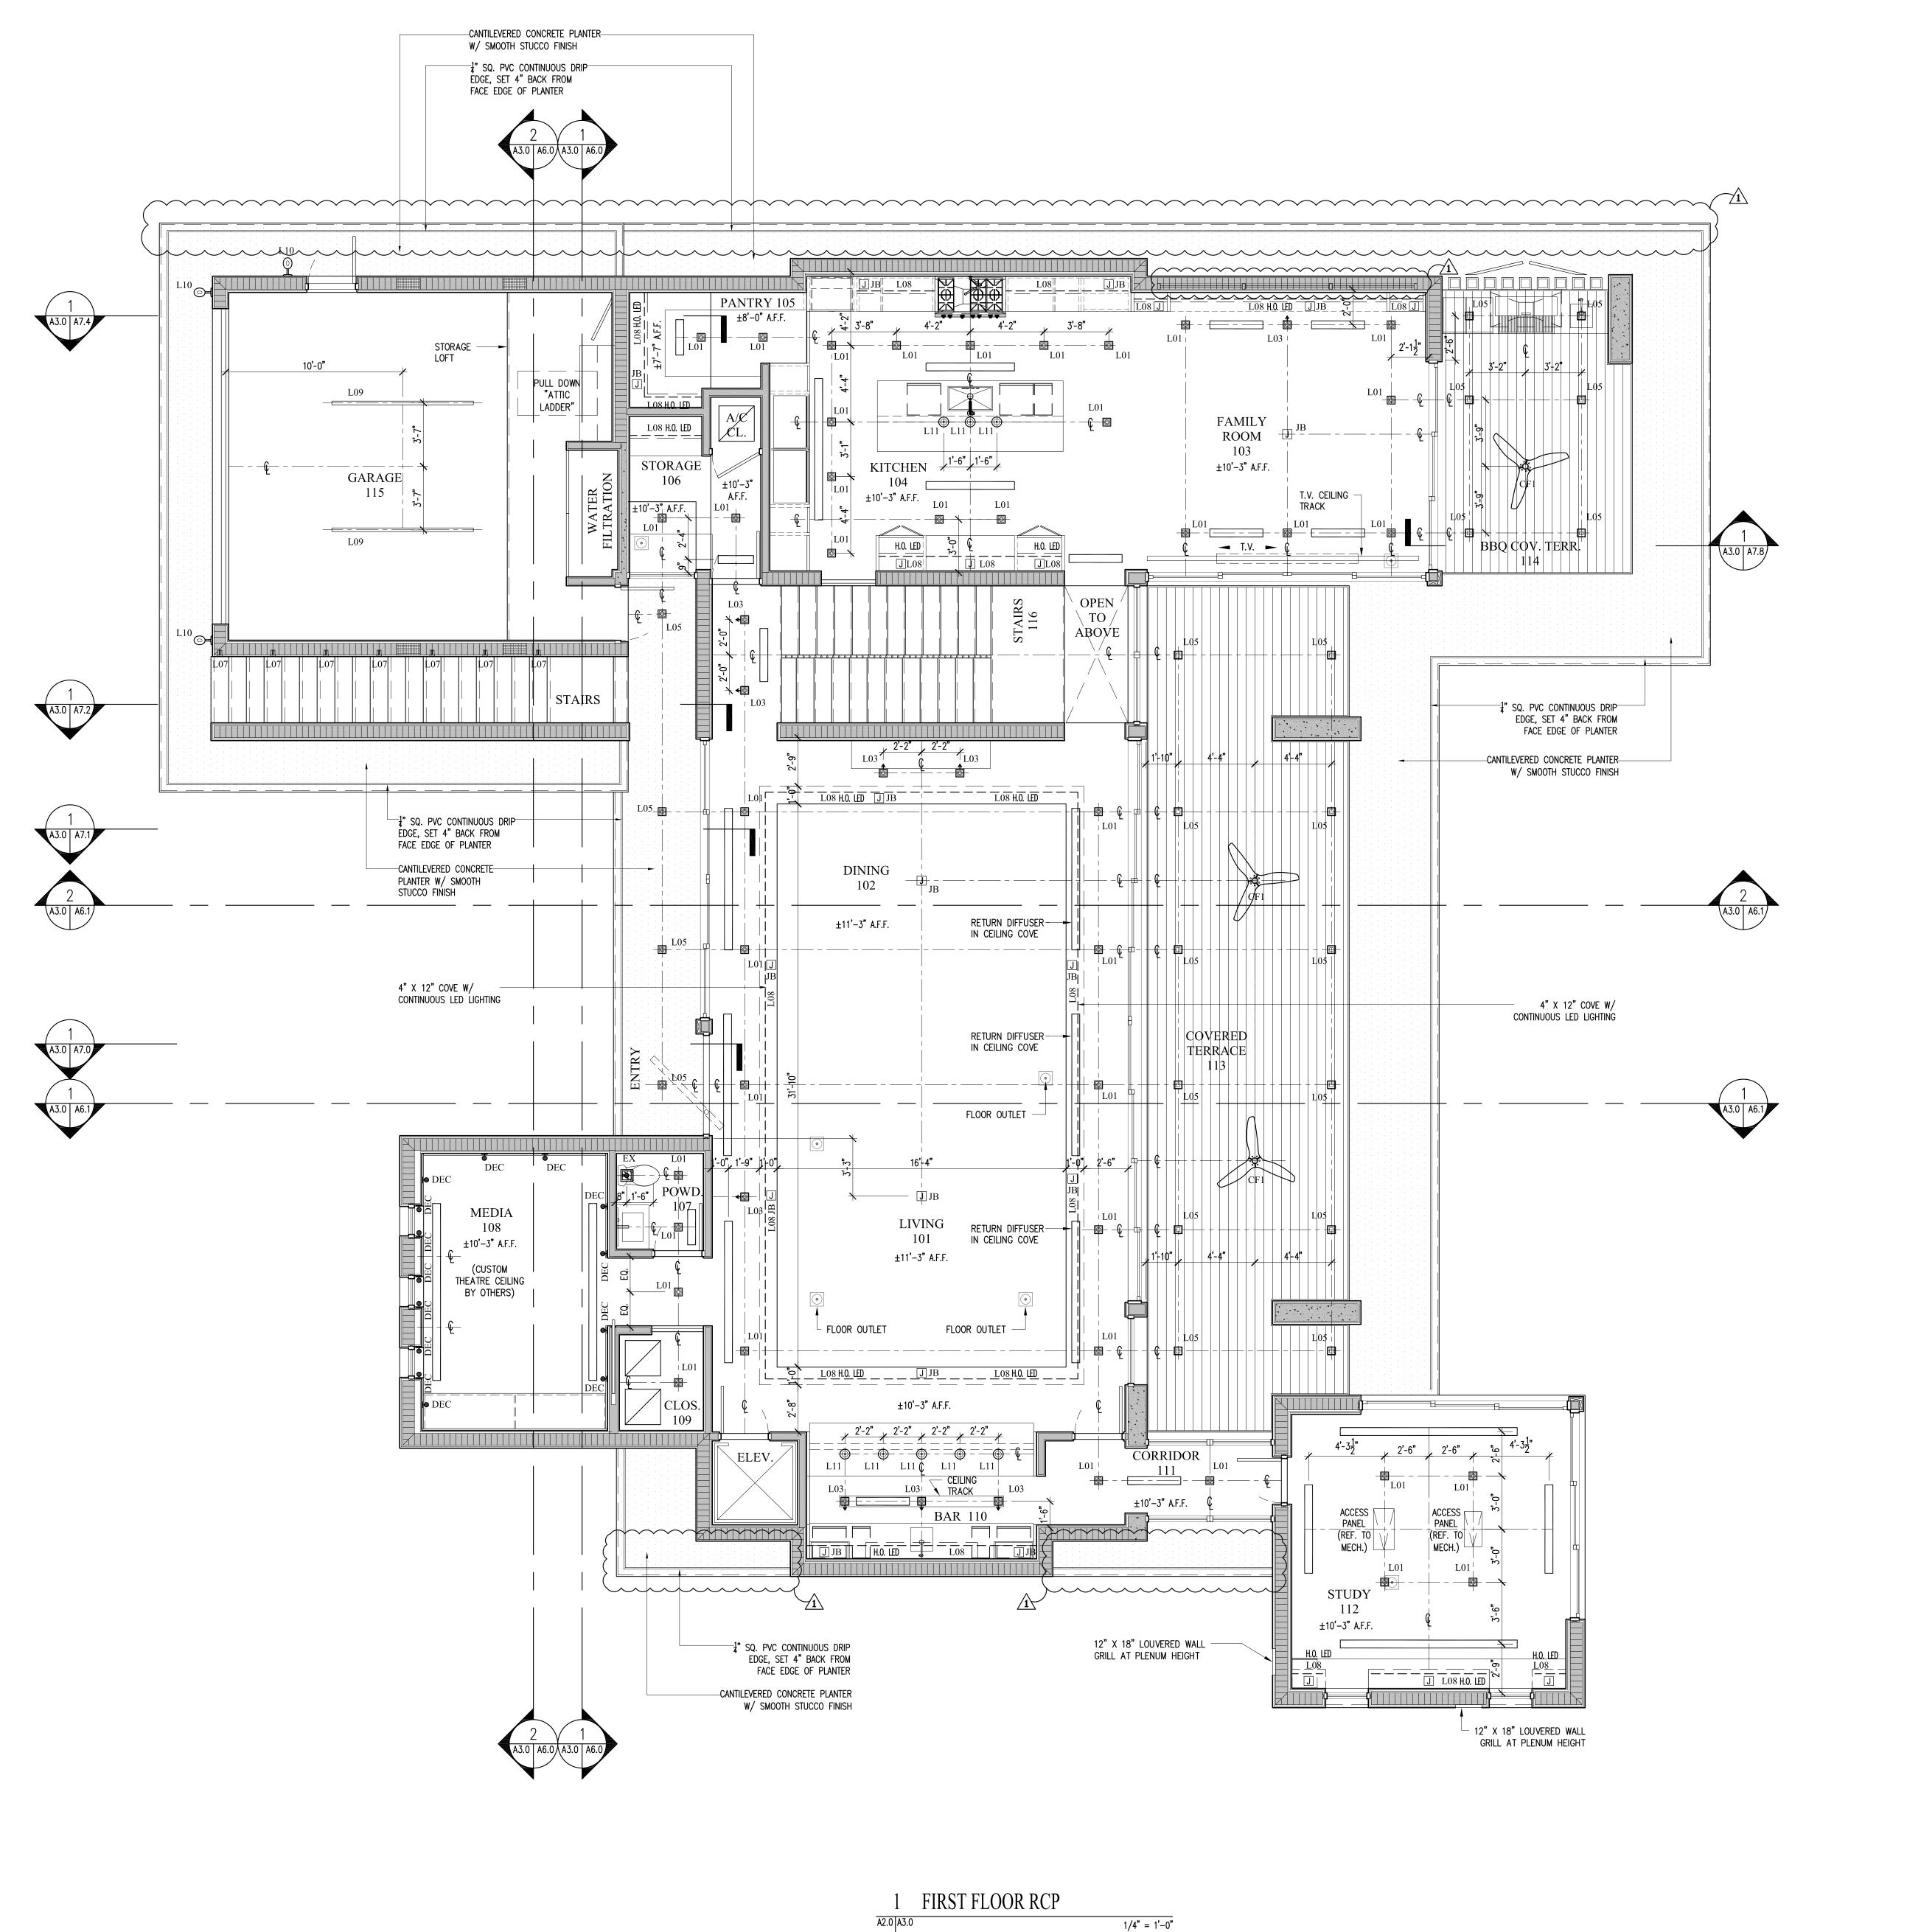

MARK	SYMBOL	TYPE	DESCRIPTION					
L01	0	LED	RECESSED INDOOR FIXTURE, 3" SQUARE LED DOWNLIGHT					
L02	0	LED	RECESSED INDOOR FIXTURE, 3" SQUARE LED DOWNLIGHT (T&G)					
L03	<b>◆</b> ◎	LED	4" LED WALL WASH DOWNLIGHT, FLANGELESS SQUARE					
L04	VP	LED	3" SQUARE LED FIXED DOWNLIGHT, FLANGELESS BEVELED, VAPOR PROOF, LV HOUSING					
L05		LED	RECESSED OUTDOOR FIXTURE 3" SQUARE LED DOWNLIGHT					
L06	40	LED	4" LED WALL WASH DOWNLIGHT, FLANGELESS SQUARE (T&G)					
L07	티	LED	SMALL LOW GLARE RECESSED WALL   STEP LIGHT FIXTURE, ANODIZED SILVER					
L08		LED	MILLWORK LIGHTING CHANNEL, HIGH OUTPUT, PREMIUM CRI, SATIN ALUMINUM					
L09		LED	12" X 48" SURFACE MOUNT LED FIXTURE, LOW PROFILE					
L10	<u> </u>	LED	DECORATIVE OUTDOOR WALL SCONCES					
L11	•	PENDANT	INTERIOR					
CF1		CEILING FAN	PENDING SELECTION					
DEC	•	DECORATIVE WALL SCONCES	PENDING SELECTION					
JВ	J	JUNCTION BOX	FOR DECORATIVE FIXTURES. PENDING SELECTION					
LD		A/C LINEAR DIFFUSER	REFER TO MECHANICAL DRAWINGS					
SP		SPEAKER	REFER TO A/V DRAWINGS					
EX	P	EXHAUST FAN	REFER TO MECHANICAL DRAWINGS					

RCP LEGEND

NOTE:
ALL CEILING DIMENSIONS ARE GIVEN TO FACE OF STRUCTURE WALLS.

CONTRACTOR TO COORDINATE LOCATIONS OF ALL REMOTE MOUNTED TRANSFORMERS WITH OWNER AND LOW VOLTAGE CONSULTANT.

ATTIC ACCESS OPENING SHALL BE 22" X 30" MIN AS PER R807.1 FBC. PROVIDE LIGHT FIXTURES IN EVERY ATTIC SPACE.

SHANER RESIDENCE
6935 Sunrise Court
Coral Gables, Florida 33133
RST FLOOR RCP

S


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AA26000730


SHEET NO.:

A3.0

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L01	<b>3</b>	LED	RECESSED INDOOR FIXTURE, 3" SQUARE LED DOWNLIGHT
L02		LED	RECESSED INDOOR FIXTURE, 3" SQUARE LED DOWNLIGHT (T&G)
L03	4∅	LED	4" LED WALL WASH DOWNLIGHT, FLANGELESS SQUARE
L04	■ VP	LED	3" SQUARE LED FIXED DOWNLIGHT, FLANGELESS BEVELED, VAPOR PROOF, LV HOUSING
L05	<b>□</b>	LED	RECESSED OUTDOOR FIXTURE 3" SQUARE LED DOWNLIGHT
L06	<b>←</b> ◎	LED	4" LED WALL WASH DOWNLIGHT, FLANGELESS SQUARE (T&G)
L07	티	LED	SMALL LOW GLARE RECESSED WALL   STEP LIGHT FIXTURE, ANODIZED SILVER
L08		LED	MILLWORK LIGHTING CHANNEL, HIGH OUTPUT, PREMIUM CRI, SATIN ALUMINUM
L09		LED	12" X 48" SURFACE MOUNT LED FIXTURE, LOW PROFILE
L10	<u> </u>	LED	DECORATIVE OUTDOOR WALL SCONCES
L11	•	PENDANT	INTERIOR
CF1		CEILING FAN	PENDING SELECTION
DEC	•	DECORATIVE WALL SCONCES	PENDING SELECTION
JB	J	JUNCTION BOX	FOR DECORATIVE FIXTURES. PENDING SELECTION
LD		A/C LINEAR DIFFUSER	REFER TO MECHANICAL DRAWINGS
SP		SPEAKER	REFER TO A/V DRAWINGS
EX	Ð	EXHAUST FAN	REFER TO MECHANICAL DRAWINGS

RCP LEGEND

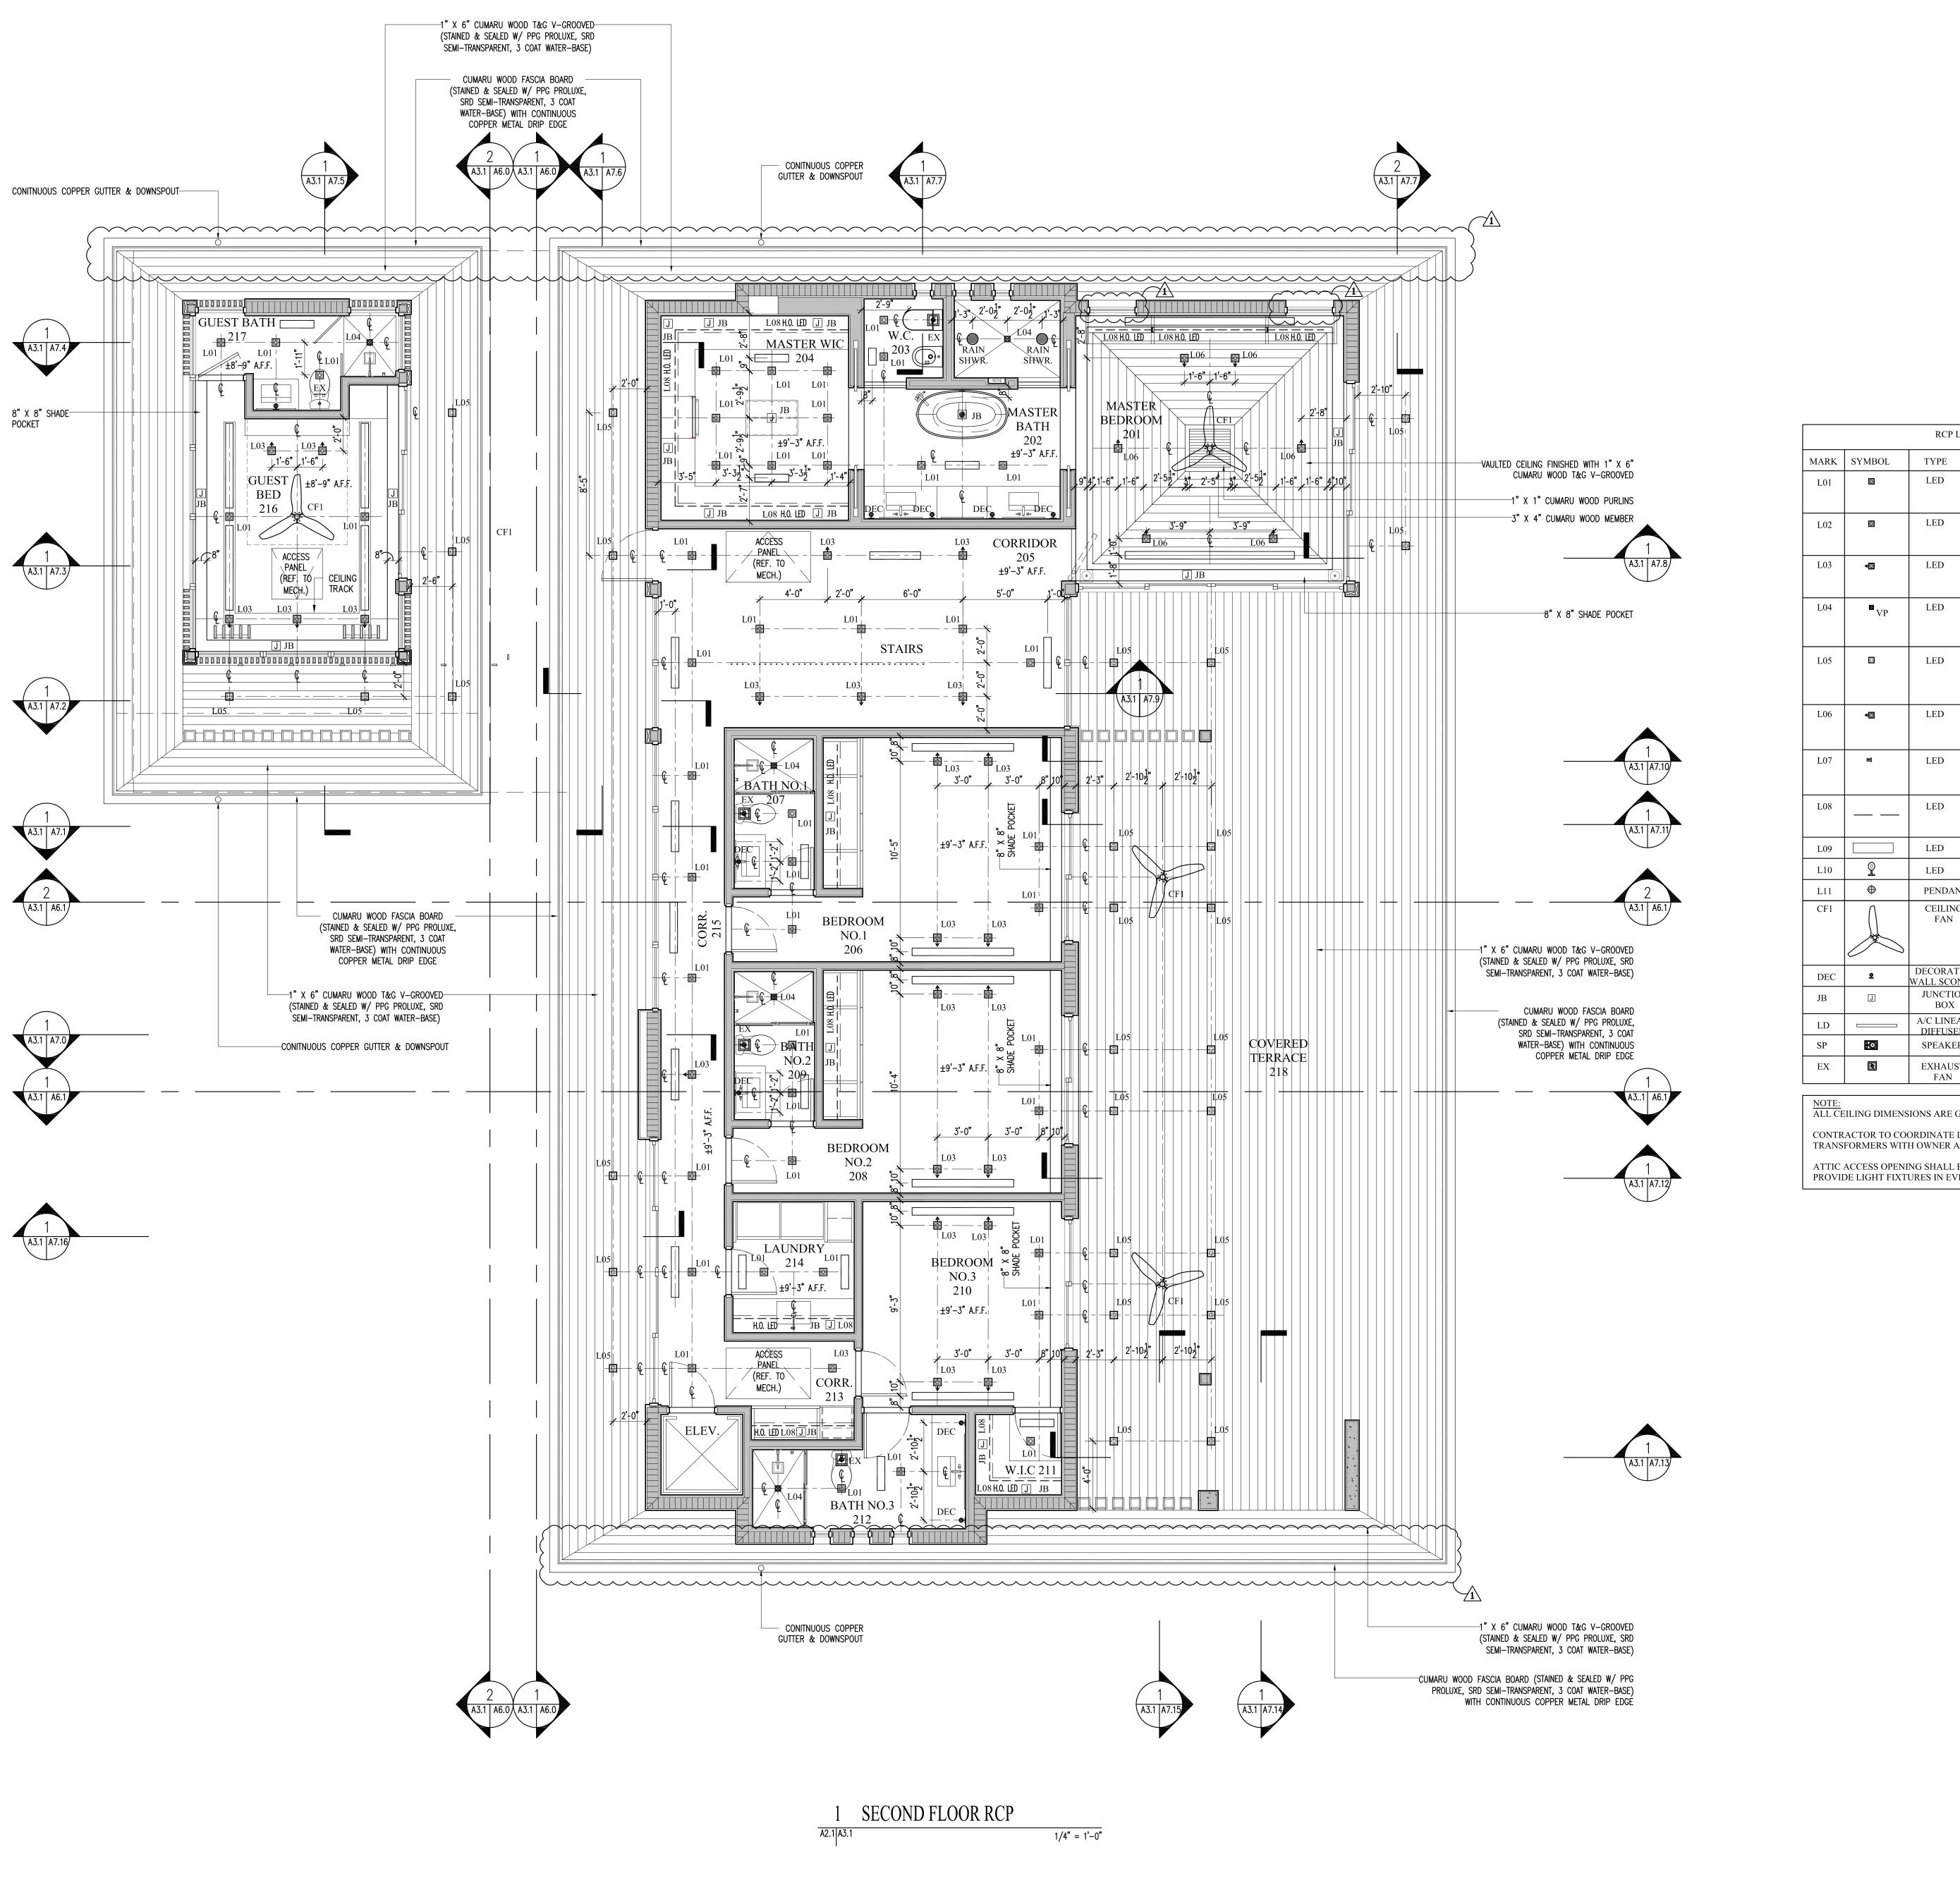DESCRIPTION

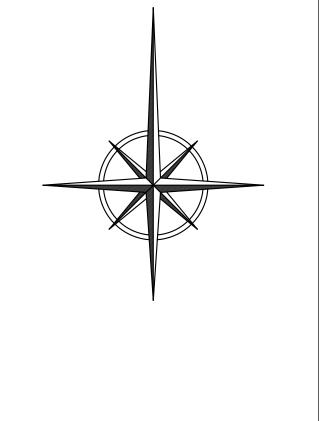NOTE:
ALL CEILING DIMENSIONS ARE GIVEN TO FACE OF STRUCTURE WALLS.

CONTRACTOR TO COORDINATE LOCATIONS OF ALL REMOTE MOUNTED TRANSFORMERS WITH OWNER AND LOW VOLTAGE CONSULTANT.

ATTIC ACCESS OPENING SHALL BE 22" X 30" MIN AS PER R807.1 FBC. PROVIDE LIGHT FIXTURES IN EVERY ATTIC SPACE.

SHANER RESIDENCE
6935 Sunrise Court
Coral Gables, Florida 33133
ECOND FLOOR RCP


NO.

SEAL

FL Architect AR99059 AA26000730

SHEET NO.:

A3.1

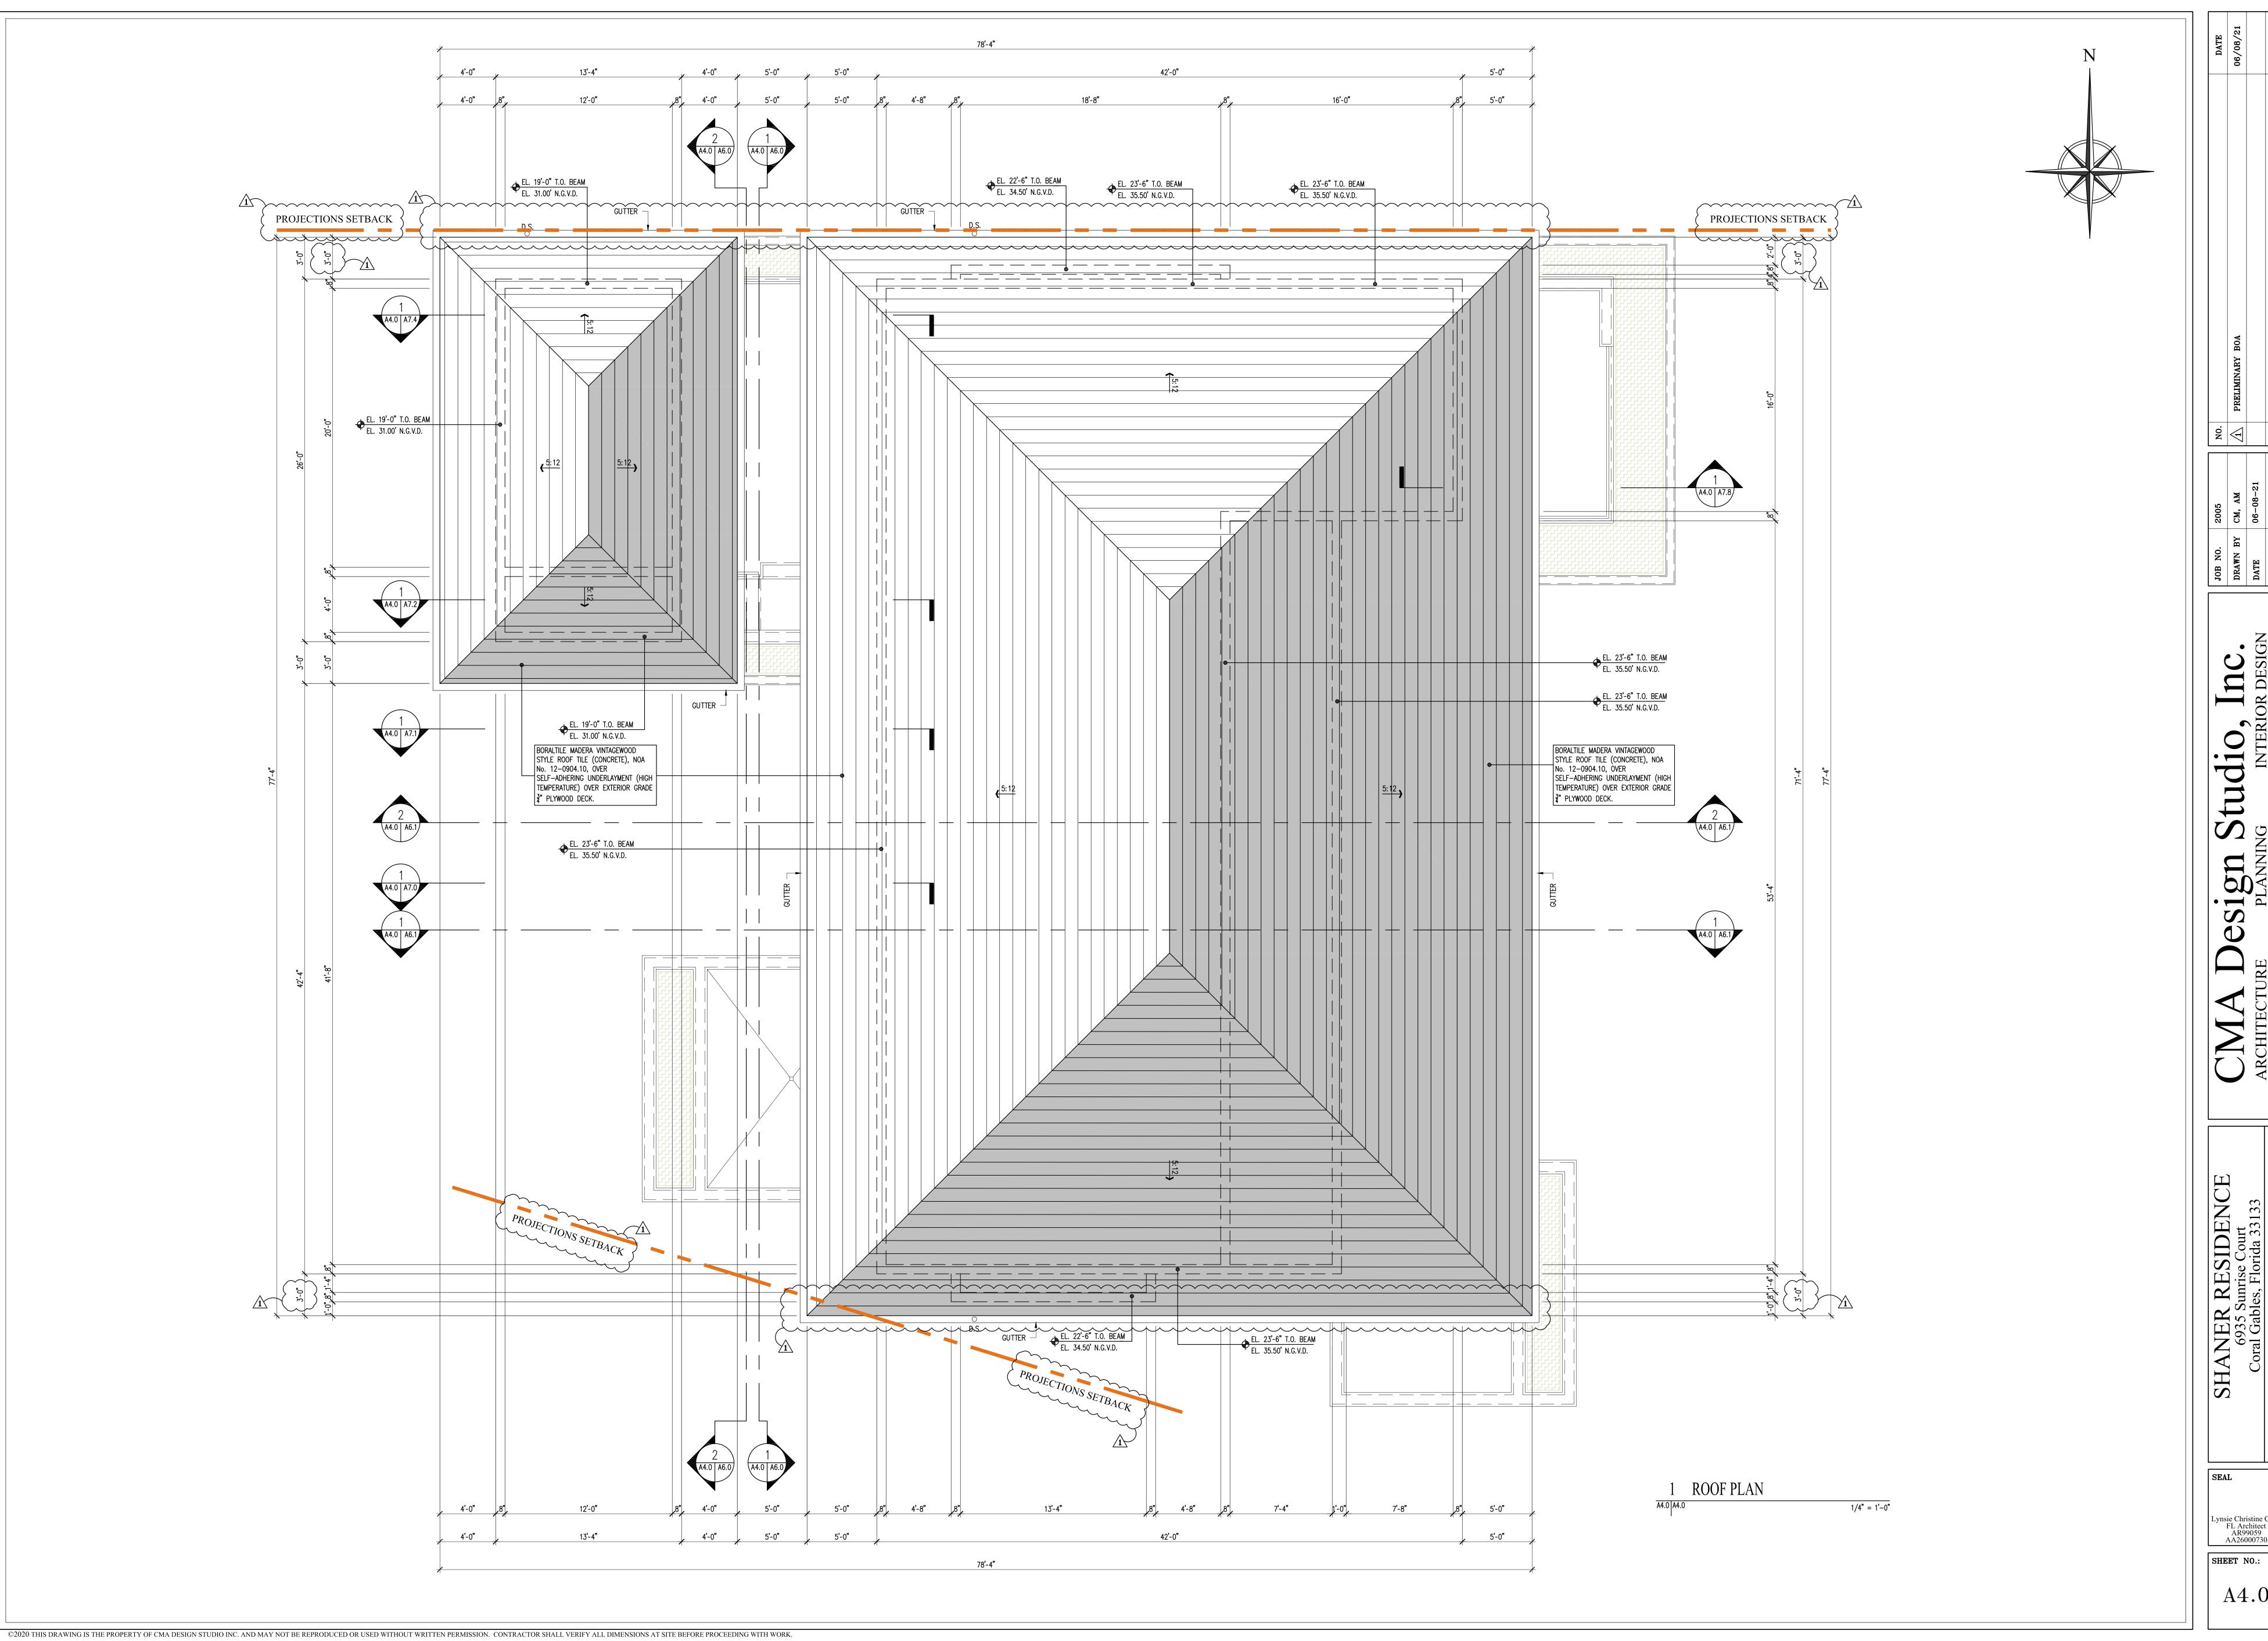



SHEET NO.:

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1305.4 igh PLANNI




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Lynsie Christine Conn FL Architect AR99059 AA26000730




igh PLANNI

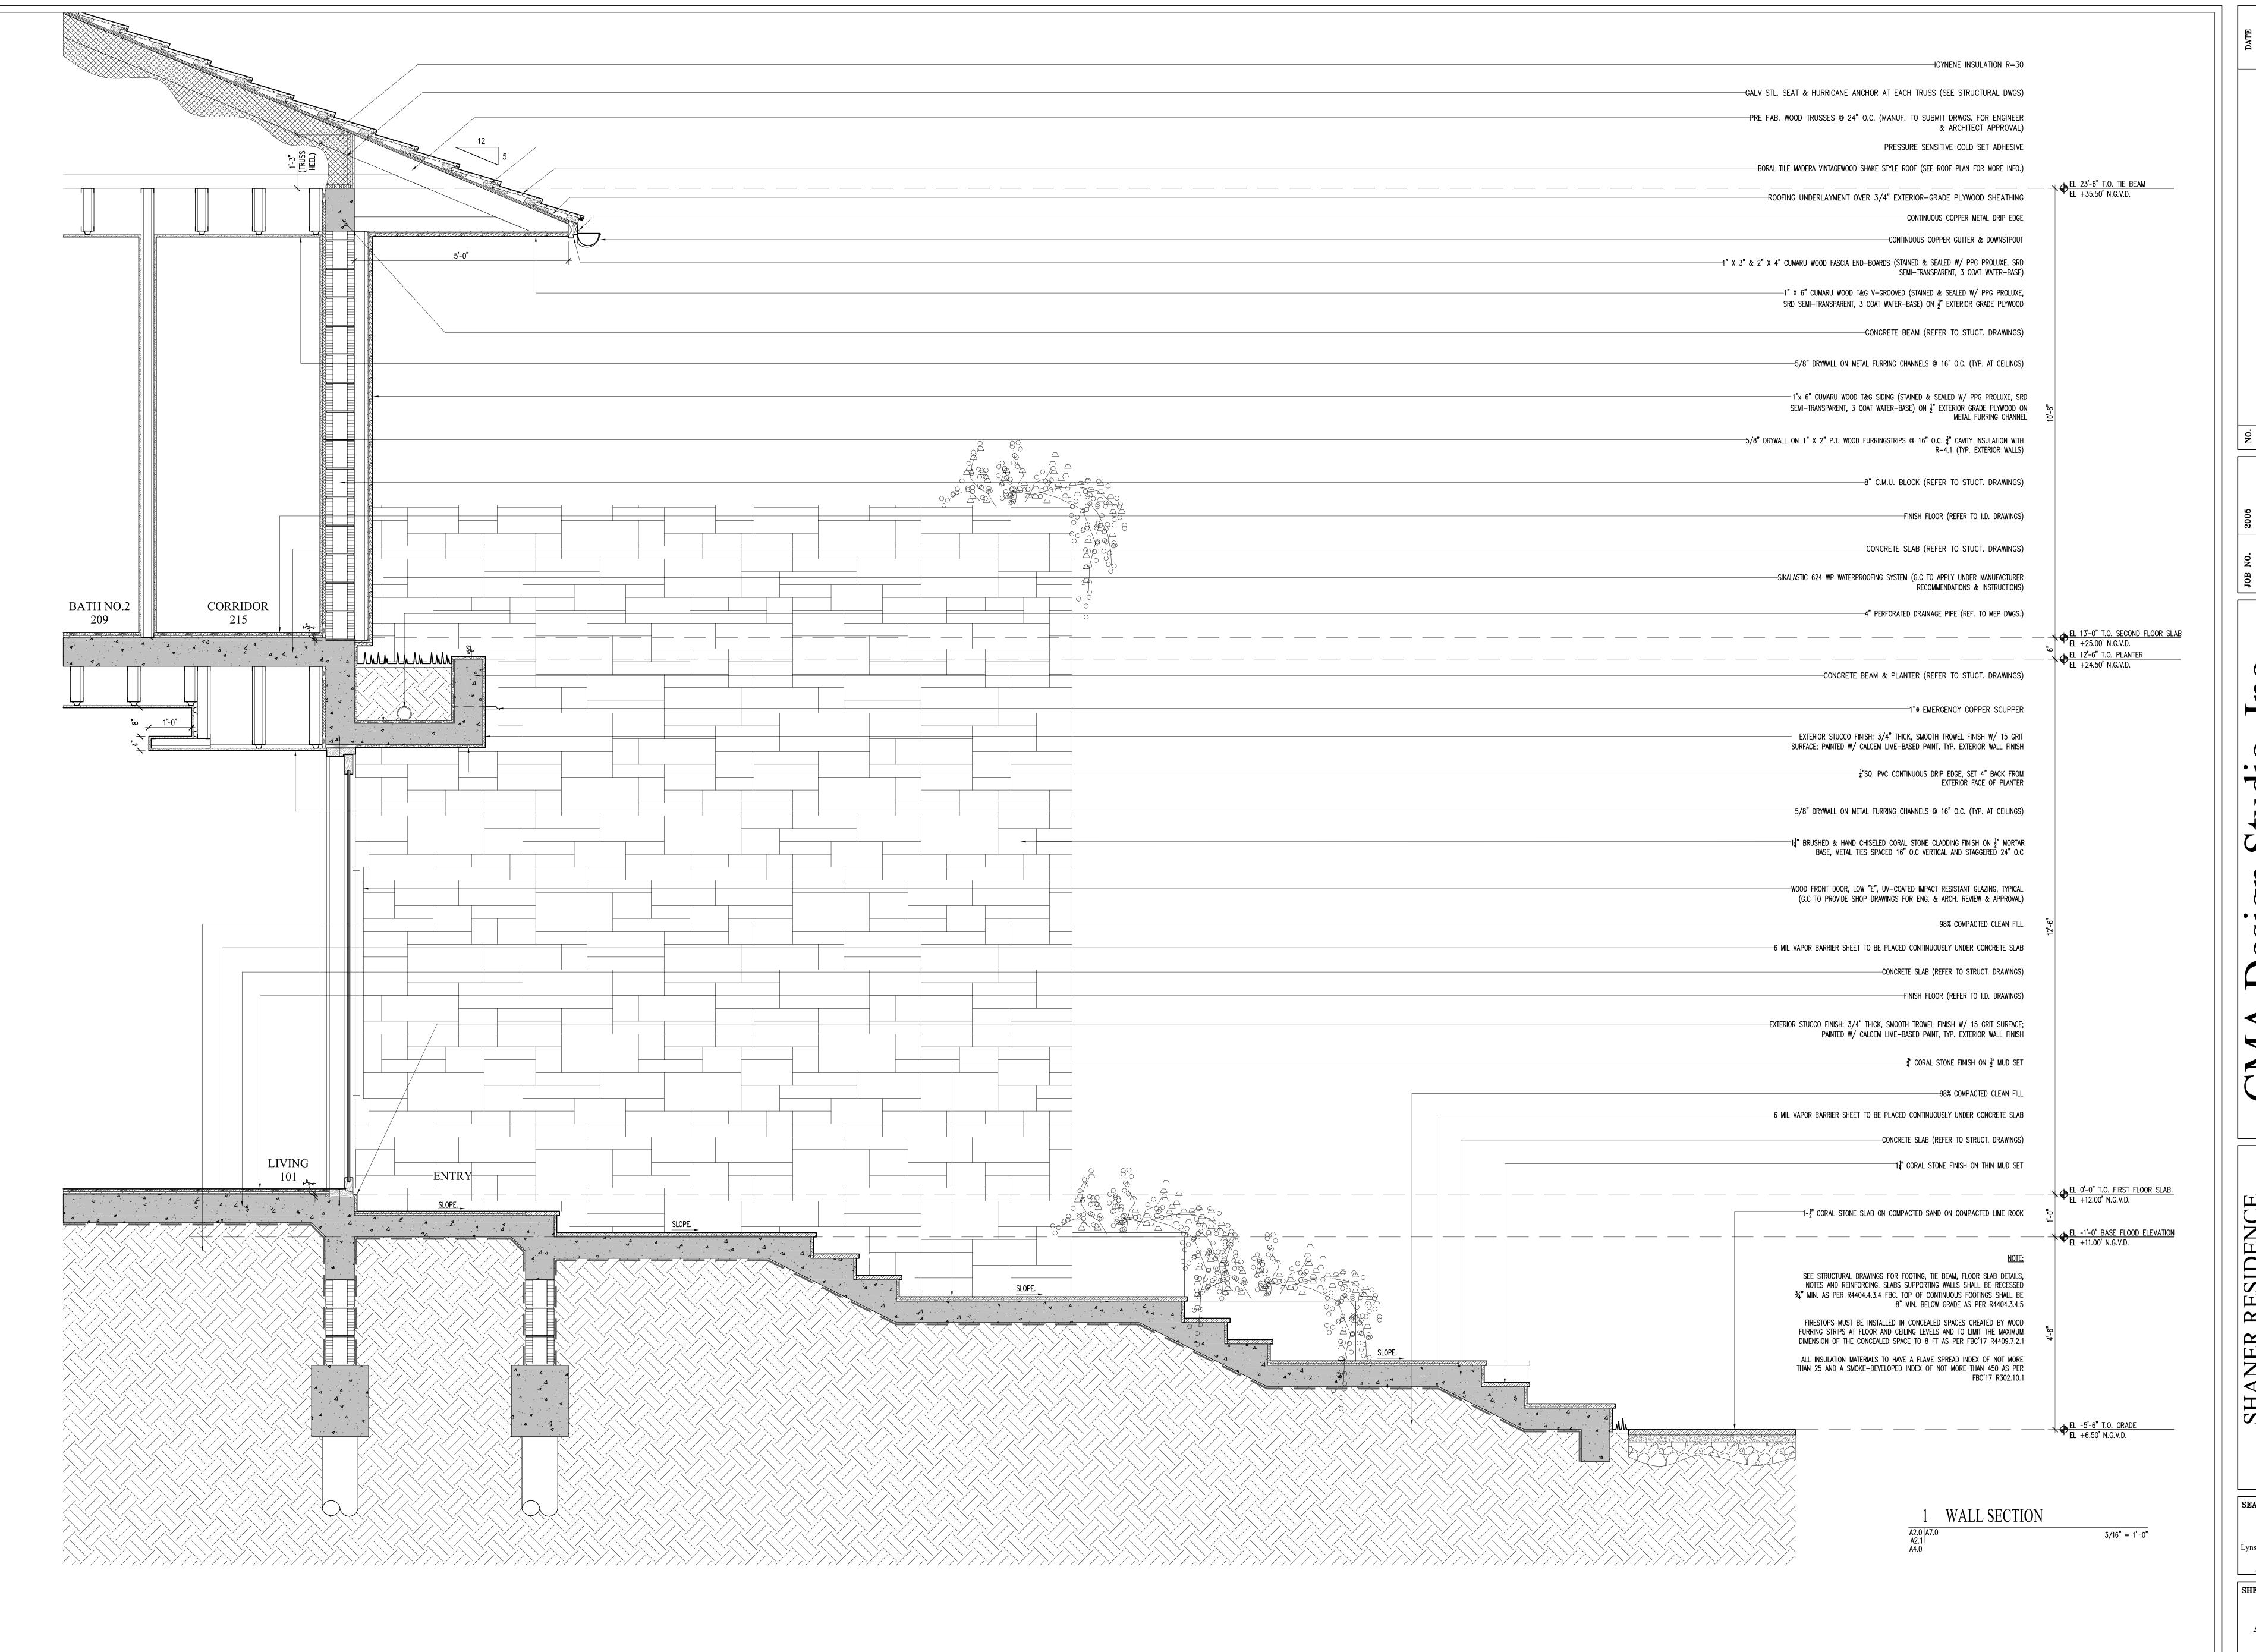


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Lynsie Christine Conn FL Architect AR99059 AA26000730

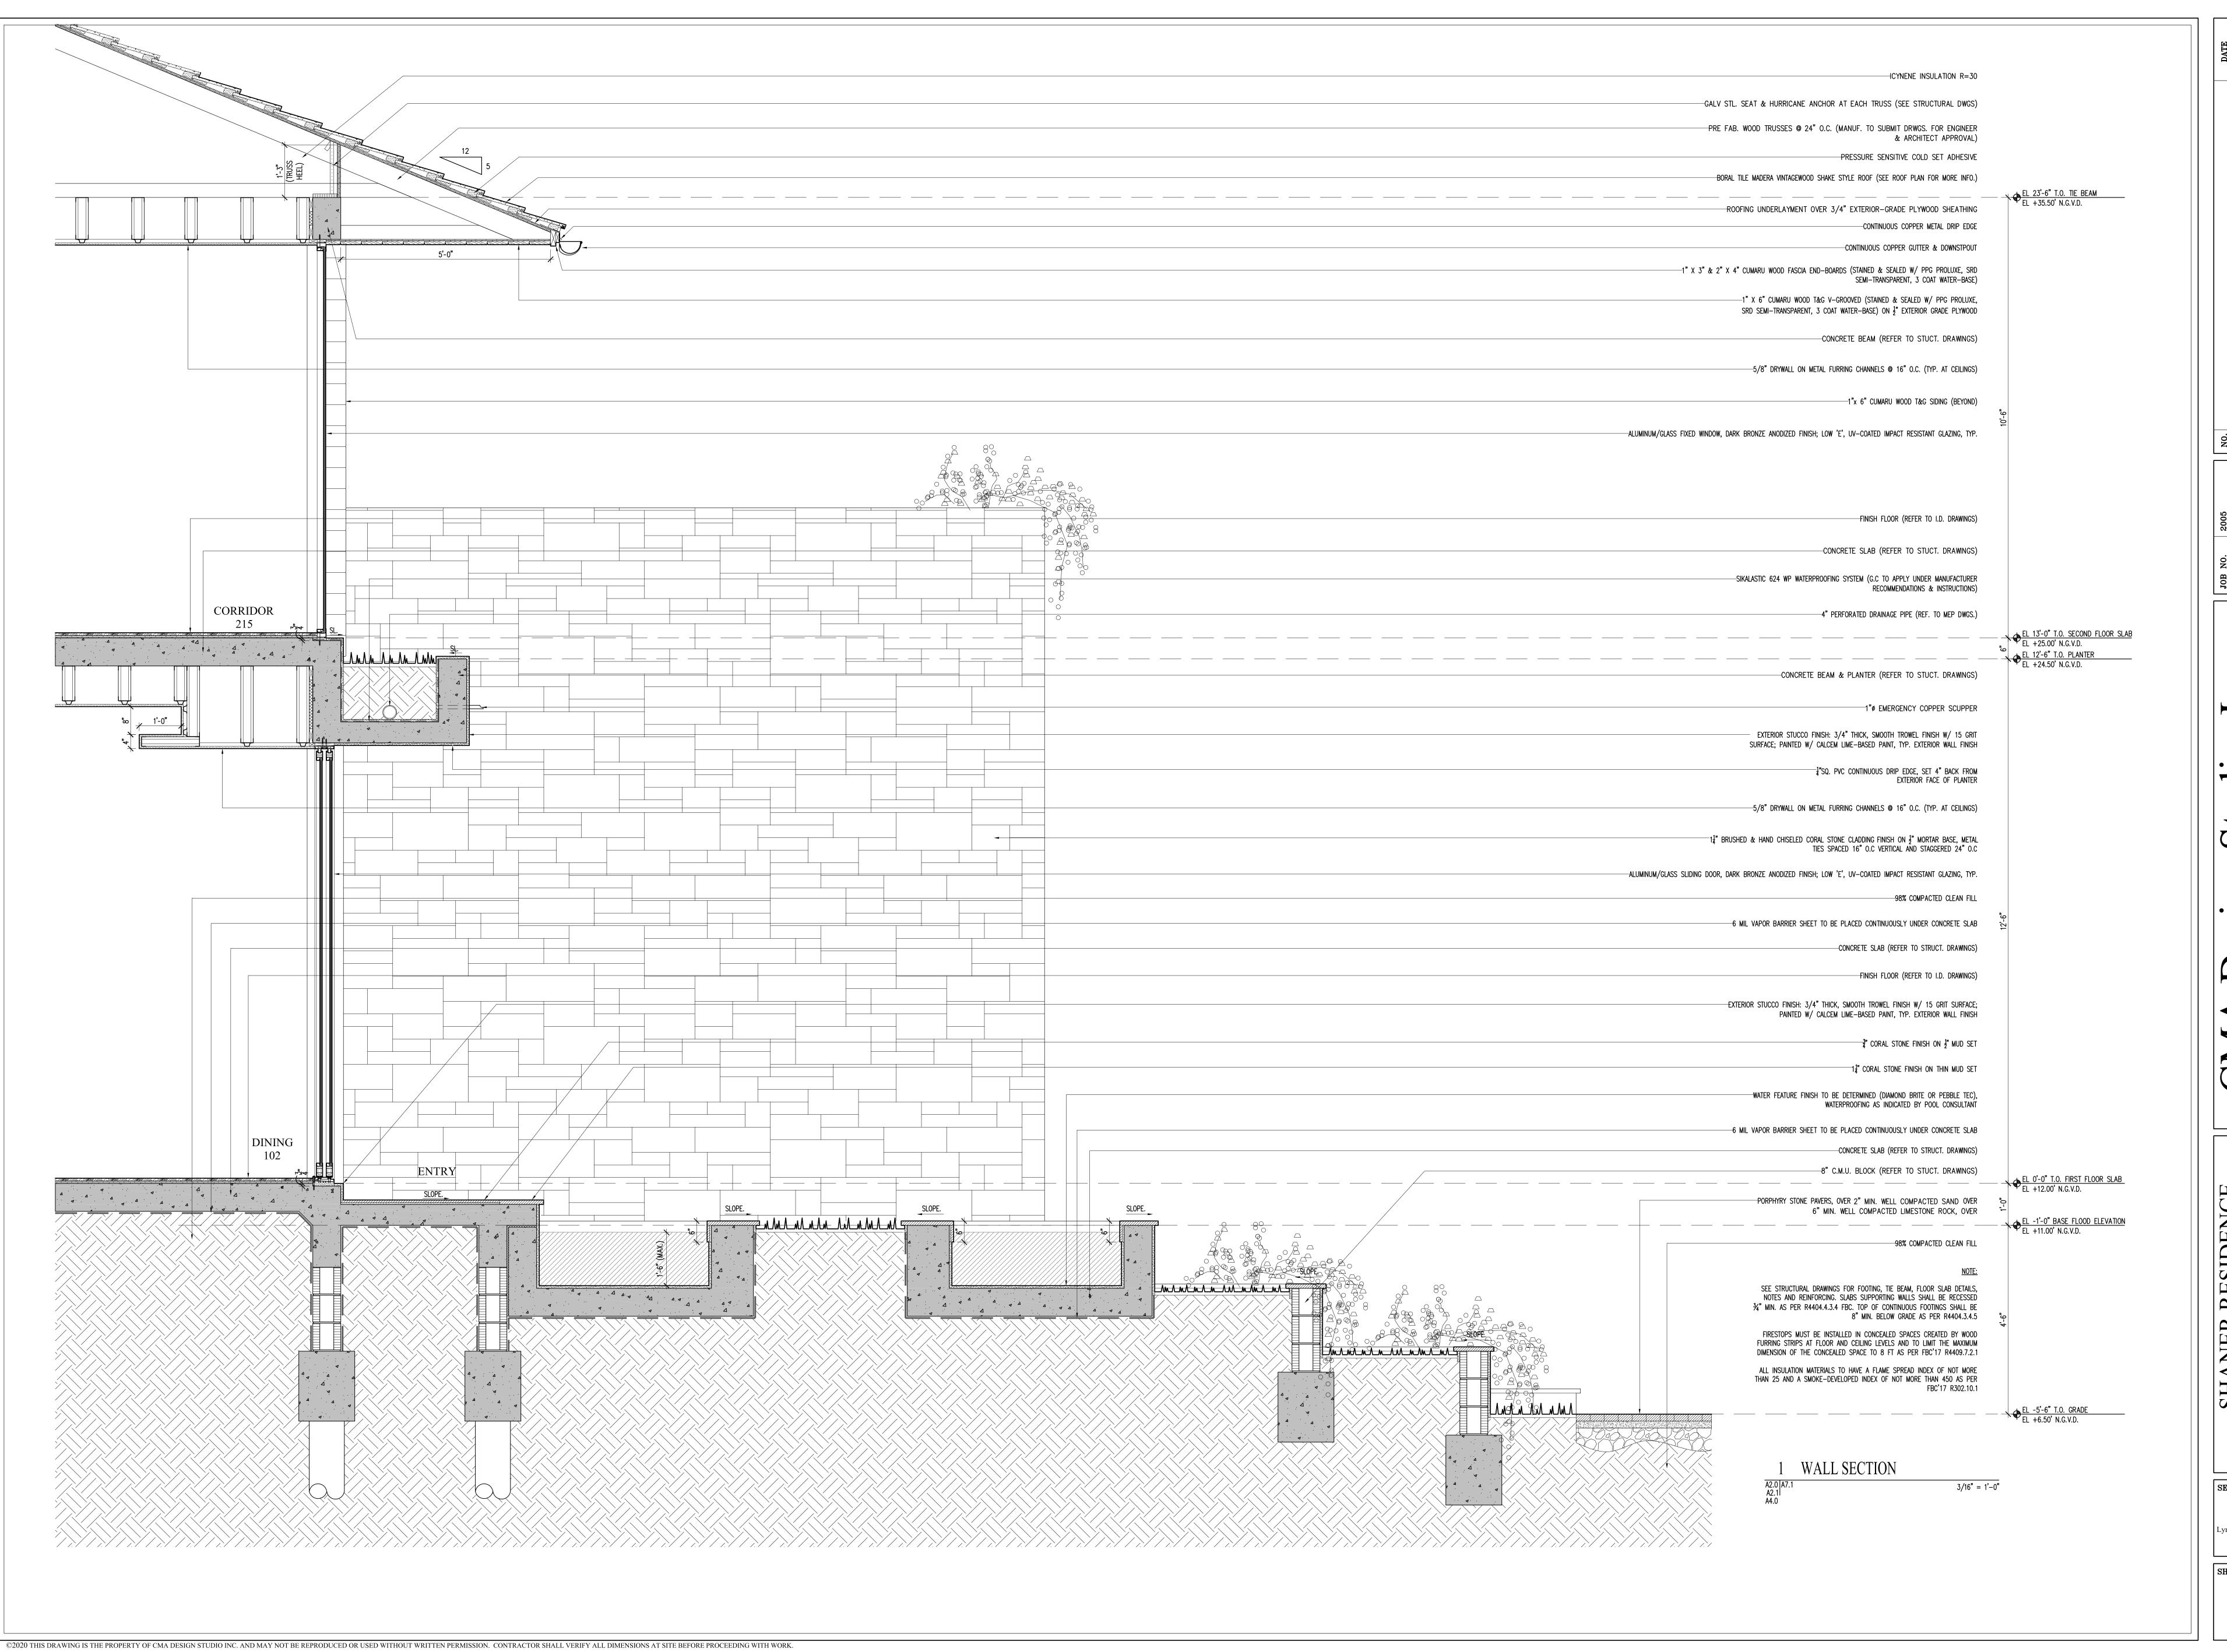

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[TERIOR]
[48.4200 F. 30

Lynsie Christine Conn FL Architect AR99059 AA26000730 SHEET NO.:

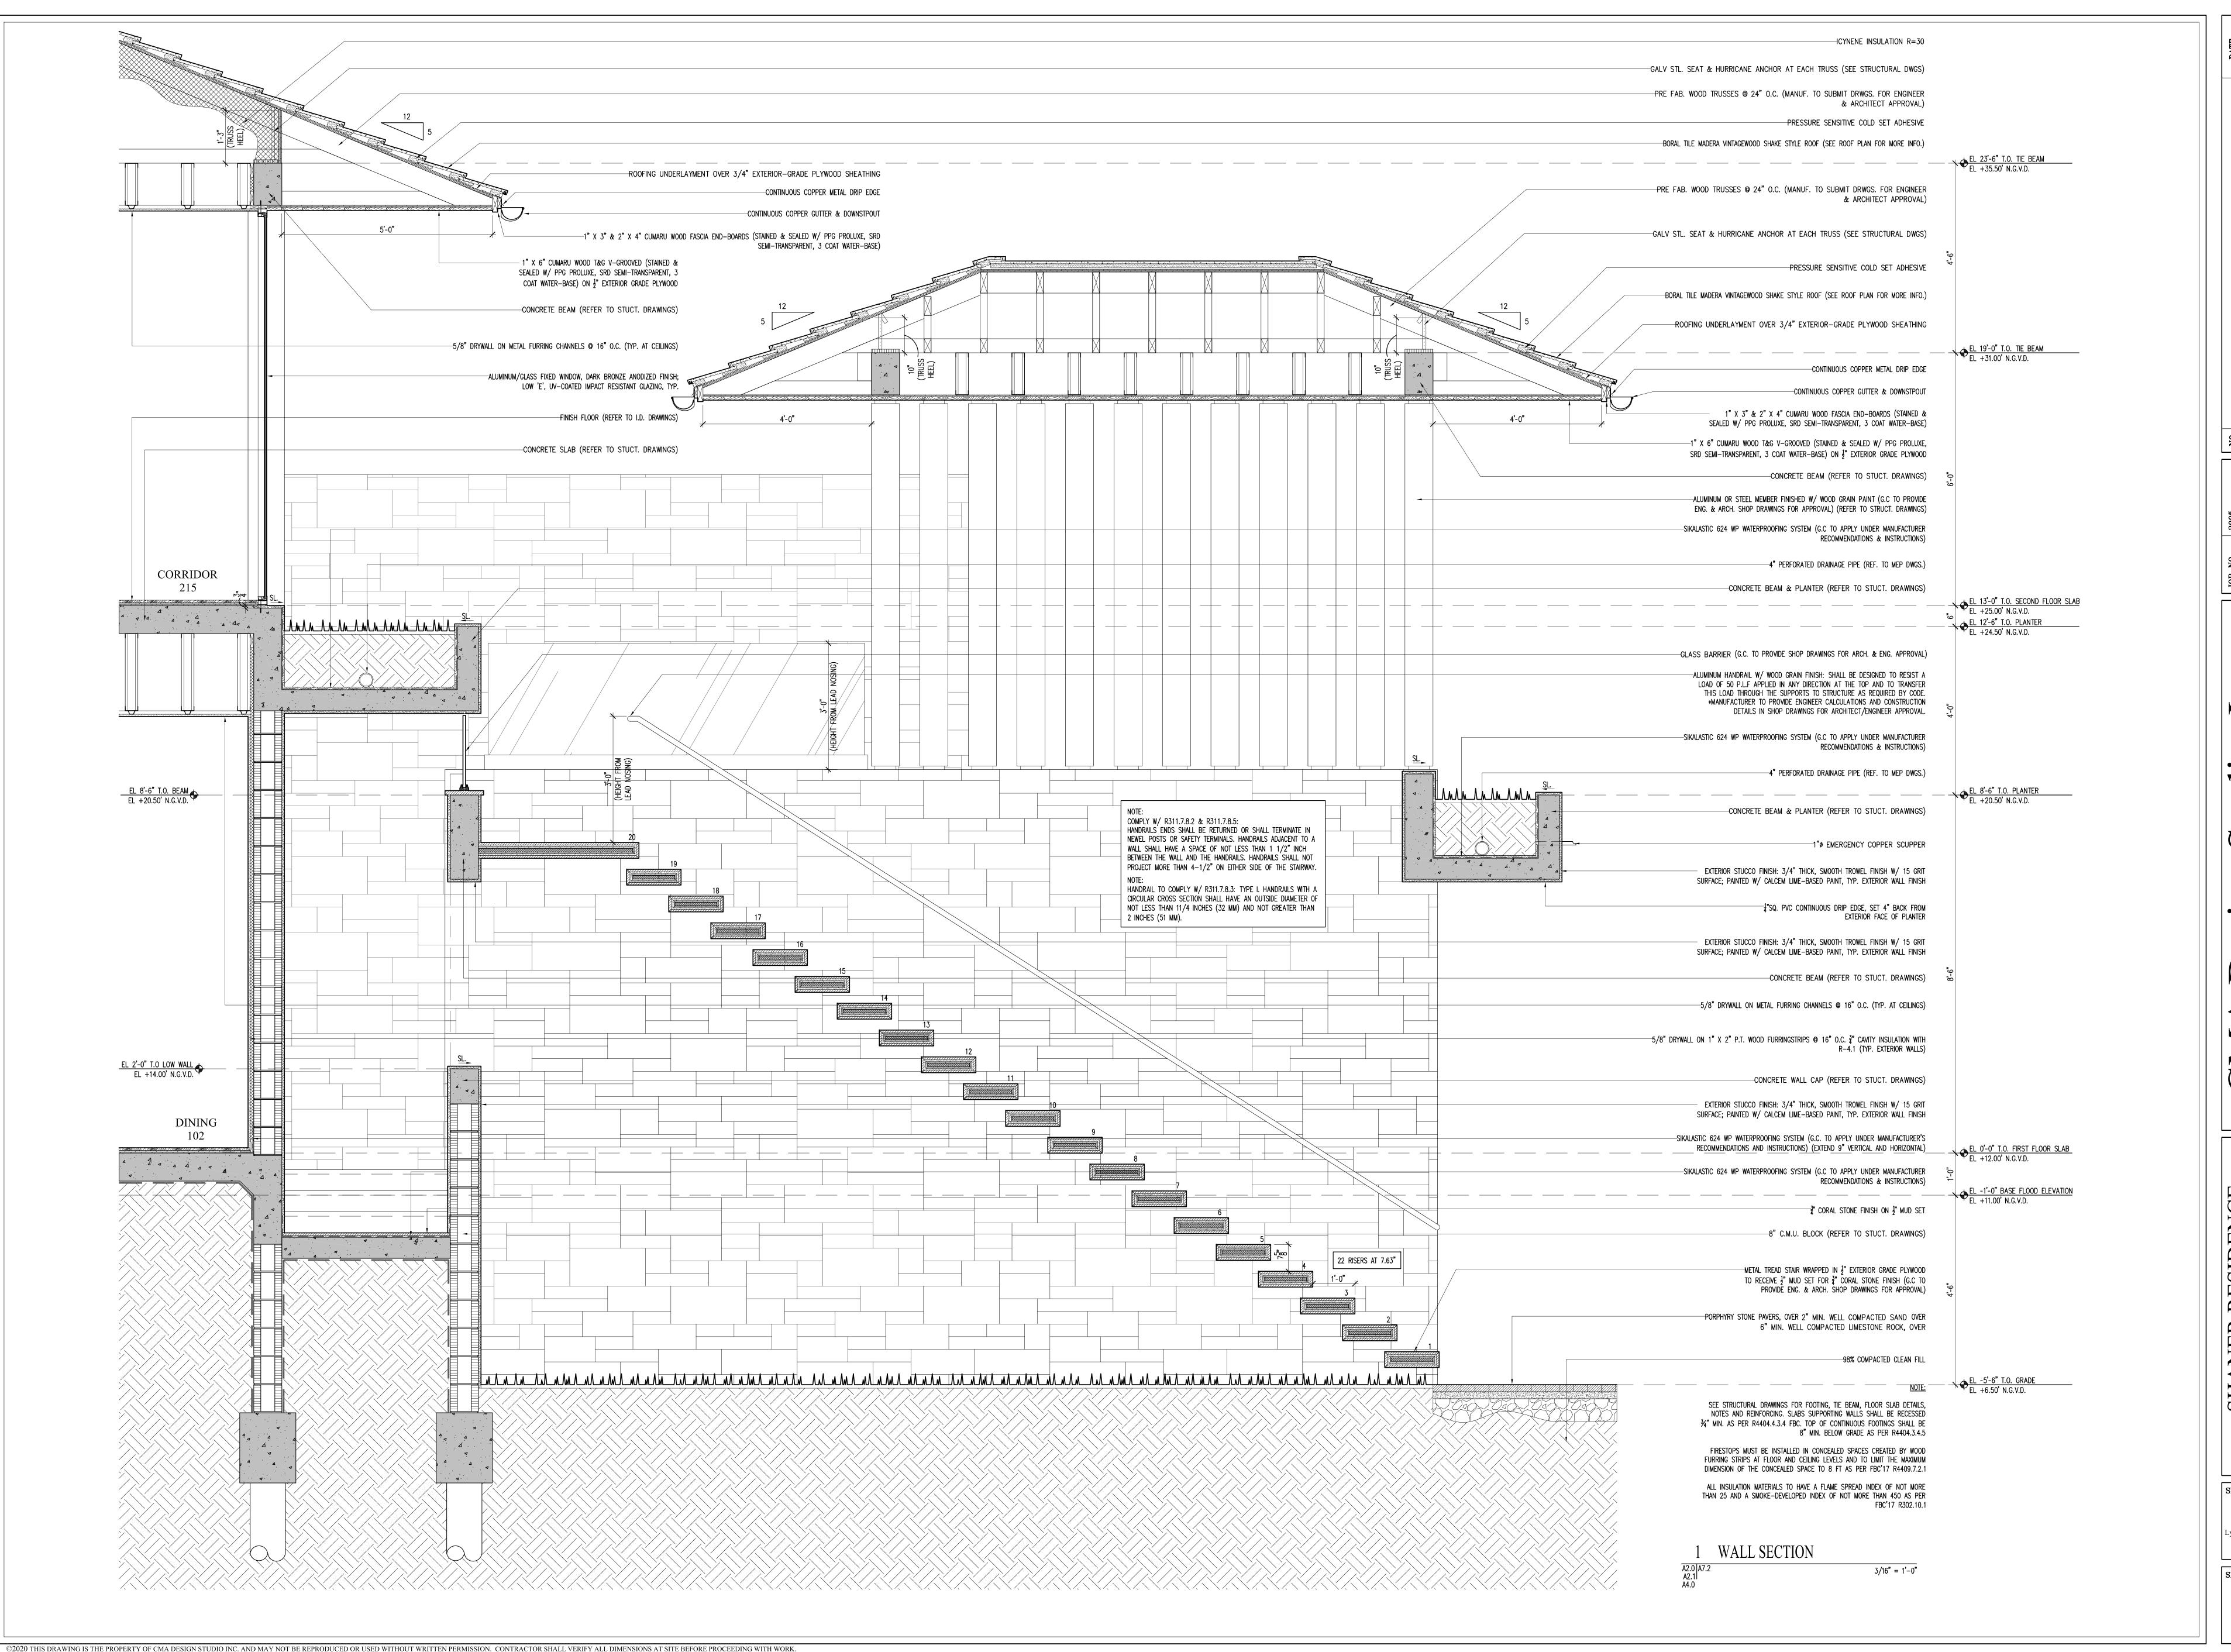

Studio Inc.

RCHITECTURE
PLANNING
INTERIOR DESIGN
2 Andalusia Avenue Suite 101 Coral Gables, Florida 33134 T: 305.448.4200 F: 305.448.4215


SHANER RESIDENCE
6935 Sunrise Court
Coral Gables, Florida 33133

Coral Garante WALL SECTION

Lynsie Christine Conn FL Architect AR99059 AA26000730 SHEET NO.:


SHEET NO.:

A7.2

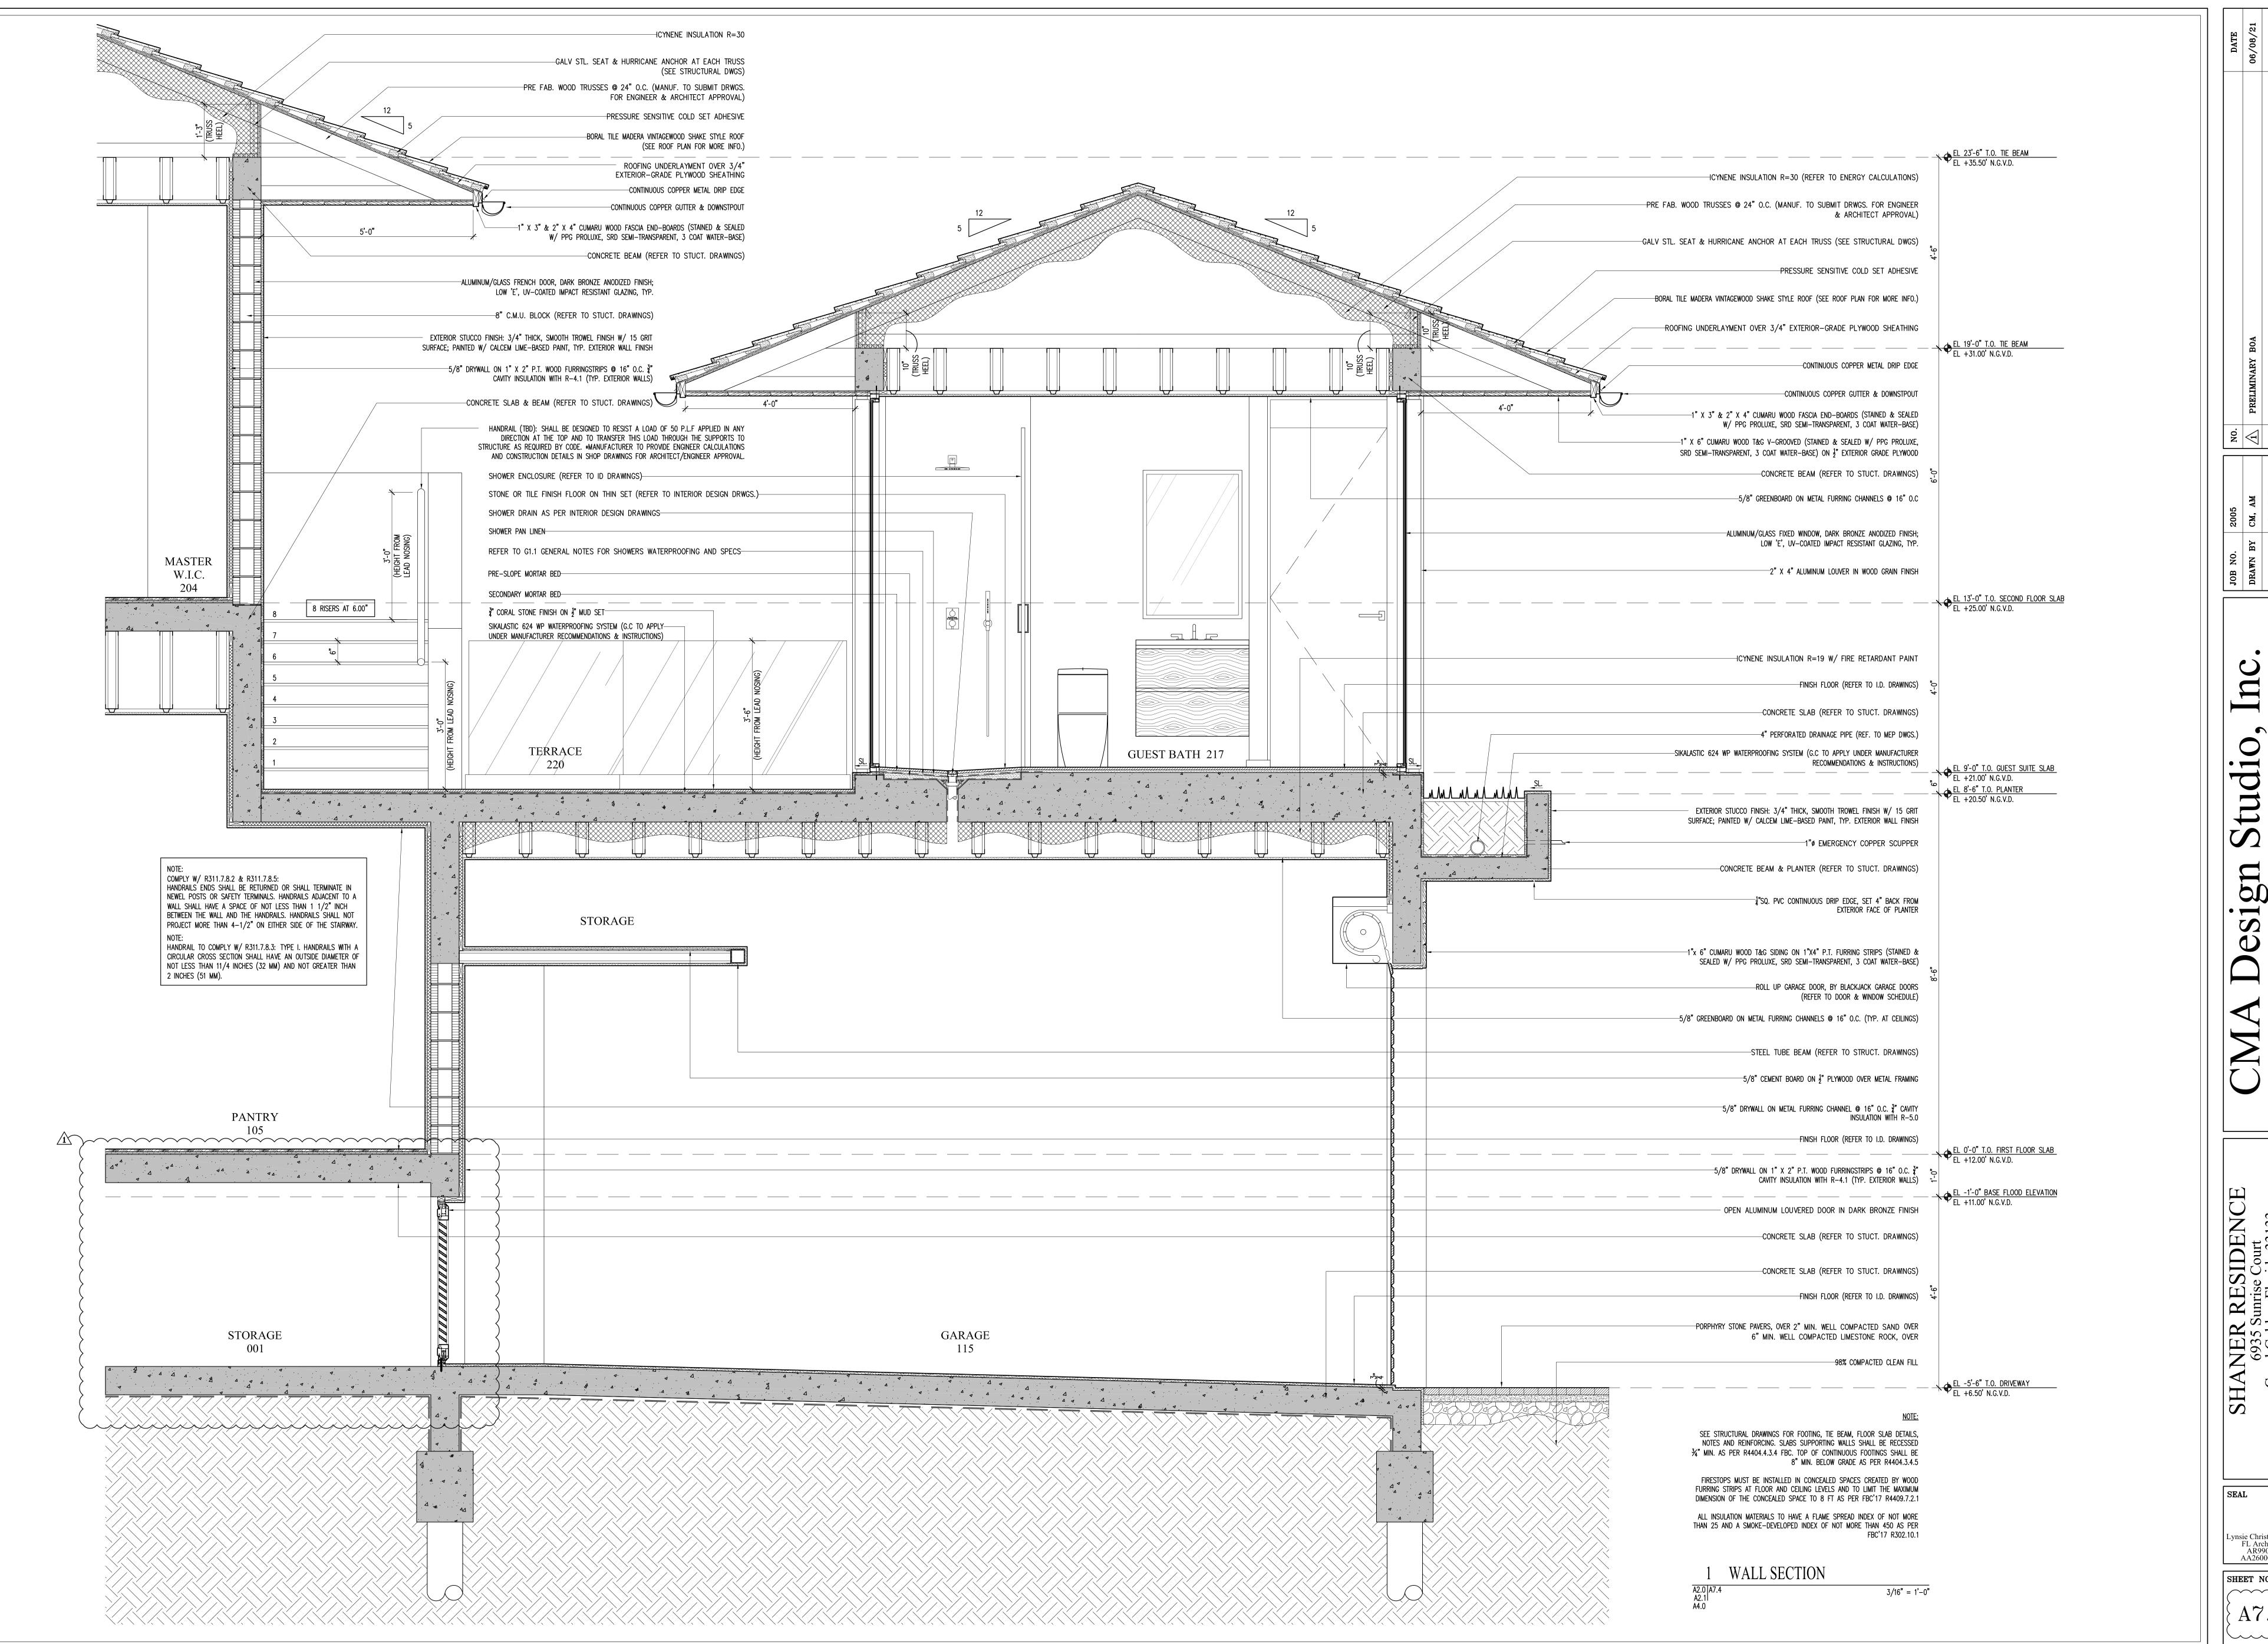

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Lynsie Christine Conn FL Architect AR99059 AA26000730 SHEET NO.:

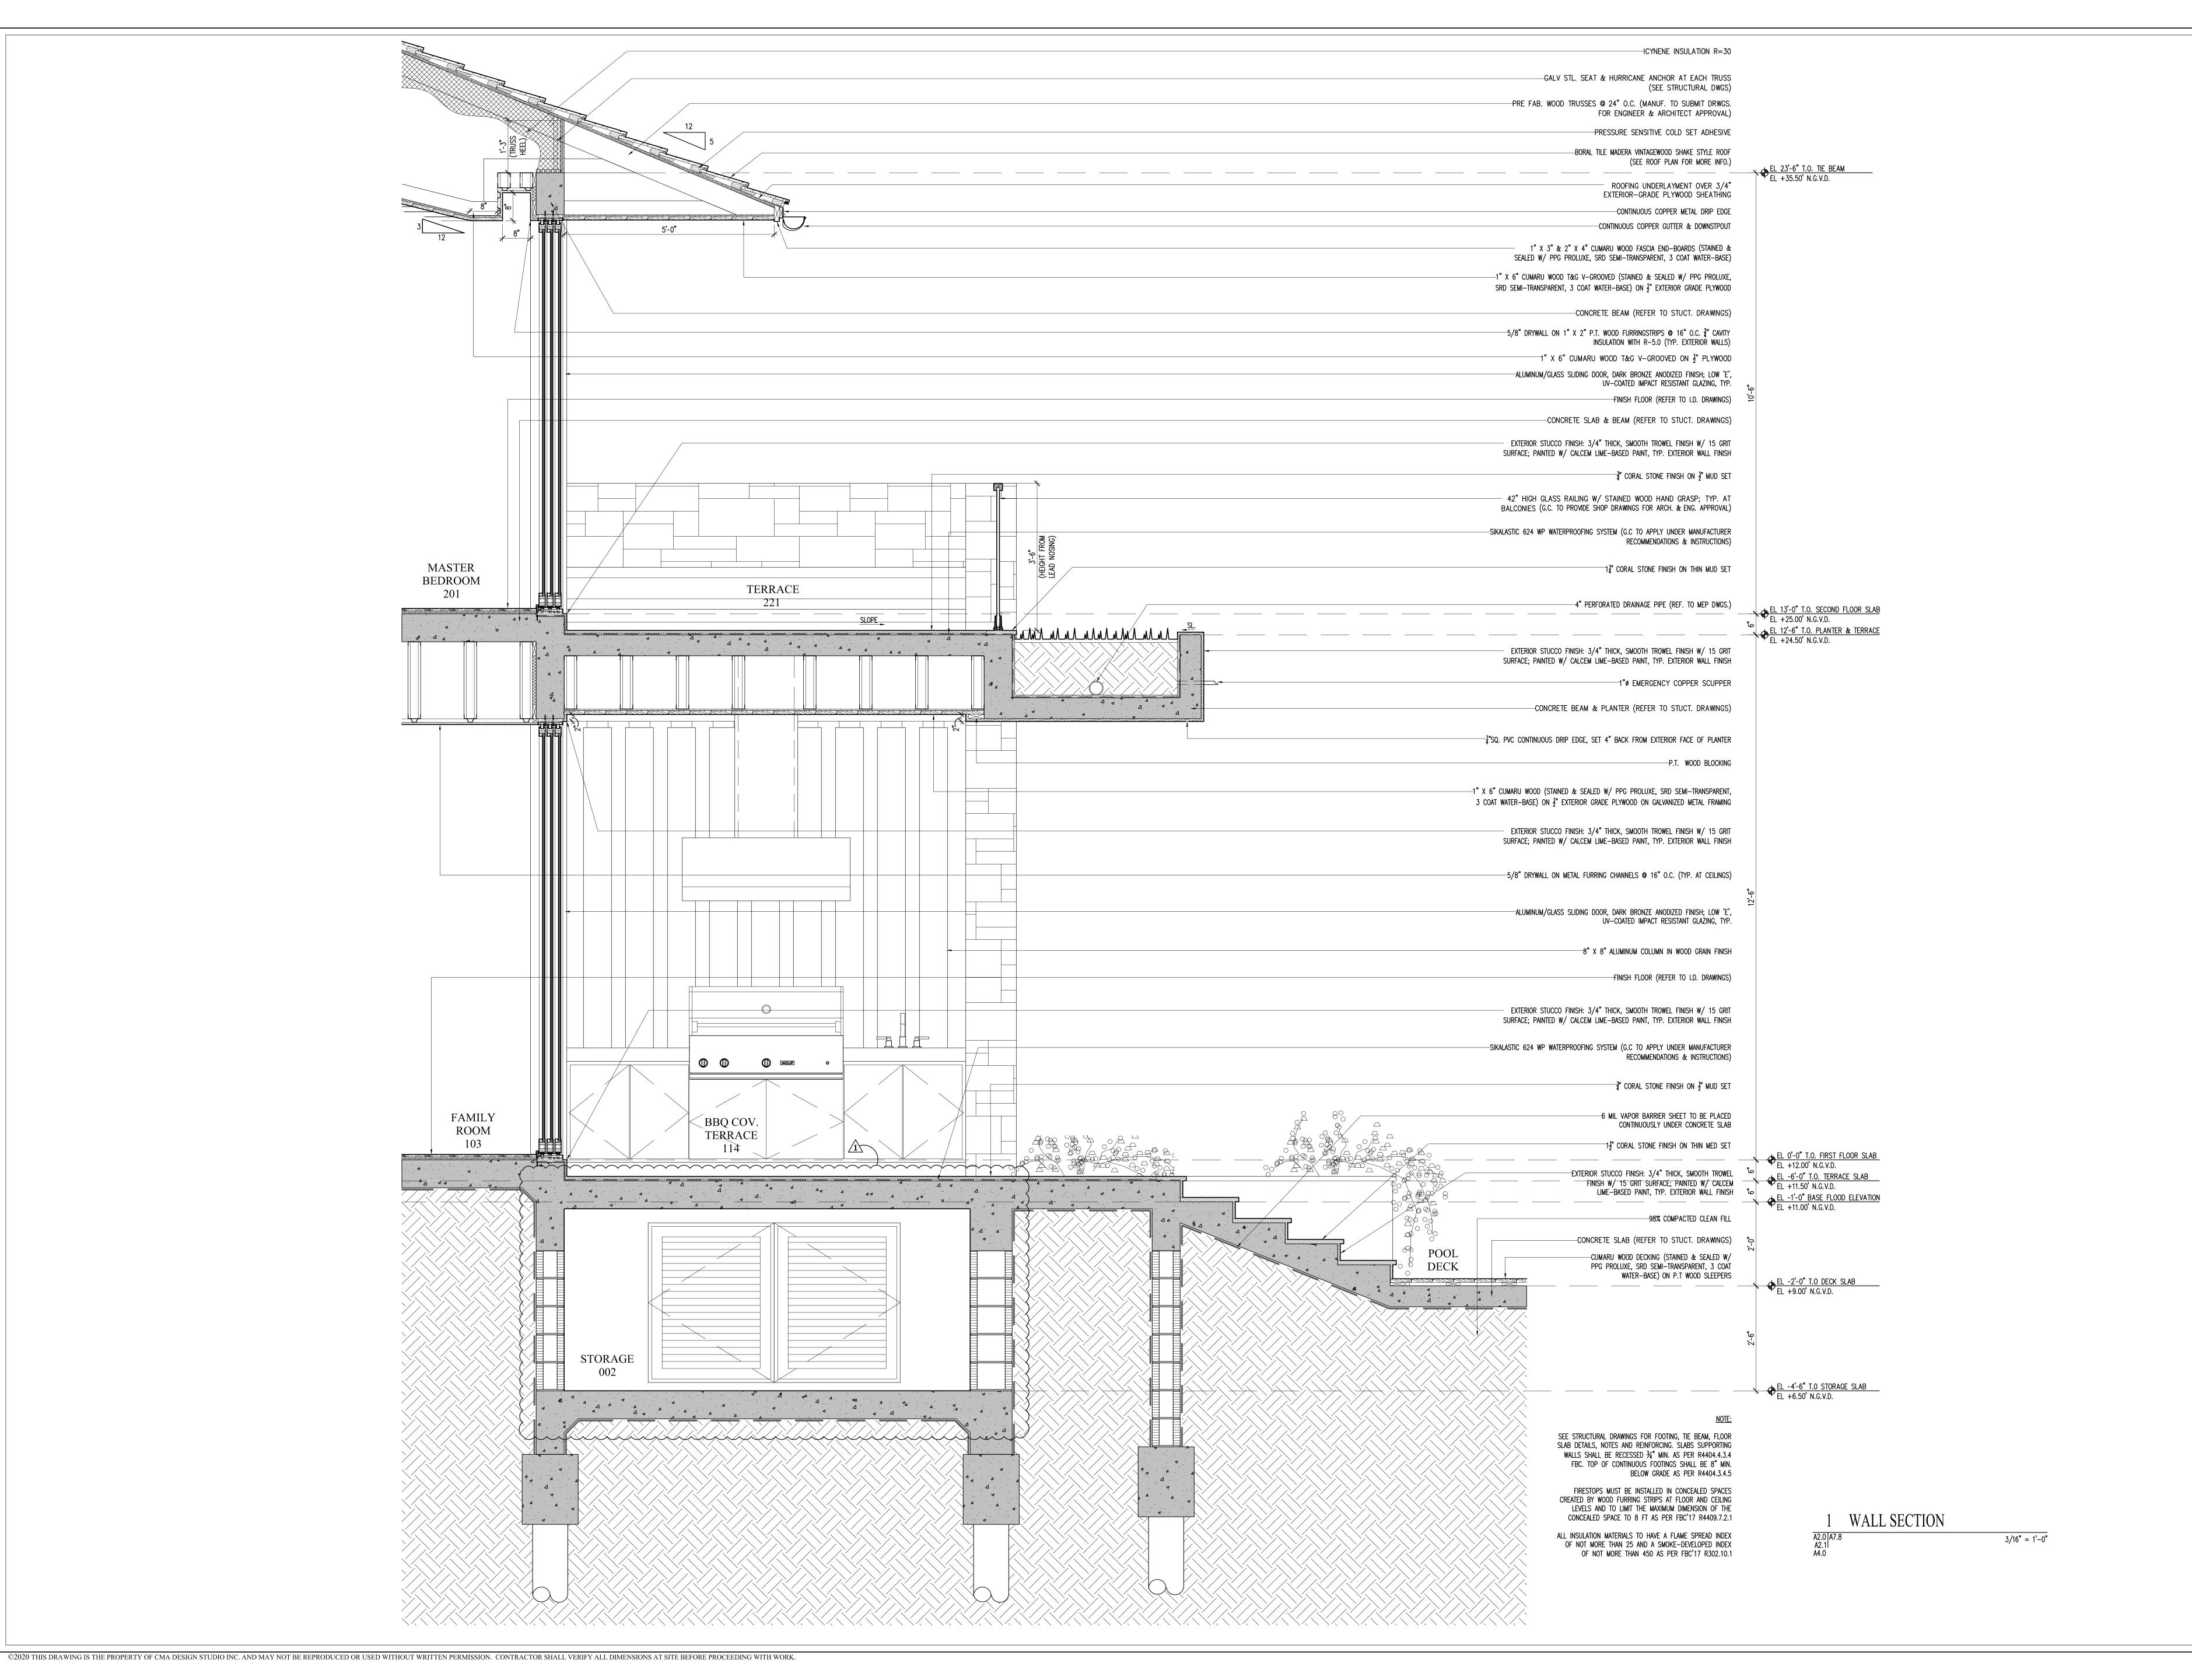

O, II TERIOR 1

SEAL Lynsie Christine Conn FL Architect AR99059 AA26000730

SHEET NO.: ~~~ 

				F	FIRST F	LOOR EXTER	IOR DOOR SCI	HEDU	LE		
DOOR	ROOM	ROOM		SIZE		MAT	ΓERIAL	DOOR	HARDWARE	HANDING	DEMARKS
NO.	NAME	NO.	WIDTH	HEIGHT	THICKNESS	DOOR	FRAME	TYPE	TYPE	(INSIDE ROOM)	REMARKS
101	LIVING	101	6'-0"	10'-6"	_	WOOD/GLASS	WOOD	1	_	LEFT	
102	DINING	102	16'-0"	10'-6"	2 1/4"	ALUMINUM & GLASS	ALUMINUM	2	-	SLIDER	4 PANEL SLIDER, 2 FIXED
103	GARAGE	115	3'-4"	8'-0"	2 1/4"	ALUMINUM & GLASS	ALUMINUM	3	-	LEFT	
104	GARAGE	115	18'-0"	10'-0"	2 1/4"	ALUMINUM & GLASS	ALUMINUM	4	-		ELECTRICAL ROLL UP DOOR
105	GARAGE	115	3'-0"	10'-0"	2 1/4"	ALUMINUM & GLASS	ALUMINUM	5	-	RIGHT	
106	FAMILY ROOM	103	12'-0"	10'-6"	2 1/4"	ALUMINUM & GLASS	ALUMINUM	6	-	SLIDER	3 PANEL SLIDER, 1 FIXED
107	FAMILY ROOM	103	16'-0"	10'-6"	2 1/4"	ALUMINUM & GLASS	ALUMINUM	2	-	SLIDER	4 PANEL SLIDER, 2 FIXED
108	DINING	102	32'-0"	10'-6"	2 1/4"	ALUMINUM & GLASS	ALUMINUM	7	-	SLIDER	8 PANEL SLIDER, 2 FIXED
109	STUDY	112	12'-0"	10'-6"	2 1/4"	ALUMINUM & GLASS	ALUMINUM	6	-	SLIDER	3 PANEL SLIDER, 1 FIXED
110	STUDY	112	12'-0"	10'-6"	2 1/4"	ALUMINUM & GLASS	ALUMINUM	6	-	SLIDER	3 PANEL SLIDER, 1 FIXED
111	STORAGE	001	3'-0"	4'-0"	2 1/4"	ALUMINUM	ALUMINUM	8	-	RIGHT	SOLID LOUVERED DOOR
112	STORAGE	002	6'-0"	4'-0"	2 1/4"	ALUMINUM	ALUMINUM	9	-	DOUBLE	SOLID LOUVERED DOOR

	SECOND FLOOR EXTERIOR DOOR SCHEDULE										
DOOR	ROOM	ROOM		SIZE		MA	TERIAL	DOOR	HARDWARE	HANDING	DEMARKS
NO.	NAME	ME NO. WIDTH HEIGHT THICK. DOOR		DOOR	FRAME	TYPE	TYPE	(INSIDE ROOM)	REMARKS		
201	CORRIDOR	215	16'-0"	9'-6"	2 1/4"	ALUMINUM & GLASS	ALUMINUM	10	-	SLIDER	4 PANEL SLIDING DOOR, 2 FIXED
202	CORRIDOR	215	3'-4"	9'-6"	2 1/4"	ALUMINUM & GLASS	ALUMINUM	11	_	LEFT	
203	MASTER BEDROOM	201	12'-0"	9'-6"	2 1/4"	ALUMINUM & GLASS	ALUMINUM	12	_	SLIDER	3 PANEL SLIDING DOOR, 1 FIXED
204	MASTER BEDROOM	201	16'-0"	9'-6"	2 1/4"	ALUMINUM & GLASS	ALUMINUM	10	_	SLIDER	4 PANEL SLIDING DOOR, 2 FIXED
205	BEDROOM NO.1	206	8'-0"	9'-6"	2 1/4"	ALUMINUM & GLASS	ALUMINUM	13	_	SLIDER	2 PANEL SLIDING DOOR, 1 FIXED
206	BEDROOM NO.2	208	8'-0"	9'-6"	2 1/4"	ALUMINUM & GLASS	ALUMINUM	13	_	SLIDER	2 PANEL SLIDING DOOR, 1 FIXED
207	BEDROOM NO.3	210	8'-0"	9'-6"	2 1/4"	ALUMINUM & GLASS	ALUMINUM	13	_	SLIDER	2 PANEL SLIDING DOOR, 1 FIXED
208	GUEST BEDROOM	216	11'-8"	9'-0"	2 1/4"	ALUMINUM & GLASS	ALUMINUM	14	-	SLIDER	3 PANEL SLIDING DOOR, 1 FIXED

			W	VINDOW SCH	EDULE		
TYPE	SI	ZE	GLASS TYPE	FRAME MAT'L	CODE	REMARKS	QUANTIT
	WIDTH	HEIGHT	02/100 111 2	110 MIL MITTE	NO.	TALIMI WATER	407111111
А	2'-0"	10'-6"	IMPACT RESISTANT	ALUMINUM		FIXED PANEL	3
В	8'-0"	10'-6"	IMPACT RESISTANT	ALUMINUM		2 FIXED PANELS	3
С	2'-9"	7'-6"	IMPACT RESISTANT	ALUMINUM		FIXED PANEL	2
D	4'-0"	10'-6"	IMPACT RESISTANT	ALUMINUM		FIXED PANEL	1
E	1'-4"	9'-6"	IMPACT RESISTANT	ALUMINUM		FIXED PANEL	6
F	8'-0"	9'-6"	IMPACT RESISTANT	ALUMINUM		2 FIXED PANELS	2
G	16'-0"	9'-6"	IMPACT RESISTANT	ALUMINUM		4 FIXED PANELS	1
Н	12'-0"	9'-6"	IMPACT RESISTANT	ALUMINUM		3 FIXED PANELS	1
1	3'-6"	9'-0"	IMPACT RESISTANT	ALUMINUM		FIXED PANEL	2
J	3'-0"	9'-0"	IMPACT RESISTANT	ALUMINUM		FIXED PANEL	2
	20'-0"	VARIES	IMPACT RESISTANT	ALUMINUM		5 FIXED PANELS, 3 MID PANELS @ 9'-0", 2 OUTSIDE PANELS @ 6'-0"	1
\ L	14'-8"	2'-0"	IMPACT RESISTANT	ALUMINUM		CLERESTORY 8'-6" ABOVE FIRST FLOOR SLAB, 3 FIXED PANELS	1
> M	3'-0"	6'-6"	IMPACT RESISTANT	ALUMINUM		FIXED PANEL, 3'-0" ABOVE SECOND FLOOR SLAB	2

# HARDWARE NOTES

1. CONTRACTOR IS TO PROVIDE ARCHITECT WITH A COMPLETE HARDWARE SCHEDULE LISTING ALL HARDWARE TO BE USED ON A DOOR BY DOOR BASIS, FOR APPROVAL.

2. ALL INTERIOR KNOBS, UNLESS OTHERWISE NOTED, WILL BE "H 5018 SERIE ATOS"

- BY FUSITAL (MFR).
  3. HANDLE SET TO BE USED AT DOOR NO.1 TO BE DETERMINED BY OWNER.
- 4. ALL HINGES TO BE STAINLESS STEEL, CONCEALED "SOSS" HINGE TYPE.
- 5. ALL INTERIOR DOOR JAMBS TO BE CONCEALED FLUSH TYPE "EZY JAMB" BY STUDCO BLDG. SYSTEMS OR APPROVED EQUAL.
- 6. DOORS 1 3/4" THICK, UP TO AND INCLUDING 36" WIDE TO HAVE PAIR AND A HALF HINGES. DOORS 1 3/4" THICK ABOVE 36" WIDE AND/OR TALLER THAN 7'-0" TO HAVE TWO PAIR HINGES.
- 7. ALL POCKET DOORS TO HAVE RECESSED TRACK IN HEADER. USE ACME HEAVY DUTY NO. 58, ANG. HANGER NO. 57.
- 8. ALL EXTERIOR DOORS OF BUILDING SHALL HAVE BOTTOM SEALS AND FRAME GASKETS.
- 9. KEYING:
  A. ALL KEYED LOCKS SHALL BE KEYED SEPARATELY AND INTO THE SAME MASTER
- KEY SYSTEM.

  B. FURNISH THREE (3) MASTER KEYS TO THE GENERAL CONTRACTOR TO BE TRANSFERRED TO THE OWNER.

  C. THE GENERAL CONTRACTOR SHALL BE RESPONSIBLE FOR ALL KEYS AND UPON COMPLETION OF HIS WORK AND
- D. FURNISH (2) KEYS FOR EACH LOCK WITH BLANK TAGS.

ACCEPTANCE BY THE OWNER, THE G.C. SHALL RETURN ALL KEYS TO THE

- 10. ALL EXTERIOR DOOR AND WINDOW MANUFACTURERS TO PROVIDE ARCHITECT/INTERIOR DESIGNER WITH SHOP DRAWINGS OF DOOR AND WINDOWS ALONG WITH DOOR AND
- DESIGNER WITH SHOP DRAWINGS OF DOOR AND WINDOWS ALONG WITH WINDOW HARDWARE FOR FINAL APPROVAL.

  11. PLEASE REFER TO DOORBELL LEGEND FOR DOORBELL STYLE.

### INTERIOR DOOR NOTES

LOCKED DOOR FROM THE OUTSIDE IN AN EMERGENCY.

- 1. EVERY CLOSET DOOR LATCH SHALL BE SUCH THAT CHILDREN CAN OPEN THE DOOR FROM
- THE INSIDE THE CLOSET.

  2. EVERY BATHROOM DOOR LOCK SHALL BE DESIGNED TO PERMIT THE OPENING OF THE
- 3. DOORS MAY BE SWINGING OR SLIDING AND ARE EXEMPT FROM THE REQUIREMENTS OF PARAGRAPH 3103.3 (C) OF THE SOUTH FLORIDA BUILDING CODE.
- 4. NO DOOR IN ANY MEANS OF ESCAPE SHALL BE LOCKED AGAINST EGRESS WHEN THE BUILDING IS OCCUPIED. ALL LOCKING DEVICES WHICH IMPEDE OR PROHIBIT EGRESS OR
- WHICH CANNOT BE EASILY DISENGAGED SHALL BE PROHIBITED.
   CONTRACTOR TO COORDINATE THAT ALL EXTERIOR DOOR EXTENSION JAMB HEIGHTS AND WINDOW HEADER JAMB HEIGHTS TO ALIGN HORIZONTALLY WITH INTERIOR DOOR HEADER
- 6. CONTRACTOR TO COORDINATE THAT TRANSOM GLAZING ALIGN WITH CLEAR GLAZING OF DOOR / WINDOW BELOW.

JAMBS. REFER TO INTERIOR DOOR TYPES FOR HEIGHTS - RESPECTIVE PER FLOOR.

- 7. CONTRACTOR TO COORDINATE THAT ALL EXTERIOR DOORS SWING FREE AND CLEAR OF ANY OVERHEAD OR FLOOR FINISH OBSTRUCTION.
- 8. IMPACT DOORS AND WINDOWS TO HAVE LOW "E" INSULATED UV-COATED GLAZING. GENERAL CONTRACTOR IS RESPONSIBLE TO COORDINATE WITH DOOR AND WINDOW MANUFACTURER U-FACTOR AND SOLAR HEAT GAIN COEFFICIENT AS SPECIFIED ON THE ENERGY CALCULATIONS PROVIDED BY THE MEP ENGINEER.

#### BURGLAR INTRUSION NOTES:

 ALL LOCKS ON EXTERIOR DOORS SHALL BE CAPABLE OF WITHSTANDING A FORCE OF 300 LBS. APPLIED IN ANY MOVABLE DIRECTION. MANUFACTURER

LA FINESTRA, L.C.

CGI WINDOWS & DOORS

PEETZ WINDOWS & DOORS

HARTMAN WINDOWS & DOORS

TISHLER WINDOWS & DOORS

GENERAL CONTRACTOR TO INFORM ARCHITECT IN WRITING IF A DIFFERENT

\* ALL GLASS IN WINDOWS TO HAVE A U FACTOR OF 0.8 AND A SOLAR

HEAT GAIN COEFFICIENT OF 0.27, DOORS TO HAVE A U VALUE OF 0.46

WINDOOR

MANUFACTURER IS PROPOSED.

1. ALUMINUM:

- 2. ALL SINGLE EXTERIOR SWING DOORS SHALL HAVE A KEY OPERATED FROM EXTERIOR WITH MIN. 6000 POSSIBLE KEY CHANGES / LOCKING COMBINATIONS. IF KEY KNOB IS USED, AN AUXILIARY DEAD BOLT WITH HARDENED BOLT OR INSERTS SHALL BE PROVIDED.
- 3. THE ACTIVE LEAF OF PAIRS OF EXTERIOR SWING DOORS SHALL HAVE SAME LOCKS AS REQUIRED FOR SINGLE EXTERIOR SWING DOORS.
- SAME LOCKS AS REQUIRED FOR SINGLE EXTERIOR SWING DOORS.

  THE INACTIVE LEAF OF THESE PAIRS OF DOORS SHALL HAVE
  MULTIPLE POINT LOCKS WITH Ç" MIN. THROW BOLTS WITH INSERTS.

  4. OVERHEAD DOORS SHALL BE PROVIDED WITH MULTIPLE POINT LOCKS
- OR BOLTS WITH INSERTS ENGAGING AT LEAST TWO OPPOSITE POINTS
  A MIN. OF Ç". OTHER LOCKING DEVICES SHALL NOT BE REQUIRED
  WHERE SUCH DOORS ARE CONTROLLED AND LOCKED BY ELECTRIC POWER.

  5. OVERHEAD DOORS SHALL BE PROVIDED WITH MULTIPLE POINT LOCKS
  OR BE LOCKED AT MORE THAN ONE POINT WITH HARDENED BOLTS
  OR BOLTS WITH INSERTS ENGAGING AT LEAST TWO OPPOSITE POINTS

OR BE LOCKED AT MORE THAN ONE POINT WITH HARDENED BOLTS

WHERE SUCH DOORS ARE CONTROLLED AND LOCKED BY ELECTRIC POWER.

6. HINGES ON EXTERIOR OUT SWINGING DOORS SHALL HAVE NON EXPOSED SCREWS AND NON-REMOVABLE PINS.

A MIN. OF Ç". OTHER LOCKING DEVICES SHALL NOT BE REQUIRED

- 7. ANSI Z97.1

  JAMBS OF ALL EXTERIOR OFFSET TYPE IN—SWINGING DOORS SHALL

  BE RABBETED OR OF SIMILAR FABRICATION TO PREVENT DEFEATING

  THE PURPOSE OF THE STRIKE AND THE INTEGRITY OF LOCKS AND LATCHES.
  8. SINGLE SWINGING EXTERIOR DOORS, IF WOOD, SHALL BE SOLID CORE OF
- 9. GLASS TO EXTERIOR DOORS SHALL COMPLY WITH THE AMERICAN NATIONAL STANDARDS INSTITUTES Z97.1.
- INSIDE LOCKING ACTIVATING DEVICE OF LOCKS AND SWINGING GLASS DOORS SHALL COMPLY WITH THE AMERICAN NATIONAL STANDARDS INSTITUTE,
- 11. VENTS IN OVERHEAD GARAGE TYPE DOORS SHALL NOT BE INSTALLED
- CLOSER THAN 40" TO THE INSIDE LOCK ACTIVATING DEVICE.

  12. SINGLE SWING EXTERIOR AND SWING DOORS CONNECTION LIVING AREAS WITH GARAGE AREAS SHALL BE SECURED WITH A LATCH AND A SINGLE

DEAD BOLT WITH ONE INCH MIN. THROWS OR A COMBINATION OF DEAD

BOLTS HAVING A 1" THROW. DOORS SHALL BE A MIN. 1a" THICK SOLID CORE.


LATCH AND DEAD BOLT SETS WITH LATCH THROW A MIN. OF 1" AND


## DOOR HAND CONVENTIONS


NOT LESS THAN 1" THICK.

- DOOR HAND CONVENTIONS ARE USED IN SPECIFYING DOOR HARDWARE SUCH AS LOCK SETS AND CLOSERS. THE TERMS RIGHT AND LEFT ASSUME A VIEW FROM THE EXTERIOR OF THE BUILDING OR ROOM TO WHICH THE DOORWAY LEADS (KEY SIDE).
- 2. DOOR HANDING ABBREVIATIONS:
  RH = RIGHT HAND, LF = LEFT HAND, RH(R) = RIGHT HAND 180 DEGREE
  HINGE, LH(R) = LEFT HAND 180 DEGREE HINGE
  RHR = RIGHT HAND REVERSE, LHR = LEFT HAND REVERSE, DBL = HINGE


# EXTERIOR DOORS

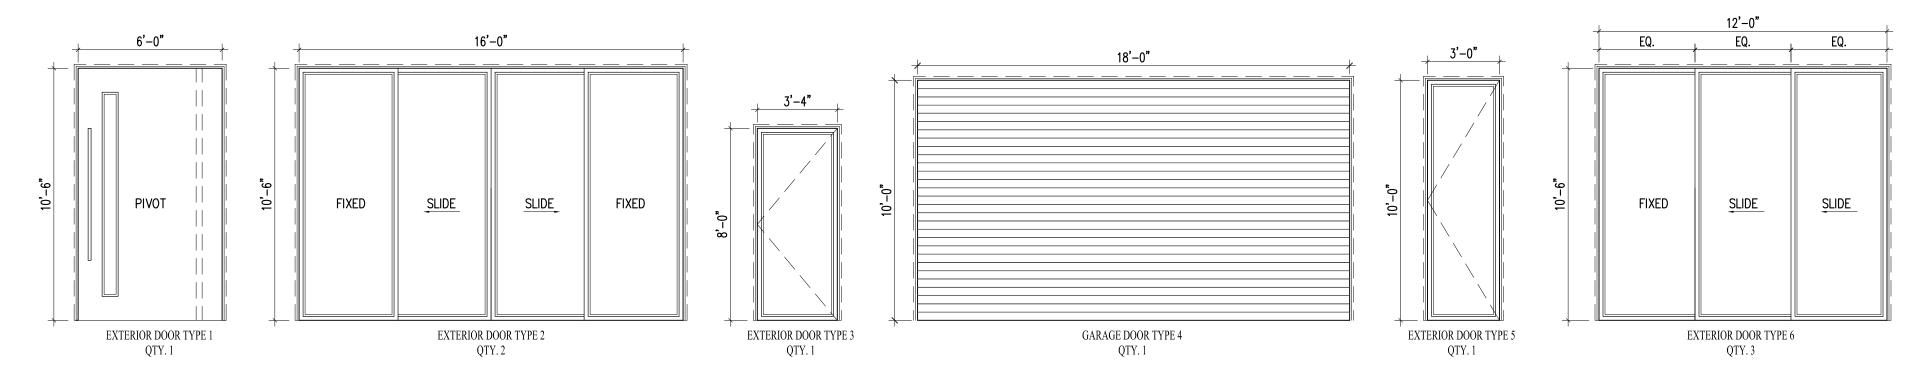


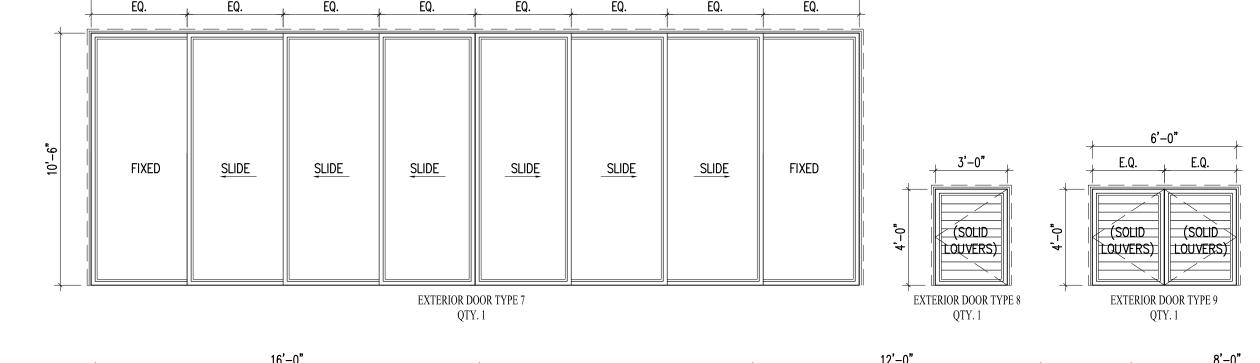


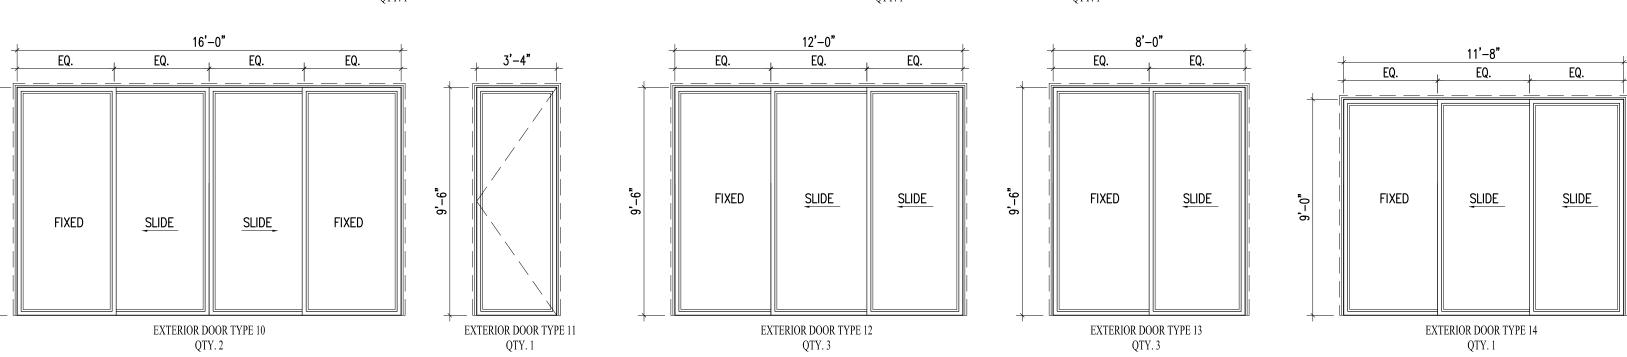

### EXTERIOR WINDOWS

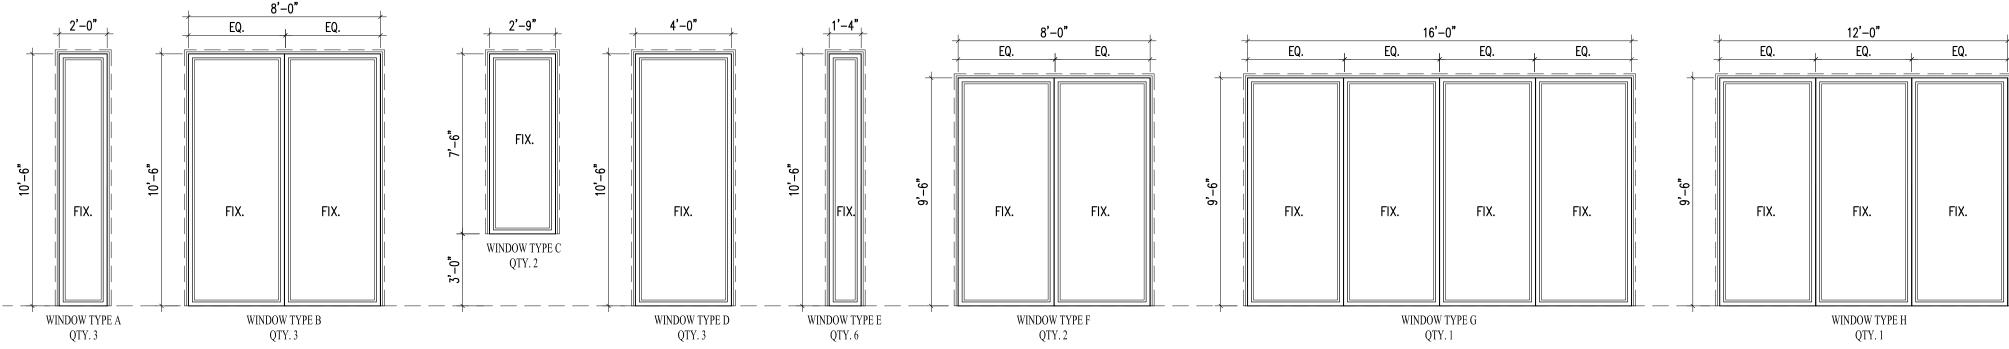

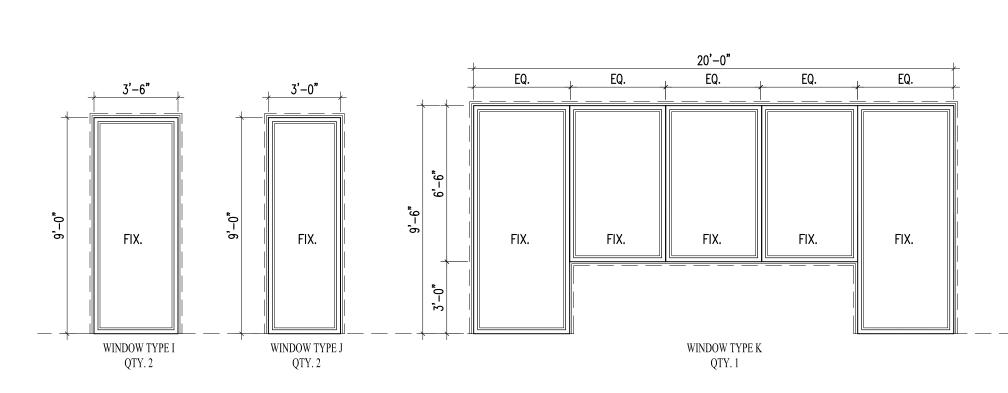

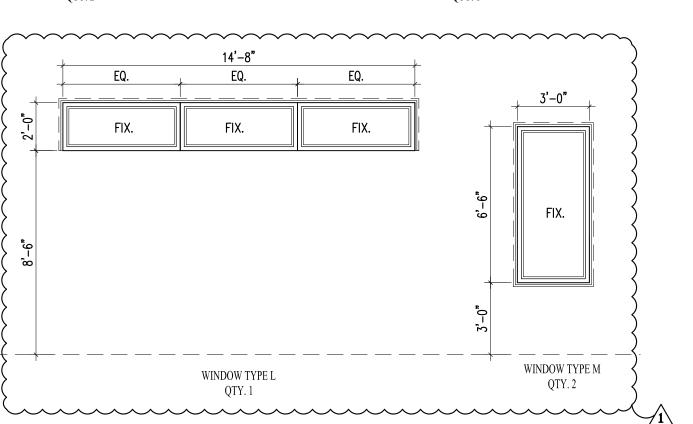

DENCE

ARCHITECTURE

ARCHITECT

SHANER RESIDEN
6935 Sunrise Court
Coral Gables, Florida 3313

Lynsie Christine Conn FL Architect AR99059 AA26000730

A10.0

SCOPE OF WORK

BE PERMITTED BY CITY OF CORAL GABLES:

 INSTALLATION OF TREE & PALM PLANTING INSTALLATION OF UNDERSTORY PLANTING

INSTALLATION OF AUTOMATIC IRRIGATION SYSTEM
INSTALLATION OF LANDSCAPE LOW VOLTAGE LIGHTING

 TREE REMOVAL & RELOCATION INSTALLATION OF HARDSCAPE

THE FOLLOWING DRAWINGS ILLUSTRATE THE PROPOSED SCOPE OF WORK FOR **6935 SUNRISE COURT** TO

LCVR COVER PAGE

GENERAL SITE NOTES

TREE DISPOSITION NOTES

TREE DISPOSITION PLAN & SCHEDULE

DEMOLITION NOTES & PLAN

BY OTHERS

**DRAWING NOTES** 

DEMOLITION NOTES & PLAN

L300 MATERIALS PLAN

L400 GRADING PLAN

L500 LAYOUT PLAN

L600 DETAILS

L700 PLANTING SCHEDULE & NOTES L701 TREE & PALM PLANTING PLAN L702 UNDERSTORY PLANTING PLAN

UNDERSTORY PLANTING PLAN

L703 SECOND LEVEL PLANTING PLAN

L704 PLANTING DETAILS

L800 IRRIGATION NOTES & SCHEDULE

IRRIGATION DETAILS

IRRIGATION PLAN

L802 IRRIGATION PLAN

L803 SECOND LEVEL IRRIGATION PLAN

L900 LIGHTING PLAN, SCHEDULE & NOTES

# **LOCATION MAP**



MR. & MRS. SHANER 6935 SUNRISE COURT CORAL GABLES, FL 33133

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**COVER PAGE** DATE ISSUE 11.25.2020 COORDINATION 12.17.2020 75% CD

02.01.2021 100% CD



#### SITEWORK GENERAL NOTES

- 1. THE GENERAL CONTRACTOR SHALL BE RESPONSIBLE FOR COORDINATING ALL WORK BY THE SUBCONTRACTORS.
- CONTRACTOR SHALL VERIFY ALL CONDITIONS AT JOB SITE AND NOTIFY LANDSCAPE ARCHITECT AND GENERAL CONTRACTOR OF DIMENSIONAL ERRORS, OMISSIONS OR DISCREPANCIES BEFORE BEGINNING ANY WORK.
- CONTRACTOR TO OBTAIN ALL NECESSARY PERMITS PRIOR TO CONSTRUCTION. ALL CONTRACTORS MUST COMPLY WITH PERMIT REQUIREMENTS, LOCAL, STATE AND FEDERAL JURISDICTIONS AND GOVERNING BODIES/AGENCIES RULES AND REGULATIONS AND LAND USE APPROVAL CONDITIONS AT ALL TIMES.
- WORK PERFORMED WITHOUT APPROVAL OF LOCAL, STATE AND FEDERAL JURISDICTIONS AND GOVERNING BODIES/AGENCIES AND/OR NOT IN COMPLIANCE WITH SPECIFICATIONS AND/OR DRAWINGS IS SUBJECT TO REMOVAL AT CONTRACTOR'S EXPENSE.
- ALL WORK SHALL CONFORM TO THE APPROPRIATE AGENCIES. CONTRACTOR SHALL VERIFY LOCATION OF ALL EXISTING UTILITIES, LINES AND STRUCTURES PRIOR TO EXCAVATION OR TRENCHING. DAMAGE SHALL BE REPAIRED BY THE CONTRACTOR AT NO COST TO THE OWNER. THE LANDSCAPE ARCHITECT ASSUMES NO RESPONSIBILITY FOR UTILITIES OR STRUCTURES NOT SHOWN ON THE DRAWINGS. CONTRACTOR IS TO VERIFY THE EXACT LOCATION OF UTILITIES PRIOR TO CONSTRUCTION AND NOTIFY THE LANDSCAPE ARCHITECT OF ANY DISCREPANCIES. CONTRACTOR SHALL USE EXTREME CAUTION WHEN WORKING OVER OR NEAR EXISTING GAS AND ELECTRICAL LINES.
- THE CONTRACTOR SHALL BE RESPONSIBLE FOR RESETTING ALL LAND MONUMENTS DISRUPTED BY CONSTRUCTION ACTIVITIES OR NEGLIGENCE ON THE PART OF THE CONTRACTOR. RESETS SHALL BE PERFORMED UNDER THE SUPERVISION OF A REGISTERED LAND SURVEYOR AND MONUMENT RECORDS MUST BE FILED AS REQUIRED BY STATUTE FOR ALL MONUMENTS.
- 7. THE CONTRACTOR SHALL TAKE ALL PRECAUTIONARY MEASURES NECESSARY TO PROTECT EXISTING IMPROVEMENTS FROM DAMAGE AND ALL SUCH IMPROVEMENTS AND STRUCTURES DAMAGED BY THE CONTRACTOR'S OPERATIONS SHALL BE REPAIRED OR RECONSTRUCTED SATISFACTORY TO THE LANDSCAPE ARCHITECT AT THE CONTRACTOR'S EXPENSE.
- ALL BARRICADING AND TEMPORARY TRAFFIC CONTROL DEVICES OR METHODS USED DURING CONSTRUCTION SHALL BE IN ACCORDANCE WITH LOCAL, STATE AND FEDERAL JURISDICTIONS AND GOVERNING BODIES/AGENCIES STANDARDS. PROVIDE ADEQUATE TIME FOR REVIEW AND APPROVAL BY THE ABOVE JURISDICTIONS PRIOR TO COMMENCEMENT.
- THE LANDSCAPE ARCHITECT IS NOT RESPONSIBLE FOR THE CONSTRUCTION MEANS, METHODS, TECHNIQUES, SEQUENCES UTILIZED OR FOR SAFETY PRECAUTIONS OR PROBLEMS IN CONNECTION WITH THE WORK. THE LANDSCAPE ARCHITECT WILL NOT BE RESPONSIBLE FOR THE CONTRACTOR'S FAILURE TO CARRY OUT THE WORK IN ACCORDANCE WITH THE CONTRACT DOCUMENTS. CONTRACT DOCUMENTS INCLUDE THE CONSTRUCTION DOCUMENT DRAWING SET/TECHNICAL SPECIFICATIONS MANUAL/LASIS.
- 10. CONTRACTOR TO VERIFY ALL QUANTITIES. IN CASE OF ANY DISCREPANCIES, GRAPHICALLY SHOWN MATERIAL QUANTITIES SHALL TAKE PRECEDENCE.
- 11. A SYSTEM OF DIAGRAMMATIC SYMBOLS, HATCHES AND NOTATIONS IS USED IN THESE DRAWINGS. REVIEW NOTATIONS CAREFULLY. NOTIFY LANDSCAPE ARCHITECT AND REQUEST CLARIFICATION OF ANY UNCLEAR NOTATION OR DISCREPANCY PRIOR TO COMMENCING WORK.
- 12. PROVIDE SLEEVES AS REQUIRED FOR DRAINAGE, IRRIGATION AND ELECTRICAL LINES. IRRIGATION AND ELECTRICAL SLEEVES AND SUBSURFACE DRAINAGE SYSTEMS SHALL BE CONSTRUCTED PRIOR TO PAVING AND LANDSCAPE WORK. UTILITY SLEEVES ARE REQUIRED IN ALL PLANT BEDS ISOLATED BY PAVEMENT OR ANY OTHER STRUCTURES.
- 13. SPECIAL CONSIDERATION IS GIVEN TO THE DESIGN AND INTENDED RELATIONSHIP BETWEEN ARCHITECTURE, PLANTING AREAS AND PAVING SYSTEMS. PAVEMENT JOINTING, PAVERS, STONE, FINISHES AND GRADES HAVE BEEN STRICTLY COORDINATED IN THE CONTRACT DOCUMENTS. CONSTRUCTION OF THESE SYSTEMS SHALL BE STRICTLY COORDINATED.

- 14. VEHICLES, EQUIPMENT, AND/OR MATERIALS SHALL NOT BE PARKED OR STORED IN AREAS OF EXISTING VEGETATION, INCLUDING WITHIN THE DRIPLINE OF EXISTING TREES TO REMAIN.
- 15. CONSTRUCTION WASTE-INCLUDING BUT NOT LIMITED TO: PLANT MATERIAL, BUILDING MATERIALS, DEMOLISHED MATERIALS, PACKAGING, LEFTOVER PAINT AND CONCRETE SLURRY-SHOULD BE PROPERLY REUSED, RECYCLED, DISPOSED OF LEGALLY OFF-SITE OR IN DESIGNATED WASH-OUT AREAS DETERMINED BY THE GENERAL CONTRACTOR.
- 16. RECYCLING AND TRASH BINS TO BE PROVIDED ON SITE. SEPARATE BINS FOR CARDBOARD, CO-MINGLED, AND OTHER RECYCLABLE/REUSABLE MATERIALS IDENTIFIED BY THE LOCAL JURISDICTION SHALL BE MAINTAINED. ALL BINS TO BE WILDLIFE-PROOF.
- 17. ON-SITE FUEL STORAGE FOR CONSTRUCTION EQUIPMENT IS DISCOURAGED. CONSTRUCTION EQUIPMENT USED ON SITE TO BE CHECKED REGULARLY TO ASSURE CONTAMINATION CONCERNS FROM OILS AND GREASES ARE ELIMINATED. NO TOXIC MATERIALS SHALL BE STORED ON-SITE.
- 18. GENERAL CONTRACTOR TO KEEP ALL ITEMS IMPLEMENTED BY LANDSCAPE ARCHITECT IN PROPER WORKING ORDER THROUGHOUT THE DURATION OF THE PROJECT.
- 19. THE CONSTRUCTION SITE TO BE INSPECTED ON A MONTHLY BASIS BY LANDSCAPE ARCHITECT AND/OR CIVIL ENGINEER TO ASSURE THAT THE SILT FENCE AND MUD TRACKING PAD ARE PROPERLY IN PLACE AND FUNCTIONING AS DESIGNED.
- GREEN BUILDING PRACTICES SHALL BE EMPLOYED TO THE EXTENT FEASIBLE. SUCH PRACTICES INCLUDE: CARPOOLING/VANPOOLING TO JOB SITE, MINIMIZING MATERIALS PACKING BEFORE ARRIVAL TO JOB SITE, REDUCING MATERIAL/RESOURCE INEFFICIENCIES BY COORDINATING WORK.
- 21. THE PROJECT LIMIT OF CONSTRUCTION AND ALL EXISTING VEGETATION TO REMAIN IS TO BE CLEARLY DEFINED BY STURDY, WEATHERPROOF FENCING AT A MINIMUM OF FOUR (4) FEET HIGH.
- 22. WATERPROOFING OF SUBGRADE AND OTHER ARCHITECTURAL SPACES BELOW AND/OR ADJACENT TO IMPROVEMENTS DESIGNED BY THE LANDSCAPE ARCHITECT IS TO BE ADEQUATELY DESIGNED AND DETAILED BY OTHERS TO PERMANENTLY REPEL ALL WATER SOURCES INCLUDING, BUT NOT LIMITED TO: PRECIPITATION, STORM WATER RUNOFF, GROUND WATER, IRRIGATION, ROOF RUNOFF, GROUND WATER, AND PLUMBING LEAKS.
- 23. STRUCTURAL DESIGN TO SUPPORT IMPROVEMENTS DESIGNED BY THE LANDSCAPE ARCHITECT AND LOCATED ABOVE, BELOW, AND/OR ADJACENT TO SUBGRADE AND OTHER ARCHITECTURAL SPACES IS THE RESPONSIBILITY OF THE STRUCTURAL ENGINEER. THE STRUCTURAL DESIGN SHOULD BE ADEQUATELY DESIGNED TO SUPPORT ALL POSSIBLE LOADS INCLUDING, BUT NOT LIMITED TO: BACKFILL, COMPACTION, PLANTINGS, HARDSCAPES, RETAINING AND FREESTANDING SITE WALLS. AND CONSTRUCTION MATERIALS/EQUIPMENT/ACTIVITY.

#### SOIL EROSION CONTROL NOTES

- 1. PRIOR TO BEGINNING ANY EARTH CHANGE, THE CONTRACTOR SHALL INSTALL AND MAINTAIN ALL SESC MEASURES AS SHOWN ON THE CONTRACT DOCUMENTS AND AS REQUIRED BY ANY GOVERNING AGENCIES.
- ALL SESC MEASURES TO BE MAINTAINED DAILY.
- 3. THE CONTRACTOR TO CONDUCT ALL EXCAVATION, FILLING, GRADING, AND CLEANUP OPERATIONS IN A MANNER SUCH THAT SEDIMENT, GENERATED BY WIND OR WATER IS NOT DISCHARGED INTO ANY STORM SEWER, DRAINAGE DITCH, RIVER, LAKE, AIR, OR UNDERGROUND UTILITY SYSTEM. STAGE WORK TO MINIMIZE THE AREA OF EXPOSED SOIL, THEREBY REDUCING THE OPPORTUNITY FOR SOIL EROSION.
- 4. WATER FROM TRENCHES AND OTHER EXCAVATION TO BE PUMPED INTO A FILTRATION BAG TO REMOVE SEDIMENTS FROM THE WATER.
- 5. NORTH AMERICAN GREEN SC-150 OR EQUIVALENT EROSION CONTROL FABRIC IS REQUIRED ON ALL DISTURBED SLOPES GREATER THAN 3:1 UNTIL PROJECT AREA IS REVEGETATED PER THE PLANTING PLAN.
- 6. PROVIDE POSITIVE DRAINAGE AWAY FROM ALL STRUCTURES.
- 7. CONTRACTOR TO PROVIDE ONSITE WATERING TO REDUCE FUGITIVE DUST LEAVING THE SITE DURING CONSTRUCTION.
- 8. SOIL EROSION CONTROL MEASURES TO BE PROVIDED FOR ALL EXISTING AND PROPOSED DRAINAGE STRUCTURES WITHIN THE PROJECT LIMITS.
- 9. CONSTRUCTION STAGING AND PHASING SHALL OCCUR, WHERE APPLICABLE, TO MINIMIZE SOIL DISTURBANCE TIME.
- 10. BEST MANAGEMENT PRACTICES (BMPs) SHALL BE ADJUSTED AS NEEDED TO MEET ANY OTHER UNFORESEEN CONDITIONS.
- 11. THE GENERAL CONTRACTOR IS RESPONSIBLE FOR INSTALLING A MUD TRACKING PAD/WASHING PAD AT THE CONSTRUCTION ENTRANCES TO MINIMIZE MUD DETACHMENT FROM TRUCK TIRES. 1-1/2 INCH SCREENED ROCK TO BE PLACED ON MIRAFI 140-N FILTER FABRIC. ADDITIONAL CLEAN GRAVEL TO BE ADDED THROUGHOUT THE DURATION OF CONSTRUCTION AS NEEDED.
- 12. CONTRACTOR SHALL ABIDE BY THE LOCAL. STATE AND FEDERAL JURISDICTIONS AND GOVERNING BODIES/AGENCIES CONSTRUCTION MANAGEMENT PLAN REQUIREMENTS.
- 13. RESEED AS INDICATED IN SEEDING NOTES.

#### **GRADING NOTES**

- VERIFY EXISTING ELEVATIONS PRIOR TO STARTING WORK. NOTIFY LANDSCAPE
- CONTRACTOR SHALL VERIFY THE PLACEMENT OF FLATWORK PENETRATIONS TO ENSURE COORDINATION OF SURFACE FIXTURES, SUCH AS DRAINS AND LIGHTS. NOTIFY GENERAL CONTRACTOR AND LANDSCAPE ARCHITECT OF DISCREPANCIES PRIOR TO
- THE CONTRACTOR SHALL REFER TO THE ARCHITECTURAL DRAWINGS TO VERIFY FINISHED FLOOR ELEVATIONS. THE GENERAL CONTRACTOR AND LANDSCAPE ARCHITECT SHALL BE NOTIFIED IF THERE ARE ANY DISCREPANCIES PRIOR TO
- THE CONTRACTOR SHALL REFER TO THE MECHANICAL DRAWINGS TO VERIFY DRAIN LOCATIONS OVER STRUCTURE. THE GENERAL CONTRACTOR AND LANDSCAPE
- THE CONTRACTOR SHALL REFER TO THE CIVIL ENGINEERING DRAWINGS TO VERIFY UTILITY AND OTHER DRAIN LOCATIONS. THE GENERAL CONTRACTOR AND LANDSCAPE
- TOPSOIL AND OTHER FINISHED CONDITIONS AS DESCRIBED IN THE CONTRACT
- 7. ALL FINISHED GRADES SHALL MEET AND BLEND SMOOTHLY WITH EXISTING GRADES AT
- ALL FINISHED GRADES SHALL BE WITHOUT LOW SPOTS OR POCKETS. CONTRACTOR SHALL SET FLOW LINES ACCURATELY AND PROVIDE A MINIMUM OF TWO (2) PERCENT OR MAXIMUM OF FIFTY (50) PERCENT, UNLESS OTHERWISE NOTED.
- 9. ALL FINISHED GRADES SHALL PRESENT SMOOTH TRANSITIONS BETWEEN TOES AND TOPS OF SLOPES.
- 10. THE MAXIMUM SLOPE OF SOD TO BE 3:1 IN AREAS DESIGNATED AS " LAWN," UNLESS OTHERWISE NOTED.
- 11. ALL MANHOLES, VALVE BOXES, UTILITY BOXES AND PEDESTALS, AND OTHER APPURTENANCES SHALL BE ADJUSTED TO FINISH GRADE IN ACCORDANCE WITH THE LOCAL, STATE AND FEDERAL JURISDICTIONS AND GOVERNING BODIES/AGENCIES OR UTILITY RULES AND REGULATIONS, UNLESS OTHERWISE NOTED.
- SHALL BE 95% PROCTOR DENSITY MINIMUM. UNLESS OTHERWISE SPECIFIED.
- 13. GRADING AND EXCAVATION WORK SHALL BE COMPLETED DURING DRY AND NON-FREEZING WEATHER CONDITIONS.
- 15. IF STRUCTURAL SOIL IS FOUND ON-SITE, THE CONTRACTOR SHALL REUSE.
- 16. THE CONTRACTOR SHALL PREVENT SOIL LOSS TO WIND AND WATER EROSION.
- 17. THE CONTRACTOR SHALL PROVIDE POSITIVE DRAINAGE AWAY FROM ALL STRUCTURES.
- 18. THE GENERAL CONTRACTOR SHALL INSTALL & MAINTAIN TEMPORARY DRAINAGE DEVICES DURING CONSTRUCTION.
- PROPOSED SPOT ELEVATIONS WITH LANDSCAPE ARCHITECT PRIOR TO FORMWORK INSTALLATION.
- 20. SPECIFICATIONS DELINEATED IN GEO-TECH REPORT TAKE PRECEDENCE OVER GRADING PLAN DRAWINGS. INFORM LANDSCAPE ARCHITECT OF DISCREPANCIES.



- ARCHITECT OF ANY DISCREPANCIES. EXISTING AND PROPOSED GRADES ARE BASED ON SURVEY DOCUMENTS PREPARED BY SURVEYOR.
- CONSTRUCTION OF FLATWORK.
- CONSTRUCTION.
- ARCHITECT SHALL BE NOTIFIED OF ANY DISCREPANCIES PRIOR TO CONSTRUCTION.
- ARCHITECT SHALL BE NOTIFIED OF ANY DISCREPANCIES PRIOR TO CONSTRUCTION.
- PROPOSED ELEVATIONS INDICATED ON DRAWINGS ARE FINISHED GRADE ELEVATIONS. THE CONTRACTOR SHALL DIRECT ROUGH GRADE WORK TO ALLOW FOR SUFFICIENT DOCUMENTS.
- THE PROJECT LIMIT.

- 12. SOIL COMPACTION BENEATH PAVEMENTS, STEPS, WALLS AND LIGHT FOUNDATIONS
- 14. THE CONTRACTOR SHALL REMOVE AND STOCKPILE TOPSOIL FOR REUSE ON-SITE. SOIL SHALL BE SCREENED TO REMOVE ROCKS AND BOULDERS.

- 19. THE CONTRACTOR SHALL VERIFY ALL CONTROL POINTS, FINISH FLOOR ELEVATIONS &



**SEAL (S TYLER NIELSEN - LA6667067)** 



DATE ISSUE COORDINATION 12.17.2020 75% CD 02.01.2021 100% CD

**SITE NOTES** 

#### CONTRACTOR QUALIFICATIONS

- CONTRACTOR MUST BE A LICENSED LANDSCAPE CONTRACTOR.
- 2. CONTRACTOR MUST HAVE A MINIMUM OF 10 YEARS OF PROVEN EXPERIENCE RELOCATING LARGE SPECIMEN TREES AND PALMS IN SOUTH FLORIDA.
- 3. CONTRACTOR MUST HAVE PROVEN EXPERIENCE RELOCATING TREES AND PALMS OF THE SAME SPECIES AND SIZE AS THOSE TO BE RELOCATED FOR THE CURRENT PROJECT.
- 4. CONTRACTOR MUST HAVE A CERTIFIED ARBORIST ON STAFF

#### CONTRACTOR REQUIREMENTS

- 1. CONTRACTOR MUST VISIT THE JOBSITE AND INSPECT ALL TREES AND PALMS TO BE RELOCATED AS WELL AS EXISTING SITE CONDITIONS AND RESTRICTIONS PRIOR TO PREPARING BID.
- CONTRACTOR MUST VERIFY AND ENSURE THAT ALL TREES AND PALMS IDENTIFIED ON THE PLANS AND THOSE TAGGED ON THE JOBSITE CORRESPOND AS TO NUMBER AND DESCRIPTION. ANY DISCREPANCIES MUST BE BROUGHT TO THE ATTENTION OF THE LANDSCAPE ARCHITECT IMMEDIATELY, PRIOR TO PREPARING BID.
- 3. CONTRACTOR MUST CONDUCT ALL WORK ASSOCIATED WITH RELOCATION AND MAINTENANCE OF TREES AND PALMS TO BE RELOCATED. NO WORK IS TO BE SUBCONTRACTED WITHOUT PRIOR WRITTEN CONSENT OF THE OWNER AND/OR LANDSCAPE ARCHITECT.
- 4. CONTRACTOR MUST DESIGNATE A COMPETENT, ENGLISH-SPEAKING SUPERVISOR OR FOREMAN OVERSEE AND DIRECT ALL RELOCATION AND MAINTENANCE ACTIVITIES AS OUTLINED IN THESE SPECIFICATIONS.
- 5. CONTRACTOR MUST SCHEDULE ROOT PRUNING TO PROVIDE THE MAXIMUM POSSIBLE TIME FOR NEW ROOT GROWTH. EVEN TREES AND PALMS THAT TYPICALLY DO NOT REQUIRE LONG (OR ANY) ROOT PRUNING WILL BENEFIT FROM MORE ROOT PRUNING TIME; THEREFORE, ALL TREES AND PALMS TO BE RELOCATED MUST BE ROOT PRUNED. CONTRACTOR MUST PROVIDE A ROOT PRUNE SCHEDULE FOR EACH TREE OR PALM TO BE RELOCATED AS AN ATTACHMENT TO THE BID.
- 6. CONTRACTOR MUST CALL SUNSHINE 811 TO HAVE ALL UNDERGROUND UTILITIES LOCATED UNDER OR IN THE VICINITY OF THE CURRENT OF FUTURE LOCATIONS OF ALL TREES AND PALMS TO BE RELOCATED PRIOR TO WORK COMMENCING.
- CONTRACTOR MUST VERIFY WITH THE GENERAL CONTRACTOR THE ABSENCE OF ANY UNDERGROUND CONSTRUCTION OR OBSTRUCTIONS (E.G., BULKHEADS, SEPTIC SYSTEMS, ETC.) IN THE CURRENT AND FUTURE LOCATIONS OF ALL TREES AND PALMS TO BE RELOCATED.
- 8. CONTRACTOR MUST ALERT THE LANDSCAPE ARCHITECT OF ANY TREES OR PALMS THAT WILL NOT SUCCESSFULLY RELOCATE DUE TO POOR HEALTH PRIOR TO BEGINNING ROOT PRUNING.
- 9. CONTRACTOR MUST FLAG ALL PROPOSED TRANSPLANT LOCATION FOR THE LANDSCAPE ARCHITECT'S APPROVAL A MINIMUM OF 15 DAYS PRIOR TO RELOCATION
- 10. CONTRACTOR MUST ENSURE THAT ALL TREES AND PALMS TO BE RELOCATED ARE INSTALLED AT THE CORRECT GRADE OR ELEVATION. ACCORDING TO THE GRADING PLAN.
- 11. CONTRACTOR MUST BE ENSURE THAT ALL ROOT FLARES ARE EXPOSED AFTER RELOCATION.
- 12. CONTRACTOR MUST REMOVE ALL RESIDUAL ROOTS, STUMPS, AND PORTIONS THEREOF AND BACKFILL PITS FROM WHICH RELOCATED TREES AND PALMS WERE REMOVED WITH CLEAN FILL FLUSH WITH THE SURROUNDING GRADE.
- 13. CONTRACTOR MUST BE REPAIR ANY DAMAGE TO OTHER PLANTS, LAWN, HARDSCAPES, OR NEW CONSTRUCTION WITHIN THE RELOCATION AREA AT CONTRACTOR'S EXPENSE. HARDSCAPES INCLUDE BUT ARE NOT LIMITED TO CURBS, WALKS, ROADS, FENCES, SITE FURNISHINGS, ETC.
- 14. CONTRACTOR MUST PHOTOGRAPHICALLY DOCUMENT NEW ROOT GROWTH FOLLOWING EACH ROOT PRUNE AND SUBMIT THIS DOCUMENTATION TO THE LANDSCAPE ARCHITECT. THE PURPOSE OF THIS REQUIREMENT IS TO ENSURE THAT SUFFICIENT ROOT GROWTH HAS OCCURRED PRIOR TO THE SECOND AND SUBSEQUENT ROOT PRUNES AND FOLLOWING THE FINAL ROOT PRUNE PRIOR TO RELOCATION.
- 15. CONTRACTOR MUST INSTALL AND MAINTAIN PROTECTION FENCING AROUND EACH TREE AND PALM TO BE RELOCATED BOTH DURING ROOT PRUNING AND AFTER RELOCATION. PROTECTION FENCING MUST CONSIST OF GALVANIZED WELDED WIRE FABRIC OR PLASTIC MESH ATTACHED TO 4" X 4" POSTS INSERTED AROUND THE PERIMETER OF THE DRIPLINE OF THE TREE OR PALM. PROTECTION FENCING MUST BE PLUMB, TAUT, AND STURDY AT ALL TIMES AND MUST REMAIN IN PLACE THROUGHOUT THE ROOT PRUNING AND WARRANTY PERIODS, OR AS DIRECTED BY THE LANDSCAPE ARCHITECT.
- 16. CONTRACTOR MUST OBTAIN ALL NECESSARY OR REQUIRED PERMITS FOR THE RELOCATION AND TRANSPORTATION OF THE TREES AND PALMS TO BE RELOCATED.
- 17. CONTRACTOR MUST REPLACE ANY TREES OR PALMS SCARRED OR DAMAGE DURING RELOCATION, AT THE CONTRACTOR'S EXPENSE, WITH THE SAME OR SIMILAR SPECIES. SIZE, AND QUALITY, REPLACEMENT TREES OR PALMS MUST BE APPROVED BY THE LANDSCAPE ARCHITECT PRIOR TO PROCUREMENT, PREPARATION, AND/OR INSTALLATION. REPLACEMENT TREES AND PALMS MUST BE INSTALLED WITHIN 60 DAYS OF NOTICE.
- 18. CONTRACTOR MUST GUARANTEE ALL RELOCATED TREES AND PALMS FOR ONE YEAR FROM THE DATE OF RELOCATION TO THE FINAL LOCATION. GUARANTEE MUST INCLUDE TREE HEALTH AND SETTLING.
- 19. CONTRACTOR MUST PROVIDE ALL MATERIAL NECESSARY TO PERFORM THE WORK COVERED HEREIN, INCLUDING BUT NOT LIMITED TO BACKFILL MATERIAL, PROTECTION FENCING, FLAGGING, ADDITIVES AND SUPPLEMENTS, TEMPORARY IRRIGATION, BURLAP, WIRE, SHRINK WRAP, AND ALL NECESSARY TOOLS AND EQUIPMENT.

#### TREE ROOT PRUNING SPECIFICATIONS

- EACH WATERING MUST THOROUGHLY SATURATE THE ROOTBALL TO ITS FULL DEPTH.
- RAIN, DURING THE ENTIRE ROOT PRUNING PROCESS EITHER BY A TEMPORARY IRRIGATION SYSTEM OR BY HAND. EACH WATERING MUST THOROUGHLY SATURATE THE ROOTBALL TO ITS FULL DEPTH.
- REPLANTING TAKE PLACE IN THE SAME 24-HOUR PERIOD. NO TREES OR PALMS MAY BE "STOCKPILED" ONSITE OR OFFSITE FOR ANY PERIOD OF TIME WITHOUT PRIOR WRITTEN APPROVAL OF THE LANDSCAPE ARCHITECT. WHEN ALLOWED, APPROVAL FOR THE METHOD OF "STOCKPILING" MUST BE OBTAINED FROM THE LANDSCAPE ARCHITECT
- ALL DIGGING IN THE ROOT ZONE DURING THE ROOT PRUNE PROCESS MUST BE DONE BY HAND: NO MACHINERY WILL BE ALLOWED. PRUNING OF ROOTS MUST BE DONE BY HAND WITH CLEAN, SHARP TOOLS. DO NOT PAINT CUT ROOTS WITH TREE PAINT OR ANY KIND OF SEALANT.
- MYCORRHIZA (ROOTS® TRANSPLANT OR EQUIVALENT) MUST BE INCORPORATED INTO THE BACKFILL SOIL PRIOR TO BACKFILLING AS PER MANUFACTURER'S RECOMMENDATIONS.
- WRAPPED WITH BLACK PLASTIC AND THE TRENCH BACKFILLED WITH ORIGINAL EXCAVATED SOIL. A TREE RING WITH A MINIMUM HEIGHT OF 6" MUST BE CONSTRUCTED 6-12" OUTSIDE THE OUTERMOST EDGE OF THE ROOTBALL AND AROUND THE ENTIRE PERIMETER OF THE ROOTBALL TO DIRECT IRRIGATION WATER AND ANY ADDED SUPPLEMENTS DOWN INTO THE ROOTBALL DURING ROOT REGENERATION.
- ONCE THE TREE RING IS CONSTRUCTED AFTER EACH ROOT PRUNE, A HIGH-PHOSPHORUS ROOT STIMULANT MUST BE LIBERALLY APPLIED TO THE SURFACE OF THE ROOTBALL AND THOROUGHLY WATERED IN TO ENCOURAGE NEW ROOT GROWTH.
- 8. PRIOR TO ANY ROOTS BEING CUT, ALL MAJOR ROOTS MUST BE IDENTIFIED TO DETERMINE THE ROOTBALL DIAMETER BASED ON THE RELATIVE LOCATION AND SIZE OF THE ROOTS.
- 9. MANY TREE RELOCATION SPECIFICATIONS USE "GENERAL RULES" TO CALCULATE MINIMUM ROOTBALL DIAMETER, SUCH AS MULTIPLYING THE DIAMETER AT BREAST HEIGHT (DBH) OF THE TREE BY A FACTOR OF 10 OR ALLOWING A MINIMUM OF 9"-12" OF ROOTBALL FOR EVERY 1" OF TREE CALIPER. OTHERS LIST UNREALISTIC MINIMUM SIZES FOR THE ROOTBALLS OF VARIOUS TREE CALIPERS OR OTHERS LIST UNREALISTIC MINIMUM SIZES FOR THE ROOTBALLS OF VARIOUS TREE CALIPERS OR HEIGHTS. IN MANY CASES, SUCH APPROACHES RESULT IN ROOTBALLS THAT ARE EITHER TOO LARGE OR TOO SMALL FOR A GIVEN TREE. THE FOLLOWING TABLE LIST MINIMUM ROOTBALL DIAMETERS BASED ON REAL-WORLD EXPERIENCE OF TREE RELOCATION SPECIALISTS IN SOUTH FLORIDA.

.CALIPER	MIN. ROOTBALL	CALIPER	MIN. ROOTBALL
(inches)	DIA. (feet)	(inches)	DIA. (feet)
1-4	3	12-14	8
4-5	4	15-17	10
6-7	5	18-24	12-15
8-9	6	25-30	15-25
10-11	7	30+	as needed

- WHENEVER POSSIBLE, ROOTBALLS MUST BE CIRCULAR IN SHAPE WITH AN EQUAL DISTANCE FROM THE TRUNK TO THE EDGE OF ROOTBALL ALL AROUND.
- MINIMUM ROOTBALL DEPTH MUST BE 24"-36" FOR ALL TREES TO BE RELOCATED, WITH ALL ROOTS DURING THE INITIAL ROOT INSPECTION AND BASED ON THE ABSENCE OF AND DEPTHS OF THE MAJOR ROOTS AS OBSERVED DURING THE INITIAL ROOT INSPECTION.
- AS A GENERAL RULE, MINIMUM ROOT PRUNE TIME FOR TREES WITH A DBH OF LESS THE ROOTBALL, WITH THE SECOND ROOT PRUNE ON ONE OF THE OTHER TWO SIDES DONE A MINIMUM OF 6 WEEKS LATER, AND A THIRD ROOT PRUNE ON THE LAST SIDE DONE A MINIMUM OF 3 WEEKS AFTER THAT. THE SECOND AND THIRD ROOT PRUNES MAY ONLY BE DONE WHEN HEALTHY NEW ROOT GROWTH FROM EARLIER ROOT PRUNES IS EVIDENT (SEE SECTION 2.14 ABOVE FOR SPECIFICATIONS ON PHOTOGRAPHICALLY DOCUMENTING NEW ROOT GROWTH DURING THE ROOT PRUNE PROCESS). MORE TIME MAY BE NEEDED DURING THE COOLER MONTHS OF THE YEAR.
- MAY ONLY BE DONE WHEN HEALTHY NEW ROOT GROWTH FROM EARLIER ROOT PRUNES IS EVIDENT (SEE SECTION 2.14 ABOVE FOR SPECIFICATIONS ON

  - BRIDALVEIL (CAESALPINIA GRANADILLO)
  - CASSIAS (ALL SPECIES OF CASSIA)
- PODOCARPUS (PODOCARPUS SP.)
- LIVE OAK (QUERCUS VIRGINIANA)
- MAGO (MANGIFERA INDICA)
- SWEET ACACIA (ACACIA FARNESIANA) VERAWOOD (BULNESIA ARBOREA)

- 1. ALL TREES AND PALMS TO BE RELOCATED MUST BE WATERED DAILY FOR AT LEAST 2-3 DAYS PRIOR TO ANY ROOTS BEING CUT TO ENSURE THAT THEY ARE FULLY HYDRATED.
- 2. EACH TREE AND PALMS MUST THEN BE WATERED EVERY OTHER DAY, NOT RELYING ON
- 3. TREE AND PALM RELOCATION ACTIVITIES MUST BE SCHEDULED SO THAT REMOVAL AND

- 6. AFTER EACH ROOT PRUNE, EACH SECTION OF ROOTBALL THAT IS PRUNED MUST BE

CALIPER	MIN. ROOTBALL	CALIPER	MIN. ROOTBALL
(inches)	DIA. (feet)	(inches)	DIA. (feet)
1-4	3	12-14	8
4-5	4	15-17	10
6-7	5	18-24	12-15
8-9	6	25-30	15-25
10-11	7	30+	as needed

- THE ACTUAL DEPTH TO BE DETERMINED ONLY AFTER A THOROUGH EXAMINATION OF MAJOR ROOTS AT THE BOTTOM OF THE ROOTBALL. ROOTBALLS DEEPER THAN 36" MAY BE REQUIRED FOR LARGE SPECIMEN TREES. DEPENDING ON THE RELATIVE LOCATIONS
- THAN 10" IS 12 WEEKS. THE FIRST ROOT PRUNE MUST BE ON TWO OPPOSING SIDES OF
- AS A GENERAL RULE, MINIMUM ROOT PRUNE TIME FOR TREES WITH A DBH OF 10" OR GREATER IS 24 WEEKS, THE FIRST ROOT PRUNE MUST BE ON TWO OPPOSING SIDES OF THE ROOTBALL, WITH THE SECOND ROOT PRUNE ON ONE OF THE OTHER TWO SIDES DONE A MINIMUM OF 12 WEEKS LATER, AND A THIRD ROOT PRUNE ON THE LAST SIDE DONE A MINIMUM OF 6 WEEKS AFTER THAT. THE SECOND AND THIRD ROOT PRUNES PHOTOGRAPHICALLY DOCUMENTING NEW ROOT GROWTH DURING THE ROOT PRUNE PROCESS). MORE TIME MAY BE NEEDED DURING THE COOLER MONTHS OF THE YEAR.
- CERTAIN HARDWOOD TREES AND GYMNOSPERMS REQUIRE LONGER ROOT PRUNING TIMES. THESE INCLUDE, BUT ARE NOT LIMITED TO, THE FOLLOWING:
- AVOCADO (PERSEA AMERICANA)
- BLACK OLIVE (BUCIDA BUCERAS)
- LIGNUM VITAE (GUA/ACUM SANCTUM & G. OFFICINALE)
- MAHOGANY (SWIETENIA MAHAGONI)
- PIGEON PLUM (COCCOLOBA DIVERSIFOLIA)
- WILD TAMARIND (LYSILOMA LATISILIQUUM & L. SABICU)

#### PALM ROOT PRUNING SPECIFICATIONS

THE FOLLOWING TABLE LISTS MINIMUM ROOTBALL DIAMETERS FOR VARIOUS SPECIES OF PALMS BASED ON REAL-WORLD EXPERIENCE OF RELOCATION SPECIALISTS IN

> ROOTBALL SPECIFICATIONS SABAL/CABBAGE PALM 36" diameter QUEEN & FOXTAIL PALMS 12"from trunk in all directions **ROYAL & COCONUT PALMS** 18-24" from trunk in all directions CANARY DATE PALM 24" from trunk in all directions SLOW-GROWING PALMS 24" from trunk in all directions

- PALM ROOTBALL MUST BE A MINIMUM OF 24" DEEP, WHENEVER POSSIBLE, ROOTBALLS MUST BE CIRCULAR IN SHAPE WITH AN EQUAL DISTANCE FROM THE TRUNK TO THE EDGE OF THE ROOTBALL ALL AROUND.
- 3. AS A GENERAL RULE, MINIMUM ROOT PRUNE TIME FOR PALMS IS 6-8 WEEKS. THE FIRST ROOT PRUNE MUST BE ON TWO OPPOSING SIDES OF THE ROOTBALL, WITH THE SECOND ROOT PRUNE ON ONE OF THE OTHER TWO SIDES DONE A MINIMUN OF 3-4 WEEKS LATER, AND A THIRD ROOT PRUNE ON THE LAST SIDE DONE A MINIMUM OF 4.5-6 WEEKS AFTER THAT. THE SECOND AND THIRD ROOT PRUNES MAY ONLY BE DONE WHEN HEALTHY NEW ROOT GROWTH FROM EARLIER ROOT PRUNES IS EVIDENT (SEE SECTION 2.14 ABOVE FOR SPECIFICATIONS ON PHOTOGRAPHICALLY DOCUMENTING NEW ROOT GROWTH DURING THE ROOT PRUNE PROCESS). MORE TIME MAY BE NEEDED DURING THE COOLER MONTHS OF THE YEAR.
- 4. CERTAIN PALMS. IN PARTICULAR THOSE THAT ARE SLOW GROWING. REQUIRE LONGER ROOT PRUNING TIME. THESE INCLUDE, BUT ARE NOT LIMITED TO, THE FOLLOWING.
  - ALL SPECIES OF ARCHONTOPHOENIX
  - ALL SPECIES OF CORYPHA
  - AMERICAN OIL PALMS (ALL SPECIES OF ATTALEA)
  - BISMARCK PALM (BISMARCKIA NOBILIS) CUBAN & CARIBBEAN COPERNICIA
  - CUBAN BELLY PALM (GASTROCOCOS CRISPA)
- GINGERBREAD/DOUM PALMS (ALL SPECIES OF HYPHAENE)
- PALMYRA PALMS (ALL SPECIES OF BORASSUS) SATAKE PALM (SATAKENTIA LIUKIUENSIS)
- SAW PALMETTO (SERENOA REPENS)
- SILVER PALM (COCCOTHRINAX ARGENTATA)

PRUNE PROCESS).

ZOMBIE PALM (ZOMBIA ANTILLARUM)

FOR THESE PALMS, THE MINIMUM ROOT PRUNING TIME IS 4-6 MONTHS OR GREATER. ONLY WHEN SUFFICIENT NEW ROOT GROWTH HAS TAKEN PLACE FOLLOWING AN EARLIER ROOT PRUNE CAN THE NEXT ROOT PRUNE BE DONE, AND ONLY WHEN SUFFICIENT NEW ROOT GROWTH HAS TAKEN PLACE FOLLOWING THE FINAL ROOT PRUNE MAY THE TREE BE RELOCATED (SEE SECTION 2.14 ABOVE FOR SPECIFICATIONS ON PHOTOGRAPHICALLY DOCUMENTING NEW ROOT GROWTH DURING THE ROOT

#### TREE CANOPY PRUNING SPECIFICATIONS

- PRIOR TO RELOCATION, THE CANOPY OF EACH TREE TO BE RELOCATED MUST BE SELECTIVELY PRUNED TO REMOVE CROSSING DEAD, DISEASED, BROKEN, AND LOW HANGING BRANCHES THAT MAY INTERFERE WITH CONSTRUCTION ACTIVITIES, OR THAT MAY INTERFERE OR RESTRICT STRAPPING OR LIFTING THE TREE DURING RELOCATION.
- 2. FOR TREES BEING RELOCATED ONSITE, THE CANOPY MAY BE SELECTIVELY THINNED AND REDUCED BY NO MORE THAN 1/3 OF THE OVERALL CANOPY MASS, AT THE DIRECTION OF THE LANDSCAPE ARCHITECT; HOWEVER, THE BASIC SHAPE, FORM, AND CHARACTER OF THE TREES MUST BE PRESERVED.
- 3. FOR TREES BEING RELOCATED OFFSITE, THE CANOPY MUST BE PRUNED, AT THE DIRECTIONS OF THE LANDSCAPE ARCHITECT, TO FIT ON THE TRAILER FOR TRANSPORT EVERY EFFORT MUST BE MADE TO RETAIN AS MANY BRANCHES AS POSSIBLE. TO THE WIDEST LOAD WIDTH ALLOWABLE BY THE FLORIDA DEPARTMENT OF TRANSPORTATION. CONTRACTOR MUST OBTAIN ALL NECESSARY PERMITS AND ESCORTS TO TRANSPORT WIDE LOADS, PER FLORIDA LAW.
- 4. ALL CANOPY PRUNING MUST BE CONDUCTED FOLLOWING ANSI A-300 TREE PRUNING STANDARDS AND BEST MANAGEMENT PRACTICES.
- 5. ALL DEBRIS GENERATED DURING CANOPY PRUNING MUST BE REMOVED OFFSITE AND DISPOSED.

## PALM CANOPY PRUNING SPECIFICATIONS

- 1. IT IS WELL KNOW THAT SOME PALMS SURVIVE RELOCATION BETTER WHEN ALL OF THE LEAVES ARE REMOVED (E.G., CABBAGE PALM, SABAL PALMETTO), AND THAT OTHER PALMS BENEFIT FROM HAVING THEIR LEAVES CUT IN HALF DURING RELOCATION (E.G., COCONUT PALM, COCOS NUCIFERA). BOTH OF THESE HORTICULTURAL PRACTICES, WHILE TRUE, ARE ONLY APPLICABLE WHEN PALMS ARE NOT ROOT PRUNED. LEAVES DO NOT NEED TO BE CUT IN HALF OR REMOVED FROM PALMS THAT ARE ADEQUATELY ROOT PRUNED. ON OCCASION WHEN SUFFICIENT ROOT PRUNING TIME IS NOT AVAILABLE. PALMS TO BE RELOCATED MAY HAVE THEIR LEAVES CUT IN HALF OR REMOVED ENTIRELY AT THE DIRECTION OF THE LANDSCAPE ARCHITECT.
- 2. PALMS LEAVES MUST BE TIED UP WITH 2-PLY BIODEGRADABLE TWINE PRIOR TO RELOCATION TO PREVENT MECHANICAL DAMAGE DURING THE RELOCATION PROCESS.
- 3. PALM TRUNKS SHALL ONLY BE 'CLEANED UP' ACCORDING TO THE LANDSCAPE ARCHITECT'S SPECIFICATIONS SPECIFIC TO EACH PALM.

#### RELOCATION SPECIFICATIONS

- LANDSCAPE CONTRACTOR TO FLAG ALL PROPOSED PLANT LOCATIONS FOR LANDSCAPE ARCHITECT'S APPROVAL PRIOR TO INSTALLATION. NOTIFY LANDSCAPE ARCHITECT A MINIMUM OF 15 DAYS PRIOR TO REVIEW.
- ALL TREES AND PALMS TO BE RELOCATED MUST BE WATERED DAILY FOR AT LEAST 5 DAYS PRIOR TO ANY RELOCATION TO ENSURE THAT THEY ARE FULLY HYDRATED. EACH WATERING MUST THOROUGHLY SATURATE THE ROOTBALL TO ITS FULL DEPTH
- ALL ROOTBALLS MUST BE WRAPPED IN BURLAP AND THE TIGHTLY WIRE-WRAPPED (USING REDLINE HORSE WIRE OR EQUIVALENT) TO KEEP THE ENTIRE ROOTBALL INTACT DURING RELOCATION. TREES AND PALMS GROWING IN LIMESTONE MUST BE DUG AND RELOCATED WITH THE ROOT ATTACHED TO A SECTION OF ROCK AS PART OF THE ROOTBALL SUCH THAT THE ROOTS REMAIN INTACT, ROOTBALLS COMING FROM SAND OR SANDY SOIL MAY ALSO NEED TO BE BOXED PRIOR TO RELOCATION, AT THE DISCRETION OF THE LANDSCAPE ARCHITECT.
- TREES AND PALMS BEING RELOCATED OFFSITE MUST HAVE THEIR ENTIRE ROOTBALLS THOROUGHLY AND TIGHTLY WRAPPED WITH PLASTIC SHRINK WRAP ON THE OUTSIDE OF THE WIRE WRAP. AND THE ENTIRE TREE OR PALM (INCLUDING CANOPY, TRUNK, AND ROOTBALL) MUST BE COVERED WITH A BREATHABLE TARP (E.G., SHADE CLOTH) DURING TRANSPORT.
- NEW PLANTING PITS FOR RELOCATED TREES AND PALMS MUST BE PREPARED PRIOR TO LIFTING THE PALM OR TREE FROM ITS CURRENT LOCATION AND MUST BE AT LEAST 3-4 FEET WIDER THAN THE ROOTBALL AND THE SAME DEPTH AS THE ROOTBALL, SUCH THAT THE FINAL ELEVATION OF THE TOP OF THE ROOTBALL IS AT OR SLIGHTLY ABOVE (NO MORE THAN 2" HIGHERO FINAL GRADE.
- TREES AND PALMS TO BE RELOCATED MUST BE LIFTED BY THE ROOTBALL ONLY, USING APPROPRIATELY SIZED (LENGTH AND STRENGTH) LIFTING STRAPS OR CHAINS. DURING LIFTING, THE TREE OR PALM MUST BE BALANCED IN A MORE-OR-LESS UPRIGHT POSITION, WITH THE STRAP THE TRUNK USED ONLY FOR BALANCING AND MANEUVERING THE TREE OR PALM INTO A POSITION. NO CHAINS MAY BE USED AROUND OR AGAINST THE TRUNK AT ANY TIME. AT NO TIME SHALL 100% OF THE WEIGHT OF THE TREE OR PALM BE ON THE STRAP ATTACHED TO THE TRUNK. TRUNKS MUST BE HEAVILY PADDED WITH 30-60 LAYERS (DEPENDING ON SIZE AND WEIGHT) OF BURLAP BENEATH THE BALANCING STRAP.
- TREES AND PALMS MUST BE LIFTED WITH A CRANE OR BACKHOE APPROPRIATELY SIZED FOR THE SIZE AND WEIGHT OF THE TREE OR PALM AND LIFTED OR CARRIED DIRECTLY TO THE FINAL INSTALL LOCATION OR TRANSPORT TRAILER.
- ONCE LIFTING BEINGS, ANY UNCUT ROOTS UNDER OR AROUND THE ROOTBALL THAT MAY YET REMAIN MUST BE IMMEDIATELY SEVERED WITH HAND PRUNING TOOLS TO MINIMIZE TEARING AND ROOT DAMAGE.
- AGRIFORM PLANTING TABLETS (OR APPROVED EQUIVALENT) MUST BE EVENLY DISTRIBUTED AROUND THE PERIMETER OF THE PLANTING PIT AT THE RATE OF 2 TABLETS PER 1" TRUNK CALIPER PRIOR TO BACKFILLING.
- THE BACKFILL SOIL PRIOR TO BACKFILLING. RELOCATED TREES AND PALMS MUST BE CENTERED IN THE PLANTING PIT, AND THE PIT

MIX THOROUGHLY BLENDED TOGETHER. DO NOT USE MUDDY SOIL AS BACKFILL.

10. MYCORRHIZA (ROOTS® TRANSPLANT OR EQUIVALENT) MUST BE INCORPORATED INTO

BACKFILLED USING A 1:1 MIXTURE OF EXISTING SOIL AND 80:20 (DOT SAND:MUCK) SOIL

- 12. SMALL TREES AND PALMS MUST BE FIRMLY BRACED USING A MINIMUM OF FOUR 4"X 4" WOODEN BRACES ATTACHED TO 2" X 4" WOODEN BATTENS HELD IN PLACE WITH TWO STEEL BANDS. LARGER TREES MAY REQUIRE 6"X 6" WOODEN POSTS OR EVEN TELEPHONE POLES TO PROVIDE SUFFICIENT BRACING STRENGTH TO PREVENT TOPPLING DURING WIND EVENTS. A SUFFICIENT NUMBER OF BATTENS MUST BE STRATEGICALLY PLACED AROUND THE TRUNK SUCH THAT THE STEEL BANDS NEVER CONTACT THE TRUNK. NO BURLAP IS TO REMAIN UNDER THE WOODEN BATTENS ON TREES DURING BRACING, BUT SEVERAL LAYERS OF BURLAP SHOULD BE LEFT UNDER THE WOODEN BATTENS WHEN BRACING PALMS. NAILS SHALL NEVER BE DRIVEN DIRECTLY INTO THE TRUNK DURING BRACING. BRACING MUST REMAIN IN PLACE FOR A
- 13. A TREE RING WITH A MINIMUM HEIGHT OF 6" MUST BE CONSTRUCTED 6-12" OUTSIDE THE OUTERMOST EDGE OF THE ROOTBALL AND AROUND THE ENTIRE PERIMETER OF THE ROOTBALL TO DIRECT IRRIGATION WATER AND ANY SUPPLEMENTS THAT ARE ADDED DOWN INTO THE ROOTBALL DURING ROOT REGENERATION.


MINIMUM OF ONE YEAR.

- 14. ONCE THE TREE RING IS CONSTRUCTED, A HIGH-PHOSPHORUS ROOT STIMULANT MUST BE LIBERALLY APPLIED TO THE SURFACE AND THOROUGHLY WATERED IN.
- 15. ROOTBALLS MUST BE A THOROUGHLY WATERED IN USING A HOSE AND JOHNSON BAR INSERTED TO THE VERY BOTTOM OF THE ROOTBALL AND SWUNG BACK AND FORTH TO PREVENT FORMATION OF AIR POCKETS. THE JOHNSON BAR TECHNIQUE MUST BE REPEATED AT LEAST ONCE MORE WITHIN 6" OF THE TRUNK. MULCH MUST NOT BE APPLIED OR ALLOWED TO ACCUMULATE DIRECTLY AGAINST THE TRUNK.
- 16. ORGANIC MULCH (MELALEUCA IS PREFERRED) MUST BE APPLIED WITHIN 48 HOURS OF RELOCATION AT A DEPTH OF 3-4" OVER THE ENTIRE TOP OF THE ROOTBALL FROM THE TREE RING TO WITHIN 6" OF THE TRUNK. MULCH MUST NOT BE APPLIED OR ALLOWED TO ACCUMULATE DIRECTLY AGAINST THE TRUNK.
- 17. PITS FROM WHICH THE RELOCATED TREES AND PALMS WERE REMOVED MUST BE CLEANED OFF ALL RESIDUAL ROOTS, STUMPS, AND PORTIONS THEREOF AND BACKFILLED WITH CLEAN FILL FLUSH WITH THE SURROUNDING GRADE.
- 18. RESTORE THE SURFACE WITH MATERIAL TO MATCH ADJACENT AREAS, MATERIAL TO BE APPROVED BY LANDSCAPE ARCHITECT. CONTRACTOR TO PROVIDE A MINIMUM OF ONE YEAR WARRANTY ON SETTLING AND PLANT MATERIAL FROM THE SUBSTANTIAL COMPLETION.
- 19. MULTI-TRUNK TREES AND PALMS MUST BE RELOCATED AS ONE UNIT WITH A SINGLE ROOTBALL.
- 20. PLANTING PITS FOR EDIBLE DATE PALMS (PHOENIX DACTYLIFERA) MUST BE BACKFILLED WITH PURE DOT SILICA SAND.


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SEAL (S TYLER NIELSEN - LA6667067)



ISSUE COORDINATION 12.17.2020 75% CD 02.01.2021 100% CD

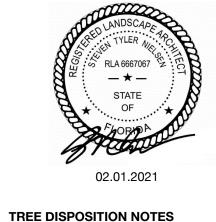

TDEE DISDOSITION SCHEDI II E

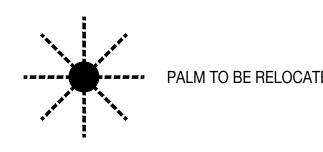
CATV

J	KE	E DISPOSITION SCHEL	DULE										
	#	BOTANICAL NAME	COMMON NAME	DBH.	HT.	SPREAD	ACTION	CRZ	TPZ	CONDITION	NATIVE	NOTES	CANOPY AREA REMOVED
	1	BISMARCKIA NOBILIS	BISMARK PALM	18"	40'	20'	RELOCATE	6'	6'	GOOD	NO	LOCATION OF PLANT MATERIAL CONFLICTS WITH CONSTRUCTION ENVELOPE	0

PROPERTY LINE

SIDE SETBACK

10.00 FT.

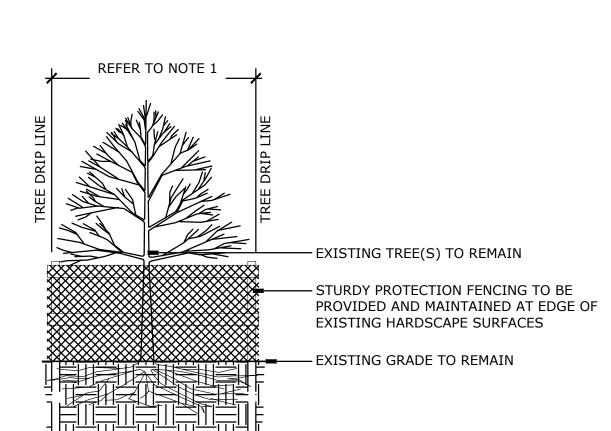


1. DUE TO SITE CONSTRAINTS TREE PROTECTION FENCE MAY BE CONTINUOUS TO PROTECT MULTIPLE TREES. TREE PROTECTION FENCE TO BE INSTALLED AT EDGE OF EXISTING HARDSCAPE. WHERE SPACE ALLOWS TREE PROTECTION FENCE TO ALIGN WITH DRIPLINE OF TREE / PALM. 2. MAINTAIN FENCE THROUGHOUT CONSTRUCTION.

3. REFER TO LOCAL, STATE AND FEDERAL JURISDICTIONS AND

GOVERNING BODIES/AGENCIES FOR ADDITIONAL REQUIREMENTS. TREE PROTECTION FENCE

Scale: 1/4" = 1'- 0"

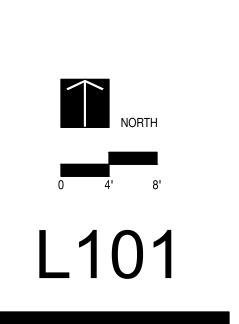

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TREE DISPOSITION PLAN & SCHEDULE

02.01.2021 100% CD



# MATERIALS NOTES

CONTRACTOR TO VERIFY ALL QUANTITIES. IN CASE OF ANY DISCREPANCIES, GRAPHICALLY SHOWN MATERIAL QUANTITIES SHALL TAKE PRECEDENCE.

9

CATV 🗌

ZOYSIA ZEOM.M.

SOD

255 SQFT.

ZOYSIA ZEON

SOD

640 SQFT.

PORPHYRY PAVERS

RE: ARCH. DRAWINGS

DRAWINGS

ZOYSIA ZEON

2,240 SQFT.

- ALL CONSTRUCTION AND MATERIALS NOT SPECIFICALLY ADDRESSED IN THE CONTRACT DOCUMENTS OR SPECIFICATIONS SHALL BE IN ACCORDANCE WITH LOCAL, STATE AND FEDERAL JURISDICTIONS AND GOVERNING BODIES/AGENCIES STANDARDS.
- THE CONTRACTOR SHALL PROVIDE A FULL-SCALE MOCKUP AND RECEIVE APPROVAL FROM THE LANDSCAPE ARCHITECT FOR ALL SYSTEMS BEFORE BEGINNING CONSTRUCTION OF PAVEMENT.
- EXPANSION JOINTS SHALL BE PROVIDED WHERE FLATWORK MEETS VERTICAL STRUCTURES, SUCH AS WALLS, CURBS, STEPS, AND OTHER HARDSCAPE ELEMENTS. EXPANSION JOINTS SHALL ALSO BE PROVIDED AT MATERIAL CHANGES. EXPANSION JOINT MATERIALS/METHODS SHALL BE SUBMITTED TO THE LANDSCAPE ARCHITECT FOR REVIEW AND APPROVAL PRIOR TO INSTALLATION.
- CONTROL JOINTS SHOULD BE SPACED NO GREATER THAN TEN (10) LINEAR FEET MAXIMUM, UNLESS OTHERWISE SPECIFIED. EXPANSION JOINTS SHOULD BE SPACED NO GREATER THAN FORTY (40) LINEAR FEET MAXIMUM, UNLESS OTHERWISE SPECIFIED. CONTRACTOR SHALL ADVISE ON OTHER JOINTS AS NEEDED TO MINIMIZE CRACKING. THIS INFORMATION SHALL BE SUBMITTED TO THE LANDSCAPE ARCHITECT FOR REVIEW AND APPROVAL PRIOR TO INSTALLATION.
- CONTROL JOINTS SHALL BE PROVIDED AS SPECIFIED IN THE CONTRACT DOCUMENTS. CONTROL JOINT MATERIALS, METHODS AND RECOMMENDATIONS ON ADDITIONAL CONTROL JOINTS TO MINIMIZE CRACKING SHALL BE SUBMITTED TO THE LANDSCAPE ARCHITECT FOR REVIEW AND APPROVAL.
- 7. ALL STEPS SHALL HAVE TWELVE (12) INCH TREADS AND SIX (6) INCH RISERS, UNLESS OTHERWISE SPECIFIED.
- 8. HOLD TOP OF WALLS AND FENCES LEVEL, UNLESS OTHERWISE SPECIFIED.
- 9. CONTRACTOR SHALL NOT INSTALL WORK LOCATED ON TOP OF ARCHITECTURAL STRUCTURES WITHOUT FIRST REVIEWING ARCHITECTURAL DRAWINGS.
- 10. SAMPLES OF SPECIFIED MATERIALS SHALL BE SUBMITTED TO THE LANDSCAPE ARCHITECT FOR REVIEW AND APPROVAL PRIOR TO ORDERING FOR JOB.




PROPOSED C.M.U. BLOCK WALL —

GARAGE

ATER FEATURE UNDE

PARATE PERMIT

PROPOSED C.M.U. BLOCK WALL -

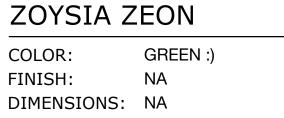

OOLITE BOULDER STEPS RE: ARCH. DRAWINGS —

TYPICAL

PLANTING AREA

PLANTING AREA TYPICAL

ZOYSIA ZEON

SOD

175 SQFT.

WOOD

DECKING RE:

ARCH. DRAWINGS

POOL & SPA UNDER SEPARATE PERMIT

OOLITE BOULDER STEPS RE: ARCH. DRAWINGS -


PROPERTY LINE

140.00 FT.


SDESETBACK

**NEW PROPOSED** 


TWO-STORY CMU STRUCTURE RESIDENCE

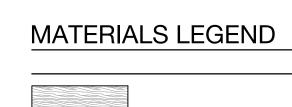



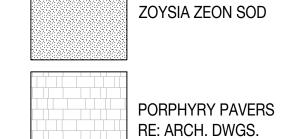



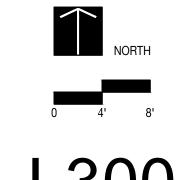

SEAL (S TYLER NIELSEN - LA6667067)

MATERIALS PLAN

11.25.2020 COORDINATION

12.17.2020 75% CD

02.01.2021 100% CD

**GROUND LEVEL** 

DATE

#### PLANTING NOTES

- PLANT MATERIAL IS TO BE HEALTHY SPECIMENS FREE FROM DISEASE OR DAMAGE, AND IS TO BE MAINTAINED IN EXCELLENT CONDITION WHILE ON THE JOBSITE. LANDSCAPE ARCHITECT SHALL INSPECT PLANT MATERIAL UPON ARRIVAL TO JOBSITE AND WILL REJECT PLANT MATERIAL THAT DOES NOT MEET THE STANDARDS DESCRIBED WITHIN THE CONTRACT DOCUMENTS.
- THE LANDSCAPE ARCHITECT WILL PERIODICALLY INSPECT PLANT MATERIAL STOCKPILED AND/OR PLANTED ON SITE DURING THE COURSE OF CONSTRUCTION. PLANT MATERIAL NOT MEETING THE STANDARDS CONTAINED WITHIN CONTRACT DOCUMENTS SHALL BE REPLACED AT NO COST TO THE OWNER.
- 3. PROVIDE MATCHING SIZES AND FORMS FOR EACH PLANT OF THE SAME SPECIES UNLESS OTHERWISE INDICATED.
- 4. CONTRACTOR TO VERIFY ALL QUANTITIES. IN CASE OF DISCREPANCIES, GRAPHICALLY SHOWN QUANTITIES SHALL TAKE PRECEDENCE.
- 5. ALL MATERIALS USED SHALL CONFORM TO THE GUIDELINES ESTABLISHED BY THE CURRENT AMERICAN STANDARDS FOR NURSERY STOCK, PUBLISHED BY THE AMERICAN ASSOCIATION OF NURSERYMEN.
- ALL PLANT MATERIAL SHALL BE INSTALLED PLUMB AND PER THE SPECIFICATIONS CONTAINED WITHIN THE CONTRACT DOCUMENTS. ANY NECESSARY STAKING AND/OR OTHER SUPPORTS MATERIALS/METHODS SHALL BE SUBMITTED TO THE LANDSCAPE ARCHITECT FOR REVIEW AND APPROVAL PRIOR TO INSTALLATION.
- 7. THE CONTRACTOR SHALL PRUNE EXISTING AND/OR NEW TREES ONLY PER LANDSCAPE ARCHITECT DIRECTION.
- 8. THE CONTRACTOR SHALL STAKE THE LOCATIONS OF ALL TREES AND B&B SHRUBS FOR LANDSCAPE ARCHITECT REVIEW AND APPROVAL, PRIOR TO INSTALLATION.
- 9. ALL ROOT-WRAPPING MATERIALS THAT ARE NOT BIO-DEGRADABLE SHALL BE REMOVED FROM THE ROOT BALL. ROOT BALLS SHALL BE FREE OF WEEDS.
- 10. SPECIFIED PLANT MATERIAL SIZES SHALL BE CONSIDERED MINIMUM SIZES.
- 11. FINISH GRADE OF PLANTING BEDS SHALL BE ONE (1) INCH BELOW ADJACENT FLATWORK, UNLESS SPECIFIED OTHERWISE.
- 12. MULCH OR PLANTING BED DRESSING SHALL BE PLACED IN ALL PLANTING AREAS AS SPECIFIED. MULCH OR PLANTING BED DRESSING SHALL NOT BE PLACED WITHIN SIX (6) INCHES OF TREE TRUNKS. MULCHING SHOULD BE REPEATED ANNUALLY DURING THE AUTUMN TO A THREE (3) INCH DEPTH.
- 13. ALL PLANT MATERIAL SHOULD RECEIVE AN ORGANIC FERTILIZER IN LIMITED APPLICATION FOLLOWING INSTALLATION. TYPE AND APPLICATION RATE AND METHOD OF APPLICATION TO BE SPECIFIED BY THE CONTRACTOR AND APPROVED BY THE LANDSCAPE ARCHITECT.
- 14. EXCESS FERTILIZER SHALL BE DISPOSED OF PROPERLY OFF-SITE. IT SHALL NOT BE DISPOSED OF IN STORM DRAINS AND/OR DRYWELLS.
- 15. STOCKPILED PLANT MATERIAL TO BE PLACED IN THE SHADE AND PROPERLY HAND-WATERED UNTIL PLANTED.
- 16. MINI-NUGGET TYPE DECORATIVE BARK MULCH WILL BE USED TO RETURN NUTRIENTS TO THE SOIL, REDUCE MAINTENANCE AND MINIMIZE EVAPORATION FOR AREAS APPROXIMATE TO THE RESIDENCE. LARGER SHREDDED BARK MULCH WILL BE USED FOR STEEP AREAS SO SLOUGHING IS LESS LIKELY TO OCCUR.
- 17. PRESERVE & PROTECT ALL EXISTING VEGETATION INDICATED TO REMAIN AT ALL TIMES.
- 18. ALL VEGETATION PROPOSED FOR OUTSIDE THE BUILDING ENVELOPE TO BE NATIVE UNLESS OTHERWISE NOTED. PLANTING THAT OCCURS OUTSIDE THE BUILDING ENVELOPE IS FOR RESTORATION PURPOSES ONLY OR IS SPECIFIC TO UTILITIES RESTORATION.
- 19. SIX (6) INCH PLANT MIX SHALL BE PROVIDED FOR ALL LAWN, TURF, AND NATIVE PLANTING ZONES. 18 INCH PLANT MIX SHALL BE PROVIDED FOR ALL PERENNIAL PLANTING BEDS UNLESS OTHERWISE NOTED.



#### PLANTING SCHEDULE

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ABR.	QUANTITY	BOTANICAL NAME	COMMON NAME	SPECIFICATIONS
TREE	S			
CDI	CDI 3 COCCOLOBA DIVERSIFOLIA PIGEON PLUM			FG. 6 IN. DBH 18 FT. HT. OA. SINGLE LEADER STANDARD
PRA	12	PIMENTO RACEMOSA	BAY RUM	200 GAL. 4 IN. DBH 16 FT. HT. SINGLE LEADER STANDARD
CUV	3	COCCOLOBA UVIFERA	SEA GRAPE	MULTI TRUNK 20-24 FT. HT.
PALM	/IS			
TR1	18	THRINAX RADIATA	FLORIDA THATCH PALM	TRIPLE 7 GAL. 3 FT. OA.
TR2	1	THRINAX RADIATA	FLORIDA THATCH PALM	FG. MULTI 7-9 TRUNK 12-15' OA.
SP1	6	SABAL PALMETTO	CABBAGE PALM	16 FT. GW W/ CHARACTER CURVE
SP2	6	SABAL PALMETTO	CABBAGE PALM	20 FT. GW W/ CHARACTER CURVE
SP3	6	SABAL PALMETTO	CABBAGE PALM	24 FT. GW W/ CHARACTER CURVE
CMI	3	CARYOTA MITIS	FISHTAIL PALM	100 GAL.
UNDE	ERSTORY 1	TREES & SHRUBS		
GL	72	GYMNANTHES LUCIDA	CRABWOOD	25 GAL. 6 FT. OA. BUSH FORM
TD	23	TRIPSACUM DACTYLOIDES	FAKAHATCHEE GRASS	3 GAL.
ACCE	ENTS			
AP	40	ALPINIA PURPURATA	RED GINGER	15 GAL. 6 FT. HT.
AS	50	ANDROLEPIS SKINERII	BROMELIAD 'BIG RED'	3 GAL.
PG	6	PHILODENDRON GIGANTEUM	SAME	7 GAL.
ВМ	100	PHILODENDRON 'BURLE MARX'	SAME	3 GAL.
GRO	UNDCOVE	RS		
HE	567	HETEROCENTRON ELEGANS	SPANISH SHAWL	1 GAL. 12 IN. O.C.
NB	364	NEOREGELIA 'BOSSA NOVA'	BROMELIAD	1 GAL. 12 IN. O.C.
SECC	OND LEVEL	PLANTING		
РВ	19	PHILODENDRON BIPINNATIFIDUM	SPLIT-LEAF PHILODENDRON	3 GAL.
PX	45	PHILODENDRON 'XANADU'	SAME	3 GAL.
BK	20	BOUGAINVILLEA 'BARBARA KARST'	SAME	3 GAL. BUSH
EA	169	EPIPREMNUM AUREUM 'JADE'	GOLDEN POTHOS VINE	6 IN. POT / 12 IN. O.C.
MISC	<u>,                                     </u>			
ALL S	SOD AREAS	S TO BE REPLACED WITH ZOYSIA 'ZEON'		
LAND	SCAPE AF	RCHITECT TO HAVE \$2000 WHOLESALE AC	CENT PLANT ALLOWANCE	

#### CORAL GABLES LANDSCAPE LEGEND

ZONING DISTRICT:	SFR
NET LOT AREA (ACRES):	0.32 ACRES
NET LOT AREA (SQUARE FEET):	13,773 SQUARE FEET

DEVELOPMENT STANDARDS			REQUIRED	PROVIDI	ED
LANDSCAPED OPEN SPACE	40% MINIMUM		5,510	5,510	40%
FRONT YARD LANDSCAPE OPEN SPACE	MINIMUM 20% OF 40%		1,102	1,578	29%
TREES					
STREET TREES	1 TREE SHADE TREE / 35 LINEAR FEET 3		3	3	
LARGE SHADE TREE (TOTAL)	1 TREE / 5,000 SQFT.	(30% NATIVE MIN.)	3 (1 NATIVE)	18	(6 NATIVES)
LARGE SHADE TREE (FRONT YARD)	AT LEAST 2 TREES		2	6	
PALM & MEDIUM SHADE TREES	2 PALMS OR 1 TREE / 5,000 SQFT. (30% NATIVE MIN.)		6 PALMS 37 PALMS		IS
SHRUBS & LAWN					
SHRUBS (TOTAL)	15 / 5,000 SQFT.	(30% NATIVE MIN.)	45 (14 NATIVES)	95	(95 NATIVES)
SHRUBS (FRONT YARD)	66% OF REQUIRED SHRUBS		30	30	
LAWN GRASS	60% OF LOT AREA MAXIMUM		8,264 MAX	2,625 (19%)	
LAWN GRASS (R.O.W.)	ALL UNPAVED SURFACES		100% R.O.W.	100% R.O.W.	

#### PLANT REFERENCE IMAGERY



PIGEON PLUM

CRABWOOD



BAY RUM

FAKAHATCHEE GRASS

BROMELIAD



SEA GRAPE

RED GINGER



FLORIDA THATCH PALM 1

PHILODENDRON 'XANADU'



BROMELIAD 'BIG RED'









PHILODENDRON GIGANTEUM BURLE MARX

GOLDEN POTHOS VINE



02.01.2021 PLANTING SCHEDULE & NOTES


SEAL (S TYLER NIELSEN - LA6667067)

11.25.2020 COORDINATION 12.17.2020 75% CD 02.01.2021 100% CD

L700



## PLANTING LEGEND

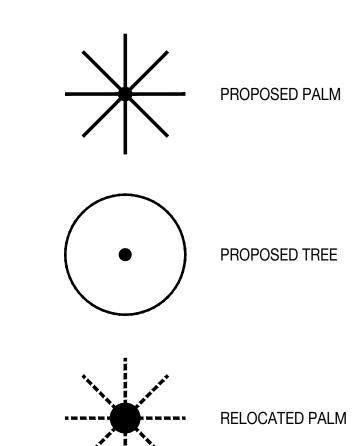

GARAGE


**NEW PROPOSED** TWO-STORY CMU STRUCTURE RESIDENCE

PLA	PLANTING SCHEDULE					
ABR.	QUANTITY	BOTANICAL NAME	COMMON NAME	SPECIFICATIONS		
TREE	S					
CDI	3	COCCOLOBA DIVERSIFOLIA	PIGEON PLUM	FG. 6 IN. DBH 18 FT. HT. OA. SINGLE LEADER STANDARD		
PRA	12	PIMENTO RACEMOSA	BAY RUM	200 GAL. 4 IN. DBH 16 FT. HT. SINGLE LEADER STANDARD		
CUV	3	COCCOLOBA UVIFERA	SEA GRAPE	MULTI TRUNK 20-24 FT. HT.		
PAL	<b>MS</b>					
TR1	18	THRINAX RADIATA	FLORIDA THATCH PALM	TRIPLE 7 GAL. 3 FT. OA.		
TR2	1	THRINAX RADIATA	FLORIDA THATCH PALM	FG. MULTI 7-9 TRUNK 12-15' OA.		
SP1	6	SABAL PALMETTO	CABBAGE PALM	16 FT. GW W/ CHARACTER CURVE		
SP2	6	SABAL PALMETTO	CABBAGE PALM	20 FT. GW W/ CHARACTER CURVE		
SP3	6	SABAL PALMETTO	CABBAGE PALM	24 FT. GW W/ CHARACTER CURVE		
CMI	3	CARYOTA MITIS	FISHTAIL PALM	100 GAL.		

# CORAL GABLES LANDSCAPE LEGEND

	OFT	
	0.32 ACRES	
	13,773 SQUARE FE	ET
	REQUIRED	PROVIDED
_		


2017 127 (0 0 0 7 11 12 1 22 1).				10,170 0007 112 1 22 1				
		REQUIRED		PROVIDE	D			
40% MINIMUM		5,510		5,510	40%			
MINIMUM 20% OF 40%		1,102		1,578	29%			
1 TREE SHADE TREE / 35 LINEAR FEI	ET	3		3				
1 TREE / 5,000 SQFT.	(30% NATIVE MIN.)	3	(1 NATIVE)	18	(6 NATIVES)			
AT LEAST 2 TREES		2		6				
2 PALMS OR 1 TREE / 5,000 SQFT. (30% NATIVE MIN.)		6 PALMS		37 PALMS				
15 / 5,000 SQFT.	(30% NATIVE MIN.)	45 (14 NA	ATIVES)	95	(95 NATIVES)			
66% OF REQUIRED SHRUBS		30		30				
60% OF LOT AREA MAXIMUM		8,264 MAX		2,625 (199	%)			
ALL UNPAVED SURFACES		100% R.O.W.		100% R.O.W.				
	MINIMUM 20% OF 40%  1 TREE SHADE TREE / 35 LINEAR FE 1 TREE / 5,000 SQFT.  AT LEAST 2 TREES 2 PALMS OR 1 TREE / 5,000 SQFT.  15 / 5,000 SQFT.  66% OF REQUIRED SHRUBS 60% OF LOT AREA MAXIMUM	MINIMUM 20% OF 40%  1 TREE SHADE TREE / 35 LINEAR FEET 1 TREE / 5,000 SQFT. (30% NATIVE MIN.) AT LEAST 2 TREES 2 PALMS OR 1 TREE / 5,000 SQFT. (30% NATIVE MIN.)  15 / 5,000 SQFT. (30% NATIVE MIN.) 66% OF REQUIRED SHRUBS 60% OF LOT AREA MAXIMUM	## REQUIRED  40% MINIMUM	## REQUIRED  40% MINIMUM	REQUIRED   PROVIDE			

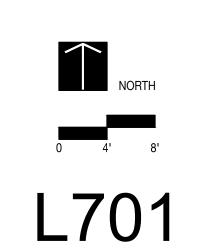

SEAL (S TYLER NIELSEN - LA6667067)

TREE & PALM PLANTING PLAN

11.25.2020 COORDINATION 12.17.2020 75% CD 02.01.2021 100% CD

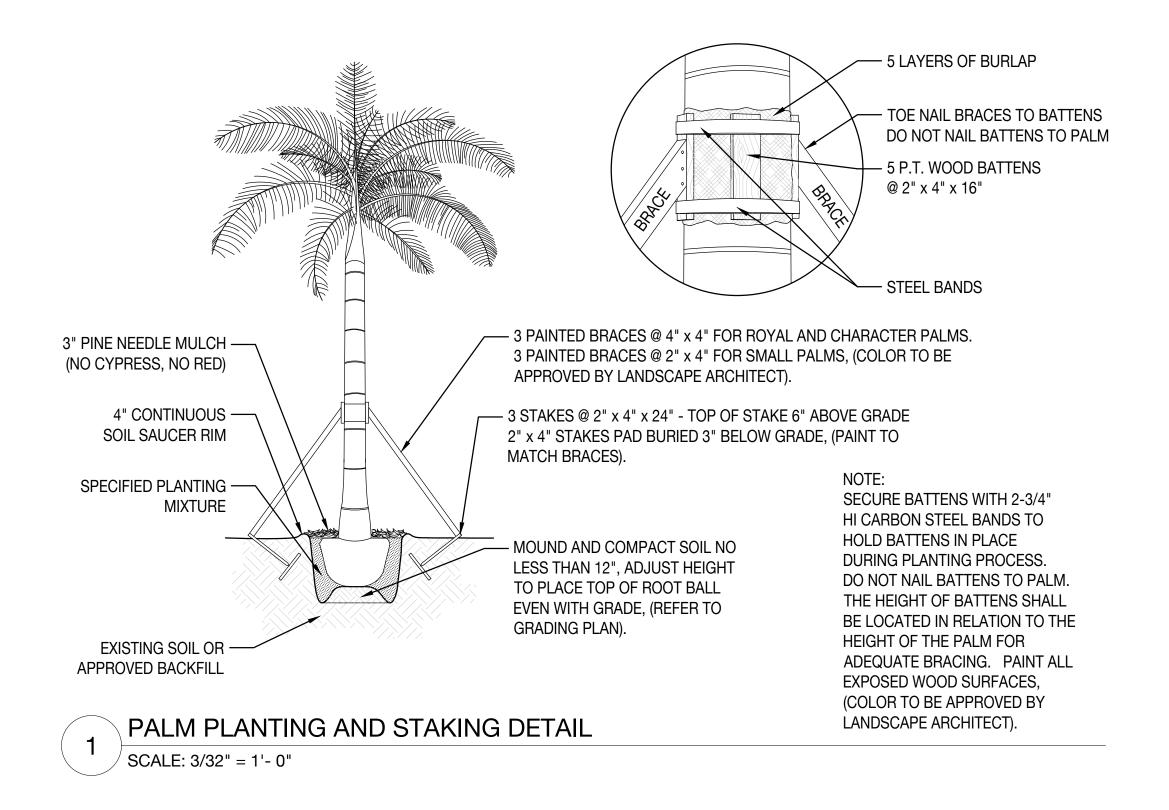

— 5 LAYERS OF BURLAP

- 5 P.T. WOOD BATTENS

@ 2" x 4" x 16"

— STEEL BANDS

SECURE BATTENS WITH 2-3/4"

HI CARBON STEEL BANDS TO

DURING PLANTING PROCESS.

DO NOT NAIL BATTENS TO TREE.

THE HEIGHT OF BATTENS SHALL

BE LOCATED IN RELATION TO THE

ADEQUATE BRACING. PAINT ALL

HOLD BATTENS IN PLACE

HEIGHT OF THE TREE FOR

EXPOSED WOOD SURFACES,

(COLOR TO BE APPROVED BY

LANDSCAPE ARCHITECT).

3 PAINTED BRACES @ 4" x 4" FOR TREES AND CHARACTER TREES.

3 PAINTED BRACES @ 2" x 4" FOR SMALL TREES, (COLOR TO BE

3 STAKES @ 2" x 4" x 24" - TOP OF STAKE 6" ABOVE GRADE

APPROVED BY LANDSCAPE ARCHITECT).

- MOUND AND COMPACT SOIL

NO LESS THAN 12", ADJUST

HEIGHT TO PLACE TOP OF

ROOT BALL EVEN WITH GRADE

2" x 4" STAKES PAD BURIED 3" BELOW GRADE

3" PINE NEEDLE MULCH

4" CONTINUOUS —

MIXTURE

SOIL SAUCER RIM

EXISTING SOIL OR -

4 SCALE: 3/32" = 1'- 0"

2X BALL DIA.


TREE PLANTING AND STAKING DETAIL


APPROVED BACKFILL

SPECIFIED PLANTING -

(NO CYPRESS, NO RED)


TOE NAIL BRACES TO BATTENS
 DO NOT NAIL BATTENS TO PALM

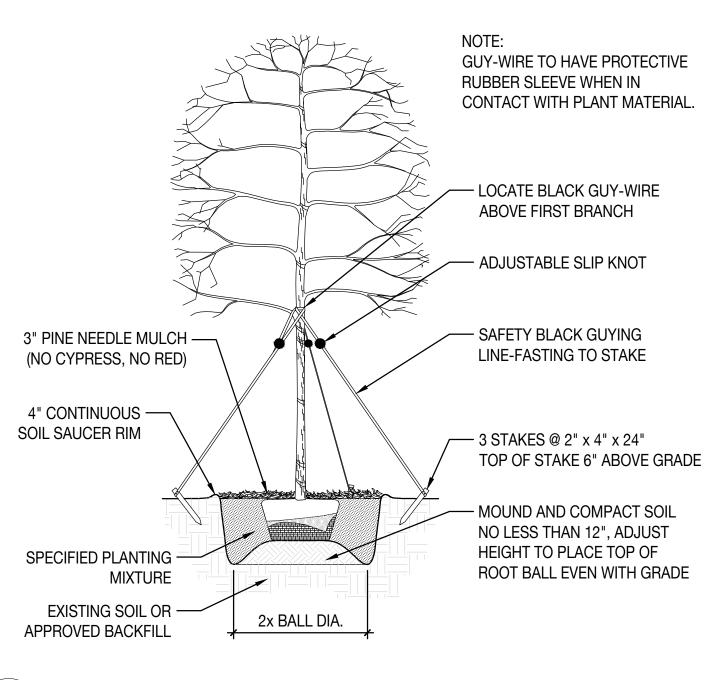


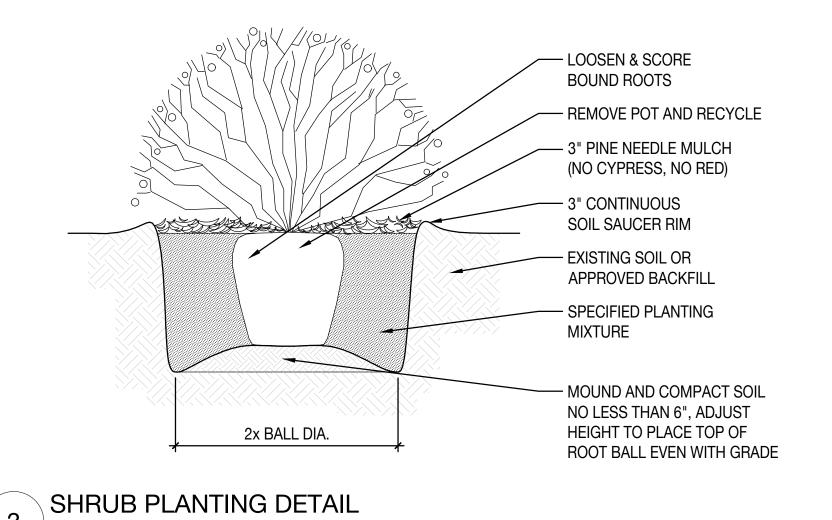

/ SCALE: 3/32" = 1'- 0"



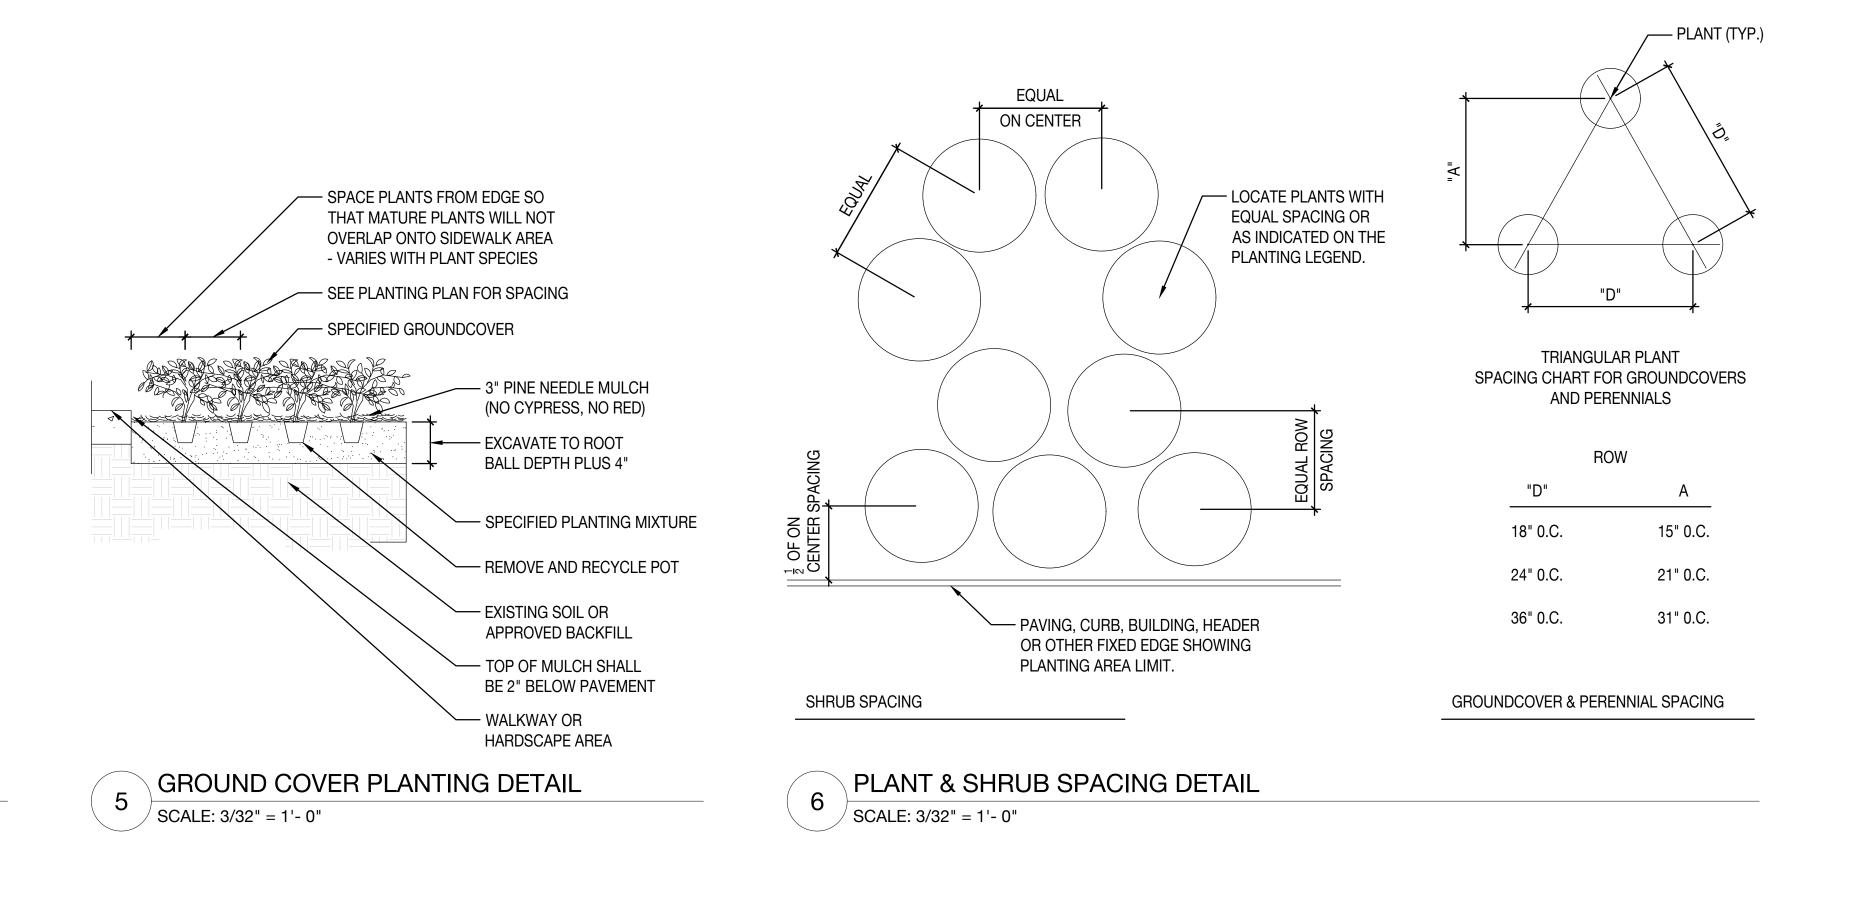

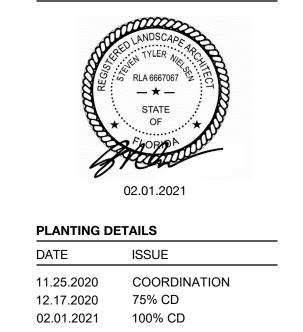

SEAL (S TYLER NIELSEN - LA6667067)