# PATRIOT WINDOWS AND DOORS

# GLAZING SYSTEMS HARRIS LEVINE RESIDENCE 405 VISCAYA AVENUE, CORAL GABLES, FLORIDA 33134

## DESIGN CRITERIA

2023 FLORIDA BUILDING CODE SEVENTH EDITION WIND LOADS PER ASCE 7-22:

> -BASIC WIND SPEED: 175 MPH -EXPOSURE CATEGORY: -WIND DIRECTIONAL FACTOR KD: .85

### GENERAL NOTES

- 1. ANCHORS SHALL BE AS LISTED, SPACED AS SHOWN ON DETAILS.
- 2. EMBEDMENT TO BASE MATERIAL SHALL BE BEYOND WALL FINISHES OR STUCCO.
- 3. MATERIALS INCLUDING BUT NOT LIMITED TO STEEL/ALUMINUM, THAT COME IN CONTACT WITH OTHER DISSIMILAR MATERIALS SHALL MEET THE REQUIREMENTS OF THE 2023 FLORIDA BUILDING CODE SECTION 2003.8.4
- 4. ALL STEEL PLATES TO BE A36, ALL STEEL TUBING TO BE A500, GRADE B (Fy=46KSI).
- 5. ALL WELDING TO BE PER THE AWS SPECIFICATIONS.
- 6. ALL ALUMINUM TO BE 6061-T6, AS PER SPECIFICATION 2 OF THE ALUMINUM DESIGN MANUAL.
- 7. WOOD BUCKS TO BE 1X OR 2X FULL DEPTH OF GLAZING FRAMES TO SUBSTRATE AS FOLLOWS: 1/4" TAPCON WITH 1-3/4" EMBED @ 12" O.C. INTO CONCRETE OR #14 SMS/TEKS @ 12" O.C. INTO METAL. PROVIDE CLUSTER OF [2] AT JAMB ENDS AND EACH SIDE OF MULLION, AND MUST ADHERE TO EDGE DISTANCE AND SPACING LIMITATIONS.
- 8. DLGE WILL NOT PROVIDE A STATEMENT OF INSPECTION UNLESS CALLED PRIOR TO INSTALLATION.
- 9. SHOP DRAWING COVER STRUCTURAL REQUIREMENTS ONLY.
- 10. ALL WINDOW OPENINGS IDENTIFIED AS EGRESS SHALL BE UNOBSTUCTED AND SHALL HAVE A MINIMUM NET CLEAR OPENING HEIGHT OF 24", A NET CLEAR OPENING WIDTH OF 20" AND A MINIMUM NET CLEAR OPENING AREA OF 5.7 S.F. (5.0 S.F. FOR GRADE LEVEL WINDOWS).
- 11. ALL EGRESS WINDOWS SHALL HAVE A SILL HEIGHT NOT TO EXCEED 44" ABOVE FINISHED FLOOR.
- 12. ALL WINDOWS SHALL NOT HAVE A SILL HEIGHT LESS THAN 36" ABOVE FINISHED FLOOR, UNLESS A CODE APPROVED PROTECTIVE BARRIER IS PROVIDED (BY OTHERS).
- 13. IT IS THE EXCLUSIVE RESPONSIBILITY OF THE WINDOW COMPANY TO PROVIDE PRODUCTS THAT MEET OR EXCEED THE ENERGY VALUES MANDATED BY THE STATE OF FLORIDA. COMPLIANCE WITH ENERGY REQUIREMENTS IS BEYOND THE SCOPE OF THESE
- 14. ALL SHIMS TO BE AS PER PRODUCT APPROVALS.
- 15. G.C. TO PROVIDE OR REPLACE FIRE PROTECTION ON ALL STRUCTURAL MEMBERS, NEW AND EXISTING, AS NECESSARY, TO MEET FIRE RATING REQUIREMENTS BY APPLICABLE CODES

ONLY MARKED UNITS ARE PART OF THE SCOPE. FULL SCOPE MAY NOT COVER FULL ENVELOPE OF THE BUILDING / RESIDENCE. DLGE NOT RESPONSIBLE FOR THE FULL ENVELOPE OF THE BUILDING / RESIDENCE.

SCOPE LIMITED TO GLAZING PRODUCTS AND ANCHORAGE CHECK

GC IS RESPONSIBLE TO VERIFY THAT THE SUBSTRATES MEET THE REQUIREMENTS SPECIFIED IN PRODUCT APPROVALS AND DETAILS IN THIS DRAWINGS.

## GLAZING SYSTEMS

A. <u>FIXED WINDOW - LARGE MISSILE IMPACT</u>

NOA# 23-0724.08 SERIES "5100 FIXED CASEMENT" ALUMINUM FIXED WINDOW - L.M.I. MANUFACTURER: E.S. WINDOWS, LLC FINISH: AAMA 2604 BRONZE

GLAZED WITH: GLASS TYPE "C" 3/8" THICK OVERALL LAMINATED GLASS

> OUTBOARD: 5/32" CLEAR HEAT-STRENGTHENED GLASS INTERLAYER: 0.090" CLEAR INTERLAYER TROSIFOL PVB BY 'KURARAY AMERICA, INC.' 1/8" CLEAR HEAT-STRENGTHENED GLASS

B. <u>CASEMENT WINDOW - LARGE MISSILE IMPACT</u>

FL# 41000.1 SERIES "5000" ALUMINUM CASEMENT WINDOW - L.M.I. MANUFACTURER: E.S. WINDOWS, INC FINISH: AAMA 2604 BRONZE

GLAZED WITH: GLASS TYPE "A"

5/16" THICK OVERALL LAMINATED GLASS OUTBOARD: 1/8" CLEAR HEAT-STRENGTHENED GLASS INTERLAYER: 0.090" CLEAR INTERLAYER TROSIFOL PVB BY 'KURARAY AMERICA, INC.' 1/8" CLEAR HEAT—STRENGTHENED GLASS

C. <u>FIXED WINDOW - LARGE MISSILE IMPACT</u>

NOA# 23-0714.17 SERIES "EL-150" ALUMINUM FIXED WINDOW - L.M.I. MANUFACTURER: E.S. WINDOWS, LLC

FINISH: AAMA 2604 BRONZE


GLAZED WITH: GLASS TYPE "B" 7/16" THICK OVERALL LAMINATED GLASS

OUTBOARD: 3/16" CLEAR HEAT-STRENGTHENED GLASS

INTERLAYER: 0.090" CLEAR INTERLAYER TROSIFOL PVB BY 'KURARAY AMERICA, INC.' INBOARD: 3/16" CLEAR HEAT-STRENGTHENED GLASS

SHEET SHEET TITLE  000 GENERAL NOTES AND SITE LOCATION  100 WINDOW & DOOR SCHEDULE  200 FIRST FLOOR PLAN (AS REFERENCE ONLY)  201 SECOND FLOOR PLAN (AS REFERENCE ONLY)  300 SOUTH & EAST ELEVATION  301 NORTH ELEVATION  400 OPENING ELEVATIONS	NDEX O	OF DRAWINGS
100 WINDOW & DOOR SCHEDULE 200 FIRST FLOOR PLAN (AS REFERENCE ONLY) 201 SECOND FLOOR PLAN (AS REFERENCE ONLY) 300 SOUTH & EAST ELEVATION 301 NORTH ELEVATION	HEET S	SHEET TITLE
200 FIRST FLOOR PLAN (AS REFERENCE ONLY) 201 SECOND FLOOR PLAN (AS REFERENCE ONLY) 300 SOUTH & EAST ELEVATION 301 NORTH ELEVATION	00 G	GENERAL NOTES AND SITE LOCATION
201 SECOND FLOOR PLAN (AS REFERENCE ONLY)  300 SOUTH & EAST ELEVATION  301 NORTH ELEVATION	00 W	WINDOW & DOOR SCHEDULE
300 SOUTH & EAST ELEVATION  301 NORTH ELEVATION	00 FI	- First floor plan (as reference only)
301 NORTH ELEVATION	01 S	SECOND FLOOR PLAN (AS REFERENCE ONLY)
	00 S	SOUTH & EAST ELEVATION
400 OPENING ELEVATIONS	01 N	NORTH ELEVATION
	00 0	DPENING ELEVATIONS
500-502 PHOTOGRAPHS	00-502 P	PHOTOGRAPHS



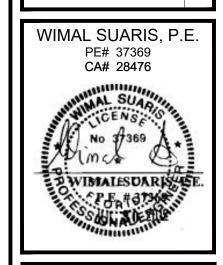

AND GENERAL NOTE

PATRIOT WINDOWS & DOORS 6175 NW 167TH STREET MIAMI LAKES, FL 33015

DATE	03/19/2024
SCALE	AS NOTED
DRAWN	AA
CHECKED BY	JRO
PROJECT	24-143

DRAWING NO. SD24-143


Wood St

SITE LOCATION

@	AT	DWG.	DRAWING	MIN.	MINIMUM	N.I.C.	NOT IN CONTRACT	SMS	SHEET METAL SCREW	SYSTEM	M ABBREVIATIONS
ALUM.	ALUMINUM	EA.	EACH	MIR.	MIRROR	O.C.	ON CENTER	STL.	STEEL	0101211	- ABBILLY II (III of to
ATT.	ATTACHED	E.DIST.	EDGE DISTANCE	MTL.	METAL	O.D.	OUTSIDE DIAMETER	STRUCT.	STRUCTURE	CW	CURTAIN WAL
BLDG.	BUILDING	EMBED.	EMBEDMENT	N.I.C.	NOT IN CONTRACT	OPG.	OPENING	THK.	THICK	ED	ENTRANCE D
BOT.	BOTTOM	EXIST.	EXISTING	HORIZ.	HORIZONTAL	P.T.	PRESSURE TREATED	TYP.	TYPICAL	FX	FIXED WINDO

WALL DOOR DOW PLATE CENTER TO CENTER F.D. FRAME DIMENSION HOLLLOW STRUCTURAL SECTION UNLESS OTHERWISE HOLLOW METAL DOOR CENTER LINE HEIGHT M.O. MASONRY OPENING RADIUS HORIZONTAL ROLLER WINDOW HORIZ. ROUGH OPENING VERIFY IN FIELD CEILING HORIZONTAL LOUVER MATERIAI REINFORCEMENT VERT. VERTICAL HSS HOLLLOW STRUCTURAL SECTION REINF. STOREFRONT COLUMN MAXIMUM CONCRETE М.О. MASONRY OPENING WIDTH SLIDING GLASS DOOR MANUFACTURER REINF'D REINFORCED CONTINUOUS SINGLE HUNG MAT'L. WITH MATERIAL MINIMUM REQ'D. REQUIRED SKYLIGHT MIR. MIRROR MAX. MAXIMUM SIM. WD. WOOD SIMILAR WINDOW WALL DIA. DIAMETER MANUFACTURER METAL SLOPE

**ABBREVIATIONS** 

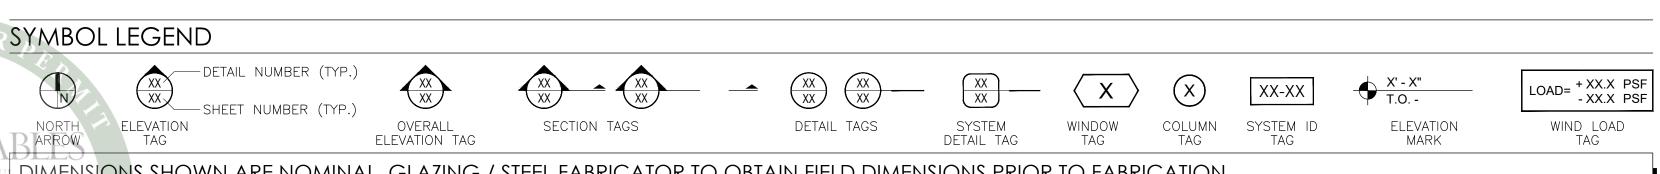

DIMENSIONS SHOWN ARE NOMINAL, GLAZING / STEEL FABRICATOR TO OBTAIN FIELD DIMENSIONS PRIOR TO FABRICATION

THE EXISTING STRUCTURE AND SUBSTRATE SHOULD BE VERIFIED, BY OTHERS, TO SUPPORT THE LOADS IMPOSED BY THE GLAZING SYSTEM

CONTRACTOR TO REPORT ANY DEVIATIONS BETWEEN FIELD CONDITIONS AND DETAILS SHOWN ON THESE DRAWINGS TO DLG ENGINEERING PRIOR TO

									WINDOW & DOOR SCHEDULE		
MARK	QTY.	GLASS TYPE	O.A. FRAME SIZE (W X H)	WIND ZONE	DESIGN PER ASO		ALLOWABL PER APP		PRODUCT DESCRIPTION	NOA No. / FL No.	REMARKS
		1116		ZONE	(+)PSF	(-)PSF	(+)PSF	(-)PSF			
1	1	С	19.0" X 40.0"	5	45.78	61.30	90.0	90.0	SERIES "5100 FIXED CASEMENT" ALUMINUM FIXED WINDOW - L.M.I.	NOA# 23-0724.08	O CONFIGURATION / FLANGE FRAME / MUNTIN DETAILS: GRID, (1) LITE ACROSS, (3) LITES DOWN, ES1014 INTERNAL AND EXTERNAL STYLE / FINISH: AAMA 2604 BRONZE
2	1	А	37.0" X 40.0"	4	45.78	49.66	85.0	85.0	SERIES "5000" ALUMINUM CASEMENT WINDOW - L.M.I.	FL# 41000.1	XR CONFIGURATION / FLANGE FRAME / MULTIPOINT LOCK / MUNTIN DETAILS: GRID, (2) LITES ACROSS, (3) LITES DOWN, ES1014 INTERNAL AND EXTERNAL STYLE / FINISH: AAMA 2604 BRONZE
3	1	С	19.0" X 40.0"	4	45.78	49.66	90.0	90.0	SERIES "5100 FIXED CASEMENT" ALUMINUM FIXED WINDOW - L.M.I.	NOA# 23-0724.08	O CONFIGURATION / FLANGE FRAME / MUNTIN DETAILS: GRID, (1) LITE ACROSS, (3) LITES DOWN, ES1014 INTERNAL AND EXTERNAL STYLE / FINISH: AAMA 2604 BRONZE
4	2	А	35-1/2" X 50.0"	4	45.78	49.66	85.0	85.0	SERIES "5000" ALUMINUM CASEMENT WINDOW - L.M.I.	FL# 41000.1	XR CONFIGURATION / FLANGE FRAME / MULTIPOINT LOCK / MUNTIN DETAILS: GRID, (2) LITES ACROSS, (3) LITES DOWN, ES1014 INTERNAL AND EXTERNAL STYLE / FINISH: AAMA 2604 BRONZE
5	1	А	35-1/2" X 37-1/2"	4	45.78	49.66	85.0	85.0	SERIES "5000" ALUMINUM CASEMENT WINDOW - L.M.I.	FL# 41000.1	XR CONFIGURATION / FLANGE FRAME / MULTIPOINT LOCK / MUNTIN DETAILS: GRID, (2) LITES ACROSS, (3) LITES DOWN, ES1014 INTERNAL AND EXTERNAL STYLE / FINISH: AAMA 2604 BRONZE
6	2	А	52-1/2" X 49-1/2"	5	45.78	61.30	85.0	85.0	SERIES "5000" ALUMINUM CASEMENT WINDOW - L.M.I.	FL# 41000.1	XX CONFIGURATION / FLANGE FRAME / MULTIPOINT LOCK / MUNTIN DETAILS: GRID, (1) LITES ACROSS, (4) LITES DOWN, ES1014 INTERNAL AND EXTERNAL STYLE / FINISH: AAMA 2604 BRONZE
7	1	А	36-1/2" X 38.0"	4	45.78	49.66	85.0	85.0	SERIES "5000" ALUMINUM CASEMENT WINDOW - L.M.I.	FL# 41000.1	XR CONFIGURATION / FLANGE FRAME / MULTIPOINT LOCK / MUNTIN DETAILS: GRID, (2) LITES ACROSS, (3) LITES DOWN, ES1014 INTERNAL AND EXTERNAL STYLE / FINISH: AAMA 2604 BRONZE
8	1	А	37.0" X 50-5/8"	4	45.78	49.66	85.0	85.0	SERIES "5000" ALUMINUM CASEMENT WINDOW - L.M.I.	FL# 41000.1	XL CONFIGURATION / FLANGE FRAME / MULTIPOINT LOCK / MUNTIN DETAILS: GRID, (2) LITES ACROSS, (3) LITES DOWN, ES1014 INTERNAL AND EXTERNAL STYLE / FINISH: AAMA 2604 BRONZE
9	1	В	37.0" X 39.0"	5	45.78	61.30	85.0	85.0	SERIES "5000" ALUMINUM CASEMENT WINDOW - L.M.I.	FL# 41000.1	XL CONFIGURATION / FLANGE FRAME / MULTIPOINT LOCK / MUNTIN DETAILS: GRID, (2) LITES ACROSS, (3) LITES DOWN, ES1014 INTERNAL AND EXTERNAL STYLE / FINISH: AAMA 2604 BRONZE
10	2	А	35-1/2" X 51.0"	4	45.78	49.66	85.0	85.0	SERIES "5000" ALUMINUM CASEMENT WINDOW - L.M.I.	FL# 41000.1	XR CONFIGURATION / FLANGE FRAME / MULTIPOINT LOCK / MUNTIN DETAILS: GRID, (2) LITES ACROSS, (3) LITES DOWN, ES1014 INTERNAL AND EXTERNAL STYLE / FINISH: AAMA 2604 BRONZE
11	1	В	19.0" X 39.0"	4	45.78	49.66	80.0	80.0	SERIES "EL-150" ALUMINUM FIXED WINDOW - L.M.I.	NOA# 23-0714.17	O CONFIGURATION / FLANGE FRAME / MUNTIN DETAILS: GRID, (1) LITE ACROSS, (3) LITES DOWN, ES1014 INTERNAL AND EXTERNAL STYLE / FINISH: AAMA 2604 BRONZE
12R	1	А	35-1/2" X 50.0"	4	45.78	49.66	85.0	85.0	SERIES "5000" ALUMINUM CASEMENT WINDOW - L.M.I.	FL# 41000.1	XR CONFIGURATION / FLANGE FRAME / MULTIPOINT LOCK / MUNTIN DETAILS: GRID, (2) LITES ACROSS, (3) LITES DOWN, ES1014 INTERNAL AND EXTERNAL STYLE / FINISH: AAMA 2604 BRONZE
12L	1	А	35-1/2" X 50.0"	4	45.78	49.66	85.0	85.0	SERIES "5000" ALUMINUM CASEMENT WINDOW - L.M.I.	FL# 41000.1	XL CONFIGURATION / FLANGE FRAME / MULTIPOINT LOCK / MUNTIN DETAILS: GRID, (2) LITES ACROSS, (3) LITES DOWN, ES1014 INTERNAL AND EXTERNAL STYLE / FINISH: AAMA 2604 BRONZE

1	WINDOW & DOOR SCHEDULE
100	SCALE

N.T.S

WIMAL SUARIS, P.E.
PE# 37369
CA# 28476

MINDOW & DOOR SCHEDULE


PATRIOT WINDOWS
& DOORS
& DOORS
6175 NW 167TH STREET
MIAMI LAKES, FL 33015
CORAL GABLES. FLORIDA

03/19/2024 AS NOTED DRAWN CHECKED BY JRO PROJECT 24-143

> DRAWING NO. SD24-143

> > 100

CORAL GABL	ES
BUILDING DEPARTMENT  Approval of this plan is for permitting purpose and does not imply authority to violate, cancel or set aside any of the provisions of the curren opted technical codes, ordinances, laws or retions, requiring correction of errors in either plans or construction, or any deficiencies which have been omitted or overlooked in the plan ror permitting process.  10/25/2024  SITE SET BLDR-24-04-5272	d, alter tly ad- gula- r the h may

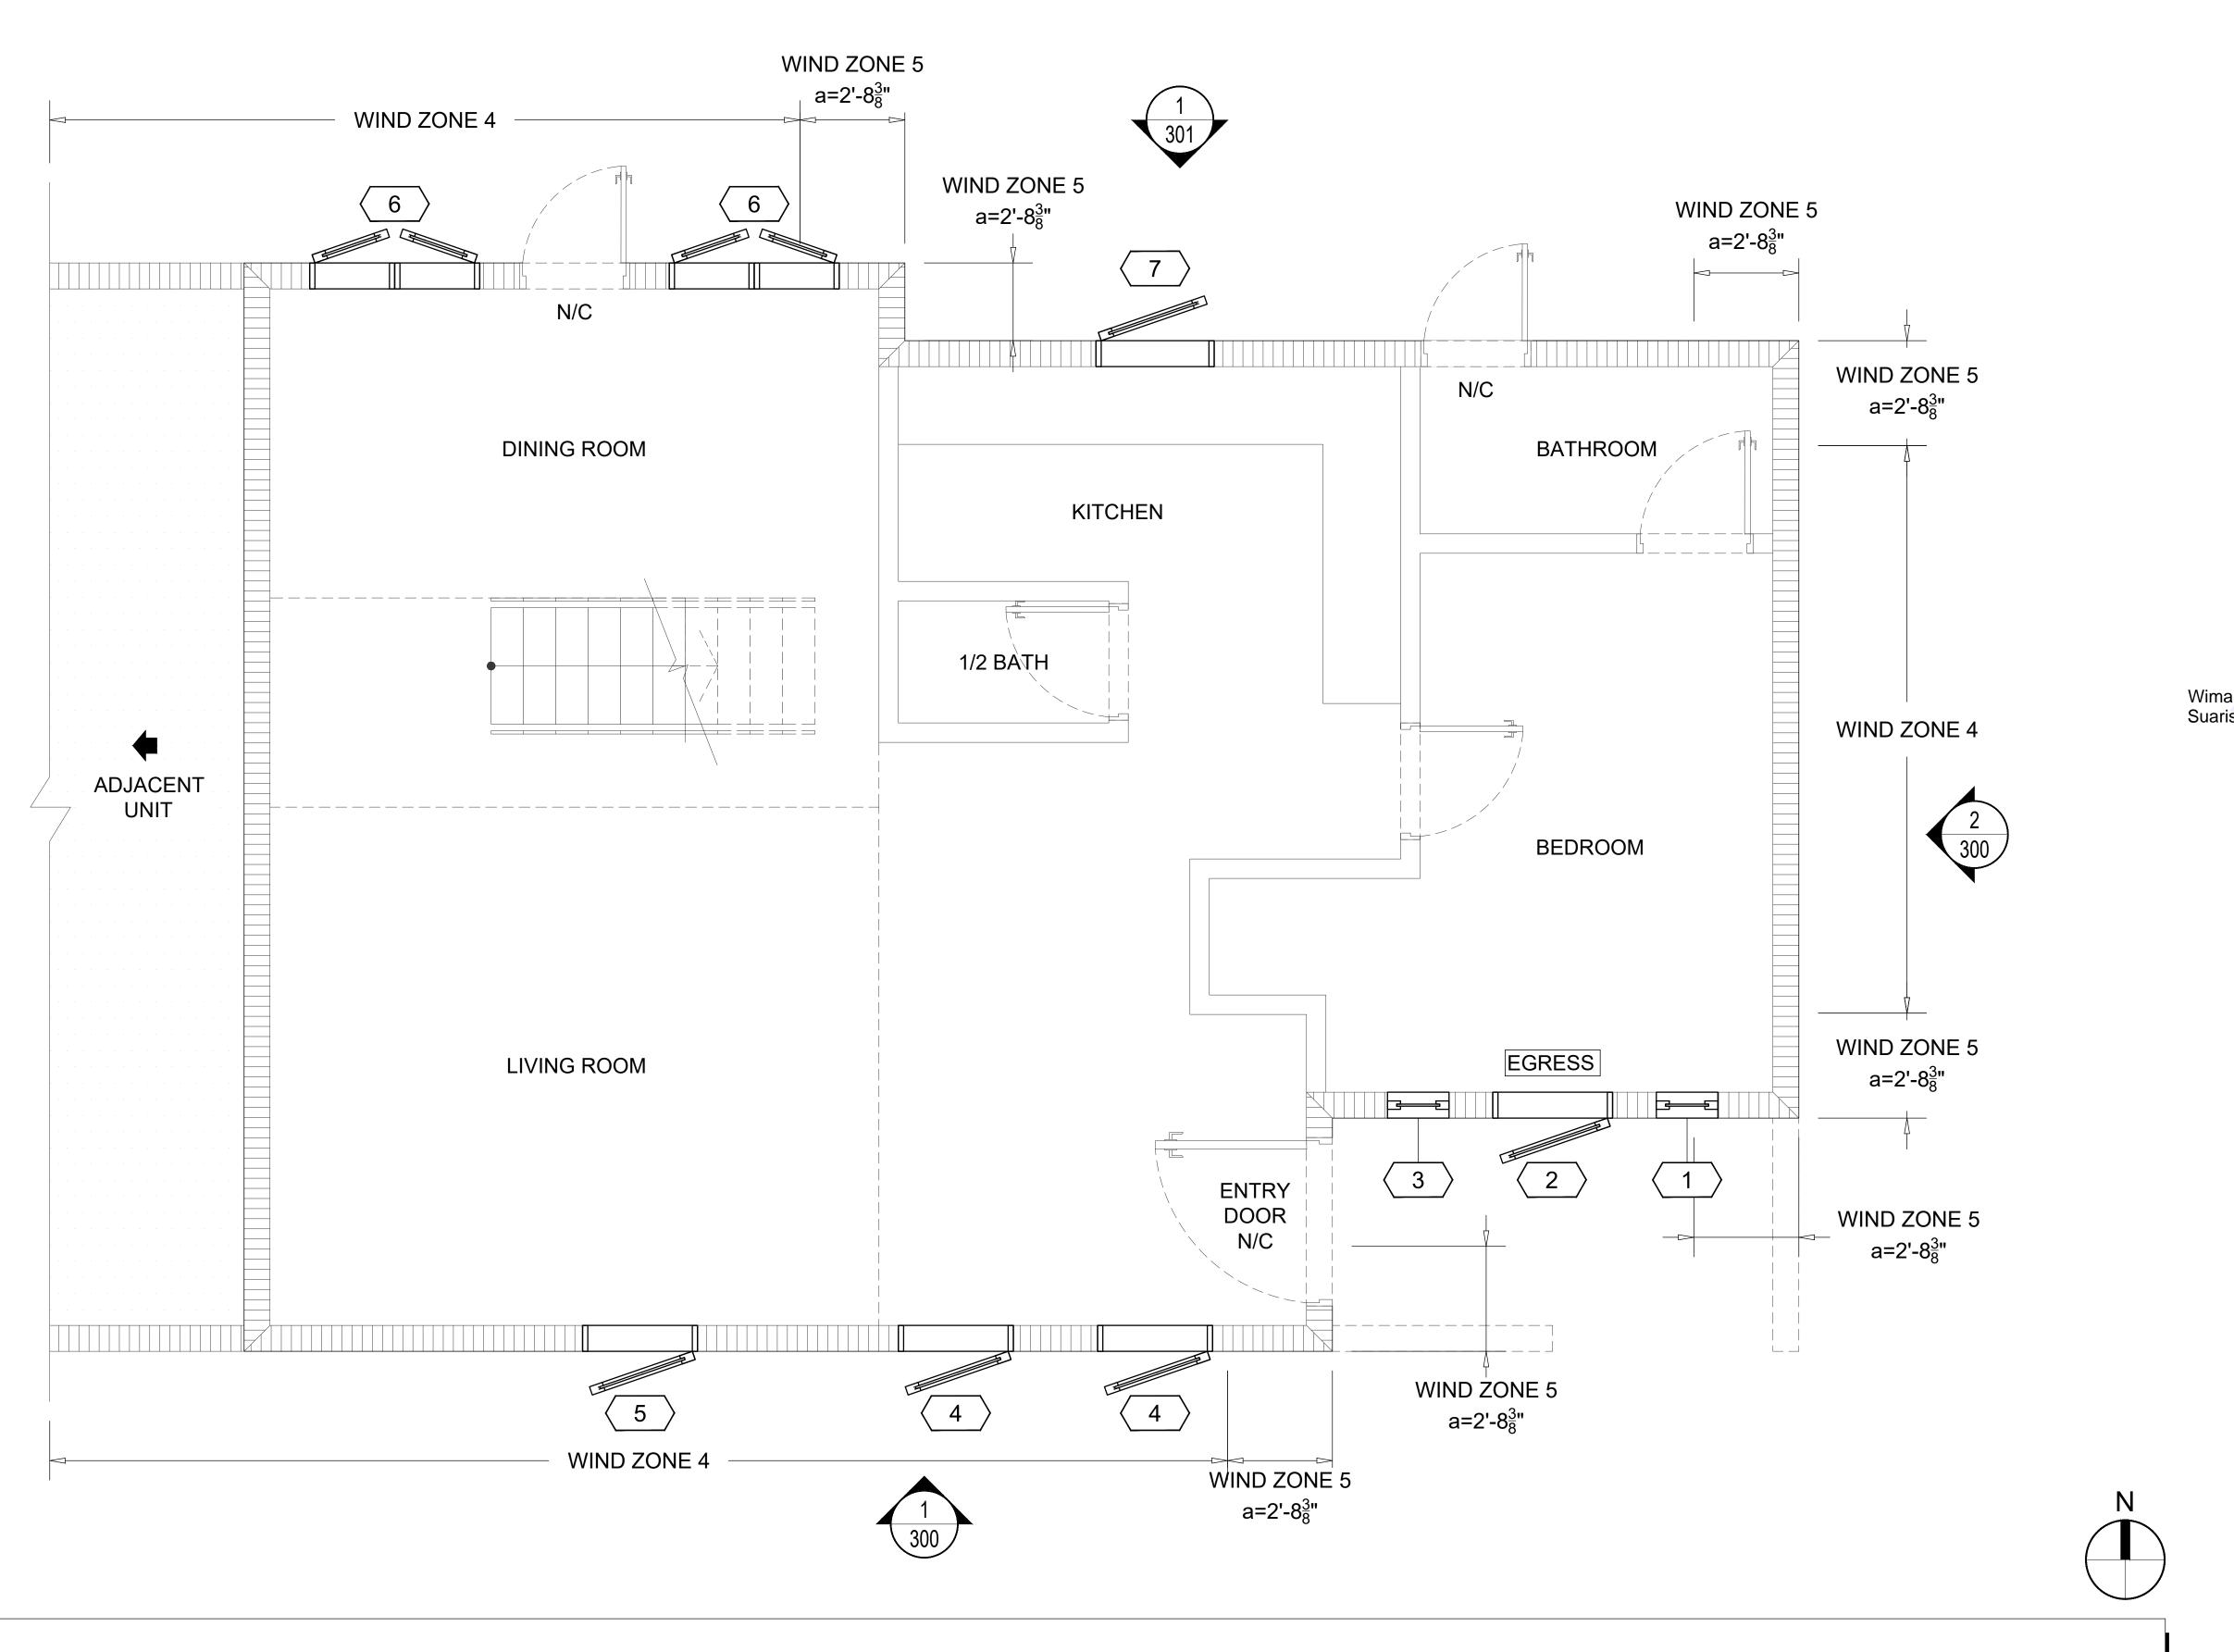

**GENERAL NOTES:** 

ONLY MARKED OPENINGS ARE PART OF THIS PERMIT.

THE MAIN WIND FORCE RESISTING SYSTEMS OF THE STRUCTURE (i.e. BEAMS, COLUMNS, FRAMING, ETC) IS NOT TO BE ALTERED. ANY ALTERATIONS TO THOSE SYSTEMS SHALL BE DESIGNED OR CHECKED BY OTHERS TO WITHSTAND ANY STRUCTURAL LOADS, NO CALCULATIONS HAVE BEEN PERFORMED TO VERIFY THE ADEQUACY OF THE EXISTING STRUCTURE.

FIRST FLOOR PLAN (AS REFERENCE ONLY) 200 SCALE


7/16"=1'0"

WIMAL SUARIS, P.E PE# 37369 CA# 28476

200

DRAWING NO. SD24-143

CHECKED BY JRO

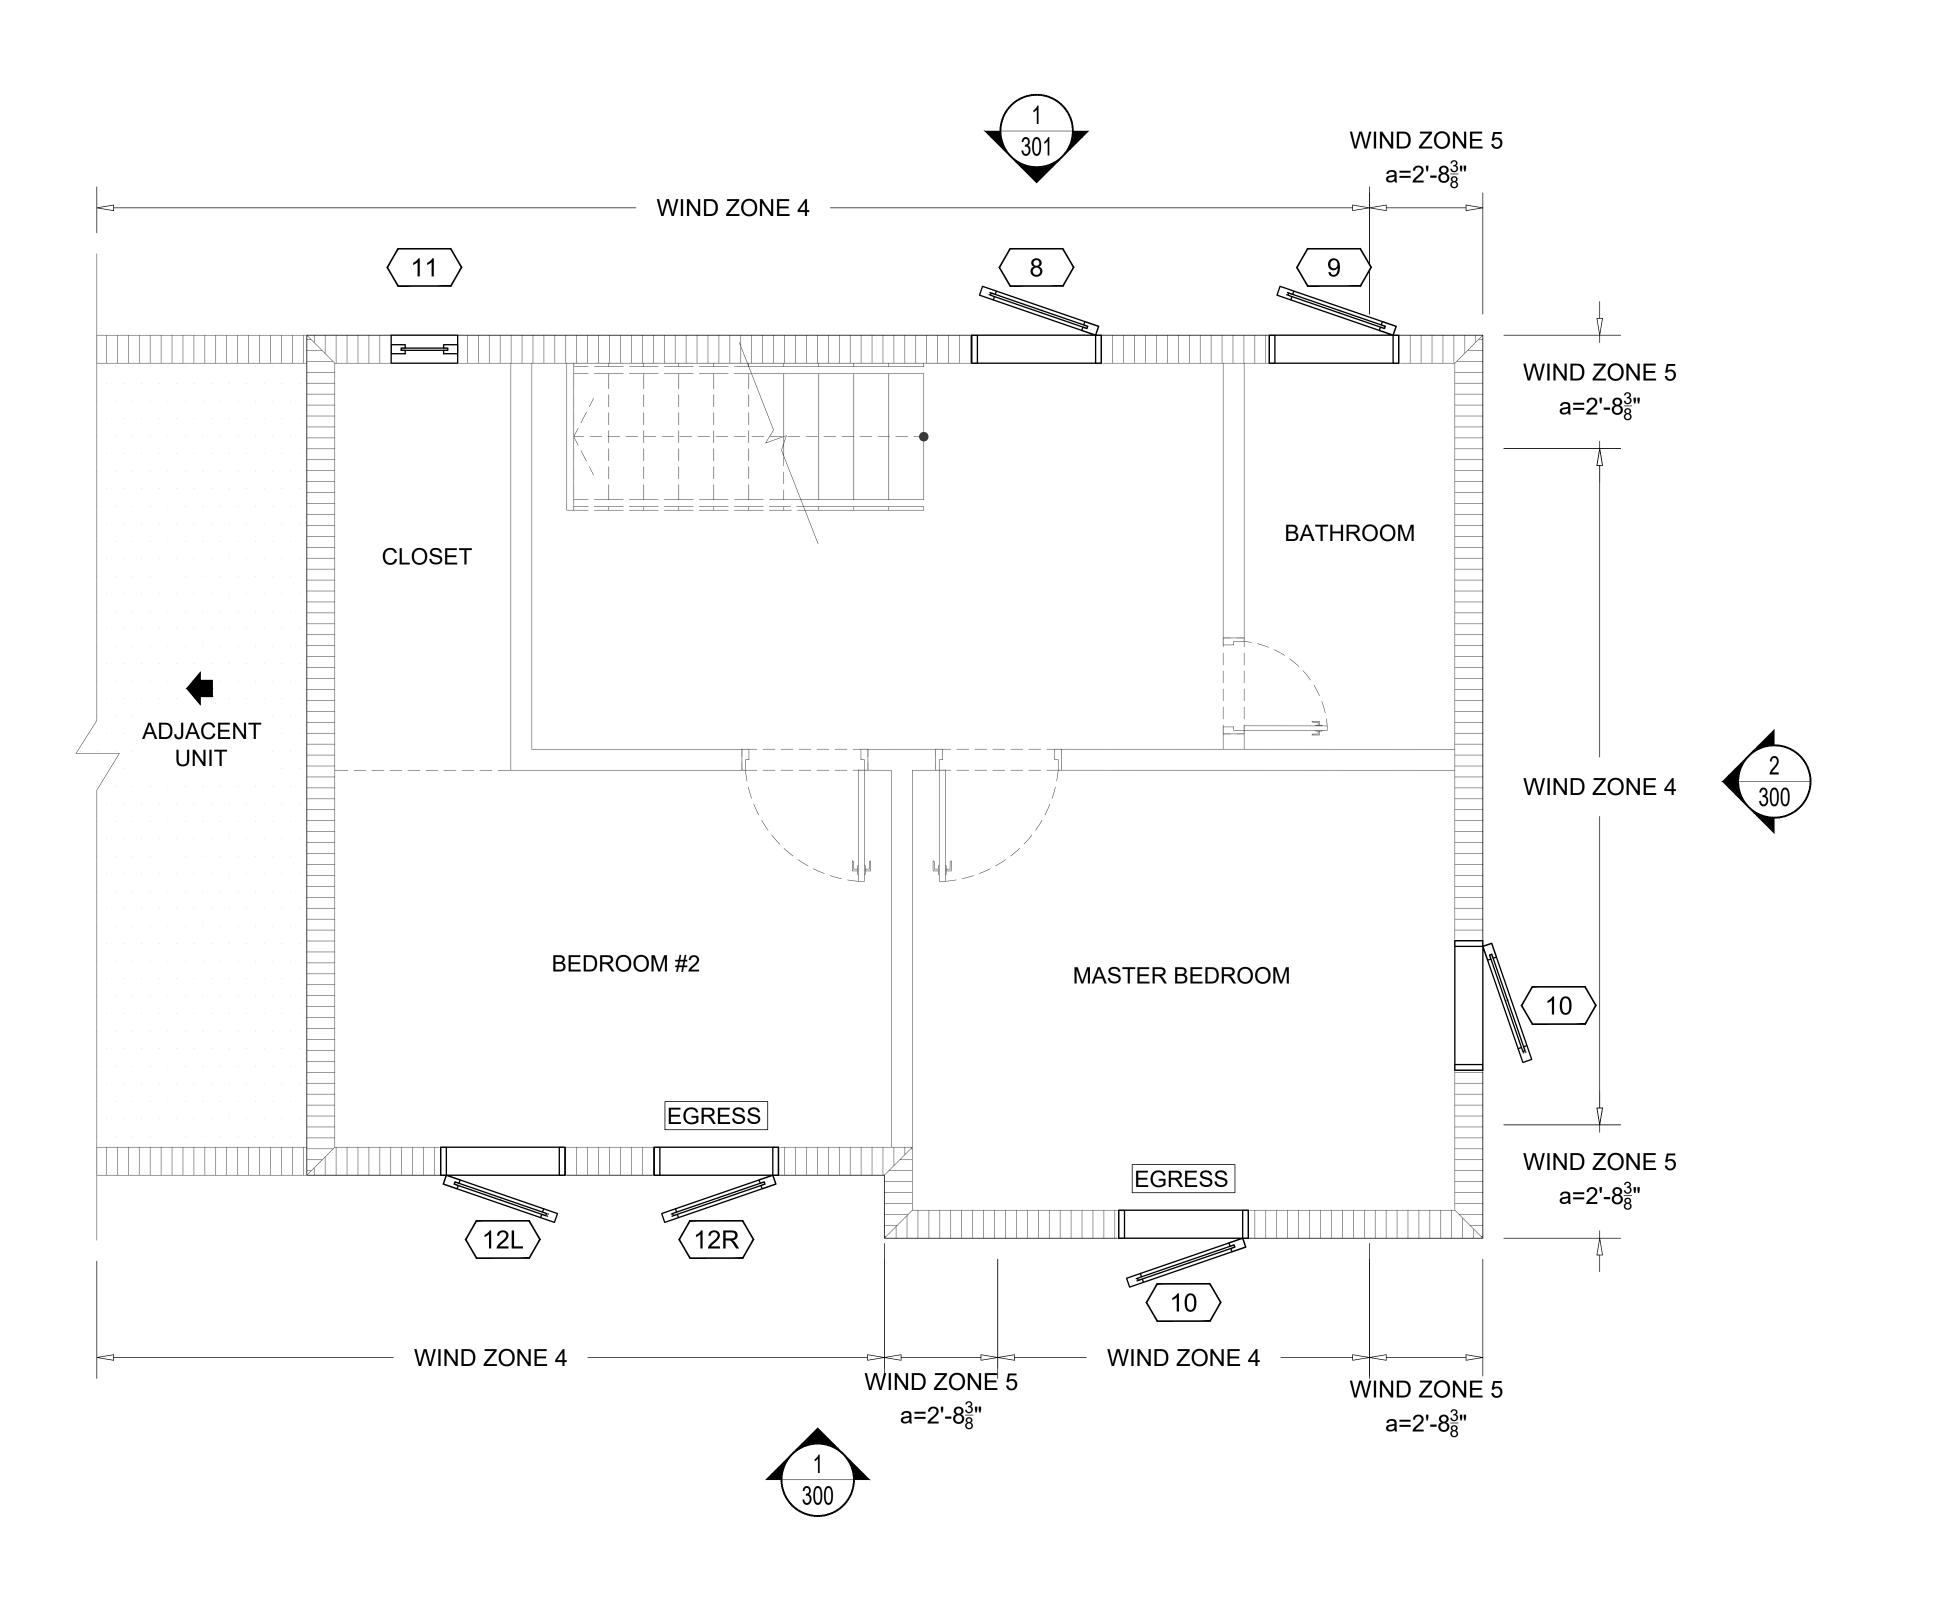



WIMAL SUARIS, P.E. PE# 37369 CA# 28476


SECOND FLOOR PLAN (AS REFERENCE ONL)

DRAWING NO. SD24-143

201

## **GENERAL NOTES:**

- ONLY MARKED OPENINGS ARE PART OF THIS PERMIT.
- THE MAIN WIND FORCE RESISTING SYSTEMS OF THE STRUCTURE (i.e. BEAMS, COLUMNS, FRAMING, ETC) IS NOT TO BE ALTERED. ANY ALTERATIONS TO THOSE SYSTEMS SHALL BE DESIGNED OR CHECKED BY OTHERS TO WITHSTAND ANY STRUCTURAL LOADS, NO CALCULATIONS HAVE BEEN PERFORMED TO VERIFY THE ADEQUACY OF THE EXISTING STRUCTURE.
- SECOND FLOOR PLAN (AS REFERENCE ONLY)

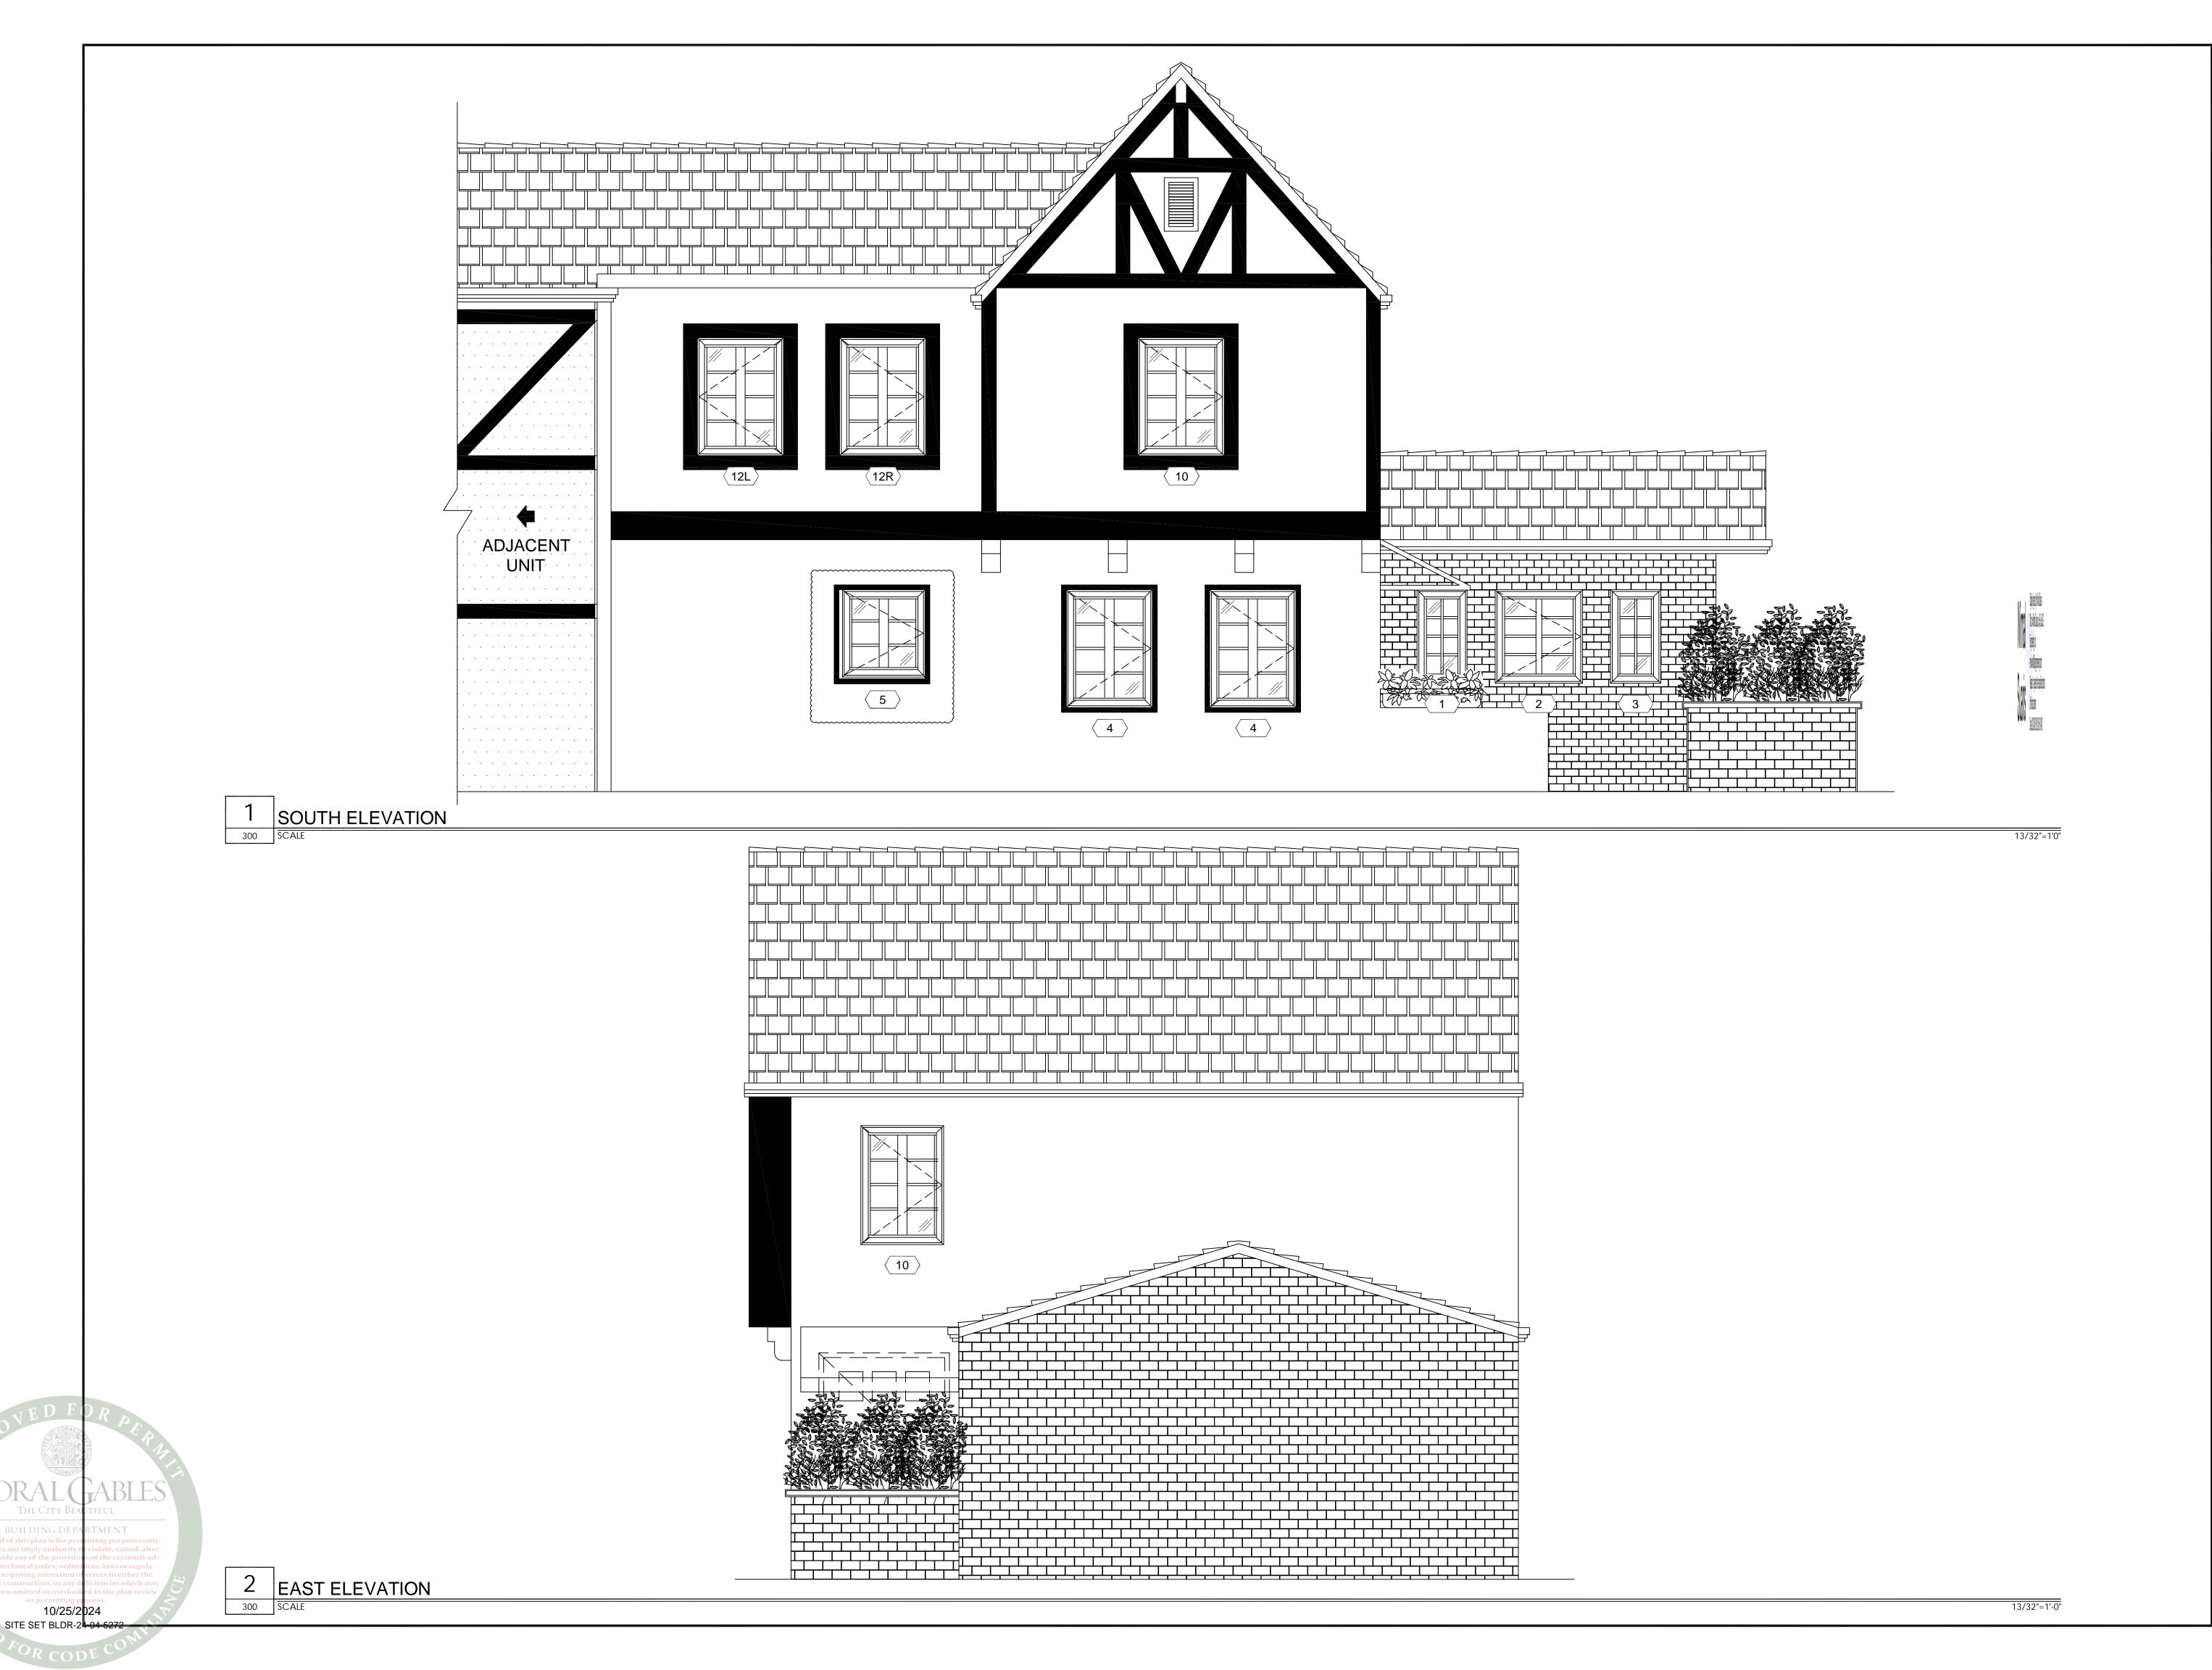

**REVISIONS** 

WIMAL SUARIS, P.E PE# 37369 CA# 28476

**ELEVATION** 

HARRIS LEVINE RESIDENCE 405 VISCAYA AVENUE CORAL GABLES, FLORIDA 33

SOUTH & EAST E
PATRIOT WINDOWS
& DOORS
6175 NW 167TH STREET
MIAMI LAKES, FL 33015
C

DATE	03/19/2024
SCALE	13/32"=1'-0"
ORAWN	AA
CHECKED BY	JRO
PROJECT	24-143


DRAWING NO. SD24-143

SHEET 300




NORTH ELEVATION

ACTUAL DOUBLE CASEMENT FRAME

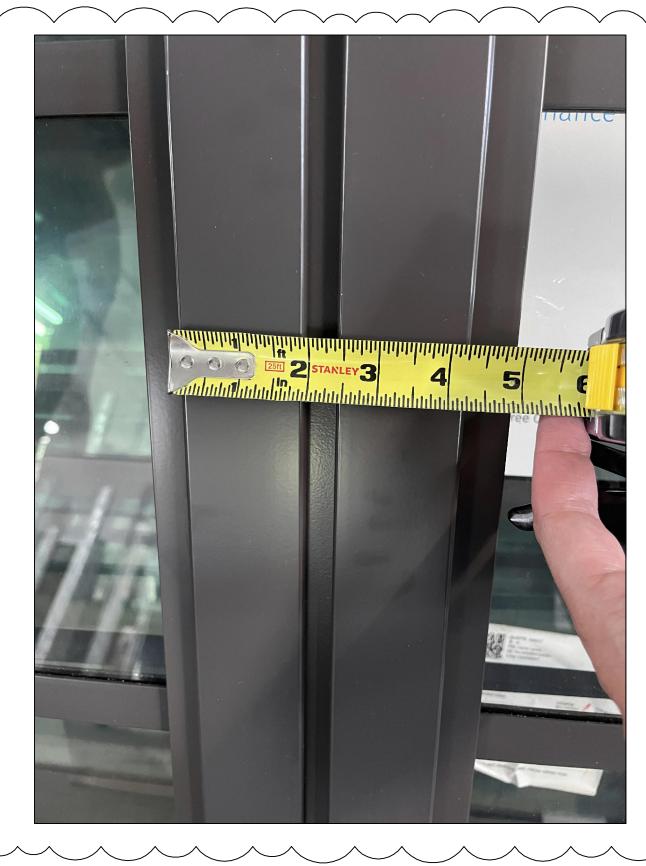




PROPOSED SURFACE APPLIED MUNTIN (APPARENT COLOR DIFFERENCE DUE TO DIFFERENT LIGHTING CONDITIONS)

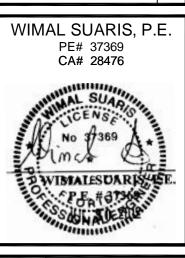

DATE	03/19/2024
SCALE	13/32"=1'-0"
DRAWN	AA
CHECKED BY	JRO
PROJECT	24-143

SD24-143

301

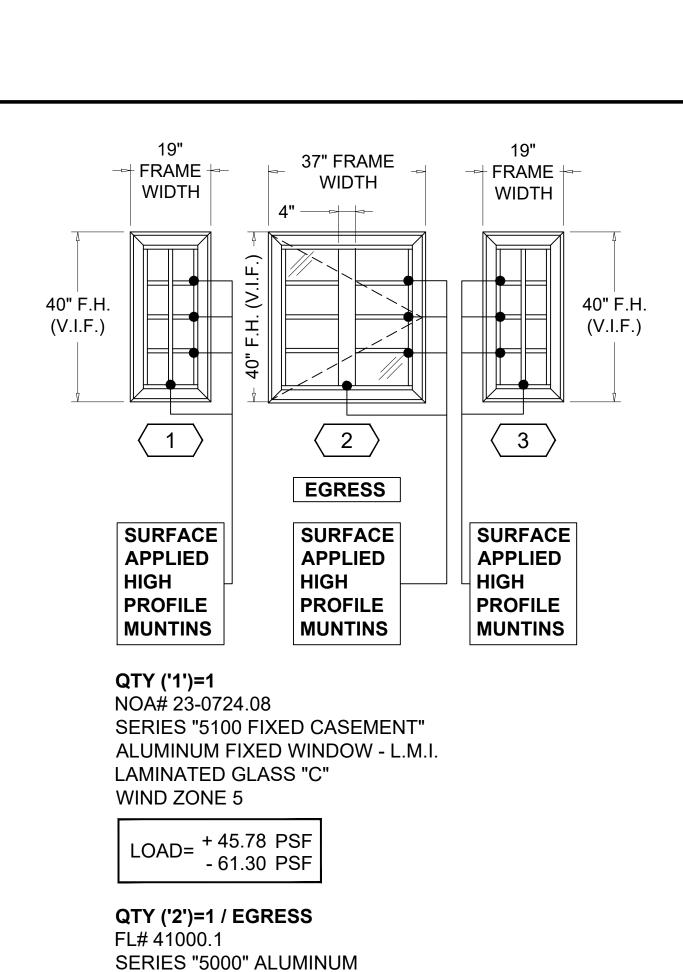

CASEMENT WINDOW - L.M.I.

-49.66 PSF

SERIES "5100 FIXED CASEMENT" ALUMINUM FIXED WINDOW - L.M.I.

LAMINATED GLASS "A"

LOAD= + 45.78 PSF

LAMINATED GLASS "C"

LOAD= +45.78 PSF

- 49.66 PSF

4" ———

37" FRAME

**WIDTH** 

9

SURFACE

APPLIED

PROFILE

MUNTINS

SERIES "5000" ALUMINUM

LAMINATED GLASS "A"

LOAD= +45.78 PSF

CASEMENT WINDOW - L.M.I.

-61.30 PSF

WIND ZONE 4


QTY ('3')=1

NOA# 23-0724.08

WIND ZONE 4

39" F.H.

(V.I.F.)

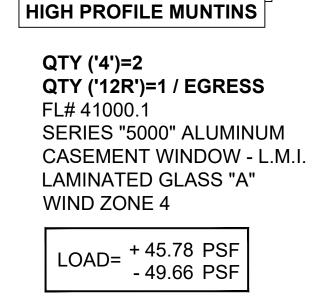

SURFACE APPLIED

35½" FRAME


WIDTH


 $\langle 12R \rangle$ 

EGRESS

50" F.H.

(V.I.F.)

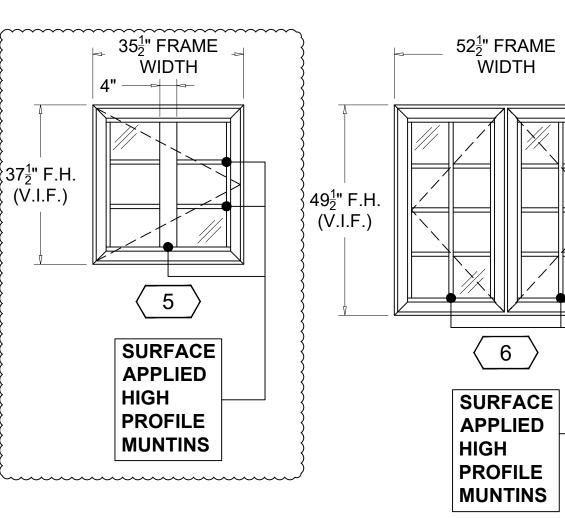


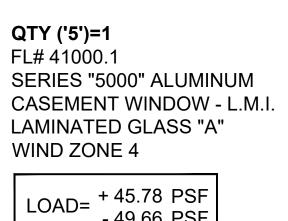

- 49.66 PSF


QTY ('6')=2 FL# 41000.1 SERIES "5000" ALUMINUM CASEMENT WINDOW - L.M.I. LAMINATED GLASS "A" WIND ZONE 5

LOAD= +45.78 PSF | - 61.30 PSF

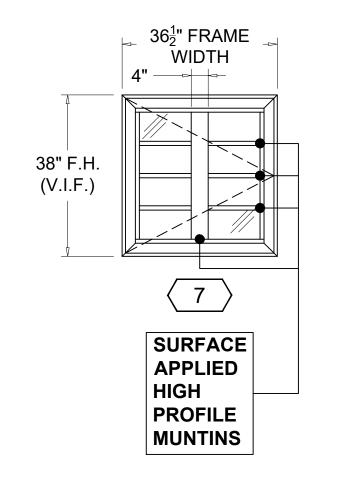


QTY ('7')=1 FL# 41000.1 SERIES "5000" ALUMINUM CASEMENT WINDOW - L.M.I. LAMINATED GLASS "A" WIND ZONE 4

LOAD= +45.78 PSF | -49.66 PSF

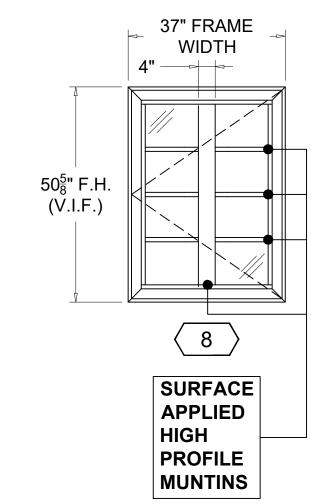

QTY ('8')=1 FL# 41000.1 SERIES "5000" ALUMINUM CASEMENT WINDOW - L.M.I. LAMINATED GLASS "A" WIND ZONE 4

LOAD= +45.78 PSF - 49.66 PSF

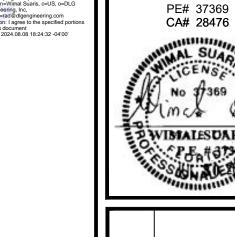

Suaris

REVISIONS

WIMAL SUARIS, P.E


OPENING PATRIOT WINDOWS & DOORS 6175 NW 167TH STREET MIAMI LAKES, FL 33015

> 03/19/2024 9/16"=1'-0" SCALE DRAWN CHECKED BY JRO PROJECT 24-143

> > DRAWING NO. SD24-143


> > > SHEET 400

NOTE: **REFER TO PICTURE ON SHEET 301** 4" THICK MUNTIN ^^^^^^

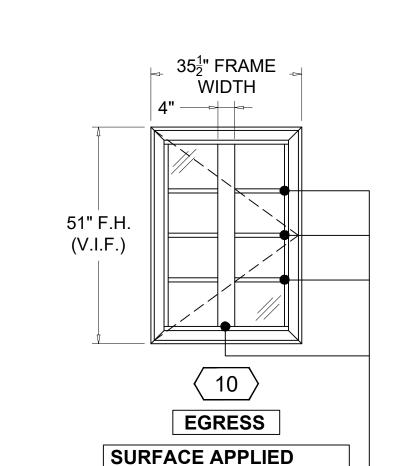


HIGH PROFILE MUNTINS QTY ('10')=2 / EGRESS FL# 41000.1 SERIES "5000" ALUMINUM CASEMENT WINDOW - L.M.I. LAMINATED GLASS "A" WIND ZONE 4

+ 45.78 PSF - 49.66 PSF

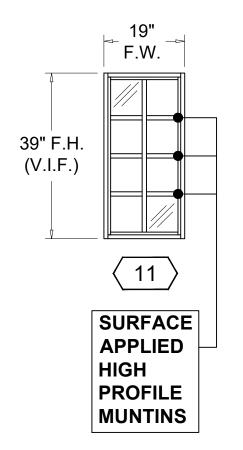

QTY ('11')=1 NOA# 23-0714.17 SERIES "EL-150" ALUMINUM FIXED WINDOW - L.M.I. LAMINATED GLASS "B" WIND ZONE 4

LOAD= +45.78 PSF - 49.66 PSF

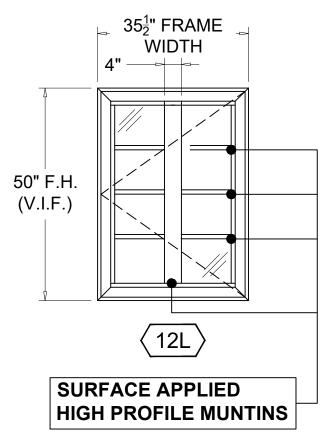

QTY ('12L')=1 FL# 41000.1 **SERIES "5000" ALUMINUM** CASEMENT WINDOW - L.M.I. LAMINATED GLASS "A" WIND ZONE 4

LOAD= +45.78 PSF -49.66 PSF

10/25/2024 SITE SET BLDR-24-04-5272 **OPENING ELEVATIONS** 

QTY ('9')=1

FL# 41000.1

WIND ZONE 5

ES-1015 / OG MUNTIN

MUNTIN DETAIL

NOTE:

FRAME COLOR: AAMA 2604 BRONZE **GLASS COLOR: CLEAR / NO TINT / NO REFLECTIVITY** 





SD24-143

500

WIMAL SUARIS, P.E.
PE# 37369
CA# 28476

REVISIONS

PHOTOGRAPHS
PATRIOT WINDOWS
& DOORS
6175 NW 167TH STREET
MIAMI LAKES, FL 33015
CORAL GABLE

03/19/2024


DRAWING NO.

CHECKED BY JRO PROJECT 24-143

SCALE

DRAWN




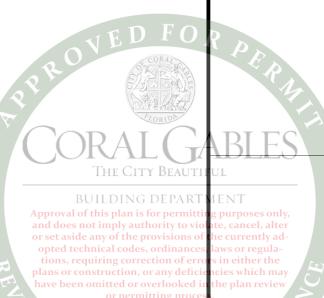

NORTH
501 SCALE

SD24-143

REVISIONS

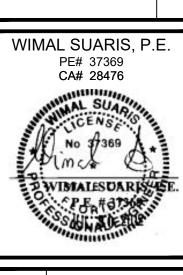

PHOTOGRAPHS


PATRIOT WINDOWS
& DOORS
6175 NW 167TH STREET
MIAMI LAKES, FL 33015
CORAL GABL

03/19/2024 SCALE DRAWN CHECKED BY JRO PROJECT 24-143

DRAWING NO.

SHEET **501** 



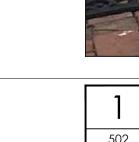

10/25/2024 SITE SET BLDR-24-04-5272

SD24-143

CHECKED BY JRO PROJECT 24-143

SCALE

DRAWN

PATRIOT WINDOWS
& DOORS
6175 NW 167TH STREET
MIAMI LAKES, FL 33015
CORAL GABL

SHEET **502** 

DRAWING NO.

REVISIONS

WIMAL SUARIS, P.E.
PE# 37369
CA# 28476

NORTH
502 SCALE

# PATRIOT WINDOWS AND DOORS

# GLAZING SYSTEMS HARRIS LEVINE RESIDENCE 405 VISCAYA AVENUE, CORAL GABLES, FLORIDA 33134

## DESIGN CRITERIA

2023 FLORIDA BUILDING CODE SEVENTH EDITION WIND LOADS PER ASCE 7-22:

> -BASIC WIND SPEED: 175 MPH -EXPOSURE CATEGORY: -WIND DIRECTIONAL FACTOR KD: .85

### GENERAL NOTES

- 1. ANCHORS SHALL BE AS LISTED, SPACED AS SHOWN ON DETAILS.
- 2. EMBEDMENT TO BASE MATERIAL SHALL BE BEYOND WALL FINISHES OR STUCCO.
- 3. MATERIALS INCLUDING BUT NOT LIMITED TO STEEL/ALUMINUM, THAT COME IN CONTACT WITH OTHER DISSIMILAR MATERIALS SHALL MEET THE REQUIREMENTS OF THE 2023 FLORIDA BUILDING CODE SECTION 2003.8.4
- 4. ALL STEEL PLATES TO BE A36, ALL STEEL TUBING TO BE A500, GRADE B (Fy=46KSI).
- 5. ALL WELDING TO BE PER THE AWS SPECIFICATIONS.
- 6. ALL ALUMINUM TO BE 6061-T6, AS PER SPECIFICATION 2 OF THE ALUMINUM DESIGN MANUAL.
- 7. WOOD BUCKS TO BE 1X OR 2X FULL DEPTH OF GLAZING FRAMES TO SUBSTRATE AS FOLLOWS: 1/4" TAPCON WITH 1-3/4" EMBED @ 12" O.C. INTO CONCRETE OR #14 SMS/TEKS @ 12" O.C. INTO METAL. PROVIDE CLUSTER OF [2] AT JAMB ENDS AND EACH SIDE OF MULLION, AND MUST ADHERE TO EDGE DISTANCE AND SPACING LIMITATIONS.
- 8. DLGE WILL NOT PROVIDE A STATEMENT OF INSPECTION UNLESS CALLED PRIOR TO INSTALLATION.
- 9. SHOP DRAWING COVER STRUCTURAL REQUIREMENTS ONLY.
- 10. ALL WINDOW OPENINGS IDENTIFIED AS EGRESS SHALL BE UNOBSTUCTED AND SHALL HAVE A MINIMUM NET CLEAR OPENING HEIGHT OF 24", A NET CLEAR OPENING WIDTH OF 20" AND A MINIMUM NET CLEAR OPENING AREA OF 5.7 S.F. (5.0 S.F. FOR GRADE LEVEL WINDOWS).
- 11. ALL EGRESS WINDOWS SHALL HAVE A SILL HEIGHT NOT TO EXCEED 44" ABOVE FINISHED FLOOR
- 12. ALL WINDOWS SHALL NOT HAVE A SILL HEIGHT LESS THAN 36" ABOVE FINISHED FLOOR, UNLESS A CODE APPROVED PROTECTIVE BARRIER IS PROVIDED (BY OTHERS).
- 13. IT IS THE EXCLUSIVE RESPONSIBILITY OF THE WINDOW COMPANY TO PROVIDE PRODUCTS THAT MEET OR EXCEED THE ENERGY VALUES MANDATED BY THE STATE OF FLORIDA. COMPLIANCE WITH ENERGY REQUIREMENTS IS BEYOND THE SCOPE OF THESE
- 14. ALL SHIMS TO BE AS PER PRODUCT APPROVALS.
- 15. G.C. TO PROVIDE OR REPLACE FIRE PROTECTION ON ALL STRUCTURAL MEMBERS, NEW AND EXISTING, AS NECESSARY, TO MEET FIRE RATING REQUIREMENTS BY APPLICABLE CODES

ONLY MARKED UNITS ARE PART OF THE SCOPE. FULL SCOPE MAY NOT COVER FULL ENVELOPE OF THE BUILDING / RESIDENCE. DLGE NOT RESPONSIBLE FOR THE FULL ENVELOPE OF THE BUILDING / RESIDENCE.

SCOPE LIMITED TO GLAZING PRODUCTS AND ANCHORAGE CHECK

GC IS RESPONSIBLE TO VERIFY THAT THE SUBSTRATES MEET THE REQUIREMENTS SPECIFIED IN PRODUCT APPROVALS AND DETAILS IN THIS DRAWINGS.

## GLAZING SYSTEMS

A. <u>FIXED WINDOW - LARGE MISSILE IMPACT</u> NOA# 23-0724.08

SERIES "5100 FIXED CASEMENT" ALUMINUM FIXED WINDOW - L.M.I. MANUFACTURER: E.S. WINDOWS, LLC FINISH: AAMA 2604 BRONZE

GLAZED WITH: GLASS TYPE "C" 3/8" THICK OVERALL LAMINATED GLASS

OUTBOARD: 5/32" CLEAR HEAT-STRENGTHENED GLASS INTERLAYER: 0.090" CLEAR INTERLAYER TROSIFOL PVB BY 'KURARAY AMERICA, INC.' 1/8" CLEAR HEAT-STRENGTHENED GLASS

B. <u>CASEMENT WINDOW - LARGE MISSILE IMPACT</u>

SERIES "5000" ALUMINUM CASEMENT WINDOW - L.M.I. MANUFACTURER: E.S. WINDOWS, INC FINISH: AAMA 2604 BRONZE

GLAZED WITH: GLASS TYPE "A"

5/16" THICK OVERALL LAMINATED GLASS OUTBOARD: 1/8" CLEAR HEAT-STRENGTHENED GLASS INTERLAYER: 0.090" CLEAR INTERLAYER TROSIFOL PVB BY 'KURARAY AMERICA, INC.' 1/8" CLEAR HEAT-STRENGTHENED GLASS

C. <u>FIXED WINDOW - LARGE MISSILE IMPACT</u>

NOA# 23-0714.17 SERIES "EL-150" ALUMINUM FIXED WINDOW - L.M.I. MANUFACTURER: E.S. WINDOWS, LLC

FINISH: AAMA 2604 BRONZE

GLAZED WITH: GLASS TYPE "B" 7/16" THICK OVERALL LAMINATED GLASS


OUTBOARD: 3/16" CLEAR HEAT-STRENGTHENED GLASS

INTERLAYER: 0.090" CLEAR INTERLAYER TROSIFOL PVB BY 'KURARAY AMERICA, INC.' INBOARD: 3/16" CLEAR HEAT-STRENGTHENED GLASS

INDEX	OF DRAWINGS
SHEET	SHEET TITLE
000	GENERAL NOTES AND SITE LOCATION
100	WINDOW & DOOR SCHEDULE
200	FIRST FLOOR PLAN (AS REFERENCE ONLY)
201	SECOND FLOOR PLAN (AS REFERENCE ONLY)
300	SOUTH & EAST ELEVATION
301	NORTH ELEVATION
400	OPENING ELEVATIONS
500-502	PHOTOGRAPHS





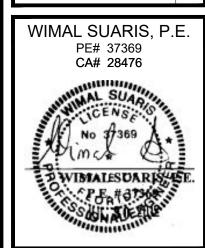

AND

PATRIOT WINDOWS & DOORS 6175 NW 167TH STREET MIAMI LAKES, FL 33015


GENERAL NOTE

03/19/2024
AS NOTED
AA
JRO
24-143

DRAWING NO. SD24-143

ABB	reviations										
@	AT	DWG.	DRAWING	MIN.	MINIMUM	N.I.C.	NOT IN CONTRACT	SMS	SHEET METAL SCREW	SYSTEM	ABBREVIATIONS
ALUM.	ALUMINUM	EA.	EACH	MIR.	MIRROR	O.C.	ON CENTER	STL.	STEEL		
ATT.	ATTACHED	E.DIST.	EDGE DISTANCE	MTL.	METAL	O.D.	OUTSIDE DIAMETER	STRUCT.	STRUCTURE	CW	CURTAIN WAL
BLDG.	BUILDING	EMBED.	EMBEDMENT	N.I.C.	NOT IN CONTRACT	OPG.	OPENING	THK.	THICK	ED	ENTRANCE DO
вот.	ВОТТОМ	FXIST.	EXISTING	HORIZ.	HORIZONTAL	P.T.	PRESSURE TREATED	TYP.	TYPICAL	FX	FIXED WINDO
0.0	OFNITED TO OFNITED		EDAME DIMENSION	1100	HOLLLOW CTDUCTUDAL CECTION	DI	DIATE	LLON	LINILECC OTLIEDWICE	1.18.4	LIQULOW MET

DOOR DOW HOLLOW METAL DOOR CENTER TO CENTER PLATE UNLESS OTHERWISE RADIUS CENTER LINE HEIGHT M.O. MASONRY OPENING HORIZONTAL ROLLER WINDOW HORIZ. VERIFY IN FIELD HORIZONTAL ROUGH OPENING LOUVER MATERIAI VERT. HSS REINF. REINFORCEMENT VERTICAL STOREFRONT COLUMN HOLLLOW STRUCTURAL SECTION CONCRETE М.О. MASONRY OPENING WIDTH SLIDING GLASS DOOR MANUFACTURER REINF'D REINFORCED CONTINUOUS SINGLE HUNG MAT'L. WITH MATERIAL MINIMUM REQ'D. REQUIRED SKYLIGHT MIR. MAX. MAXIMUM MIRROR SIM. WD. WOOD SIMILAR WINDOW WALL DIA. DIAMETER MANUFACTURER METAL SLOPE

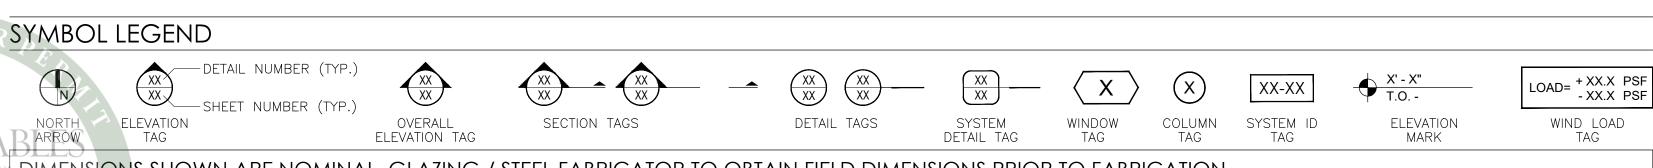

DIMENSIONS SHOWN ARE NOMINAL, GLAZING / STEEL FABRICATOR TO OBTAIN FIELD DIMENSIONS PRIOR TO FABRICATION

THE EXISTING STRUCTURE AND SUBSTRATE SHOULD BE VERIFIED, BY OTHERS, TO SUPPORT THE LOADS IMPOSED BY THE GLAZING SYSTEM

CONTRACTOR TO REPORT ANY DEVIATIONS BETWEEN FIELD CONDITIONS AND DETAILS SHOWN ON THESE DRAWINGS TO DLG ENGINEERING PRIOR TO

SITE LOCATION

Wood St

									WINDOW & DOOR SCHEDULE		
MARK	QTY.	GLASS TYPE	O.A. FRAME SIZE (W X H)	WIND ZONE	DESIGN PER ASO		ALLOWABL PER APP		PRODUCT DESCRIPTION	NOA No. / FL No.	REMARKS
		1116		ZONE	(+)PSF	(-)PSF	(+)PSF	(-)PSF			
1	1	С	19.0" X 40.0"	5	45.78	61.30	90.0	90.0	SERIES "5100 FIXED CASEMENT" ALUMINUM FIXED WINDOW - L.M.I.	NOA# 23-0724.08	O CONFIGURATION / FLANGE FRAME / MUNTIN DETAILS: GRID, (1) LITE ACROSS, (3) LITES DOWN, ES1014 INTERNAL AND EXTERNAL STYLE / FINISH: AAMA 2604 BRONZE
2	1	А	37.0" X 40.0"	4	45.78	49.66	85.0	85.0	SERIES "5000" ALUMINUM CASEMENT WINDOW - L.M.I.	FL# 41000.1	XR CONFIGURATION / FLANGE FRAME / MULTIPOINT LOCK / MUNTIN DETAILS: GRID, (2) LITES ACROSS, (3) LITES DOWN, ES1014 INTERNAL AND EXTERNAL STYLE / FINISH: AAMA 2604 BRONZE
3	1	С	19.0" X 40.0"	4	45.78	49.66	90.0	90.0	SERIES "5100 FIXED CASEMENT" ALUMINUM FIXED WINDOW - L.M.I.	NOA# 23-0724.08	O CONFIGURATION / FLANGE FRAME / MUNTIN DETAILS: GRID, (1) LITE ACROSS, (3) LITES DOWN, ES1014 INTERNAL AND EXTERNAL STYLE / FINISH: AAMA 2604 BRONZE
4	2	А	35-1/2" X 50.0"	4	45.78	49.66	85.0	85.0	SERIES "5000" ALUMINUM CASEMENT WINDOW - L.M.I.	FL# 41000.1	XR CONFIGURATION / FLANGE FRAME / MULTIPOINT LOCK / MUNTIN DETAILS: GRID, (2) LITES ACROSS, (3) LITES DOWN, ES1014 INTERNAL AND EXTERNAL STYLE / FINISH: AAMA 2604 BRONZE
5	1	А	35-1/2" X 37-1/2"	4	45.78	49.66	85.0	85.0	SERIES "5000" ALUMINUM CASEMENT WINDOW - L.M.I.	FL# 41000.1	XR CONFIGURATION / FLANGE FRAME / MULTIPOINT LOCK / MUNTIN DETAILS: GRID, (2) LITES ACROSS, (3) LITES DOWN, ES1014 INTERNAL AND EXTERNAL STYLE / FINISH: AAMA 2604 BRONZE
6	2	А	52-1/2" X 49-1/2"	5	45.78	61.30	85.0	85.0	SERIES "5000" ALUMINUM CASEMENT WINDOW - L.M.I.	FL# 41000.1	XX CONFIGURATION / FLANGE FRAME / MULTIPOINT LOCK / MUNTIN DETAILS: GRID, (1) LITES ACROSS, (4) LITES DOWN, ES1014 INTERNAL AND EXTERNAL STYLE / FINISH: AAMA 2604 BRONZE
7	1	А	36-1/2" X 38.0"	4	45.78	49.66	85.0	85.0	SERIES "5000" ALUMINUM CASEMENT WINDOW - L.M.I.	FL# 41000.1	XR CONFIGURATION / FLANGE FRAME / MULTIPOINT LOCK / MUNTIN DETAILS: GRID, (2) LITES ACROSS, (3) LITES DOWN, ES1014 INTERNAL AND EXTERNAL STYLE / FINISH: AAMA 2604 BRONZE
8	1	А	37.0" X 50-5/8"	4	45.78	49.66	85.0	85.0	SERIES "5000" ALUMINUM CASEMENT WINDOW - L.M.I.	FL# 41000.1	XL CONFIGURATION / FLANGE FRAME / MULTIPOINT LOCK / MUNTIN DETAILS: GRID, (2) LITES ACROSS, (3) LITES DOWN, ES1014 INTERNAL AND EXTERNAL STYLE / FINISH: AAMA 2604 BRONZE
9	1	В	37.0" X 39.0"	5	45.78	61.30	85.0	85.0	SERIES "5000" ALUMINUM CASEMENT WINDOW - L.M.I.	FL# 41000.1	XL CONFIGURATION / FLANGE FRAME / MULTIPOINT LOCK / MUNTIN DETAILS: GRID, (2) LITES ACROSS, (3) LITES DOWN, ES1014 INTERNAL AND EXTERNAL STYLE / FINISH: AAMA 2604 BRONZE
10	2	А	35-1/2" X 51.0"	4	45.78	49.66	85.0	85.0	SERIES "5000" ALUMINUM CASEMENT WINDOW - L.M.I.	FL# 41000.1	XR CONFIGURATION / FLANGE FRAME / MULTIPOINT LOCK / MUNTIN DETAILS: GRID, (2) LITES ACROSS, (3) LITES DOWN, ES1014 INTERNAL AND EXTERNAL STYLE / FINISH: AAMA 2604 BRONZE
11	1	В	19.0" X 39.0"	4	45.78	49.66	80.0	80.0	SERIES "EL-150" ALUMINUM FIXED WINDOW - L.M.I.	NOA# 23-0714.17	O CONFIGURATION / FLANGE FRAME / MUNTIN DETAILS: GRID, (1) LITE ACROSS, (3) LITES DOWN, ES1014 INTERNAL AND EXTERNAL STYLE / FINISH: AAMA 2604 BRONZE
12R	1	А	35-1/2" X 50.0"	4	45.78	49.66	85.0	85.0	SERIES "5000" ALUMINUM CASEMENT WINDOW - L.M.I.	FL# 41000.1	XR CONFIGURATION / FLANGE FRAME / MULTIPOINT LOCK / MUNTIN DETAILS: GRID, (2) LITES ACROSS, (3) LITES DOWN, ES1014 INTERNAL AND EXTERNAL STYLE / FINISH: AAMA 2604 BRONZE
12L	1	А	35-1/2" X 50.0"	4	45.78	49.66	85.0	85.0	SERIES "5000" ALUMINUM CASEMENT WINDOW - L.M.I.	FL# 41000.1	XL CONFIGURATION / FLANGE FRAME / MULTIPOINT LOCK / MUNTIN DETAILS: GRID, (2) LITES ACROSS, (3) LITES DOWN, ES1014 INTERNAL AND EXTERNAL STYLE / FINISH: AAMA 2604 BRONZE

1	WINDOW & DOOR SCHEDULE
100	SCALE

WIMAL SUARIS, P.E.
PE# 37369
CA# 28476

MINDOW & DOOR SCHEDULE


PATRIOT WINDOWS
& DOORS
6175 NW 167TH STREET
MIAMI LAKES, FL 33015
CORAL GABLES. FLORIDA

ATE	03/19/2024
CALE	AS NOTED
RAWN	AA
HECKED BY	JRO
ROJECT	24-143

DRAWING NO. SD24-143

100

CORAL GABLES THE CITY BEAUTIFUL	
Approval of this plan is for permitting purposes only, and does not imply authority to violate, cancel, alter or set aside any of the provisions of the currently adopted technical codes, ordinances, laws or regulations, requiring correction of errors in either the plans or construction, or any deficiencies which may have been omitted or overlooked in the plan review or permitting process.  10/25/2024  SITE SET BLDR-24-04-5272	
SITE SET BLDR-24-04-5272	_

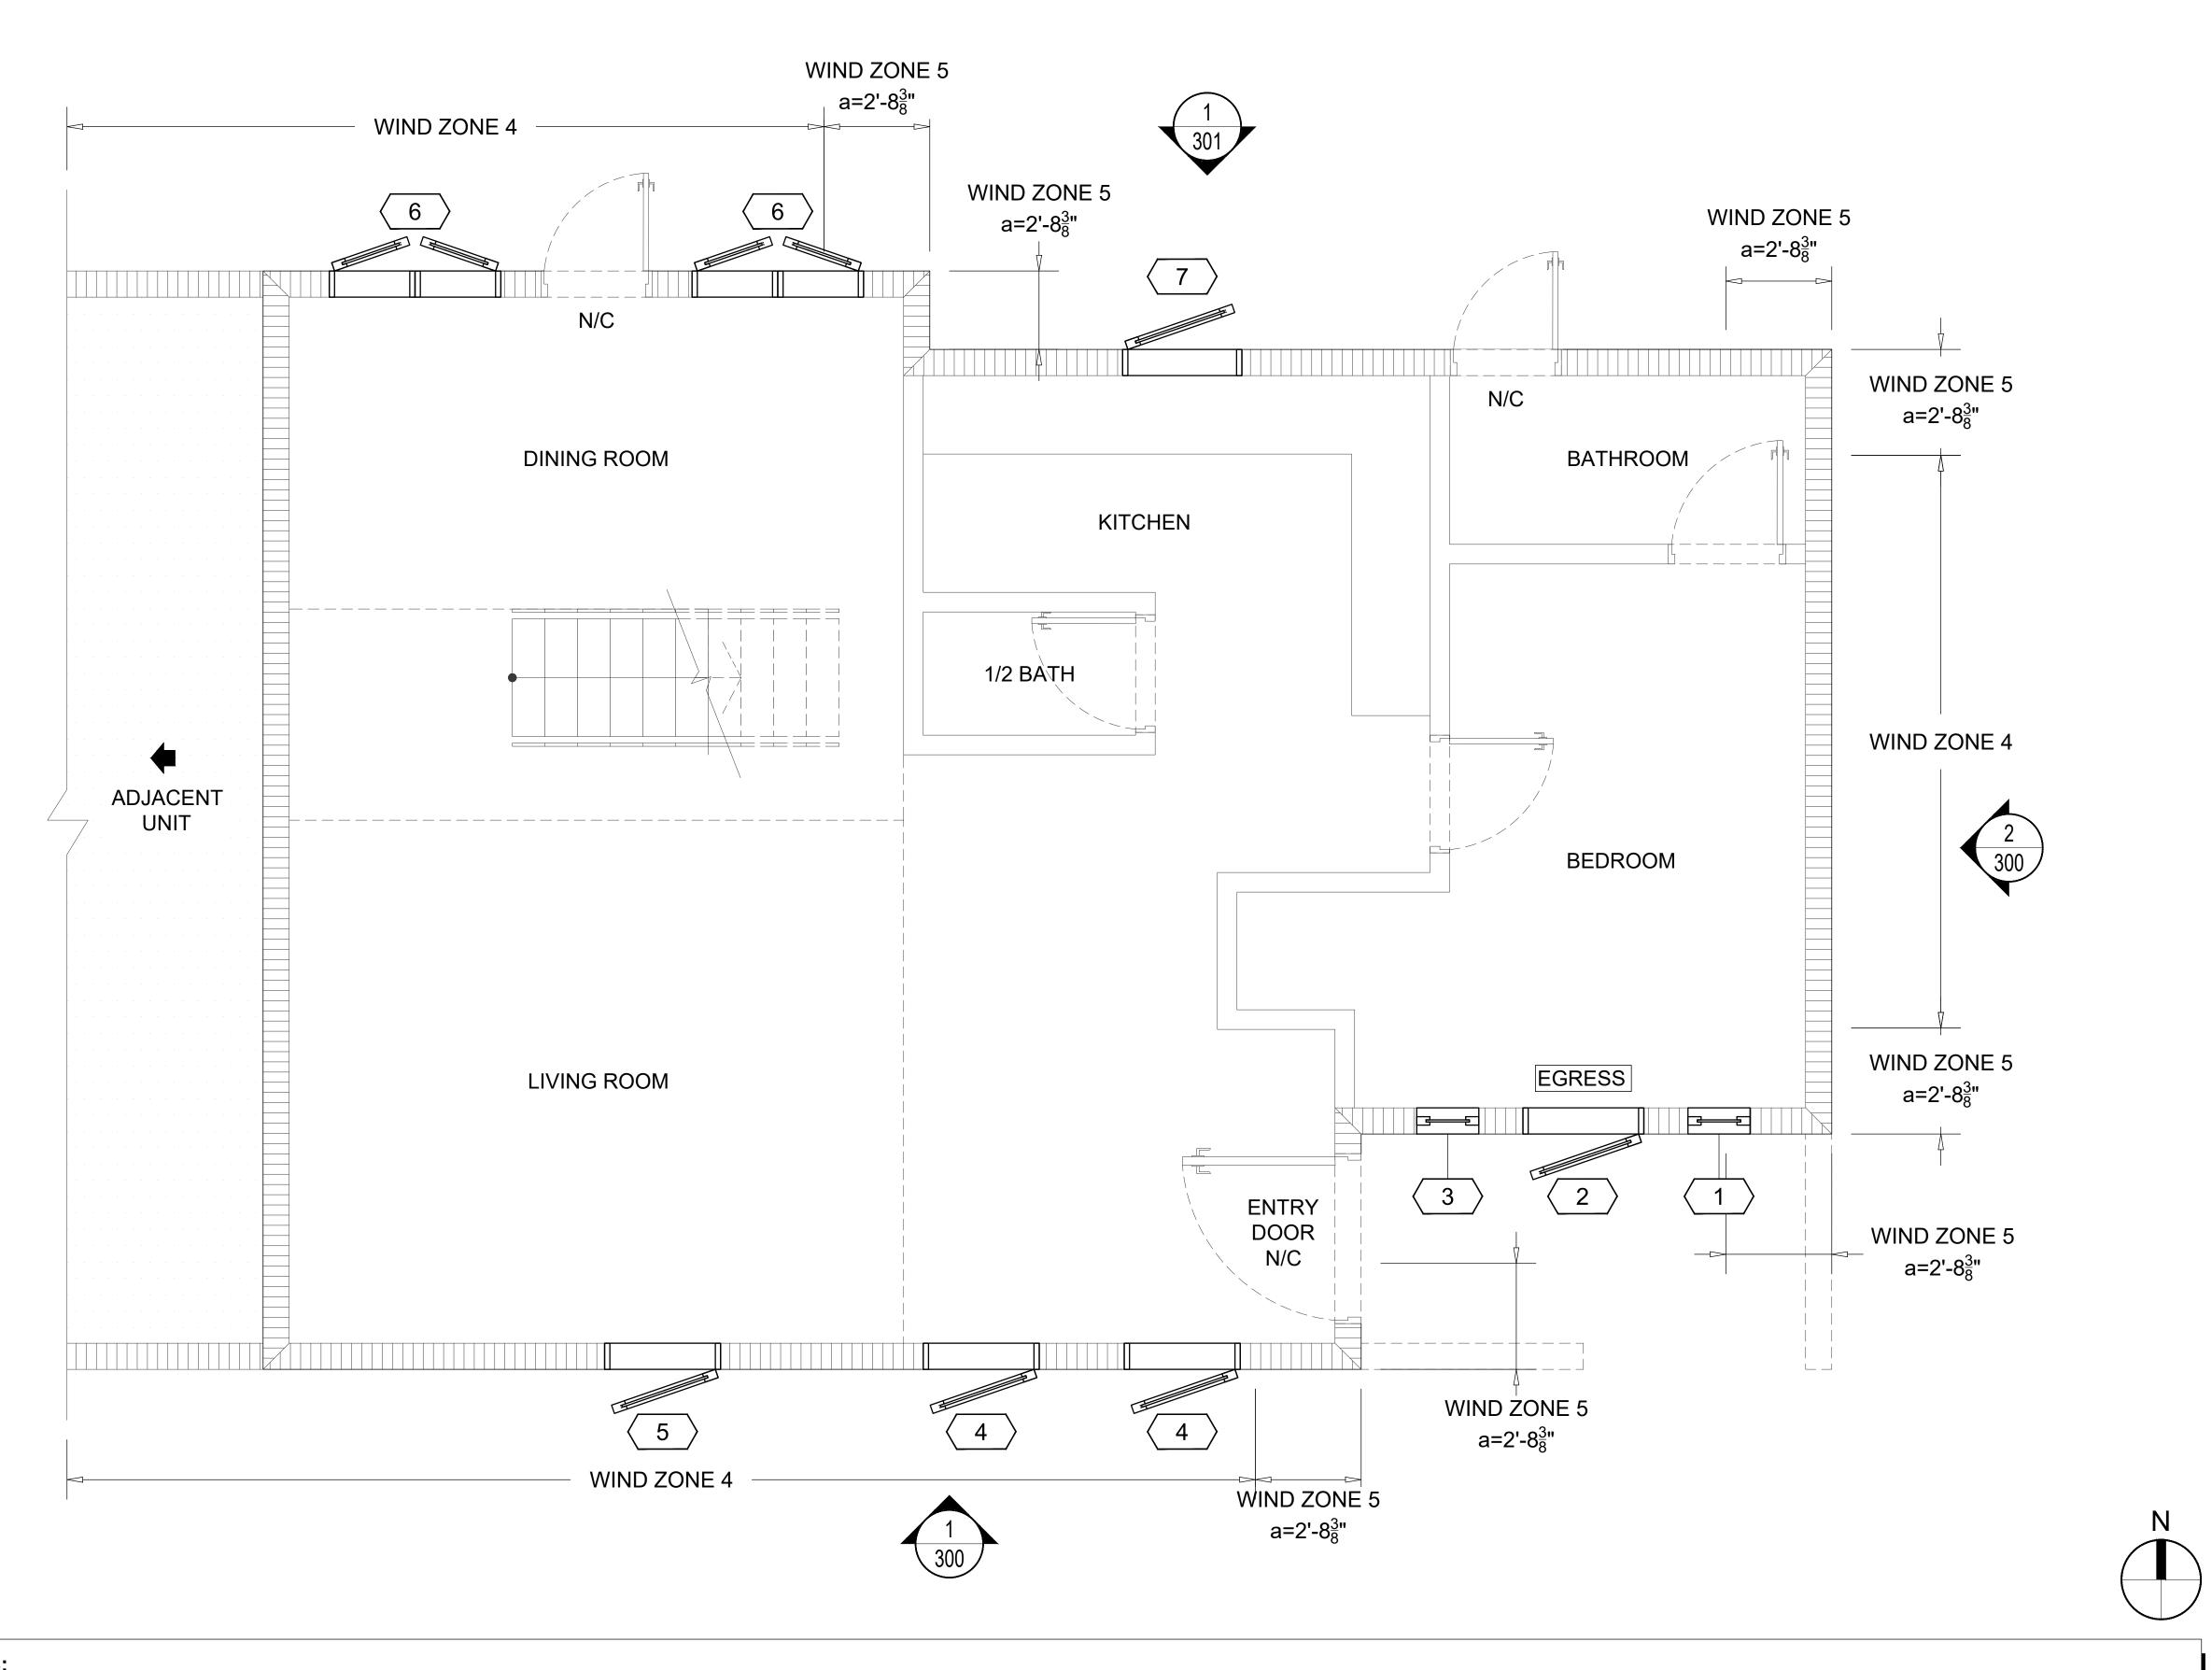

**GENERAL NOTES:** 

• ONLY MARKED OPENINGS ARE PART OF THIS PERMIT.

• THE MAIN WIND FORCE RESISTING SYSTEMS OF THE STRUCTURE (i.e. BEAMS, COLUMNS, FRAMING, ETC) IS NOT TO BE ALTERED. ANY ALTERATIONS TO THOSE SYSTEMS SHALL BE DESIGNED OR CHECKED BY OTHERS TO WITHSTAND ANY STRUCTURAL LOADS, NO CALCULATIONS HAVE BEEN PERFORMED TO VERIFY THE ADEQUACY OF THE EXISTING STRUCTURE.

1 FIRST FLOOR PLAN (AS REFERENCE ONLY)
200 SCALE

7/16"=1'0"

LAN (AS REFERENCE ON NS HARRIS LEVINE

WIMAL SUARIS, P.E. PE# 37369 CA# 28476

Wimal Digitally signed by Wimal Suaris DN. cn-Wimal Suaris, c-US, en-Engineering, inc., email-rand & digentineering, communication of this document. I agree to the specified of this document. Date: 2024.05.21 12:05:20-0400

PATRIOT WINDOWS
& DOORS
6175 NW 167TH STREET

DATE 03/19/2024


SCALE 7/16"=1'-0"

DRAWN AA

CHECKED BY JRO

DRAWING NO. SD24-143

SHEET **200** 

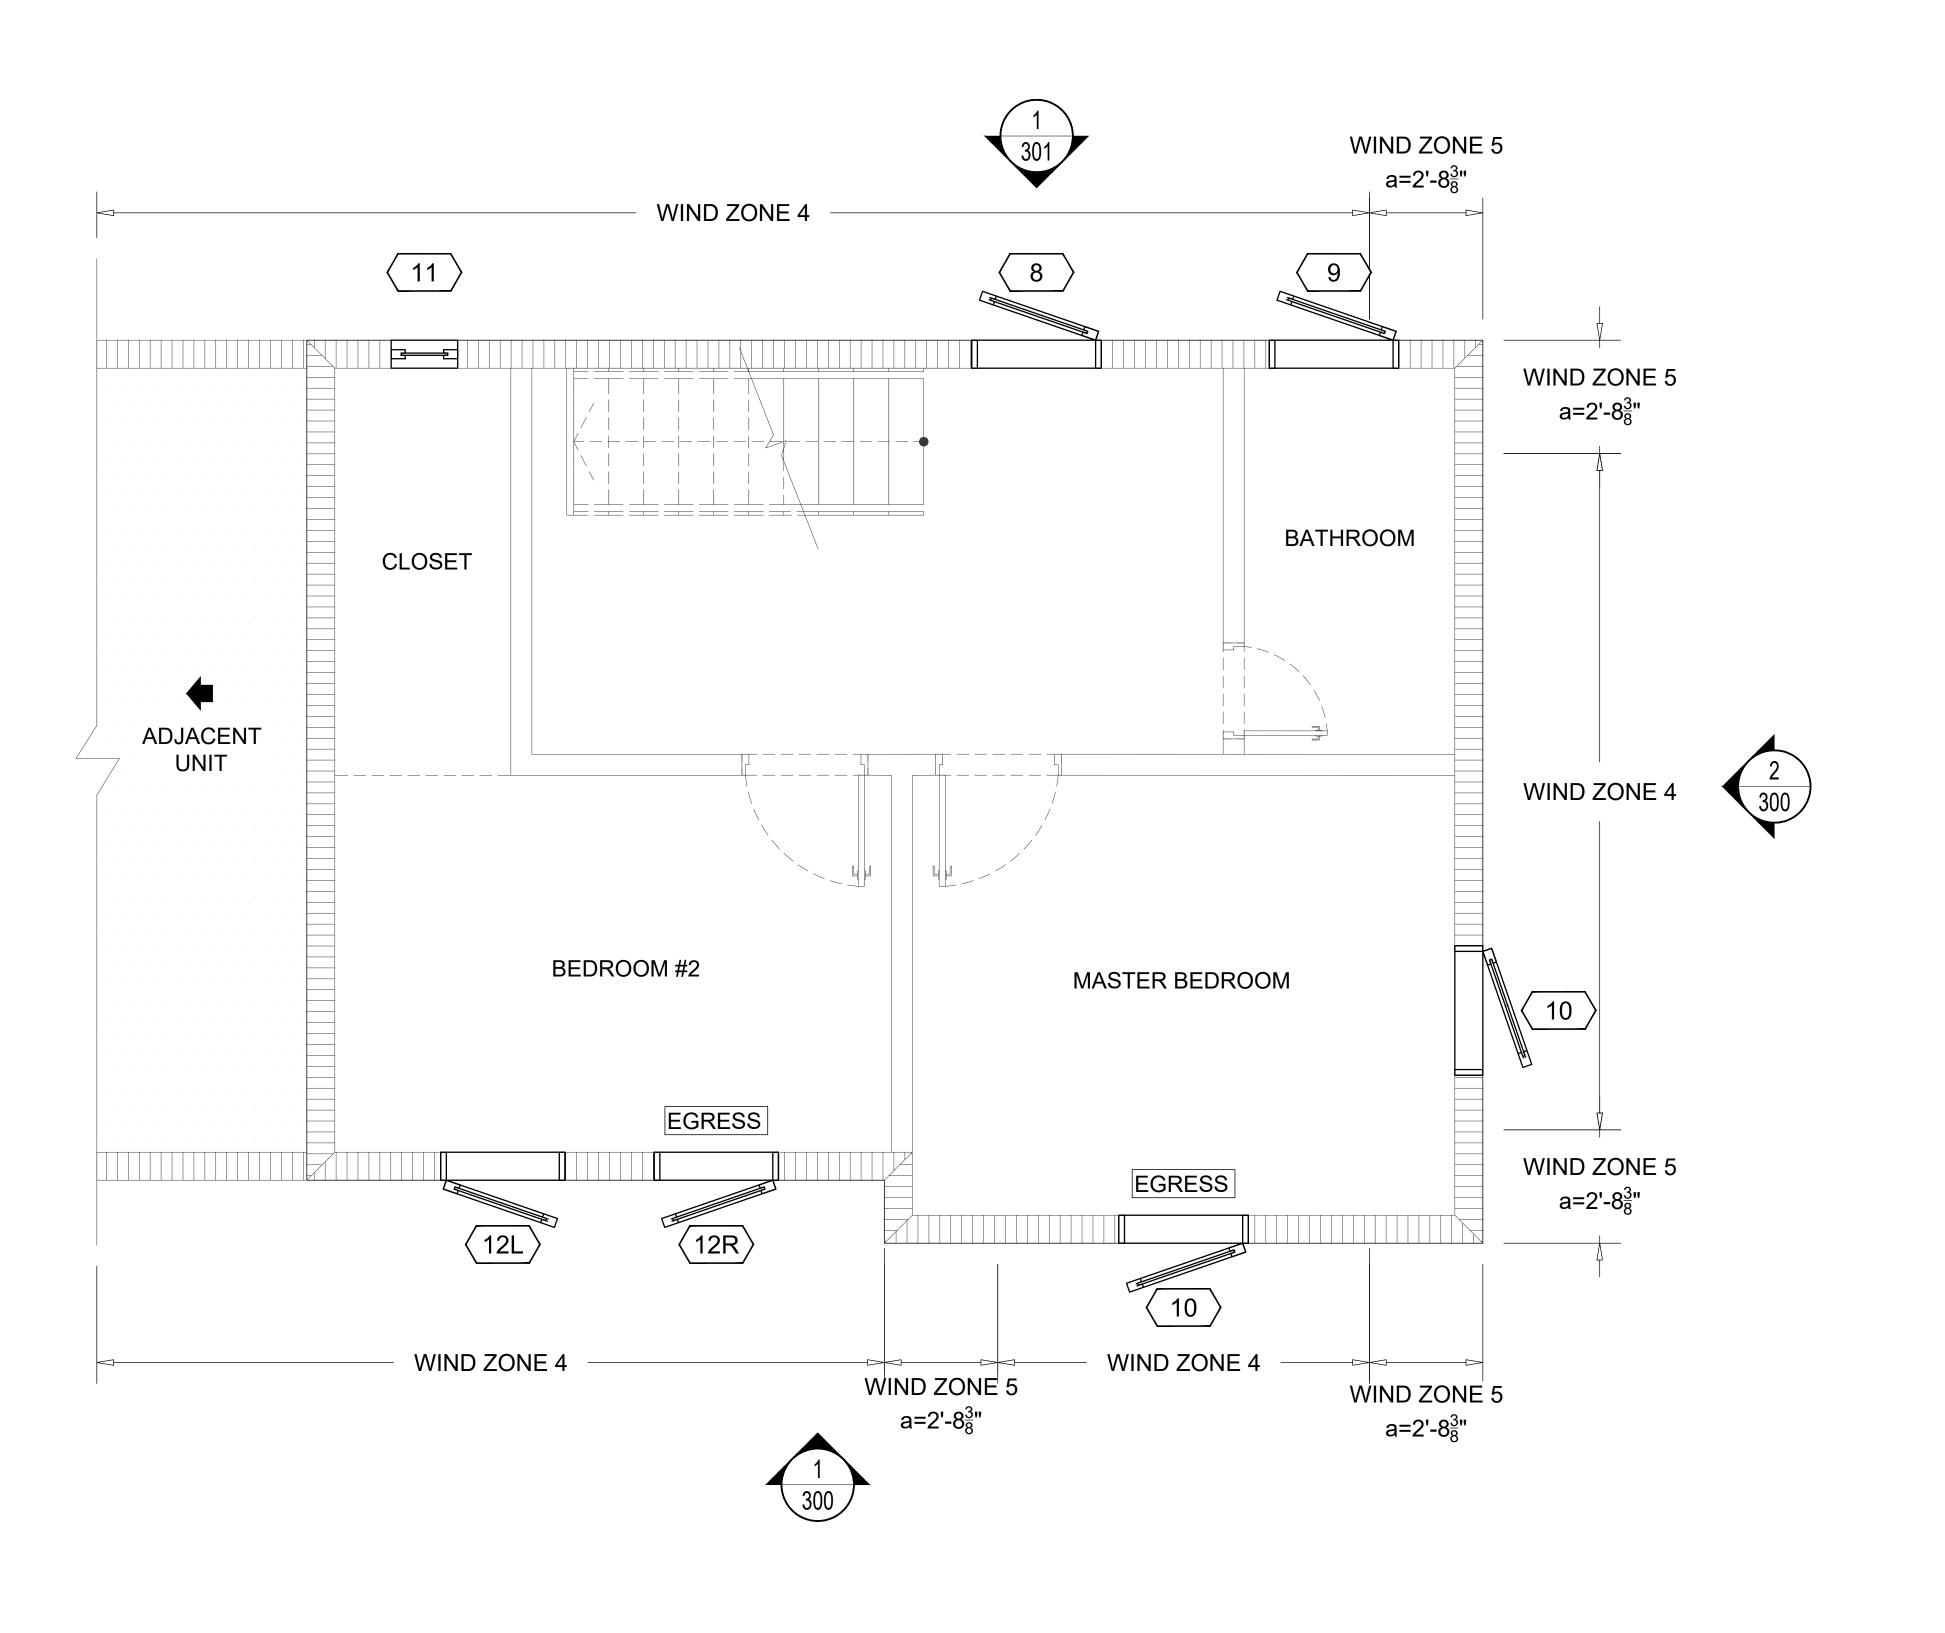



SECOND FLOOR PLAN (AS REFERENCE ONL)

DRAWING NO. SD24-143

201

**GENERAL NOTES:** 

ONLY MARKED OPENINGS ARE PART OF THIS PERMIT.

THE MAIN WIND FORCE RESISTING SYSTEMS OF THE STRUCTURE (i.e. BEAMS, COLUMNS, FRAMING, ETC) IS NOT TO BE ALTERED. ANY ALTERATIONS TO THOSE SYSTEMS SHALL BE DESIGNED OR CHECKED BY OTHERS TO WITHSTAND ANY STRUCTURAL LOADS, NO CALCULATIONS HAVE BEEN PERFORMED TO VERIFY THE ADEQUACY OF THE EXISTING STRUCTURE.

SECOND FLOOR PLAN (AS REFERENCE ONLY)



10/25/2024 SITE SET BLDR-24-04-5272

**REVISIONS** 

WIMAL SUARIS, P.E PE# 37369 CA# 28476

DRAWING NO. SD24-143

PROJECT

PATRIOT WINDOWS & DOORS 6175 NW 167TH STREET MIAMI LAKES, FL 33015

03/19/2024

13/32"=1'-0"

300



13/32"=1'0"


WIMAL SUARIS, P.E. PE# 37369 CA# 28476

PATRIOT WINDOWS
& DOORS
& DOORS
& DOORS
& DOORS
& A05 VISCAN
MIAMI LAKES, FL 33015
CORAL GABLES.

ATE	03/19/2024
CALE	13/32"=1'-0"
PRAWN	AA
HECKED BY	JRO
ROJECT	24-143

DRAWING NO. SD24-143

301

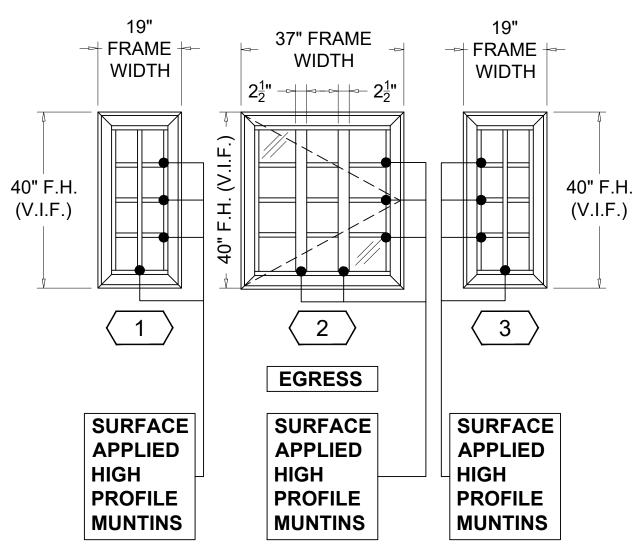

QTY ('1')=1 NOA# 23-0724.08 SERIES "5100 FIXED CASEMENT" ALUMINUM FIXED WINDOW - L.M.I. LAMINATED GLASS "C" WIND ZONE 5

LOAD= +45.78 PSF - 61.30 PSF

QTY ('2')=1 / EGRESS FL# 41000.1


SERIES "5000" ALUMINUM CASEMENT WINDOW - L.M.I. LAMINATED GLASS "A" WIND ZONE 4

LOAD= +45.78 PSF - 49.66 PSF

QTY ('3')=1 NOA# 23-0724.08 SERIES "5100 FIXED CASEMENT" ALUMINUM FIXED WINDOW - L.M.I. LAMINATED GLASS "C"


LOAD= +45.78 PSF - 49.66 PSF

WIND ZONE 4

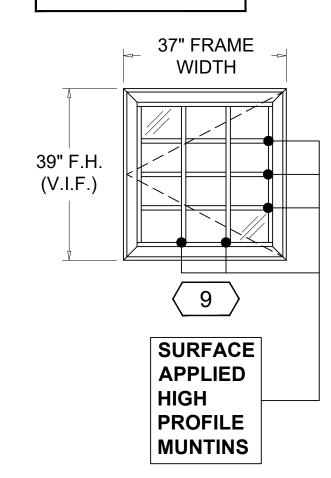

QTY ('9')=1 FL# 41000.1 SERIES "5000" ALUMINUM CASEMENT WINDOW - L.M.I. LAMINATED GLASS "A" WIND ZONE 5


LOAD= +45.78 PSF - 61.30 PSF

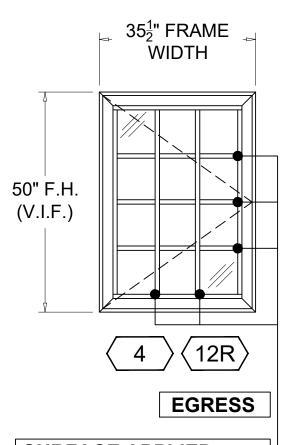

**SURFACE APPLIED** HIGH PROFILE MUNTINS


QTY ('4')=2 QTY ('12R')=1 / EGRESS FL# 41000.1 **SERIES "5000" ALUMINUM** CASEMENT WINDOW - L.M.I. LAMINATED GLASS "A" WIND ZONE 4

LOAD= +45.78 PSF | - 49.66 PSF

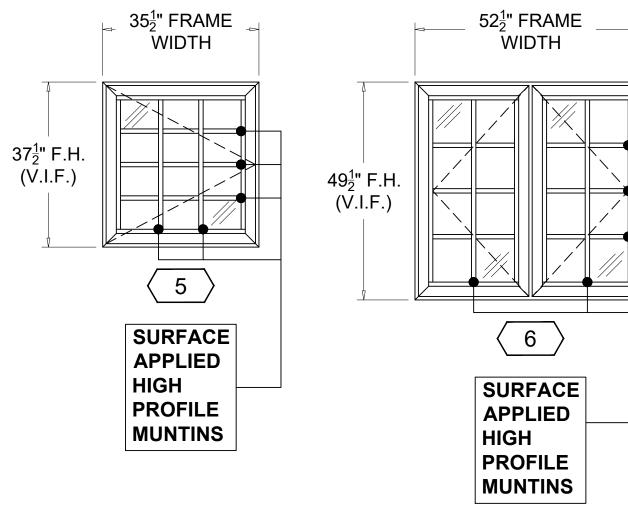


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LOAD= +45.78 PSF | - 49.66 PSF

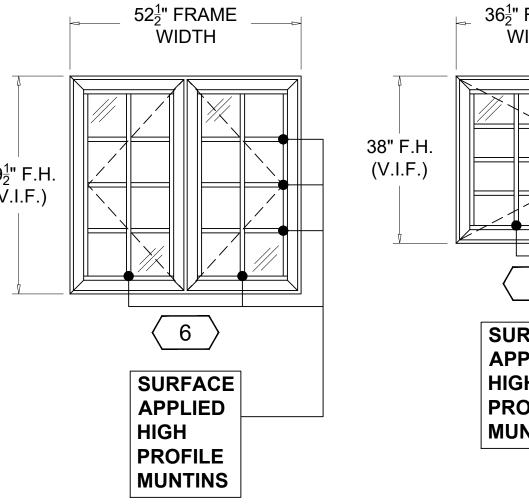


QTY ('6')=2 FL# 41000.1 SERIES "5000" ALUMINUM CASEMENT WINDOW - L.M.I. LAMINATED GLASS "A" WIND ZONE 5

LOAD= +45.78 PSF - 61.30 PSF

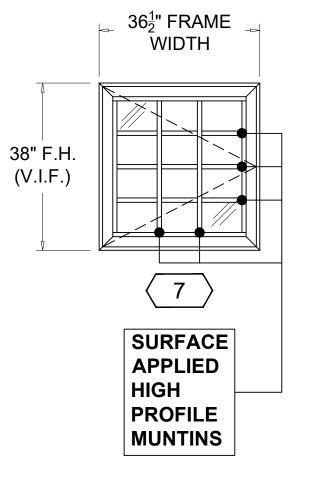

QTY ('7')=1 FL# 41000.1 SERIES "5000" ALUMINUM CASEMENT WINDOW - L.M.I. LAMINATED GLASS "A" WIND ZONE 4

LOAD= +45.78 PSF - 49.66 PSF

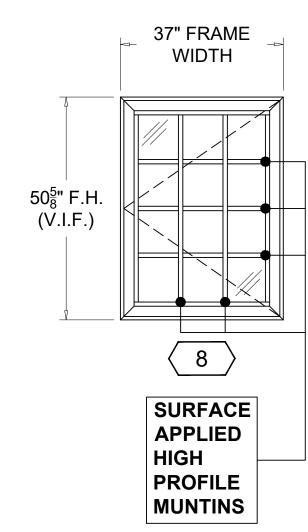

QTY ('8')=1 FL# 41000.1 SERIES "5000" ALUMINUM CASEMENT WINDOW - L.M.I. LAMINATED GLASS "A" WIND ZONE 4

LOAD= +45.78 PSF - 49.66 PSF

**ES-1015 / OG MUNTIN** 

FRAME COLOR: AAMA 2604 BRONZE

GLASS COLOR: CLEAR / NO TINT /

2 MUNTIN DETAIL

**NO REFLECTIVITY** 

400

NOTE:



WIMAL SUARIS, P.E. PE# 37369 CA# 28476 Dimck

REVISIONS


HARRIS LEVINE RESIDENCE 405 VISCAYA AVENUE, IL GABLES, FLORIDA 331

ELEVATIONS OPENING E
PATRIOT WINDOWS
& DOORS
6175 NW 167TH STREET
MIAMI LAKES, FL 33015

CL	
DATE	03/19/2024
SCALE	9/16"=1'-0"
DRAWN	AA
CHECKED BY	JRO
PROJECT	24-143


DRAWING NO. SD24-143

SHEET 400

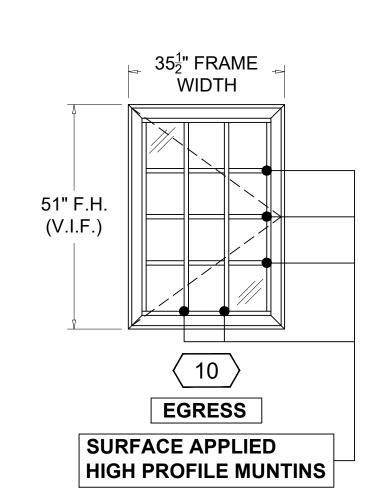

QTY ('10')=2 / EGRESS FL# 41000.1 SERIES "5000" ALUMINUM CASEMENT WINDOW - L.M.I. LAMINATED GLASS "A" WIND ZONE 4

LOAD= +45.78 PSF - 49.66 PSF

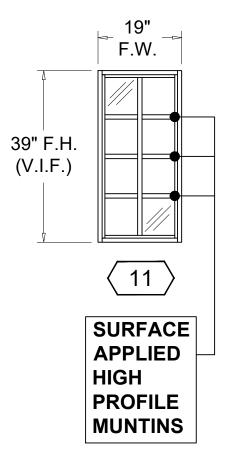


QTY ('11')=1 NOA# 23-0714.17 SERIES "EL-150" ALUMINUM FIXED WINDOW - L.M.I. LAMINATED GLASS "B" WIND ZONE 4


LOAD= +45.78 PSF - 49.66 PSF

QTY ('12L')=1 FL# 41000.1 SERIES "5000" ALUMINUM LAMINATED GLASS "A" WIND ZONE 4

LOAD= +45.78 PSF -49.66 PSF

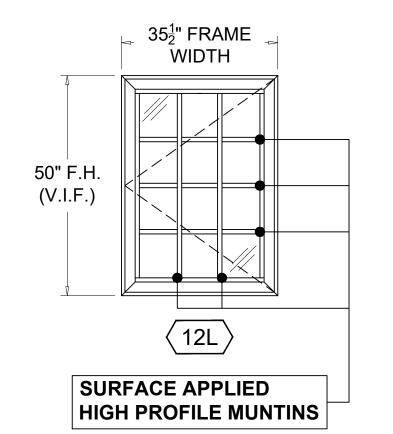

CASEMENT WINDOW - L.M.I.

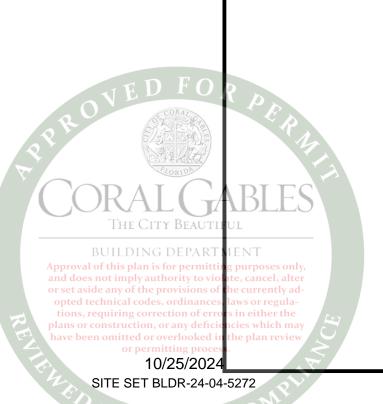

OPENING ELEVATIONS

9/16''=1'-0'





03/19/2024 SCALE DRAWN CHECKED BY JRO PROJECT 24-143

PHOTOGRAPHS
PATRIOT WINDOWS
& DOORS
6175 NW 167TH STREET
MIAMI LAKES, FL 33015
CORAL GABLE

REVISIONS

WIMAL SUARIS, P.E.
PE# 37369
CA# 28476

DRAWING NO. SD24-143

500





NORTH
501 SCALE

REVISIONS

WIMAL SUARIS, P.E.
PE# 37369
CA# 28476

PHOTOGRAPHS

PATRIOT WINDOWS
& DOORS
6175 NW 167TH STREET
MIAMI LAKES, FL 33015
CORAL GABL

03/19/2024 SCALE DRAWN CHECKED BY JRO PROJECT 24-143

> DRAWING NO. SD24-143

> > SHEET **501**



REVISIONS

WIMAL SUARIS, P.E.
PE# 37369
CA# 28476

PATRIOT WINDOWS
& DOORS
6175 NW 167TH STREET
MIAMI LAKES, FL 33015
CORAL GABL

SCALE DRAWN CHECKED BY JRO PROJECT 24-143

DRAWING NO. SD24-143

SHEET **502** 

NORTH
502 SCALE

### HARRIS LEVINE RESIDENCE

405 VISCAYA LEVINE, CORAL GABLES, FL 33134

PROJECT # 24-143

03/20/2023



PREPARED BY: AA

DLG ENGINEERING, INC. 5825 SUNSET DRIVE | SUITE 300 SOUTH MIAMI, FLORIDA 33181 PHONE (305) 665-9089 FAX (305) 665-4672

CA # 0028476



### BUILDING DEPARTMENT

Approval of this plan is for permitting purposes only and does not imply authority to violate, cancel, alter or set aside any of the provisions of the currently adopted technical codes, ordinances, laws or regulations, requiring correction of errors in either the plans or construction, or any deficiencies which may have been omitted or overlooked in the plan review

10/25/2024 SITE SET BLDR-24-04-5272



WIMAL SUARIS, P.E. P.E. # 37369

Wimal Suaris Digitally signed by Wirnal Suaris DN: cn=Wirnal Suaris, c=US, o=DLG ENGINEERING, INC, email=rad@digengineering.com Reason: I agree to the specified portions of this document Date: 2024.03.29 11:24:57 -04'00'

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SERIES "5000" ALUMINUM CASEMENT WINDOW – L.M.I. PA-02

SERIES "EL-150" ALUMINUM FIXED WINDOW - L.M.I. PA-03

\*\*ENGINEERS SEAL COVERS SHEETS: DC-1, WL-1 THRU WL-2



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### **DESIGN CRITERIA**

### HARRIS LEVINE RESIDENCE

03/20/2024

2023 FLORIDA BUILDING CODE

ASCE 7-22

DEFLECTION LIMIT = L/180 IN.

ALLOWABLE STRESS OF ALUM WAS CHECKED W/O STRESS INCREASE OF 1/3:

ALUMUNIM: (PER SPEC 2 ALUM DESIGN MANUAL):

ALLOWABLE BENDING STRESS (Fb) (6063-T6) = 15000 PSI

ANCHORS WERE CHECKED W/O THE 1/3 INCREASE

ALL GLASS TO BE AS NOTED AND SPECIFIED ON PRODUCT APPROVALS (NOA)

IMPACT RESISTANT GLAZING:

LARGE MISSILE: UP TO 30 FT. ABOVE GRADE SMALL MISSILE: ABOVE 30 FT. OF GRADE

SHOP DRAWINGS CHECKED FOR STRUCTURAL REQUIREMENTS ONLY

DLGE WILL NOT PROVIDE A STATEMENT OF INSPECTION OR LETTER OF COMPLIANCE UNLESS CALLED PRIOR TO INSTALLATION



### MecaWind v2460

### Developed by Meca Enterprises Inc., <a href="www.mecaenterprises.com">www.mecaenterprises.com</a>, Copyright © 2024

Client:

Project #:

Location:


Calculations Prepared For:

24-143

Patriot Windows & Doors

```
405 Viscaya Ave. Coral Gables, FL 33134
                                                        Description: Levine Residence
General:
Wind Load Standard
                                      = FBC 2023
                                                       Basic Wind Speed
                                                                                                175.0 mph
Exposure Classification
                                                       Risk Category
                                                                                             = TT
                                      = C
Structure Type
                                      = Building
                                                       Design Basis for Wind Pressures
                                                                                            = ASD
MWFRS Analysis Method
                                        None
                                                       C&C Analysis Method
                                                                                                Ch 30 Pt 1
Dynamic Type of Structure
                                      = Rigid
                                                       Show Advanced Options
Wind Speed Basis to be used in calculations:
          = Convert to ASD wind speed: V<sub>ult</sub>•0.6<sup>0.5</sup>[Eqn 16-17]
                                                                                           = 135.6 \text{ mph}
Building:
Roof = Roof Type
                                      = Gabled
                                                       Encl = Enclosure Classification
                                                                                           = Enclosed
     = Help on Building Roof Type
                                                       Pitch = Pitch of Roof
Help
                                     = Help
                                                                                              = 11.56 :12
      = Slope of Roof
                                      = 43.92 Deg
                                                             = Ridge Height
                                                                                                35,000 ft.
θ
                                                       R<sub>Ht</sub>
\mathbb{E}_{\text{Ht}}
      = Eave Height
                                      = 22.000 ft
                                                       W
                                                             = Building Width
                                                                                              = 27.000 ft
      = Building Length
                                         120.000 ft
                                                       ОН
                                                             = Type of Overhang
                                                                                                None
Par
                                      = None
                                                       \mathrm{HT}_{\mathrm{over}} = Override Mean Roof Height
      = Parapet
                                                                                             = False
                                      = 28.500 ft
                                                       RA<sub>over</sub> = Override Roof Area
                                                                                             = False
Htman
     = Mean Roof Height
                                                       IsElev = Building is Elevated
      = Override GCpivalue
                                      = False
                                                                                             = False
```

### Components and Cladding (C&C) Wind Loads per Ch 30 Part 1 Roof & Wall

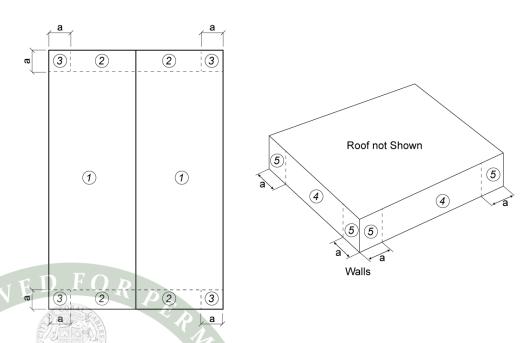

```
Ratio of mean roof height to building width
                                                                                                                           = 1.056
                  Ratio of mean roof height to building length
                                                                                                                              0.238
h/L
                  Mean structure height
                                                                                                                              28.500 ft
                  2.41 \cdot (Z/Z_g)^{2/\alpha}
                                                                                                                           = 0.970
               = No Topographic feature specified
                                                                                                                              1.000
                  Wind Directionality Factor per Tbl 26.6-1
                                                                                                                           = 0.85
               = Wind Directronality ractor por a Enclosed Positive Internal Pressure Tbl 26.13-1 = Enclosed Negative Internal Pressure Tbl 26.13-1
+GC<sub>pi</sub>
                                                                                                                           = +0.18
-GC<sub>pi</sub>
                                                                                                                              -0.18
           BUHLLoad Factor based upon ASD Design
                                                                                                                           = 0.60
KeApproval of this Ground (Elevn Factor (Tbles 26.110-1)
q<sub>h</sub> and does no = im 0.100256 • K<sub>h</sub> • K<sub>2e</sub> • K<sub>e</sub> • V<sup>2</sup>, *LF<sub>1</sub> [Eq. | 26.10-1]
                                                                                                                           = 45.64 psf
LHD set aside any Leastp Horizontalh Dimension: -Min (B, L)
                                                                                                                              27.000 ft
a1 opted tech=icaMin(0s, 1 · LHD, nc0·s Aloh)s or regul
                                                                                                                               2.700 ft
   tions, requirirMaxx(acction04 *LHD; i3 efthe[0h9 m])
                                                                                                                               3.000 ft
h/Blans or con=trunatio of nmean croof height to least horizontal dim: h/B
                                                                                                                               1.056
```

10/25/2024 SITE SET BLDR-24-04-5272

Calculations Prepared by:

Designer: Alejandro Arango

Date: Mar 19, 2024


### Wind Pressures for C&C Ch 30 Pt 1 Roof & Wall All wind pressures include a Load Factor (LF) of 0.6

Description	Zone	Width	Span	Area	1/3 Rule	Figure	GCp Max	GCp Min	p Max	p Min
		ft	ft	ft²					psf	psf
Zone 4	4	1.000	1.000	1.00	No	30.3-1	1.000	-1.100	45.78	-49.66
Zone 5	5	1.000	1.000	1.00	No	30.3-1	1.000	-1.400	45.78	-61.30

= Span Length x Effective Width Area

1/3 Rule = Effective width need not be less than 1/3 of the span length

 $\begin{array}{lll} \text{For Super Pressure Coefficients taken from Figures 30.3-1 through 30.3-7} \\ \text{p} &=& \text{External Pressure: } Q_h \cdot K_d \cdot [GC_p - GC_{pi}] & \text{Eq. 30.3-1} \\ \text{pressure: } Q_h \cdot K_d \cdot [GC_p - GC_{pi}] & \text{Eq. 30.3-1} \\ \text{Per $\S$ 30.2.2 the Minimum Pressure for C&C is 9.60 psf [0.460 kPa] {Includes LF}} \\ \end{aligned}$ 

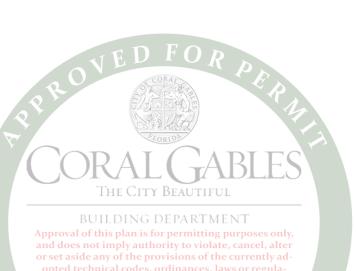

10/25/2024 SITE SET BLDR-24-04-5272

# CITY OF CORAL GABLES HISTORIC PRESERVATION CERTIFICATE OF APPROPRIATENESS

SITE ADDRESS/LOCATION: 405 Viscaya Avenue
LEGAL DESCRIPTION: Portion of Lots 10 & 11, Block 4, The French Village, PB  29-71
CASE FILE NUMBER: COA (ST) 2024-114
CERTIFICATE TYPE: X STANDARD SPECIAL
DECISION BY: X STAFF
HISTORIC PRESERVATION BOARD
ACTION DATE: October 21, 2024
ACTION: APPROVE DENY
X APPROVE W/CONDITIONS
Conditions: AS PER APPROVED DRAWINGS, GLASS TO BE CLEAR /
NO TINT / NO REFLECTIVITY
VEDTORPA
EXPIRATION DATE: October 21, 2026
THE CITY BEAUTIFUL
BUILDING DEPARTMATA Kautz  Assistant Historic Preservation Officer
es not imply authority to violate challe, side any of the provisions of the cufrently ad-
requiring correction of the Association of the Asso
r construction, or any of iciencies plGNATURE  pen omitted or overlooked in the pan review
or permitting process 10/25/2024 Or permitting process & cultural arts department -2327 salzedo street, coral gables, florida 33134

SITE SET BLDR-24-04-5272



Historical Resources & Cultural Arts

October 21, 2024

2327 SALZEDO STREET CORAL GABLES FLORIDA 33134

Harris Levine and Kamila Przytula 405 Viscava Avenue Coral Gables, FL 33134

P 305-460-5093

(E) hist@coralgables.com

Re: Certificate of Appropriateness

Dear Mr. Levine and Ms. Przytula:

This letter is to confirm the results of the review by the Historical Resources Department. On October 21, 2024, an application for a Standard Certificate of Appropriateness was approved by the Historical Resources and Cultural Arts Department for the installation of impact-resistant windows on the property at 405 Viscaya Avenue, a Contributing Resource within the "French Normandy Village Historic District." Because the work does not significantly alter the character of the existing historic structure, the matter was deemed appropriate for administrative review.

The proposed work does not destroy or detract from the integrity of the historic building, and is minimal in impact, which is entirely consistent with the Secretary of the Interior's Standards for Rehabilitation. Therefore, a Standard Certificate of Appropriateness is issued.

Please be advised that any changes or alterations to the approved plans will need to be submitted to this office for a revision to the Certificate of Appropriateness. Should you have any questions regarding this matter please do not hesitate to contact the office.

Sincerely.

Assistant Historic Preservation Officer

Approval of this plan is (Enclosed; purpo Certificate of Appropriateness

or set aside any of the processions of file COA (ST) 2024-114

tions, requiring correction of err Cesari Garcia-Pons, Chairman, Historic Preservation Board

plans or construction, or any deficibility Yic Urquia, City Clerk have been omitted or overlooked in the plan review.

or permitting proceDouglas Ramirez, Development Services Deputy Director

10/25/2024 ennifer Garcia, City Planner

SITE SET BLDR-24-04-5272n Hernandez, Permit Clerk Supervisor

### **PATRIOT WINDOWS** AND DOORS.



PROPOSAL NUMBER 496037 PROPOSAL NAME Harris Levine EXTERNAL PURCHASE ORDER ID Harris Levine

### **QUOTE ITEMS**

LIME NUM LINE NAME

FRONT DOWNSTAIRS/

BABY ROOM

ASSEMBLY SYSTEM

ASSEMBLY

TOTAL QUANTITY

S 5 €

ES-5000 -CASEMENT

SIZE

AREA FINISH GLASS

SCREEN MUNTINS OPENING FRAME TYPE FLANGE

LIMIT DEVICE PROTECTIVE FILM LOCKING

MECHANISM PRE-GLAZED?

MULTIPOINT

37" X 50 5/8" 13.01 FT<sup>2</sup>

AAMA 2604 BRONZE 1/8" CLEAR HS \$870 + 0.09 PVB CLEAR + 1/8" CLEAR HS

YES YES

RIGHT OPENING (XR)

MULTIPOINT LOCK

37" X 50 5/8"

AAMA 2604 BRONZE

RIGHT OPENING (XR)

MULTIPOINT LOCK

CLEAR + 1/8" CLEAR HS

1/8" CLEAR HS \$870 + 0.09 PVB

13.01 FT2

YES

YES

NO

NO

FBC CERTIFICATION

INTERNAL PSF EXTERNAL PSF 85.00 85.00 CODE FL-41000.1

NFRC CERTIFICATION

U FACTOR SHGC VT 1.05 0.29 0.40

MUNTIN DETAILS

PANEL PATTERN GRID LITES ACROSS 3 LITES DOWN INTERNAL STYLE ES1014 EXTERNAL STYLE ES1014

MASTER

ES-5000 -CASEMENT MULTIPOINT



SIZE AREA FINISH GLASS

SCREEN MUNTINS OPENING. FRAME TYPE FLANGE

LIMIT DEVICE PROTECTIVE LOCKING

MECHANISM isple alte

YES

**FBC CERTIFICATION** 

INTERNAL PSF EXTERNAL PSF 85.00 85.00

CODE

FL-41000.1

NFRC CERTIFICATION


U FACTOR SHGC 1.05 0.29 0.40

MUNTIN DETAILS

PANEL PATTERN GRID LITES ACROSS 3 LITES DOWN INTERNAL STYLE ES1014 EXTERNAL STYLE E51014

10/25/2024 SITE SET BLDR-24-04-5272



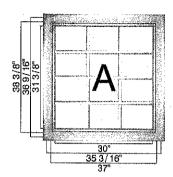

SIZE

AREA 9.86 FT<sup>2</sup> FINISH

GLASS

SCREEN MUNTINS

**OPENING** FRAME TYPE LIMIT

DEVICE PROTECTIVE FILM LOCKING

MECHANISM PRE-GLAZED?

37" X 38 3/8"

AAMA 2604 BRONZE 1/8" CLEAR HS SB70 + 0,09 PVB

CLEAR + 1/8" CLEAR HS

YES RIGHT OPENING (XR)

FLANGE NO

MULTIPOINT LOCK

YES

FBC CERTIFICATION

INTERNAL PSF EXTERNAL PSF 85.00 85.00

CODE

FL-41000.1

NFRC CERTIFICATION

U FACTOR SMGC 1.05 0.29 0.40

MUNTIN DETAILS

PANEL PATTERN GRID

LITES ACROSS 3 LITES DOWN

INTERNAL STYLE ES1014

**EXTERNAL STYLE** 


ES1014

IN GATE MIDDLE

ES-5000 -

MULTIPOINT

I.

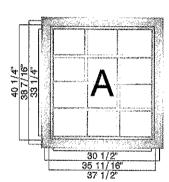

CASEMENT

SIZE

AREA 10.48 FT<sup>2</sup> FINISH AAMA 2604 BRONZE GLASS

1/8" CLEAR HS 5870 + 0.09 PVB CLEAR + 1/8" CLEAR HS

SCREEN

MUNTINS **OPENING** FRAME TYPE FLANGE

LIMIT DEVICE PROTECTIVE

FILM LOCKING

MECHANISM PRE-

37 1/2" X 40 1/4"

RIGHT OPENING (XR)

NO

MULTIPOINT LOCK

YES **GLAZED?** 

FBC CERTIFICATION

INTERNAL PSF EXTERNAL PSF 85.00

85.00 CODE

FL-41000.1

**NOA CERTIFICATION** 

INTERNAL PSF EXTERNAL PSF 85.00 85.00 CODE 20-0915,02

NFRC CERTIFICATION

U FACTOR SHGC 1.05 0.29 0.40

MUNTIN DETAILS

PANEL PATTERN GRID LITES ACROSS 3 LITES DOWN

INTERNAL STYLE

1

ES1014 EXTERNAL STYLE ES1014

GATE LEFT (WIDTH REST) ES-5100 - FIXED CASEMENT



21 1/2" X 40 1/4" SIZE 6.01 FT<sup>2</sup> FINISH AAMA 2604 BRONZE GLASS 5/32" CLEAR HS + 0,09 PVB CLEAR + 1/8" CLEAR MS NO MUNTIN FRAME TYPE FLANGE PROTECTIVE EXTERIOR PRE-YES

**FBC CERTIFICATION** 

INTERNAL PSF EXTERNAL PSF

90.00 CODE

90.00 FL15976

23-0724.08


NOA CERTIFICATION

INTERNAL PSF EXTERNAL PSF 90,00 90,00

CODE

NFRC CERTIFICATION **U FACTOR** SHGC 1,01 0,60 0.68

10/25/2024 SITE SET BLDR-24-04-5272 ES-5100 - FIXED CASEMENT

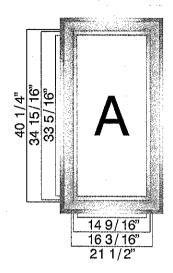

SIZE 21 1/2" X 40 1/4"

AREA

FINISH GLASS

FRAME TYPE PROTECTIVE EXTERIOR

FILM PRE-GLAZED?

MUNTIN

6,01 FT2

AAMA 2604 BRONZE 5/32" CLEAR HS + 0,09 PVB

CLEAR + 1/8" CLEAR HS

FLANGE

YES

FBC CERTIFICATION

INTERNAL PSF EXTERNAL PSF

90.00 CODE 90.00 FL15976

NOA CERTIFICATION

INTERNAL PSF EXTERNAL PSF

90.00

CODE

90.00 23-0724.08

NFRC CERTIFICATION


**U FACTOR** SHGC

1.01 0,60 0.68

KITCHEN

ES-5000 -

MULTIPOINT

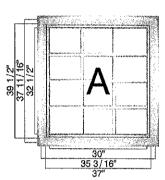

**CASEMENT** 

SIZE 37" X 39 1/2"  $10.15~\mathrm{FT}^2$ AREA

FINISH AAMA 2604 BRONZE GLASS

1/8" CLEAR HS + 0.09 PVB CLEAR + 1/8" CLEAR HS

YES

MUNTINS YES

RIGHT OPENING (XR) OPENING FRAME TYPE

FLANGE LIMIT NO

DEVICE PROTECTIVE NO

LOCKING

SCREEN

MULTIPOINT LOCK MECHANISM PRE-

GLAZED?

FBC CERTIFICATION

INTERNAL PSF EXTERNAL PSF

85,00

85.00

CODE

FL-41000.1

**MUNTIN DETAILS** 

PANEL PATTERN GRID

LITES ACROSS 3

LITES DOWN

INTERNAL STYLE

ES1014 **EXTERNAL STYLE** ES1014

ES-5000 -

XX -MULTIPOINT



AREA 18.63 FT2 FINISH AAMA 2604 BRONZE GLASS 1/8" CLEAR HS + 0.09 PVB CLEAR + 1/8" CLEAR HS SCREEN YES MUNTINS YES FRAME TYPE FLANGE LIMIT DEVICE PROTECTIVE NO

53" X 50 5/8"

MULTIPOINT LOCK

YES

LOCKING

GLAZED?

MECHANISM

**FBC CERTIFICATION** 

INTERNAL PSF EXTERNAL PSF 85.00 85,00

CODE

FL-41000,1

NOA CERTIFICATION

INTERNAL PSF EXTERNAL PSF

85.00 . 85,00

CODE 20-0915,02

**MUNTIN DETAILS** 

PANEL

PATTERN

LITES ACROSS

LITES DOWN

2

INTERNAL STYLE

**EXTERNAL STYLE** 

ES1014 ES1014

A, B

GRID

SITE SET BLDR-24-04-5272

SIZE AREA

FINISH GLASS

9.86 FT<sup>2</sup> AAMA 2604 BRONZE 3/16" CLEAR HS + 0.09 PVB

37" X 38 3/8"

CLEAR + 3/16" CLEAR HS MUNTIN FRAME TYPE PROTECTIVE FILM PRE-

FLANGE EXTERIOR

YES

FBC CERTIFICATION

INTERNAL PSF EXTERNAL PSF 81.10 81.10 CODE FL 21461.1

NOA CERTIFICATION

INTERNAL PSF EXTERNAL PSF 80.00 80.00 CODE 22-0105.01

NFRC CERTIFICATION

U FACTOR SHGC 1,02 0.65 0.75

2ND FLOOR STAIRS

ES-5000 -CASEMENT MULTIPOINT

1

SIZE

AREA

FINISH

GLASS

SCREEN

GLAZED?

37" X 50 5/8" 13.01 FT<sup>2</sup> AAMA 2604 BRONZE

1/8" CLEAR HS + 0.09 PVB CLEAR + 1/8" CLEAR HS

YES YES

MUNTINS OPENING RIGHT OPENING (XR) FRAME TYPE FLANGE

LIMIT NO DEVICE PROTECTIVE NO FILM

LOCKING MULTIPOINT LOCK MECHANISM PRE-

GLAZED?

YES

FBC CERTIFICATION

INTERNAL PSF EXTERNAL PSF

85.00 CODE 85.00 FL-41000.1

**MUNTIN DETAILS** 

PANFI PATTERN GRID LITES ACROSS LITES DOWN

Λ INTERNAL STYLE ES1014 **EXTERNAL STYLE** ES1014

BABY CLOSET

ES-EL150 - FIXED **WINDOW** 



SIZE AREA FINISH GLASS

MUNTIN

幹能與

PRE-

FRAME TYPE

PROTECTIVE

18" X 38 3/8" 4.80 FT<sup>2</sup>

AAMA 2604 BRONZE 3/16" CLEAR HS + 0.09 PVB CLEAR + 3/16" CLEAR HS

YES FLANGE EXTERIOR

YES

FBC CERTIFICATION

INTERNAL PSF EXTERNAL PSF 81,10 81.10

CODE FL 21461.1

**NOA CERTIFICATION** 

INTERNAL PSF EXTERNAL PSF 80,00

CODE 22-0105.01

NFRC CERTIFICATION

U FACTOR SHGC 0,65 0.75

**MUNTIN DETAILS** 

PANEL. PATTERN GRID LITES ACROSS LITES DOWN INTERNAL STYLE ES1014 EXTERNAL STYLE ES1014

GLAZED?

15 7/8"+ Approval of this plan 117,13/n16" ng purposes only, and does not imply author 18 to violate, cancel, alter

have beePRODUCT TOTALS erlooked in the plan review

TAX RATE 0.00% TAX AMOUNT \$0.00 TERMS AND SERVICES INSTALLATION PRICE \$5,200,00 PERMIT PRICE \$1,200.00 MISCELLANEOUS \$0.00 TOTALS TOTAL \$19,915.90

- Payment #1 50% Deposit
   Required prior to order/final measurement
- Payment #2 40% Balance Due on or before DELIVERY
- Payment #3 10% Balance Due on or before final inspection
- · All major credit cards accepted (Credit card fee: 4% of total order)
- \*\*\*\* No Return/Cancellation once Dealer has ordered materials

### INCLUDED:

- · Job site delivery
- · Removal and disposal of existing window(s) and or door(s)
- Re-bucking of openings as needed -- including buck material (residential customers only)
- Professional installation of new window(s) and or door(s)
- · Protection of interior and exterior of work areas from unreasonable dust and debris
- · Minor drywall and stucco repair

### NOT INCLUDED:

- · Permit Runner Expediting Fee, Engineering Services/Engineering Costs
- · Final cleaning of glass
- · Painting of windows, doors, stucco, trim or drywall
- · Removal, replacement or installation of window treatment, drapes, blinds, window coverings
- · Wind load calculation/Engineering: (\$1,200.00) Due with Deposit.
- · City/County permit application Fees (to be reimbursed to Dealer)
- Shop Drawings available upon request (TBD)
- · Disconnection or reconnection of security system available upon request (TBD)
- · Interior door casings available upon request (TBD)

### ADDITIONAL TERMS:

- · Dealer has the absolute discretion to cancel a job in the event the work conditions at the Job Address are not acceptable to Dealer, including but not limited to restrictions on access to the Job Address during regular business hours and Customer's display of disrespect or contempt towards Dealer's employees/agents/ subcontractors. In the event of such cancellation, Dealer agrees to refund to Customer any portion of the Deposit not applied towards the purchase of materials. In the event the Job Address is governed by a Homeowner's or Condominium Association, Dealer will not order materials until the Association approves the job.
- In the event a permit or regulatory approval is required by a local municipality/county government, Dealer will not order materials under the required
- Any work order changes involving this job shall be in writing, signed by both parties.
- In the event that performance of the job is prevented, restricted, or interfered with by causes beyond Dealer's reasonable control ("Force Majeure"), then Dealer's obligations shall be suspended to the extent necessary by such event. The term Force Majeure shall include, without limitation, acts of God, storm, hurricane, vandalism, fire, explosion, work stoppages or supplier failures.
- · Customer's failure to timely make payment on the due date shall be deemed a material breach, which shall permit Dealer to cancel this agreement or suspend work on the job until such time as all payments due have been made. Customer agrees to pay a late charge of 15% of all payments that are more than five (5)
- This agreement shall be interpreted and governed in accordance with the laws of the State of Florida. If any party to this agreement brings a cause of action against the other party arising from or relating to the job (including payment under this agreement), the prevailing party in such legal proceeding shall be entitled to recover reasonable attorneys' fee and costs.

Thank you for the opportunity to work with you. Please sign and return copy of this agreement to confirm acceptance of job, terms and conditions. Once a signed copy is received, we will schedule to commencement in accordance with arrival of window(s)/door(s).

14mm Accepted By: nstruct

10/25/2024 SITE SET BLDR-24-04-5272

# CERTIFICATE OF APPROPRIATENESS A P P L I C A T I O N CITY OF CORAL GABLES - HISTORICAL RESOURCES AND CULTURAL ARTS DEPARTMENT

40E \ / 10C A \ / A A \ / E

1.	405 VISCATA AVE	
	Building Address Historic name of building (if any)	District Name (if any)
	THE FRENCH VILLAGE PB 29- 4	
	Legal Description: Lot(s)  Block(s)	Section
	2561 25551, 1151 251(2)	_
	HARRIS LEVINE & KAMILA PRZ 9700 67 AVE PINECE	
(Requir	Owner's Name Street Address Zip C  oret/Je-mail: harris.levine@gmail.com	ode Phone No.
	YANAY GONZALEZ 14795 SW 178TH TER	MIA 7869850174
	Applicant's Name Street Address Zip C	
(Require	red) e-mail: citypermittingservices@gmail.com	
	PATRIOT WINDOWS AND DOO 6073 NW 167TH ST C	5 MI 3052065292
(Require	Contractor/Arch/Engineer's Name Street Address Zip C red) e-mail: brandon@patriotwindowsdoors.com	ode Phone/Fax
2.		м.
2.	PLEASE INDICATE THE CATEGORY WHICH DESCRIBES THE PROPOSED WOR	K:
	Minor Alterations New Construction Addition Rehab	litation
	Demolition Other:	
3.	Will the work proposed require a variance from the Zoning Code?	
5.		
	NO YES, from section(s)  Attach the requested variance language to this form	
4.	Has this property been qualified as a Coral Gables Cottage? NO YES (att	ach a copy of qualification sheet)
5.	This request is: new result of a violation a revision to a previous submi	ttal a revision to a previously approved COA  Case File:
6.	Case File:WORK PROPOSED: Brief narrative of work to be performed.	Case File.
	NEW 16 WINDOWS	
7.	Variance requests require a processing fee. Payment must be included with the City of Coral Gables. <u>Applications for ad valorem tax relief must be filed on a sep</u>	
8. >	The following supplementary information (where applicable) shall be provide	led:*
ONE	Site Plan (with dimensions) Floor Plan(s) (with dimensions) Elevations(s)  Before/After  Before/After	(with dimensions) Mailing list & 3 sets of labels
		VARIANCES/DEMOLITIONS
SE		VARIANCES/DEMOLITIONS  Intent Reduced Plans 11x17
F USE		Reduced Plans 11x17 [6 copies) Board review 2 sign/seal + 14reg.
TAFF USE	Photos Survey(5 yrs or younger)  Labeled Board review (1 Orig + 16 copies)  2 per page Non-Board (1 original)  Color/Material Sample Letter of Board review (16 swatches)  Non-Board review (1 set)  Non-Board review (1 set)	Reduced Plans 11x17    6 copies   Board review 2 sign/seal + 14reg.    ew (1 copy)   Non-Board review (1 set)
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REVISED: August 2021



DEPARTMENT OF REGULATORY AND ECONOMIC RESOURCES (RER) BOARD AND CODE ADMINISTRATION DIVISION

### NOTICE OF ACCEPTANCE (NOA)

MIAMI-DADE COUNTY PRODUCT CONTROL SECTION 11805 SW 26 Street, Room 208 Miami, Florida 33175-2474 T (786) 315-2590 F (786) 315-2599 www.miamidade.gov/building

PA-01

E.S. Windows, LLC 3550 NW 49<sup>th</sup> Street Miami, FL 33142

### Scope:

This NOA is being issued under the applicable rules and regulations governing the use of construction materials. The documentation submitted has been reviewed and accepted by Miami-Dade County RER-Product Control Section to be used in Miami-Dade County and other areas where allowed by the Authority Having Jurisdiction (AHJ).

This NOA shall not be valid after the expiration date stated below. The Miami-Dade County Product Control Section (In Miami-Dade County) and/ or the AHJ (in areas other than Miami-Dade County) reserve the right to have this product or material tested for quality assurance purposes. If this product or material fails to perform in the accepted manner, the manufacturer will incur the expense of such testing and the AHJ may immediately revoke, modify, or suspend the use of such product or material within their jurisdiction. RER reserves the right to revoke this acceptance if it is determined by Miami-Dade County Product Control Section that this product or material fails to meet the requirements of the applicable building code.

This product is approved as described herein and has been designed to comply with the Florida Building Code, including the High Velocity Hurricane Zone.

### **DESCRIPTION:** Series "5100 Fixed Casement" Aluminum Fixed Window – L.M.I.

**APPROVAL DOCUMENT:** Drawing No. **W11-15**, titled "Series 5100 Aluminum Fixed Wdw. (L.M.I.)", sheets 1 through 7 of 7, dated 03/22/11, with revision **H** dated 07/14/23, prepared by Al-Farooq Corporation, signed and sealed by Jalal Farooq, P.E., bearing the Miami-Dade County Product Control Revision stamp with the Notice of Acceptance number and expiration date by the Miami-Dade County Product Control Section.

### MISSILE IMPACT RATING: Large and Small Missile Impact Resistant

**LABELING:** Each unit shall bear a permanent label with the manufacturer's name or logo, **Barranquilla**, **Colombia**, model/series, and following statement: "Miami–Dade County Product Control Approved", unless otherwise noted herein.

**RENEWAL** of this NOA shall be considered after a renewal application has been filed and there has been no change in the applicable building code negatively affecting the performance of this product.

**TERMINATION** of this NOA will occur after the expiration date or if there has been a revision or change in the materials, use, and/ or manufacture of the product or process. Misuse of this NOA as an endorsement of any product, for sales, advertising or any other purposes shall automatically terminate this NOA. Failure to comply with any section of this NOA shall be cause for termination and removal of NOA.

**ADVERTISEMENT:** The NOA number preceded by the words Miami–Dade County, Florida, and followed by the expiration date may be displayed in advertising literature. If any portion of the NOA is displayed, then it shall be done in its entirety.

**INSPECTION:** A copy of this entire NOA shall be provided to the user by the manufacturer or its distributors and shall be available for inspection at the job site at the request of the Building Official.

This NOA revises NOA No. 20-1116.01 and consists of this page 1 and evidence pages E-1, E-2 and E-3, as approval document mentioned above.

or set The submitted documentation was reviewed by Manuel Perez, P.E.

tions, requiring correction of errors in either the

have b<mark>een omitted or overlooked</mark> in the plan review

MIAMI-DADE COUNTY OF SERVICE APPROVED 125/2024

SITE SET BLDR-24-04-5272

9/13/23

NOA No. 23-0724.08 Expiration Date: September 22, 2026 Approval Date: September 21, 2023

Page 1

### NOTICE OF ACCEPTANCE: EVIDENCE SUBMITTED

### 1. EVIDENCE SUBMITTED UNDER PREVIOUS NOA's

### A. DRAWINGS

- 1. Manufacturer's die drawings and sections. (Submitted under NOA No. 11-0531.09)
- 2. Drawing No. W11-15, titled "Series 5100 Aluminum Fixed Wdw. (L.M.I.)", sheets 1 through 7 of 7, dated 03/22/11, with revision G dated 11/05/20, prepared by Al-Farooq Corporation, signed and sealed by Jalal Farooq, P.E. (Submitted under NOA No. 20-1116.01)

### B. TESTS

- 1. Test reports on: 1) Air Infiltration Test, per FBC, TAS 202-94
  - 2) Uniform Static Air Pressure Test, Loading per FBC TAS 202-94
  - 3) Water Resistance Test, per FBC, TAS 202-94
  - 4) Large Missile Impact Test per FBC, TAS 201-94
  - 5) Cyclic Wind Pressure Loading per FBC, TAS 203-94

along with marked-up drawings and installation diagram of an aluminum fixed casement window, prepared by Fenestration Testing Laboratory, Inc., Test Reports No. **FTL-6294** and **FTL-6295**, dated 02/25/11 and 03/16/11 respectively, both signed and sealed by Marlin D. Brinson, P.E.

(Submitted under NOA No. 11-0531.09)

### C. CALCULATIONS

1. Anchor verification calculations and structural analysis, complying with FBC 5<sup>th</sup> Edition (2014) and FBC 6<sup>th</sup> Edition (2017), dated 10/28/14 and 10/06/17, and further updated on 07/24/20 to comply with FBC 7<sup>th</sup> Edition (2020), prepared by Al-Farooq Corporation, signed and sealed by Jalal Farooq, P.E. (Submitted under NOA No. 20-1116.01)

### D. **OUALITY ASSURANCE**

1. Miami-Dade Department of Regulatory and Economic Resources (RER)

### E. MATERIAL CERTIFICATIONS

- 1. Notice of Acceptance No. 19-0305.02 issued to Kuraray America, Inc. for their "Trosifol® Ultraclear, Clear and Color PVB Glass Interlayers" dated 05/09/19, expiring on 07/08/24.
- Notice of Acceptance No. 18-0725.11 issued to Kuraray America, Inc. for their The City "Kuraray SentryGlas" Xtra<sup>TM</sup> (SGX<sup>TM</sup>) Clear Glass Interlayer" dated 05/23/19, expiring on 05/23/24.

Approval of this plan is for permitting purposes only, and does not imply authority to violate, cancel, alter or set aside any of the provisions of the currently adopted technical codes, ordinances, laws or regulations, requiring correction of errors in either the plans or construction, or any deficiencies which may have been omitted or overlooked in the plan review

10/25/2024 SITE SET BLDR-24-04-5272 Manuel Perez, P.E. Product Control Examiner NOA No. 23-0724.08

Expiration Date: September 22, 2026 Approval Date: September 21, 2023

### **NOTICE OF ACCEPTANCE: EVIDENCE SUBMITTED**

1. **EVIDENCE SUBMITTED UNDER PREVIOUS NOA'S (CONTINUED)** 

### F. **STATEMENTS**

1. Statement letter of conformance, complying with FBC 6<sup>th</sup> Edition (2017), with FBC 7<sup>th</sup> Edition (2020), and of no financial interest, dated November 16, 2020, issued by Al-Farooq Corporation, signed and sealed by Jalal Farooq, P.E.

(Submitted under NOA No. 20-1116.01)

- Laboratory compliance letter for Test Reports No. FTL-6294 and FTL-6295, issued by 2. Fenestration Testing Laboratory, Inc., dated 02/25/11 and 03/16/11 respectively, both signed and sealed by Marlin D. Brinson, P.E. (Submitted under NOA No. 11-0531.09)
- 3. Proposal No. 10-0505 issued by Product Control, dated 06/29/10, signed by Manuel Perez, P.E.

(Submitted under NOA No. 11-0531.09)

4. Distributor Agreement between, E.S. Windows – Energia Solar S.A., Barranquilla, Colombia and E.S. Windows, LLC, Miami, Florida, U.S.A., dated 10/20/10, signed by Carla Garcia Torrente and by Andres Chamorro, respectively. (Submitted under NOA No. 11-0531.09)

### G. **OTHERS**

Notice of Acceptance No. 18-0116.05, issued to E.S. Windows, LLC for their Series 1. "5100 Fixed Casement" Aluminum Fixed Window - L.M.I., approved on 02/22/18 and expiring on 09/22/21.



10/25/2024 SITE SET BLDR-24-04-5272

Manuel Perez, P.E **Product Control Examiner** NOA No. 23-0724.08

**Expiration Date: September 22, 2026** Approval Date: September 21, 2023

#### E.S. Windows, LLC

### NOTICE OF ACCEPTANCE: EVIDENCE SUBMITTED

#### 2. NEW EVIDENCE SUBMITTED

#### A. DRAWINGS

1. Drawing No. W11-15, titled "Series 5100 Aluminum Fixed Wdw. (L.M.I.)", sheets 1 through 7 of 7, dated 03/22/11, with revision H dated 07/14/23, prepared by Al-Farooq Corporation, signed and sealed by Jalal Farooq, P.E.

#### B. TESTS

1. None.

#### C. CALCULATIONS

1. None.

### D. QUALITY ASSURANCE

1. Miami-Dade Department of Regulatory and Economic Resources (RER)

#### E. MATERIAL CERTIFICATIONS

- 1. Notice of Acceptance No. 20-0915.22 issued to Kuraray America, Inc. for their "Trosifol® Ultraclear, Clear and Color PVB Glass Interlayers" dated 11/19/20, expiring on 07/08/24.
- 2. Notice of Acceptance No. 22-1116.01 issued to Kuraray America, Inc. for their "SentryGlas® (Clear and White) Glass Interlayers" dated 12/15/22, expiring on 07/04/28.

#### F. STATEMENTS

1. Statement letter of conformance, complying with FBC 7<sup>th</sup> Edition (2020), with FBC 8<sup>th</sup> Edition (2023), and of no financial interest, dated July 14, 2023, issued by Al-Farooq Corporation, signed and sealed by Jalal Farooq, P.E.

#### G. OTHERS

1. Notice of Acceptance No. **20-1116.01**, issued to E.S. Windows, LLC for their Series "5100 Fixed Casement" Aluminum Fixed Window – L.M.I., approved on 02/04/21 and expiring on 09/22/26.

# CORAL GABLES

THE CITY BEAUTIFUL

#### BUILDING DEPARTMENT

Approval of this plan is for permitting purposes only and does not imply authority to violate, cancel, alter or set aside any of the provisions of the currently adopted technical codes, ordinances, laws or regulations, requiring correction of errors in either the plans or construction, or any deficiencies which may have been omitted or overlooked in the plan review

10/25/2024 SITE SET BLDR-24-04-5272 Manuel Perez, P.E.
Product Control Examiner
NOA No. 23-0724.08

Expiration Date: September 22, 2026 Approval Date: September 21, 2023

E-3



## SERIES 5100 ALUMINUM FIXED WINDOW

APPROVAL APPLIES TO SINGLE UNITS OR SIDE BY SIDE COMBINATIONS OF FIX./FIX. OR FIXED WITH SERIES 5000 CASEMENT WINDOWS USING MULLIONS IN BETWEEN. LOWER DESIGN PRESSURE FROM CASEMENT WINDOW, FIXED WINDOW OR MULLION CHART WILL APPLY TO ENTIRE SYSTEM.

THIS PRODUCT HAS BEEN DESIGNED AND TESTED TO COMPLY WITH THE REQUIREMENTS OF THE 2020 (7TH EDITION)/2023 (8TH EDITION) FLORIDA BUILDING CODE INCLUDING HIGH VELOCITY HURRICANE ZONE (HVHZ).

1BY OR 2BY WOOD BUCKS & BUCK FASTENERS BY OTHERS, MUST BE DESIGNED AND INSTALLED ADEQUATELY TO TRANSFER APPLIED PRODUCT LOADS TO THE BUILDING STRUCTURE.

ANCHORS SHALL BE CORROSION RESISTANT, SPACED AS SHOWN ON DETAILS AND INSTALLED PER MANUF'S INSTRUCTIONS. SPECIFIED EMBEDMENT TO BASE MATERIAL SHALL BE BEYOND WALL DRESSING OR STUCCO.

A LOAD DURATION INCREASE IS USED IN DESIGN OF ANCHORS INTO WOOD ONLY.


ALL SHIMS TO BE HIGH IMPACT, NON-METALLIC AND NON-COMPRESSIBLE.

MATERIALS INCLUDING BUT NOT LIMITED TO STEEL/METAL SCREWS, THAT COME INTO CONTACT WITH OTHER DISSIMILAR MATERIALS SHALL MEET THE REQUIREMENTS OF THE 2020/2023 FLORIDA BLDG. CODE & ADOPTED STANDARDS.

THIS PRODUCT APPROVALIS GENERIC AND DOES NOT PROVIDE INFORMATION FOR A SITE SPECIFIC PROJECT, i.e. LIFE SAFETY OF THIS PRODUCT, ADEQUACY OF STRUCTURE OF STRUCTUR

CONSTTUNS TO BE ANALYZED SEPARATELY, AND TO BE REVIEWED BY BUILDING OFFICIAL.

DESIGN LOADS SHOWN ARE BASED ON 'ALLOWABLE STRESS DESIGN (ASD)'.

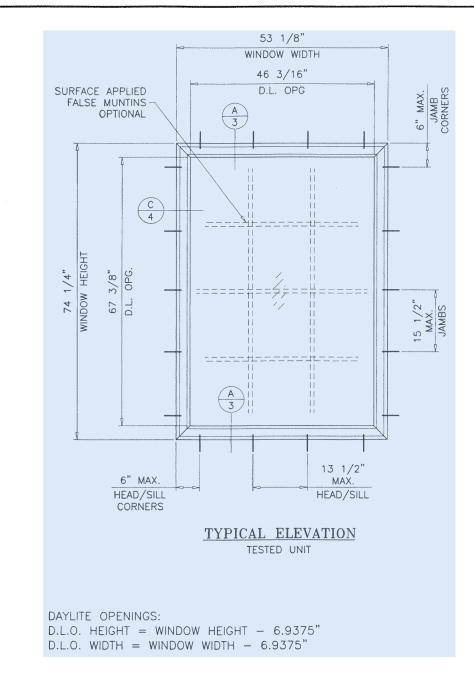


THESE WINDOWS ARE RATED FOR LARGE & SMALL MISSILE IMPACT. SHUTTERS ARE NOT REQUIRED.

PRODUCT REVISED

As complying with the Florida JUL 17 2023

NOA-No. <u>23-0724.08</u> Expiration Date: <u>09/22/2026</u>

By: Manuel Product Control

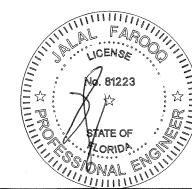

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sheet 1 of 7

**AL-FAROOQ CORPORATION**ENGINEERS & PRODUCT DEVELOPMENT
9360 SUNSET DRIVE, SUITE 220
MIAMI, FLORIDA 33173 (C.A.N. 3538)
TEL. (305) 264-8100 FAX. (305) 262-6978

M.I.

WDW.


5100 ALUMINUM FIXED


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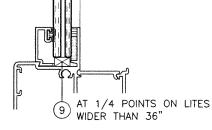
E.S. WINDOWS, LLC 3550 N.W. 49 STREET MIAMI, FL. 33142 TEL. (305) 638–5151 FAX.

DESI	GN LOAD CA	APACITY -	PSF	DESI	GN LOAD CA	PACITY -	PSF
WINDOV	V DIMS.	GLASS 'C', 'D',		WINDOY	V DIMS.		TYPES 'E' & 'F'
wiDTH (W)	LENGTH (L)	EXT.(+)	1NT.(-)	WIDTH (W)	LENGTH (L)	EXT.(+)	1NT.(-)
24"		90.0	90.0	19-1/8"		90.0	90.0
30"		90.0	90.0	26-1/2"		90.0	90.0
36"		90.0	90.0	37"		90.0	90.0
42"	42"	90.0	90.0	48"	26"	90.0	90.0
48"		90.0	90.0	53-1/8"		90.0	90.0
54"		90.0	90.0	62"		90.0	90.0
60"		90.0	90.0	19-1/8"		90.0	90.0
62"		90.0	90.0	26-1/2"		90.0	90.0
24"		90.0	90.0	37"	70 7/0"	90.0	90.0
30"		90.0	90.0	48"	38-3/8"	90.0	90.0
36"		90.0	90.0	53-1/8"		90.0	90.0
42"	48"	90.0	90.0	62"		90.0	90.0
48"		90.0	90.0	19-1/8"		90.0	90.0
54"		90.0	90.0	26-1/2"		90.0	90.0
60"		90.0	90.0	37"	50-5/8"	90.0	90.0
62"		90.0	90.0	48"	50-5/6	90.0	90.0
24"		90.0	90.0	53-1/8"		90.0	90.0
30"		90.0	90.0	62"		90.0	90.0
36"		90.0	90.0	19-1/8"		90.0	90.0
42"	54"	90.0	90.0	26-1/2"	63"	90.0	90.0
48"		90.0	90.0	37"	67"	90.0	90.0
54"		88.5	88.5	48"	63	90.0	90.0
60"		88.5	88.5	53-1/8"	63"	90.0	90.0
62"		88.5	88.5	62"		77.1	77.1
24"		90.0	90.0	19-1/8"		90.0	90.0
30"		90.0	90.0	26-1/2"		90.0	90.0
36"		90.0	90.0	37"	74-1/4"	90.0	90.0
42"	60"	90.0	90.0	48"	74-1/4"	90.0	90.0
48"		90.0	90.0	53-1/8"		90.0	90.0
54"		88.5	88.5	19-1/8"		90.0	90.0
60"		79.7	79.7	26-1/2"		90.0	90.0
62"		79.7	79.7	37"	2" 74-1/4" 8" 8"	90.0	90.0
24"		90.0	90.0	48"		90.0	90.0
30"	r D	90.0	90.0	51"		90.0	90.0
36"		90.0	90.0				W
42"	66"	90.0	90.0				
48"		90.0	90.0				4
54"		88.5	88.5				manuscom and the second and the seco
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42"		90.0	90.0	*	1977/	The state of the s	
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e b <b>42</b> n om 48"	itted or over or permittir	ool90.10n tl	e p90.0 evi	2w			
			90.0				
51"	10/25	5/2024	90.0	V. V.			



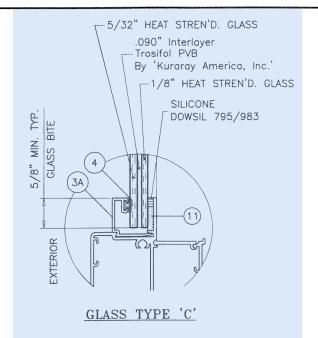

GLASS TYPE 'D'

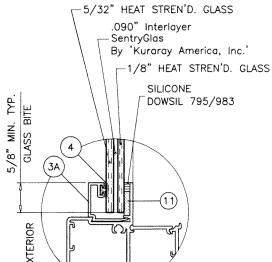

SETTING BLOCKS AT LAM. GLASS NOTCH GLAZING BEAD LEG TO CLEAR BLOCKS

#### 5/32" HEAT STREN'D. GLASS 5/32" HEAT STREN'D. GLASS 5/32" TEMP. GLASS 5/32" TEMP. GLASS -1/4" AIR SPACE -1/4" AIR SPACE √1/8" HEAT STREN'D. GLASS -1/8" HEAT STREN'D. GLASS .090" Interlayer .090" Interlayer Trosifol PVB SentryGlas By 'Kuraray America, Inc.' By 'Kuraray America, Inc.' -5/32" HEAT STREN'D. GLASS -5/32" HEAT STREN'D. GLASS SILICONE SILICONE DOWSIL 795/983 DOWSIL 795/983 BITE (4) 1/2" GLA (3B) EXTERIOR

(9A) AT 1/4 POINTS ALL SIZES

SETTING BLOCKS AT INSUL. LAM. GLASS NOTCH GLAZING BEAD LEG TO CLEAR BLOCKS

### GLAZING OPTIONS

NOTE: TO QUALIFY FOR SMALL MISSILE IMPACT RATING EXTERIOR PLY OF GLASS TYPES 'E' & 'F' MUST BE TEMPERED.

1/4" AIR SPACE CONSISTING OF: SPACER: 'HELIMA' LOW PROFILE ALUMINUM SPACER BY 'LINGERMANN GMBH' AROUND THE PERIMETER OF THE GLASS.

GLASS TYPE 'E'

PERIMETER SEALANT: SILICONE DOWSIL 791

GE 2000

¥. TYP. BITE

**PRODUCT REVISED** As complying with the Florida Building Code 23-0724.08 NOA-No. Expiration Date: 09/22/2026 JUL 17 2023

GLASS TYPE 'F'

By: Manuel Peres Miami-Dade Product Control

GLASS CAPACITIES ON THIS SHEET ARE BASED ON ASTM E1300-09 (3 SEC. GUSTS).



(C.A.N. 3538) FAX. (305) 262-6978 COMP—ANL\W11

(305)

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AL-FAROOQ CORPORATION
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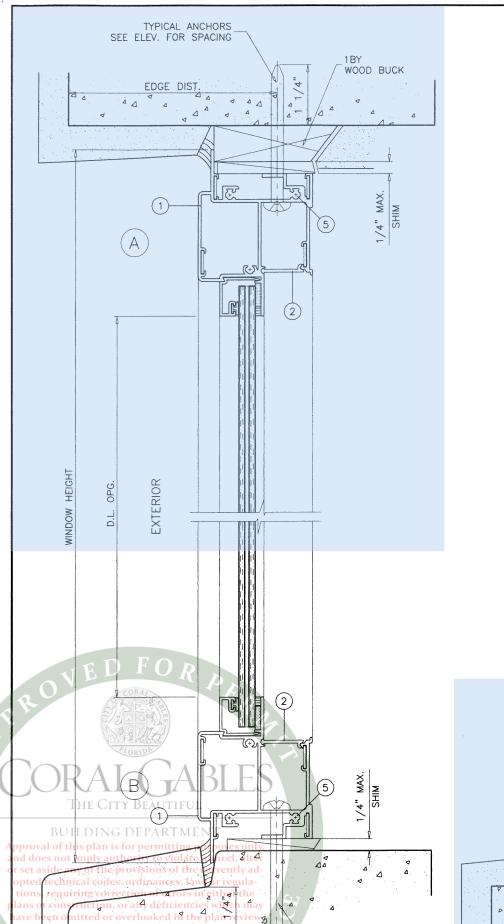
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SERIES 5100 ALUMINUM FIXED

drawing no.

W11 - 15sheet 2 of 7




TYPICAL ANCHORS

10/25/2024


EDGE DIST.


SITE SET BLDR-24-04-5272

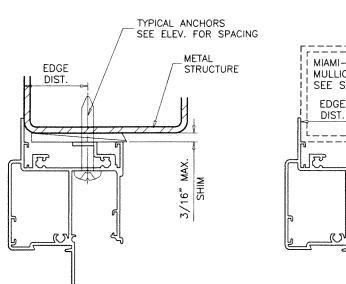

MUST SUSTAIN LOADS IMPOSED BY GLAZING SYSTEM

AND TRANSFER THEM TO THE BUILDING STRUCTURE.

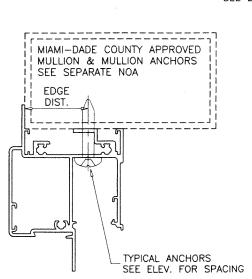

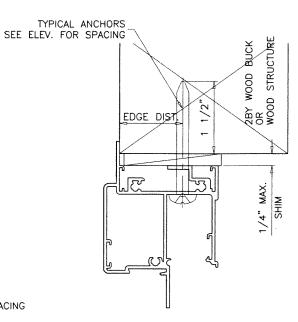

WOOD BUCKS AND METAL STRUCTURE NOT BY 'E.S. WINDOWS'

TYPICAL ANCHORS: SEE ELEV. FOR SPACING

1/4" DIA. ULTRACON+ BY 'DEWALT' (Fu=164 KSI, Fy=148 KSI)

INTO 2BY WOOD BUCKS OR WOOD STRUCTURES 1-1/2" MIN. PENETRATION INTO WOOD (HEAD/SILL/JAMBS)

THRU 1BY BUCKS INTO CONC. OR BLOCKS

1-1/4" MIN. EMBED INTO CONCRETE (HEAD/SILL/JAMBS)

1-1/4" MIN. EMBED INTO BLOCKS (JAMBS)

DIRECTLY INTO CONCRETE OR BLOCKS

1-1/4" MIN. EMBED INTO CONCRETE (HEAD/SILL/JAMBS)

1-1/4" MIN. EMBED INTO BLOCKS (JAMBS)

1-3/4" MIN. EMBED INTO CONC. (FOR MULLION CLIPS ONLY)

#14 SMS OR SELF DRILLING SCREWS (GRADE 2 CRS)

INTO MIAMI-DADE COUNTY APPROVED MULLIONS

INTO METAL STRUCTURES (HEAD/SILL/JAMBS)

(3) THREADS MIN. PENETRATION BEYOND SUBSTRATE

ALUMINUM: 1/8" THK. MIN. (6063-T5 MIN.)

STEEL: 1/8" THK. MIN. (Fy = 36 KSI MIN.)

(STEEL IN CONTACT WITH ALUMINUM TO BE PLATED OR PAINTED)

#### TYPICAL EDGE DISTANCE

INTO CONCRETE AND MASONRY = 2-1/2" MIN.


INTO CONCRETE = 1-1/2" MIN. (INTERIOR ANCHORS AT MULL CLIP)

INTO WOOD STRUCTURE = 1" MIN.

INTO METAL STRUCTURE = 3/4" MIN.

WOOD AT HEAD, SILL OR JAMBS SG = 0.55 MIN.

CONCRETE AT HEAD, SILL OR JAMBS f'c = 3000 PSI MIN. C-90 HOLLOW/FILLED BLOCK AT JAMBS I'm = 2000 PSI MIN.

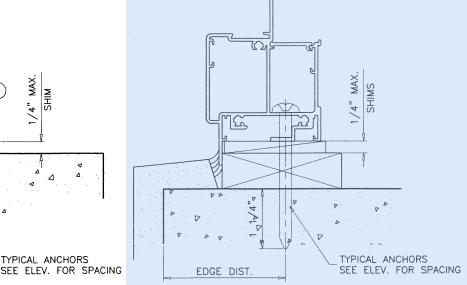

**PRODUCT REVISED** NOA-No. **Expiration Date: 09/22/2026** 

By: Manuel Peres Miami-Dade Product Control



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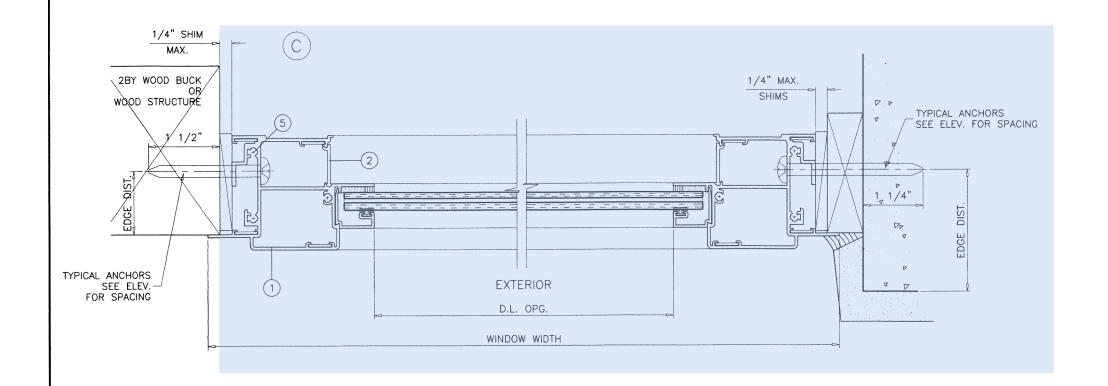
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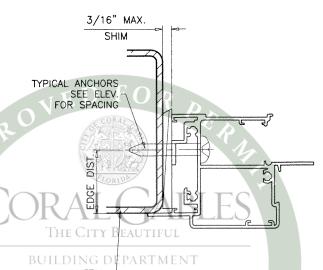
E.S. WINDOWS, LLC 3550 N.W. 49 STREET MIAMI, FL. 33142 TEL. (305) 638-5151 FAX.

drawing

sheet 3 of 7

As complying with the Florida Building Code






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10/25/2024 SITE SET BLDR-24-04-5272 PRODUCT REVISED
As complying with the Florida
Building Code
NOA-No. 23-0724.08

Expiration Date: 09/22/2026

By: Manuel Pres Miami-Dade Product Control

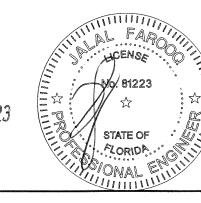

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 AL-FAROOQ CORPORATION

 ENGINEERS & PRODUCT DEVELOPMENT

 9360 SUNSET DRIVE, SUITE 220

 MIAMI, FLORIDA 33173
 (C.A.N. 3538)


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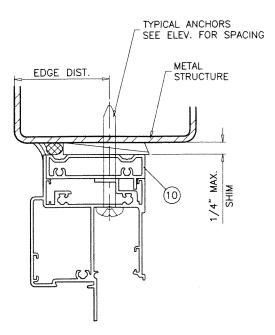
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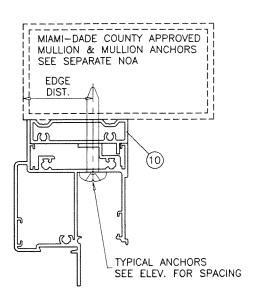
SERIES 5100 ALUMINUM FIXED WDW.


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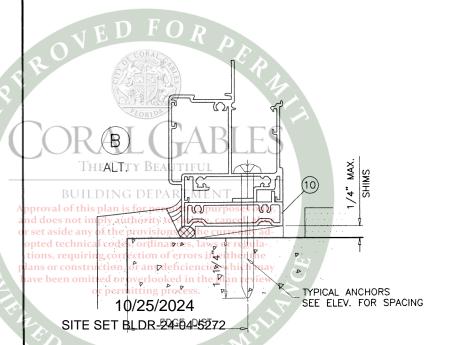
drawing no. W11 - 15sheet 4 of 7







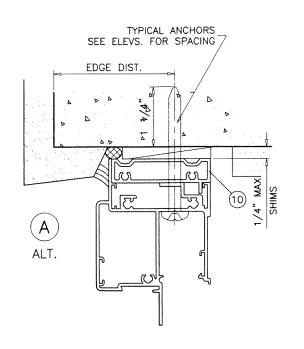

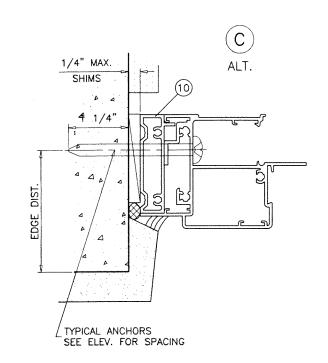

**PRODUCT REVISED** As complying with the Florida Building Code 23-0724.08

Expiration Date: 09/22/2026

By: Manuel Pers

Miami-Dade Product Control

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DRPORATION	T DEVELOPMENT	UITE 220	3 (C.A.N. 3538)	FAX. (305) 262-6978
AL-FAROOQ CORPORATION	<b>ENGINEERS &amp; PRODUCT DEVELOPMENT</b>	9360 SUNSET DRIVE, SUITE 220	MIAMI, FLORIDA 33173	TEL. (305) 264-8100


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W11 - 15

sheet 5 of 7

INSTALLATION DETAILS WITH FLUSH FRAME ADAPTER



			OF THE PROPERTY OF THE PROPERT	PARTICULAR DE LA COMPANION DE			
	MULLION LO	OAD CAPACITY	- PSF		MULLION LO	AD CAPACITY	- PSF
WINDO	W DIMS.	1 X 3 STD. MULL	1 X 3 CUSTOM MULL	WINDO	W DIMS.	1 X 3 STD. MULL	1 X 3 CUSTOM MULL
	. 5110511 (1)	EXT.(+)	EXT.(+)	WIDTH (W)	I ENOTH (1)	EXT.(+)	EXT.(+)
<u> </u>	LENGTH (L)	<u>`</u>	INT.(-)		LENGTH (L)		INT.(-)
26-1/2"		90.0	90.0	30"		90.0	90.0
37"		90.0	90.0	36"		90.0	90.0
42"		90.0	90.0	42"		90.0	90.0
45"	58"	90.0	90.0	48"	54"	90.0	90.0
48"		90.0	90.0	54"		90.0	90.0
53-1/8"		90.0	90.0	60"		90.0	90.0
62"		90.0	90.0	62"		90.0	90.0
26-1/2"		90.0	90.0	30"		90.0	90.0
37"		90.0	90.0	36"		90.0	90.0
42"		90.0	90.0	42"		90.0	90.0
45"	63"	90.0	90.0	48"	60"	90.0	90.0
48"	63"	90.0	90.0	54"		90.0	90.0
53-1/8"		90.0	90.0	60"		90.0	90.0
62"		90.0	90.0	62"		90.0	90.0
26-1/2"		90.0	90.0	30"		90.0	90.0
37"		90.0	90.0	36"		90.0	90.0
42"		82.5	90.0	42"	66"	90.0	90.0
45"	74-1/4"	78.6	90.0	48"	00	90.0	90.0
48"		75.4	87.4	54"		90.0	90.0
53-1/8"		71.0	83.2	59"		90.0	90.0
26-1/2"		90.0	90.0	30"		90.0	90.0
37"		84.2	90.0	36"		90.0	90.0
42"		76.4 90.0	90.0	42"	72"	90.0	90.0
45"	76"	72.8	87.6	48"		83.6	90.0
48"		69.7	84.5	54"		78.4	86.8
51"		67.1	81.9	30"	<u> </u>	90.0	90.0
Lumman	<u> </u>	1	.4	36"		86.1	90.0
				42"	76"	76.4	90.0
				48"		69.7	84.5

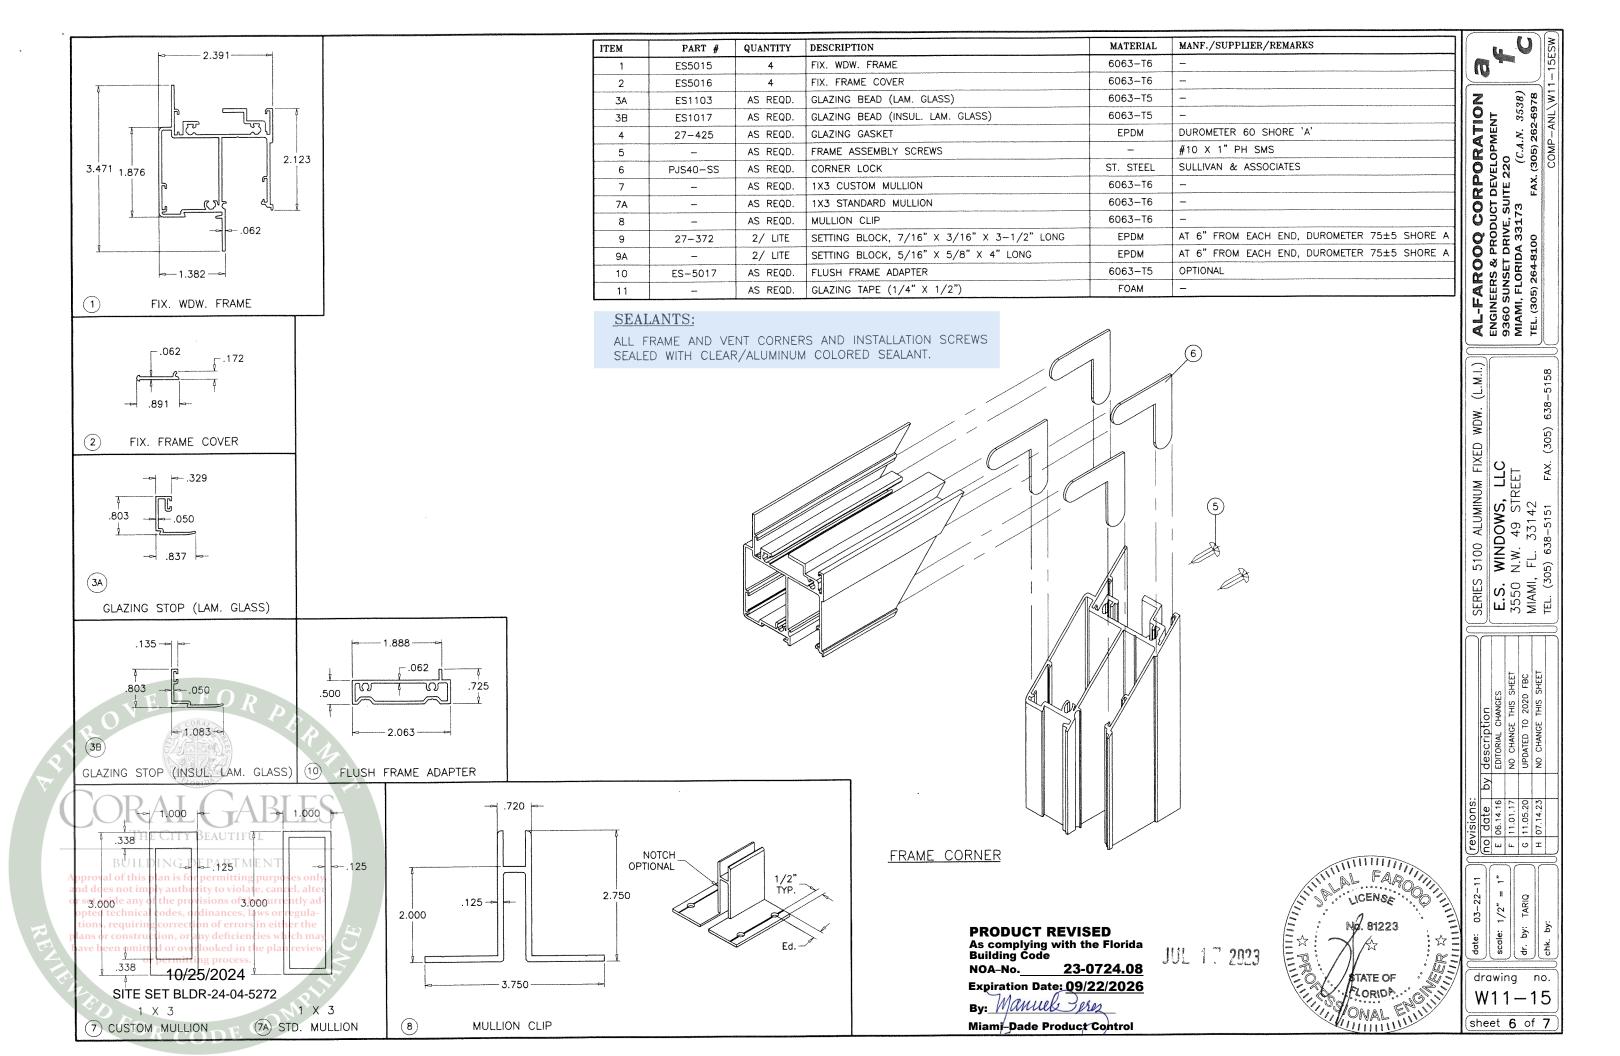51"

67.1

81.9


### NOTES:

- 1. USE CHART ON THIS SHEET FOR SIDE BY SIDE CONNECTION CAPACITY OF WINDOW MULLION.
- 2. FOR FIXED WINDOW CAPACITY SEE SHEET 2 OF 7.
- . LOWER VALUES FROM STEPS 1 OR 2 WILL APPLY TO ENTIRE SYSTEM.




10/25/2024 SITE SET BLDR-24-04-5272


### CLIPPED MULLIONS

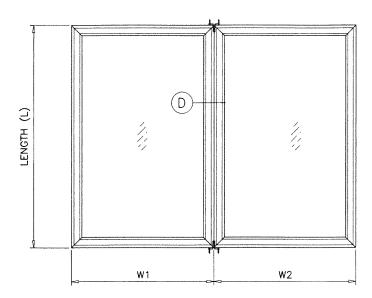

TYPICAL ELEVATION SIDE BY SIDE WINDOWS SIDE BY SIDE APPLIES TO TWO OR MORE WINDOWS

WIDTH (W) =  $\frac{W1 + W2}{2}$ 

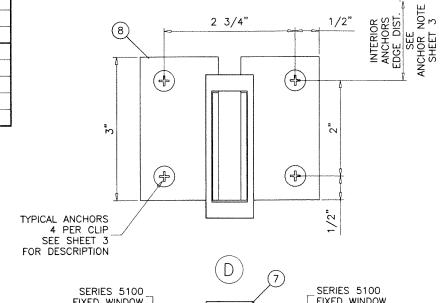

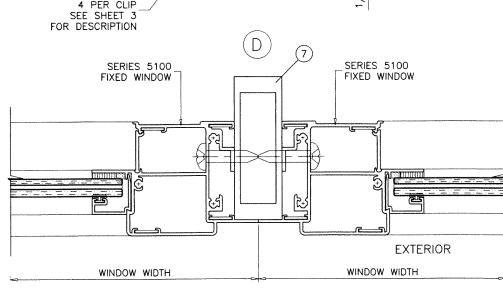


PRODUCT REVISED
As complying with the Florida
Building Code NOA-No. 23-0724.08

Expiration Date: 09/22/2026

By: Manuel Pro

Miami-Dade Product Control

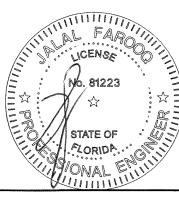



 AL-FAROOQ CORPORATION

 ENGINEERS & PRODUCT DEVELOPMENT

 9360 SUNSET DRIVE, SUITE 220

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 (C.A.N. 3538)

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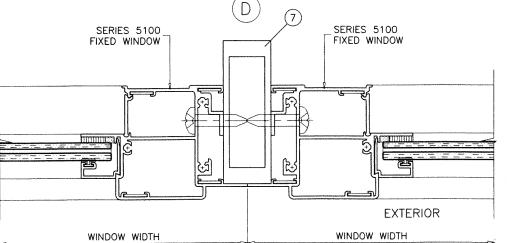
(L.M.I.)

SERIES 5100 ALUMINUM FIXED WDW. (I
E.S. WINDOWS, LLC
3550 N.W. 49 STREET
MIAMI, FL. 33142
TEL. (305) 638-5151 FAX. (305) 638-3

scale: 1/2" <u>ج</u> | 등 || 충

drawing no.

W11 - 15sheet 7 of 7



**MULLION** 

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veronica@afceng.com

ssabagh@energiasolarsa.com

Jalal Farooq

Samir Sabagh

3550 NW 49th St. Miami, FL 33142 (305) 638-5151

# **Business & Professional Regulation**





PA-02



Product Approval Menu > Product or Application Search > Application List > Application Detail

FL41000-R1 Application Type Revision Code Version 2023 **Application Status** Approved

Comments Archived

Product Manufacturer Address/Phone/Email

Authorized Signature

Technical Representative Address/Phone/Email

Quality Assurance Representative Address/Phone/Email

Category Subcategory

Compliance Method

Windows

Casement

Evaluation Report from a Florida Registered Architect or a Licensed Florida Professional Engineer

Evaluation Report - Hardcopy Received

Florida Engineer or Architect Name who developed the Evaluation Report

Florida License

Quality Assurance Entity

Quality Assurance Contract Expiration Date

Validated By

Certificate of Independence

Approval of this Referenced Standard and Year (of Standard)

have been omitted or overlooked in the plan revi Equivalence of Product Standards

Certified By 10/25/2024

SITE SET, BLDR-24-04-5272

Jalal Farooq

PE-81223

Keystone Certifications, Inc.

07/16/2025

Abel Carrasco, PE

☑ Validation Checklist - Hardcopy Received

FL41000 R1 COI SS - Certificate of Independence 2023.pdf

<u>Standard</u>	<u>Year</u>
TAS 201	1994
TAS 202	1994
TAS 203	1994

Product Approval Method 1 Option D

Date Submitted08/01/2023Date Validated08/01/2023Date Pending FBC Approval08/02/2023Date Approved10/18/2023

#### **Summary of Products**

FL#	Model, Number or Name	Description
41000.1	Series 5000 Aluminum Casement Window	Large missile impact resistant aluminum casement window.
Limits of Use Approved for use in H Approved for use outs Impact Resistant: Yes Design Pressure: +90, Other: See installation combinations and installation	side HVHZ: Yes /-114 drawings 21-68F for span vs load	Installation Instructions FL41000 R1 II SS - 5000 OS Casement (LMI) - DWG 21-68F 2023.pdf Verified By: Jalal Farooq PE # 81223 Created by Independent Third Party: Yes Evaluation Reports FL41000 R1 AE SS - 5000 Casement (LMI)-PAE 2023.pdf Created by Independent Third Party: Yes

Back

Next

Contact Us:: 2601 Blair Stone Road, Tallahassee FL 32399 Phone: 850-487-1824

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#### Product Approval Accepts:











Approval of this plan is for permitting purposes only and does not imply authority to violate, cancel, alter or set aside any of the provisions of the currently adopted technical codes, ordinances, laws or regulations, requiring correction of errors in either the plans or construction, or any deficiencies which may have been omitted or overlooked in the plan review

10/25/2024 SITE SET BLDR-24-04-5272



# AL-FAROOQ CORPORATION

CONSULTING ENGINEERS & PRODUCT DEVELOPMENT

# PRODUCT APPROVAL EVALUATION RULE CHAPTER #61G20-3 • METHOD 1 OPTION D

FL 41000

Date: 07/31/2023

**Detailed Product Description: Manufacturer:** E.S. WINDOWS, LLC.

Manufacturer Address: 3550 N.W. 49 STREET – MIAMI, FL. 33142

Model Name: SERIES 5000 ALUMINUM CASEMENT WINDOW

Maximum Load: +90 PSF, -114 PSF (Large Missile Impact)

**Installation Drawings #** 21-68F

This product complies with the High Velocity Hurricane Zone (HVHZ) testing requirements.

For maximum sizes, combination of span vs loads and anchor type refer to installation drawings.

Comparative analysis used X Yes No

#### Mandatory Tests (Tested in accordance with AAMA 101/I.S.2/NAFS/TAS-202)

	, , , , , , , , , , , , , , , , , , , ,			- ,,	· - ,
TEST	DESCRIPTION	TEST LOCATION	TEST REPORT DATE	TEST REPORT #	Test Sealed by
ASTM E283	Air Infiltration	Fenestration Testing	03/16/2011	FTL-6294	Marlin D Brinson,PE
	Leakage	Laboratory, Inc	03/16/2011	FTL-6295	Marlin D Brinson,PE
		,,	11/16/2007	FTL-58336	Carlos S Rionda,PE
			06/19/2020	FTL-12112	Idalmis Ortega, PE
			02/04/2022	FTL-12657	Idalmis Ortega, PE
ASTM E331	Water	Fenestration Testing	03/16/2011	FTL-6294	Marlin D Brinson,PE
OR ASTM 547	Penetration	Laboratory, Inc	03/16/2011	FTL-6295	Marlin D Brinson,PE
& TAS 202			11/16/2007	FTL-58336	Carlos S Rionda,PE
			06/19/2020	FTL-12112	Idalmis Ortega, PE
			02/04/2022	FTL-12657	Idalmis Ortega, PE
ASTM E330	Uniform Static Air	Fenestration Testing	03/16/2011	FTL-6294	Marlin D Brinson,PE
& TAS 202	Press.	Laboratory, Inc	03/16/2011	FTL-6295	Marlin D Brinson,PE
	TA P		11/16/2007	FTL-58336	Carlos S Rionda,PE
(S)	PRAVE		06/19/2020	FTL-12112	Idalmis Ortega, PE
\$25a		1	02/04/2022	FTL-12657	Idalmis Ortega, PE
ASTM F588	Forced Entry	Fenestration Testing	03/16/2011	FTL-6294	Marlin D Brinson,PE
FL	DRIDA	Laboratory, Inc	03/16/2011	FTL-6295	Marlin D Brinson,PE
(D) A I	( A DI I		11/16/2007	FTL-58336	Carlos S Rionda,PE
UKAL	JABLI		02/04/2022	FTL-12657	Idalmis Ortega, PE
Tyrn Cymr	Danie				

#### BUILDING DEPARTMENT

Approval of this plan is for permitting purposes only and does not imply authority to violate, cancel, alter or set aside any of the provisions of the currently ad opted technical codes, ordinances, laws or regulations, requiring correction of errors in either the plans or construction, or any deficiencies which may have been omitted or overlooked in the plan review

10/25/2024


SITE SET BLDR-24-04-5272

	Supplemental Tes	sts (Tested in accorda	nce with TAS-20	)1 and TAS-20	3)
TEST	DESCRIPTION	TEST LOCATION	TEST REPORT DATE	TEST REPORT #	Test Sealed by
FBC 1626.2 TAS 201 & 203	Large Missile Impact & Cyclic	Fenestration Testing Laboratory, Inc	07/26/2018 03/16/2011 03/16/2011 11/16/2007 06/19/2020 02/04/2022	FTL-9711 FTL-6294 FTL-6295 FTL-58336 FTL-12112 FTL-12657	Idalmis Ortega, PE Marlin D Brinson,PE Marlin D Brinson,PE Carlos S Rionda,PE Idalmis Ortega, PE Idalmis Ortega, PE

Under the limitations of the attached installation drawings, to the best of my knowledge and ability, the above product conforms to the requirements of the 2023 Florida Building Code.

#### **Evaluation Report Engineer:**

Jalal Farooq PE # 81223 Al-Farooq Corporation EB # 3538

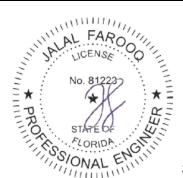

Sealed: 7/31/2023





#### BUILDING DEPARTMENT

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opted actions of the provisions of the Carrents, as opted technical codes, ordinances, laws or regulations, requiring correction of errors in either the 1235-SW-87<sup>th</sup> Avenue of aMiami, Ftn33174 in hTr.305.264.8100 | F: 305.262.6978 | www.afceng.com | alfarooq@afceng.com have been omitted or overlooked in the plan review or permitting process.

10/25/2024 SITE SET BLDR-24-04-5272



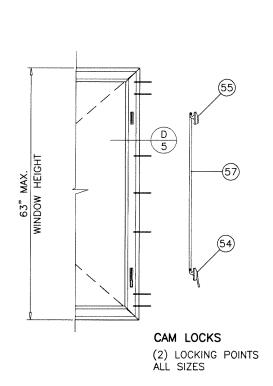
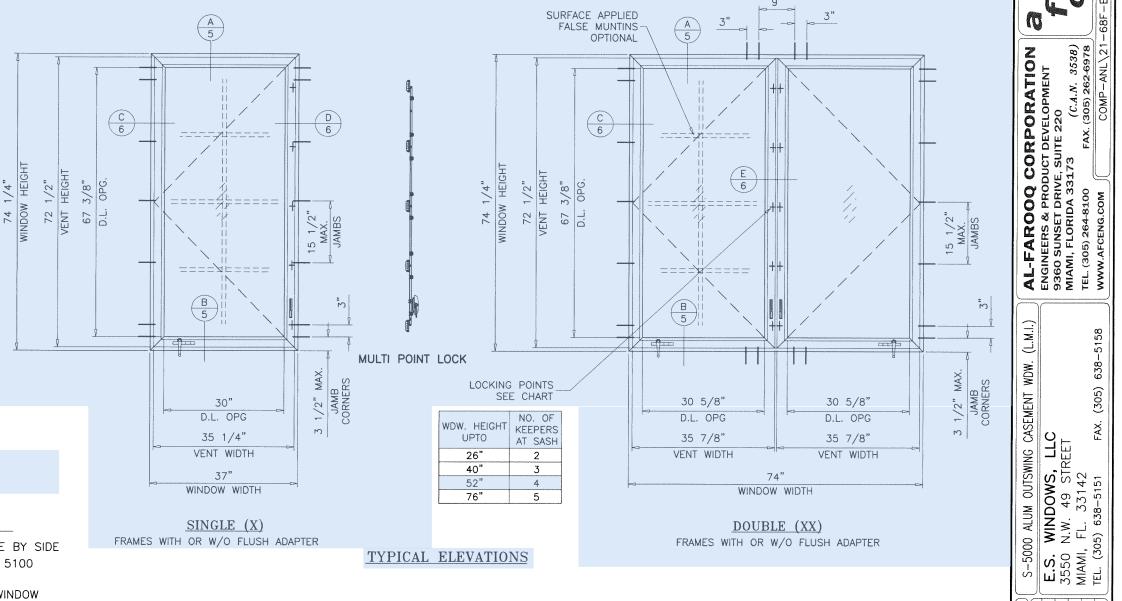
### SERIES 5000 ALUMINUM OUTSWING CASEMENT WINDOW

DESIGN LOAD RATINGS FOR THESE WINDOWS TO BE AS PER CHARTS SHOWN ON SHEETS 3 AND 3.1.

APPROVAL APPLIES TO SINGLE OR DOUBLE WINDOWS OR SIDE BY SIDE COMBINATIONS OF CASMT/CASMT OR CASEMENT WITH SERIES 5100 FIXED WINDOWS USING MULLIONS IN BETWEEN. LOWER DESIGN PRESSURE FROM CASEMENT WINDOW, FIXED WINDOW OR MULLION CHART WILL APPLY TO ENTIRE SYSTEM.

THIS PRODUCT HAS BEEN DESIGNED AND TESTED TO COMPLY WITH THE REQUIREMENTS OF THE 2020 (7TH EDITION)/2023 (8TH EDITION) FLORIDA BUILDING CODE INCLUDING HIGH VELOCITY HURRICANE ZONE (HVHZ).

1BY OR 2BY WOOD BUCKS & BUCK FASTENERS BY OTHERS, MUST BE DESIGNED AND INSTALLED ADEQUATELY TO TRANSFER APPLIED PRODUCT LOADS TO THE BUILDING STRUCTURE.

ANCHORS SHALL BE CORROSION RESISTANT, SPACED AS SHOWN ON DETAILS AND INSTALLED PER MANUF'S INSTRUCTIONS. SPECIFIED EMBEDMENT TO BASE MATERIAL SHALL BE BEYOND WALL DRESSING OR STUCCO.

A LOAD DURATION INCREASE IS USED IN DESIGN OF ANCHORS INTO WOOD ONLY.

ALL SHIMS TO BE HIGH IMPACT, NON-METALLIC AND NON-COMPRESSIBLE.

MATERIALS INCLUDING BUT NOT LIMITED TO STEEL/METAL SCREWS, THAT COME INTO CONTACT WITH OTHER DISSIMILAR MATERIALS SHALL MEET THE REQUIREMENTS OF THE 2020/2023 FLORIDA BLDG. CODE & ADOPTED STANDARDS.

THIS PRODUCT APPROVALUS GENERIC AND DOES NOT PROVIDE INFORMATION FOR A SITE SPECIFIC PROJECT, i.e. LIFE SAFETY OF THIS PRODUCT, ADEQUACY OF STRUCTURE RECEIVING THIS PRODUCT AND SEALING AROUND OPENING FOR WATER INFILTRATION RESISTANCE ETC.

conditions not shown in this drawing are to be analyzed separately, and to be reviewed by building official.


Design loads \$1902542924 ased on 'allowable stress design (asd)'.

MANUFACTURES BLDER-34FALT-5272 LOCATED ON A READILY VISIBLE LOCATION IN ACCORDANCE WITH SECTION 1709.9.3 OF FLORIDA BUILDING CODE. LABELING TO COMPLY WITH SECTION 1709.9.2.

THESE WINDOWS ARE RATED FOR LARGE & SMALL MISSILE IMPACT. SHUTTERS ARE NOT REQUIRED.

### Sealed: 7/31/2023

- A- CONTRACTOR TO BE RESPONSIBLE FOR THE SELECTION, PURCHASE AND INSTALLATION OF THIS PRODUCT BASED ON THIS PRODUCT EVALUATION PROVIDED HE/SHE DOES NOT DEVIATE FROM THE CONDITIONS DETAILED ON THIS DOCUMENT.
- -THIS PRODUCT EVALUATION DOCUMENT WILL BE CONSIDERED INVALID IF ALTERED BY ANY MEANS.
- SITE SPECIFIC PROJECTS SHALL BE PREPARED BY A FLORIDA REGISTERED ENGINEER OR ARCHITECT WHICH WILL BECOME THE ENGINEER OF RECORD (E.O.R.) FOR THE PROJECT AND WHO WILL BE RESPONSIBLE FOR THE PROPER USE OF THE P.E.D. ENGINEER OF RECORD, ACTING AS A DELEGATED ENGINEER TO THE P.E.D. ENGINEER SHALL SUBMIT TO THIS LATTER THE SITE SPECIFIC DRAWINGS FOR REVIEW.
- D—THIS P.E.D. SHALL BEAR THE DATE AND ORIGINAL SEAL AND SIGNATURE OF THE PROFESSIONAL ENGINEER OF RECORD THAT PREPARED IT.

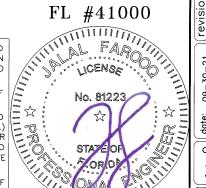

description UPDATED TO 2023 revisions: no date A 07.12.23 1/2"=1'-0" 09-30-21 TARIQ څ <u>ئ</u>

(C.A.N. 3538) FAX. (305) 262-6978

ENGINEERS & PRODUCT DEVEL 9360 SUNSET DRIVE, SUITE 22/ MIAMI, FLORIDA 33173


CORPORATION

AL-FAROOQ ENGINEERS & PRO

(L.M.I.)

drawing no.

21-68F sheet 1 of 12

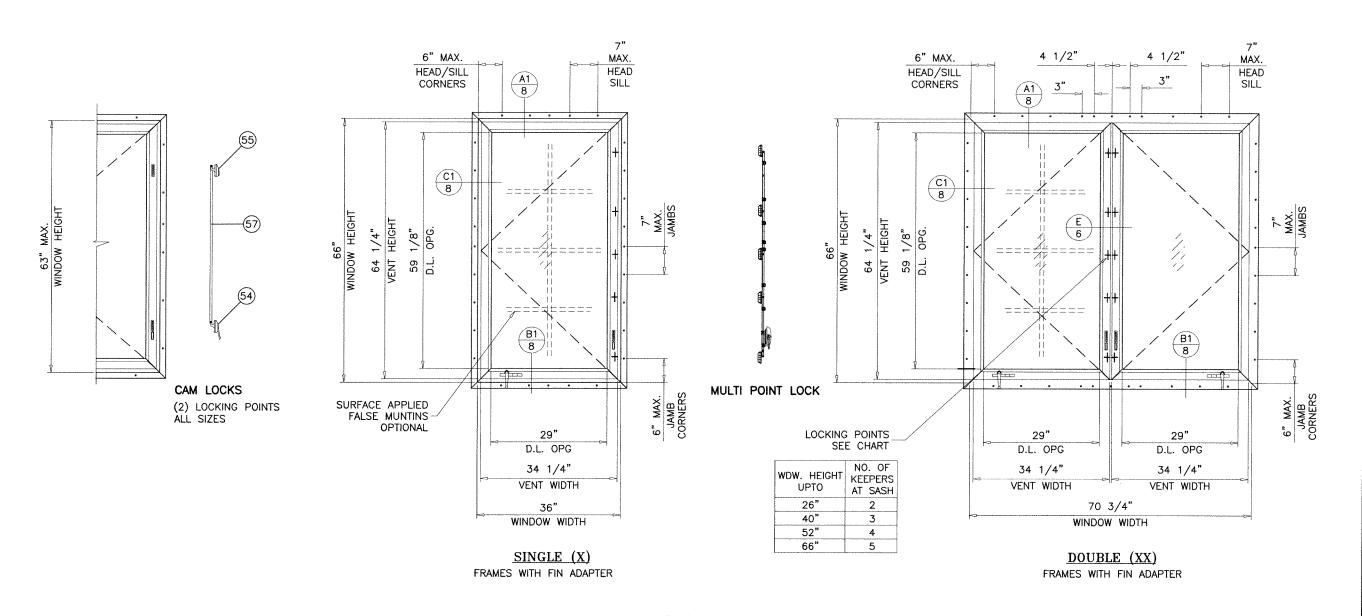


### TYPICAL ELEVATION

FOR WINDOWS WITH FIN FRAME ADAPTERS LIMIT MAX. DESIGN LOAD TO ±70.0 PSF



10/25/2024 SITE SET BLDR-24-04-5272

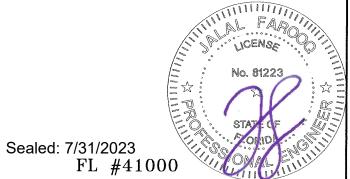

revisions: no date by description scale: 1/2"=1'-0"

drawing no. 21-68F sheet 2 of 12

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AL-FAROOQ CORPORATION
ENGINEERS & PRODUCT DEVELOPMENT
9360 SUNSET DRIVE, SUITE 220
MIAMI, FLORIDA 33173 (C.A.N. 3538)
TEL. (305) 264-8100 FAX. (305) 262-6978

WWW.AFGENG.COM COMP-ANL\21-

638-5158

(305)

E.S. WINDOWS, LLC 3550 N.W. 49 STREET MIAMI, FL. 33142 TEL. (305) 638-5151 FAX.

(L.M.I.)

S-5000 ALUM OUTSWING CASEMENT WDW.

K COD!

					DESIGN	LOAD CAF	PACITY -	PSF FOR	R ( X ) S	SIZES					
			WITH CA	AM LOCKS	3			WINDOWS	WITH M	ULTI POII	NT LOCK				
WINDO	W DIMS.		TYPES D, E, F		TYPE H'	4	TYPE		TYPE B'	1	TYPES 'E', 'F'		TYPE G'	t	TYPE H'
WIDTH	HEIGHT	EXT.(+)	1NT.(-)	EXT.(+)	1NT.(-)	EXT.(+)	1NT.(-)	EXT.(+)	1NT.(-)	EXT.(+)	1NT.(-)	EXT.(+)	1NT.(-)	EXT.(+)	1NT.(-)
19-1/8"		85.0	85.0	70.0	70.0	85.0	85.0	90.0	90.0	90.0	90.0	90.0	114.0	70.0	70.0
26-1/2"	26"	85.0	85.0	70.0	70.0	85.0	85.0	90.0	90.0	90.0	90.0	90.0	114.0	70.0	70.0
37"		85.0	85.0	70.0	70.0	85.0	85.0	90.0	90.0	90.0	90.0	90.0	102.8	70.0	70.0
42" 19-1/8"		85.0 85.0	85.0 85.0	70.0 70.0	70.0	85.0 85.0	85.0 85.0	90.0	90.0	90.0	90.0	90.0	90.6	70.0	70.0
26-1/2"		85.0	85.0	70.0	70.0	85.0	85.0	90.0	90.0	90.0	90.0	90.0	114.0	70.0 70.0	70.0
37"	38-3/8"	85.0	85.0	70.0	70.0	85.0	85.0	90.0	90.0	90.0	90.0	90.0	104.5	70.0	70.0
42"		85.0	85.0	70.0	70.0	85.0	85.0	90.0	90.0	90.0	90.0	90.0	92.0	70.0	70.0
19-1/8"		85.0	85.0	70.0	70.0	85.0	85.0	90.0	90.0	90.0	90.0	90.0	114.0	70.0	70.0
26-1/2"	50-5/8"	85.0	85.0	70.0	70.0	85.0	85.0	90.0	90.0	90.0	90.0	90.0	114.0	70.0	70.0
37"	30-3/6	85.0	85.0	70.0	70.0	85.0	85.0	90.0	90.0	90.0	90.0	90.0	105.6	70.0	70.0
42"		85.0	85.0	70.0	70.0	85.0	85.0	90.0	90.0	90.0	90.0	90.0	93.0	70.0	70.0
19-1/8"		85.0	85.0	70.0	70.0	85.0	85.0	90.0	90.0	90.0	90.0	90.0	114.0	70.0	70.0
26-1/2"	63"	85.0	85.0	70.0	70.0	85.0	85.0	90.0	90.0	90.0	90.0	90.0	114.0	70.0	70.0
37"		85.0	85.0	70.0	70.0	85.0	85.0	90.0	90.0	90.0	90.0	90.0	106.1	70.0	70.0
42"		_		_	-			_	_	90.0	90.0	90.0	93.4	_	
19-1/8"		_		_	-	_	_	_	_	90.0	90.0	90.0	114.0	70.0	70.0
26-1/2"	74-1/4"	-	_	_	-	_	_	_	-	90.0	90.0	90.0	114.0	62.1	62.1
37" 19-1/8"			-		_					90.0	90.0	90.0	90.0	70.0	70.0
26-1/2"	76"		_						_	90.0	90.0	90.0	114.0	70.0	70.0
36"	76			<del></del>	_		_	<del></del>	_	90.0 85.4	90.0 85.4	90.0 85.4	111.1 85.4	57.8 —	57.8
24"		85.0	85.0	70.0	70.0	85.0	85.0	90.0	90.0	90.0	90.0	90.0	114.0	70.0	70.0
28"		85.0	85.0	70.0	70.0	85.0	85.0	90.0	90.0	90.0	90.0	90.0	114.0	70.0	70.0
32"		85.0	85.0	70.0	70.0	85.0	85.0	90.0	90.0	90.0	90.0	90.0	114.0	70.0	70.0
36"	48"	85.0	85.0	70.0	70.0	85.0	85.0	90.0	90.0	90.0	90.0	90.0	114.0	70.0	70.0
40"		85.0	85.0	70.0	70.0	85.0	85.0	90.0	90.0	90.0	90.0	90.0	103.0	70.0	70.0
42"		85.0	85.0	70.0	70.0	85.0	85.0	90.0	90.0	90.0	90.0	90.0	98.1	70.0	70.0
24"		85.0	85.0	70.0	70.0	85.0	85.0	90.0	90.0	90.0	90.0	90.0	114.0	70.0	70.0
28"		85.0	85.0	70.0	70.0	85.0	85.0	90.0	90.0	90.0	90.0	90.0	114.0	70.0	70.0
32"	54"	85.0	85.0	70.0	70.0	85.0	85.0	90.0	90.0	90.0	90.0	90.0	114.0	70.0	70.0
36"	54	85.0	85.0	70.0	70.0	85.0	85.0	90.0	90.0	90.0	90.0	90.0	114.0	70.0	70.0
40"		85.0	85.0	70.0	70.0	85.0	85.0	90.0	90.0	90.0	90.0	90.0	114.0	70.0	70.0
42"		85.0	85.0	70.0	70.0	85.0	85.0	90.0	90.0	90.0	90.0	90.0	109.0	70.0	70.0
24"	1 E.D	85.0	85.0	70.0	70.0	85.0	85.0	90.0	90.0	90.0	90.0	90.0	114.0	70.0	70.0
28"		85.0	85.0	70.0	70.0	85.0	85.0	90.0	90.0	90.0	90.0	90.0	114.0	70.0	70.0
32" 36"	60"	85.0 85.0	85.0 85.0	70.0 70.0	70.0 70.0	85.0 85.0	85.0 85.0	90.0	90.0	90.0	90.0	90.0	114.0	70.0	70.0
40"	5/3	- 63.0	- 65.0	70.0	70.0	- 65.0	- 65.0	90.0	90.0	90.0 90.0	90.0	90.0	114.0 103.0	70.0	70.0
42"	1. F.		_	_		_	_	_		90.0	90.0	90.0	98.1		
26-3/8"	60-3/4"	CORIDA	_				_	_	_	-	-	90.0	114.0	_	_
36"	60-3/4"	-			$C \perp$	_	_		_	_		_	_	70.0	70.0
24"	$\mathcal{M}$	85.0	85.0	70.0	70.0	85.0	85.0	90.0	90.0	90.0	90.0	90.0	114.0	70.0	70.0
28"	The Cit	85.0U	85.0	70.0	70.0	85.0	85.0	90.0	90.0	90.0	90.0	90.0	114.0	70.0	70.0
32" <sub>B.L.</sub>	ILDING	85.0	_85.0	_ 70.0	70.0	85.0	85.0	90.0	90.0	90.0	90.0	90.0	114.0	70.0	70.0
ppr36" of	this plan is	or permi	tting pur	poses onl	V, –	-	_	_	_	90.0	90.0	90.0	104.1	70.0	70.0
nd 40'es no	t imply autl	iori <del>ty</del> to v	iolate, ca	nce <del>l,</del> alte	т —	-	_	_		90.0	90.0	90.0	93.7	_	
r set aside l 24 opted tech	nical codes.	ordinana	of the cur es, laws c	rrently ac or regula-	l/	<u> </u>		_	-	90.0	90.0	90.0	114.0	70.0	70.0
tio28" regu	iring corre	ction of e	rror <del>s</del> in e	ithe <del>r</del> the	76.		_	-	-	90.0	90.0	90.0	114.0	65.1	65.1
ian32" con iave been o	72" struction, o mitted or o	verlooked	l in the o	which ma an reviev	y –		-	-		90.0	90.0	90.0	107.3	58.1	58.1
		THE PLO		an reviev				-	-	90.0	90.0	90.0	95.4		_
24"	- 1	25/20				-		-	_	90.0	90.0	90.0	114.0	63.2	63.2
<sup>28</sup> " SIT	TE S€T BL	DR-24-	04-5272		<u> </u>	_	_			90.0	90.0	90.0	105.7	55.0	55.0
32"		-				_		-		90.0	90.0	90.0	94.1	_	
36"	$\cap$								_	85.4	85.4	85.4	85.4	-	

FOR SINGLE (X) CASEMENT SIZES WITH FIN FRAME ADAPTERS LIMIT MAX. DESIGN LOAD TO  $\pm 70.0~\mathrm{PSF}$ LIMIT MAX. WINDOW AREA TO 16.5 SQ. FT.

GLASS CAPACITIES ON THIS SHEET ARE
BASED ON ASTM E1300-09 (3 SEC. GUSTS)
AND FLORIDA BUILDING COMMISSION
DECLARATORY STATEMENT DCA05-DEC-219

FL #410

FL #41000

### AL-FAROOQ CORPORATION
| ENGINEERS & PRODUCT DEVELOPMENT |
| 9360 SUNSET DRIVE, SUITE 220 |
| MIAMI, FLORIDA 33173 | (C.A.N. 3538) |
| TEL. (305) 264-8100 | FAX. (305) 262-6978 |
| www.AFGENG.COM | COMP-ANL\21-6 E.S. WINDOWS, LLC
3550 N.W. 49 STREET
MIAMI, FL. 33142
TEL. (305) 638–5151 FAX. (305) 638–5158 revisions: dr. by: date:

drawing no.

21-68F sheet 3 of 12

			DE	SIGN LOA	D CAPACI	TY - PS	F FOR (	XX ) SIZ	ES				
			WITH CA	AM LOCKS	S			WINDOWS	WITH MI	ULTI POIN	T LOCK		
WINDO	W DIMS.		TYPES D, E, F	1	TYPE H'	1	TYPE A'		TYPE B'		TYPES E', 'F', 'G'		TYPE H'
WIDTH	HEIGHT	EXT.(+)	1NT.(-)	EXT.(+)	1NT.(-)	EXT.(+)	1NT.(-)	EXT.(+)	1NT.(-)	EXT.(+)	1NT.(-)	EXT.(+)	1NT.(-)
37"	26"	85.0	85.0	70.0	70.0	85.0	85.0	90.0	90.0	90.0	90.0	70.0	70.0
53-1/8"	26	85.0	85.0	70.0	70.0	85.0	85.0	90.0	90.0	90.0	90.0	70.0	70.0
37"		85.0	85.0	70.0	70.0	85.0	85.0	90.0	90.0	90.0	90.0	70.0	70.0
53-1/8"	38-3/8"	85.0	85.0	70.0	70.0	85.0	85.0	90.0	90.0	90.0	90.0	70.0	70.0
74"	30 3/0	85.0	85.0	70.0	70.0	85.0	85.0	90.0	90.0	90.0	90.0	70.0	70.0
84"		85.0	85.0	70.0	70.0	85.0	85.0	90.0	90.0	90.0	90.0	70.0	70.0
37"		85.0	85.0	70.0	70.0	85.0	85.0	90.0	90.0	90.0	90.0	70.0	70.0
53-1/8"	50-5/8"	85.0	85.0	70.0	70.0	85.0	85.0	90.0	90.0	90.0	90.0	70.0	70.0
74"	00 0/0	85.0	85.0	70.0	70.0	85.0	85.0	90.0	90.0	90.0	90.0	70.0	70.0
84"		85.0	85.0	70.0	70.0	85.0	85.0	90.0	90.0	90.0	90.0	70.0	70.0
37"		85.0	85.0	70.0	70.0	85.0	85.0	90.0	90.0	90.0	90.0	70.0	70.0
53-1/8"	63"	79.6	79.6	70.0	70.0	79.6	79.6	79.6	79.6	79.6	79.6	70.0	70.0
74"		61.4	61.4	61.4	61.4	61.4	61.4	61.4	61.4	61.4	61.4	61.4	61.4
84"			_	_			_		_	56.5	56.5		-
37"					_	-		_	_	66.6	66.6	66.6	66.6
53-1/8"	74-1/4"	_	_		_	_		-	-	47.6	47.6	47.6	47.6
74"			_	_			_	-	_	36.0	36.0	_	
37"		_	_	_		_		_		62.0	62.0	62.0	62.0
53-1/8"	76"	_	-	_					-	44.3	44.3	44.3	44.3
74"			_		_	_	-		_	33.4	33.4	_	_
48"		85.0	85.0	70.0	70.0	85.0	85.0	90.0	90.0	90.0	90.0	70.0	70.0
56"		85.0	85.0	70.0	70.0	85.0	85.0	90.0	90.0	90.0	90.0	70.0	70.0
64"	_	85.0	85.0	70.0	70.0	85.0	85.0	90.0	90.0	90.0	90.0	70.0	70.0
72"	48"	85.0	85.0	70.0	70.0	85.0	85.0	90.0	90.0	90.0	90.0	70.0	70.0
80"		85.0	85.0	70.0	70.0	85.0	85.0	90.0	90.0	90.0	90.0	70.0	70.0
84"		85.0	85.0	70.0	70.0	85.0	85.0	90.0	90.0	90.0	90.0	70.0	70.0
48"		85.0	85.0	70.0	70.0	85.0	85.0	90.0	90.0	90.0	90.0	70.0	70.0
56"		85.0	85.0	70.0	70.0	85.0	85.0	90.0	90.0	90.0	90.0	70.0	70.0
64"	n	85.0	85.0	70.0	70.0	85.0	85.0	90.0	90.0	90.0	90.0	70.0	70.0
72"	54"	85.0	85.0	70.0	70.0	85.0	85.0	90.0	90.0	90.0	90.0	70.0	70.0
80"		85.0	85.0	70.0	70.0	85.0	85.0	90.0	90.0	90.0	90.0	70.0	70.0
84"		85.0	85.0	70.0	70.0	85.0	85.0	90.0	90.0	90.0	90.0	70.0	70.0
48"		85.0	85.0	70.0	70.0	85.0	85.0	90.0	90.0	90.0	90.0	70.0	70.0
56" 64"		85.0 80.0	85.0 80.0	70.0 70.0	70.0 70.0	85.0 80.0	85.0 80.0	88.9	88.9	88.9	88.9	70.0	70.0
72"	7 60" D	73.5	73.5	70.0	70.0	73.5	73.5	80.0 73.5	80.0 73.5	80.0 73.5	80.0 73.5	70.0	70.0
80"	30	73.5 COR4/	/ J. J	70.0	70.0	73.5	73.5	/3.5	/3.5	73.5 68.7	73.5 68.7	70.0	70.0 —
84"	AS CONTRACTOR OF THE PARTY OF T		_	2	_					66.8	66.8		
48"	5/3	75.2	75.2	75.2	75.2	75.2	75.2	75.2	75.2	75.2	75.2	70.0	70.0
56"	( - 3)	65.7	65.7	65.7	65.7	65.7	65.7	65.7	65.7	65.7	65.7	65.7	65.7
64"	7	58.9	58.9	58.9	58.9	58.9	58.9	58.9	58.9	58.9	58.9	58.9	58.9
72"	66"		<b>A</b> T	56.9	C	-	-	-	_	53.8	53.8	53.8	53.8
80"				)LE	<b>D_</b>	_		_		49.9	49.9	-	-
48"	THE CIT	y B <u>e</u> au	TIFUL	_	_	_		_	_	57.4	57.4	_	_
56"						_	_	_	_	50.0	50.0		
64" BU	JILDING this <mark>plan is</mark>	DEPAI for perm	TMEN	T poses on	_	_	_	_	_	44.6	44.6	_	
Approval of and 727es no			tting pur viol <del>a</del> te, ca	poses on ince <del>l</del> , alte	lУ, 2Г —		_	_		40.6	40.6	_	_
or set aside	any of the p	rovi <u>s</u> ions	of the cu	rrently a	1	_			_	48.6	48.6	_	_
opted tech	nical codes uiring corre	ordinan ction of a	ces, laws rrors in a	or regula- ither the	-/-	/_				42.3	42.3	_	_
plan <sub>64</sub> er cor	strugion, o	ir any def	iciencies	whi <u>c</u> h ma	y /	7 -	_	_		37.6	37.6	_	_
have been o	mitted or o	verlooke tting pro	d in the p	tan <u>r</u> evie	<b>V</b> 5	/ _			_	34.1	34.1		
L	urperm	HILLIE DEG	CCSS.		Annual Control			L					

10/25/2024 SITE SET BLDR-24-04-5272 FOR DOUBLE (XX) CASEMENT SIZES WITH FIN FRAME ADAPTERS LIMIT MAX. DESIGN LOAD TO  $\pm 70.0$  PSF LIMIT MAX. WINDOW AREA TO 32.4 SQ. FT.

NOTE:
GLASS CAPACITIES ON THIS SHEET ARE
BASED ON ASTM E1300-09 (3 SEC. GUSTS)
AND FLORIDA BUILDING COMMISSION
DECLARATORY STATEMENT DCA05-DEC-219

Sealed: 7/31/2023

FL #41000

AL-FAROOQ CORPORATION
ENGINEERS & PRODUCT DEVELOPMENT
9360 SUNSET DRIVE, SUITE 220
MIAMI, FLORIDA 33173 (C.A.N. 3538)
TEL. (305) 264-8100 FAX. (305) 262-6978

WWW.AFCENG.COM COMP—ANL\21-1 S-5000 ALUM OUTSWING CASEMENT WDW. (L.M.I.)


E.S. WINDOWS, LLC
3550 N.W. 49 STREET
MIAMI, FL. 33142
TEL. (305) 638-5151 FAX. (305) 638-5158 revisions: no date by description dr. by: TARIQ


drawing


21-68F

sheet **3.1**of **12** 


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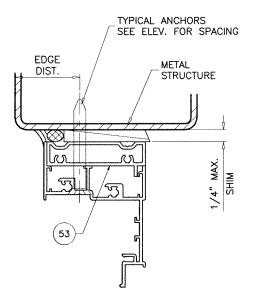


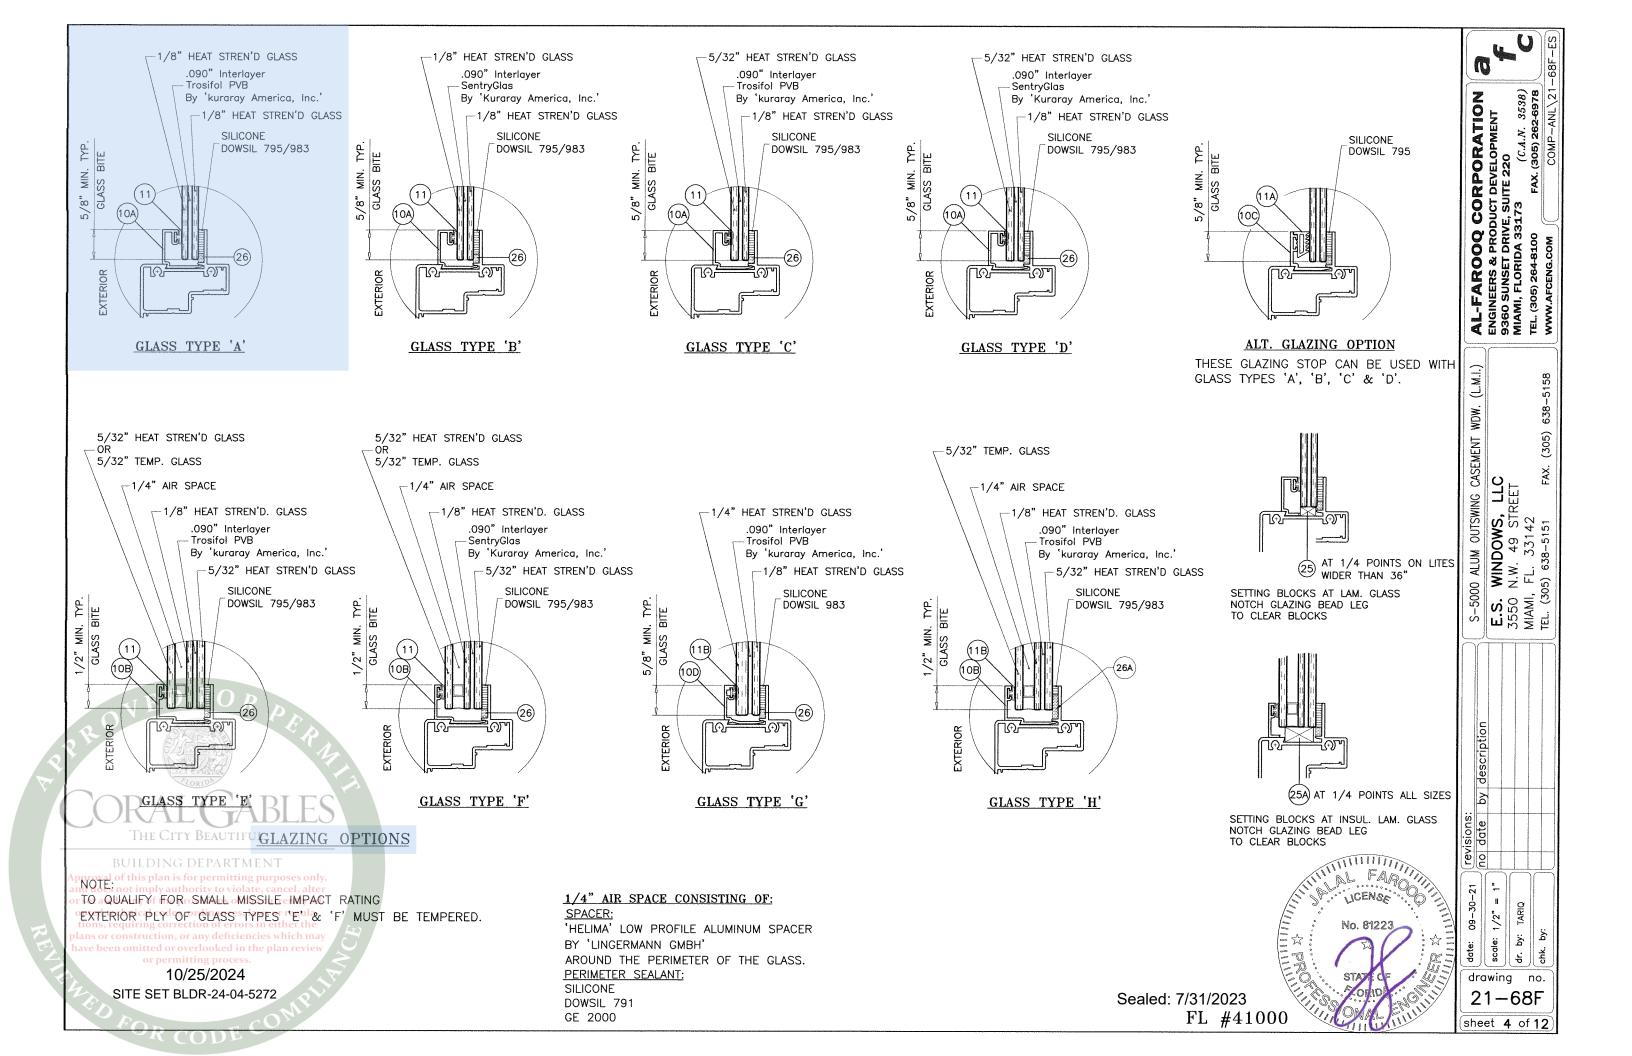


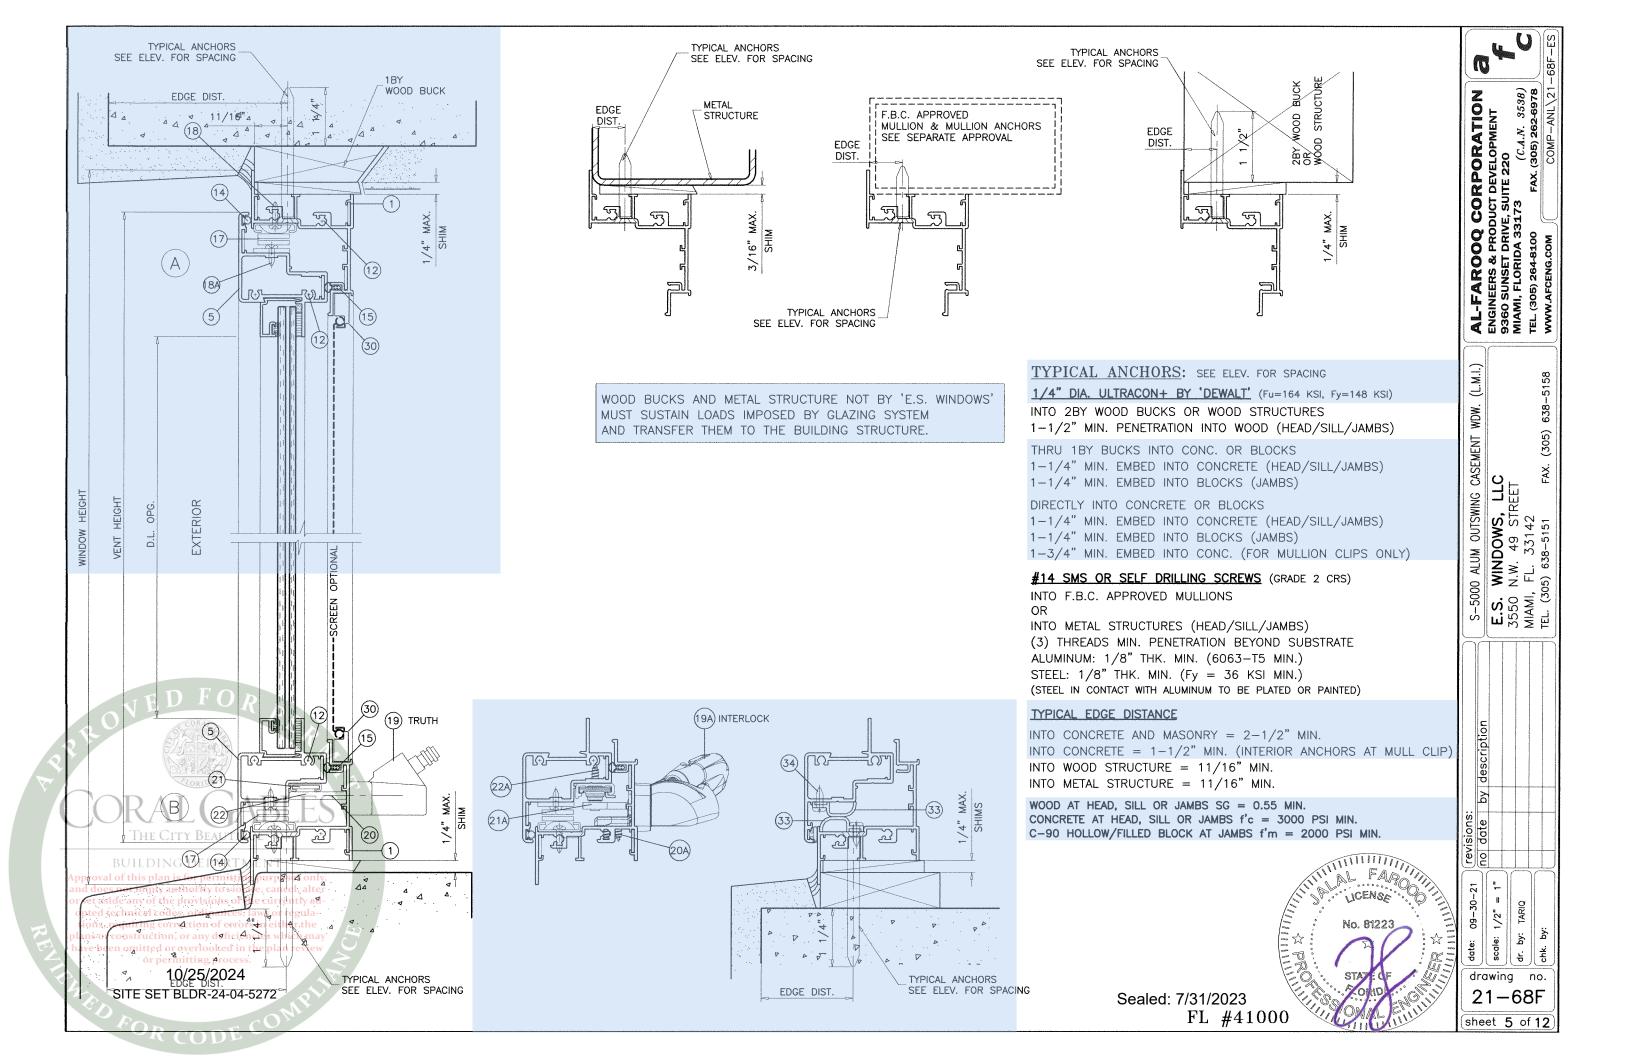


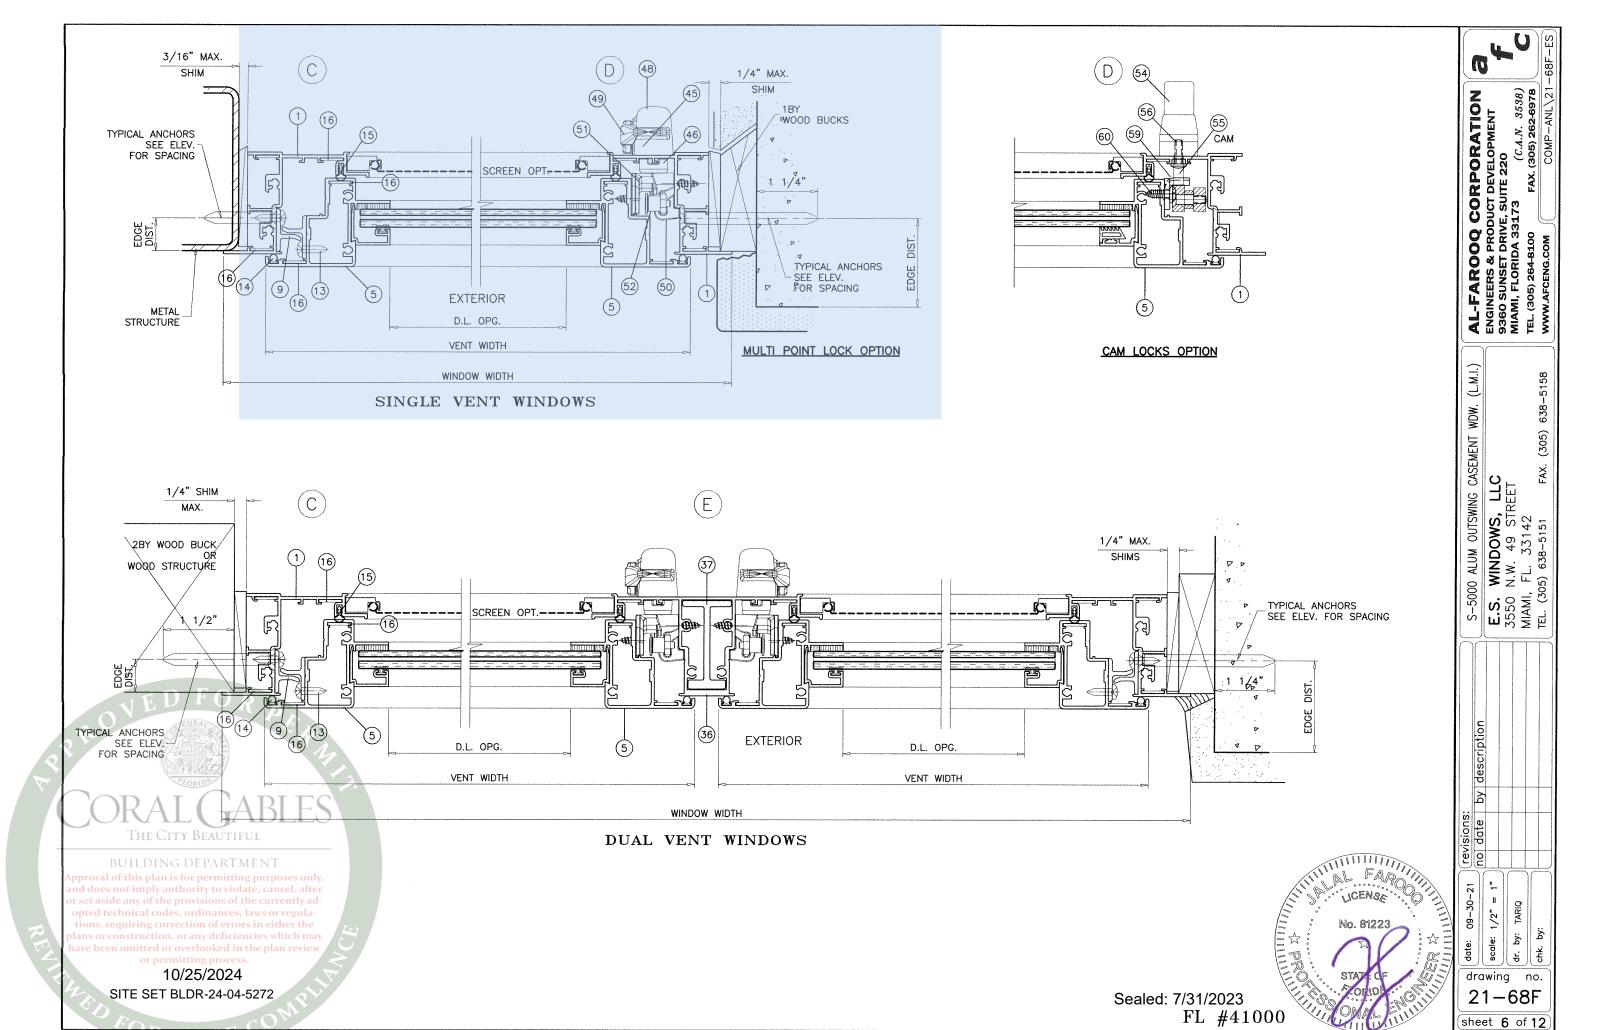
CODE Z



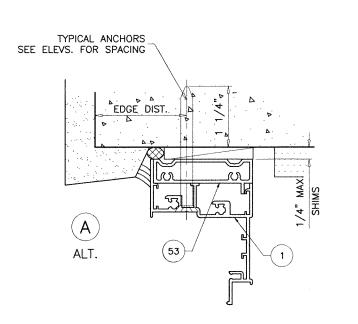

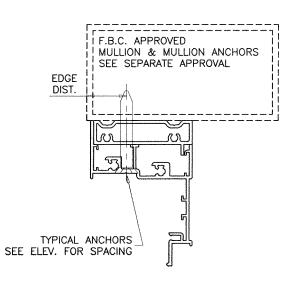

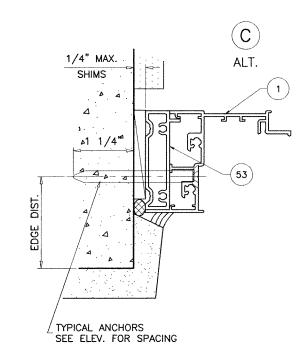

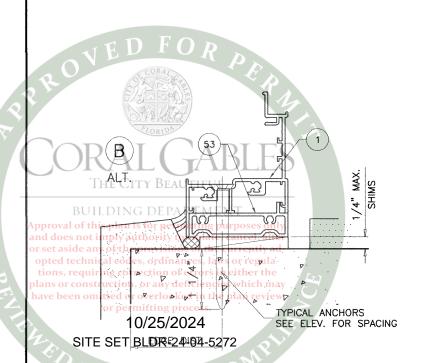

# INSTALLATION DETAILS WITH FLUSH FRAME ADAPTER

SEE SHEETS 5 & 6 FOR WINDOW DETAILS

Sealed: 7/31/2023 FL #41000

revisions: no date by description

scale: 1/2" = ا کی 등 | 유


AL-FAROOQ CORPORATION
ENGINEERS & PRODUCT DEVELOPMENT
9360 SUNSET DRIVE, SUITE 220
MIAMI, FLORIDA 33173 (C.A.N. 3638)
TEL. (305) 264-8100 FAX. (305) 262-6978

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S-5000 ALUM OUTSWING CASEMENT WDW. (L.M.I.)

E.S. WINDOWS, LLC
3550 N.W. 49 STREET
MIAMI, FL. 33142
TEL. (305) 638-5151 FAX. (305) 638-5158


drawing no. 21-68F sheet 7 of 12

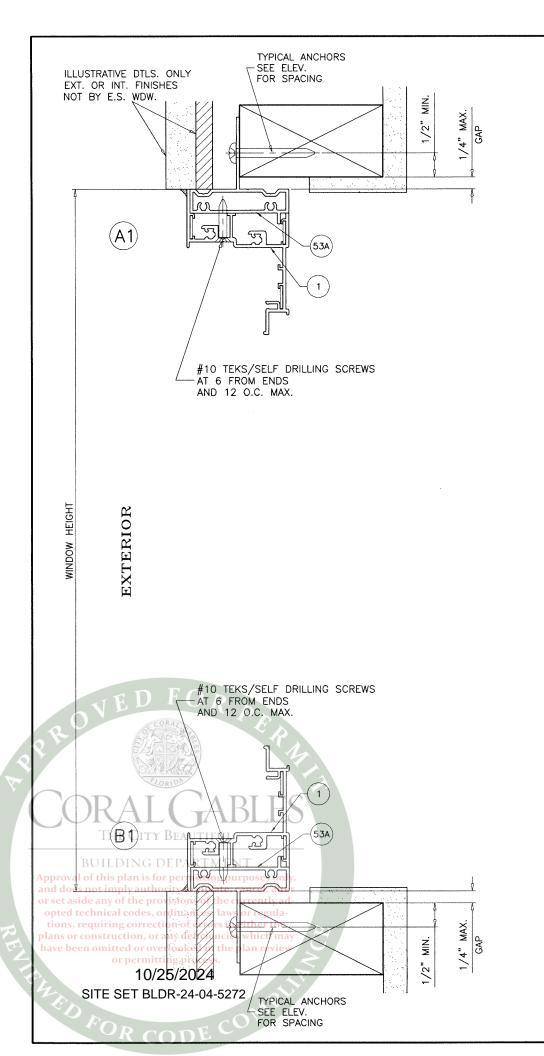

TYPICAL ANCHORS: SEE ELEV. FOR SPACING

#12 WOOD SCREWS (GRADE 2 CRS)

INTO 2BY WOOD BUCKS OR WOOD STRUCTURES 1-1/4" MIN. PENETRATION INTO WOOD

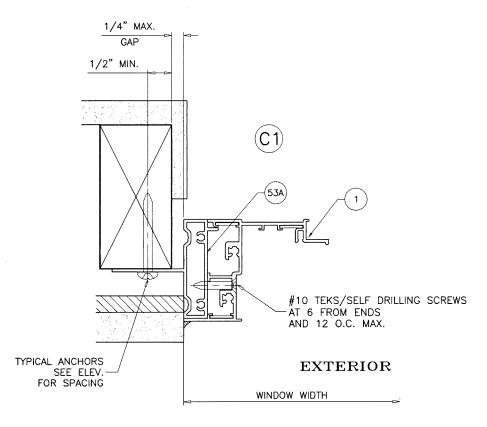


## INSTALLATION DETAILS WITH FIN FRAME ADAPTERS

SEE SHEETS 5 & 6 FOR WINDOW DETAILS

Sealed: 7/31/2023

FL #41000

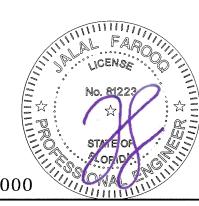

by description revisions: no date drawing no. 21-68F

AL-FAROOQ CORPORATION

ENGINEERS & PRODUCT DEVELOPMENT
9360 SUNSET DRIVE, SUITE 220
MIAMI, FLORIDA 33173 (C.A.N. 3538)


TEL. (305) 264-8100 FAX. (305) 262-6978

WWW.AFCENG.COM COMP-ANL\21-6

S-5000 ALUM OUTSWING CASEMENT WI E.S. WINDOWS, LLC 3550 N.W. 49 STREET MIAMI, FL. 33142 TEL. (305) 638-5151 FAX. (305) 6

(305)

sheet 8 of 12

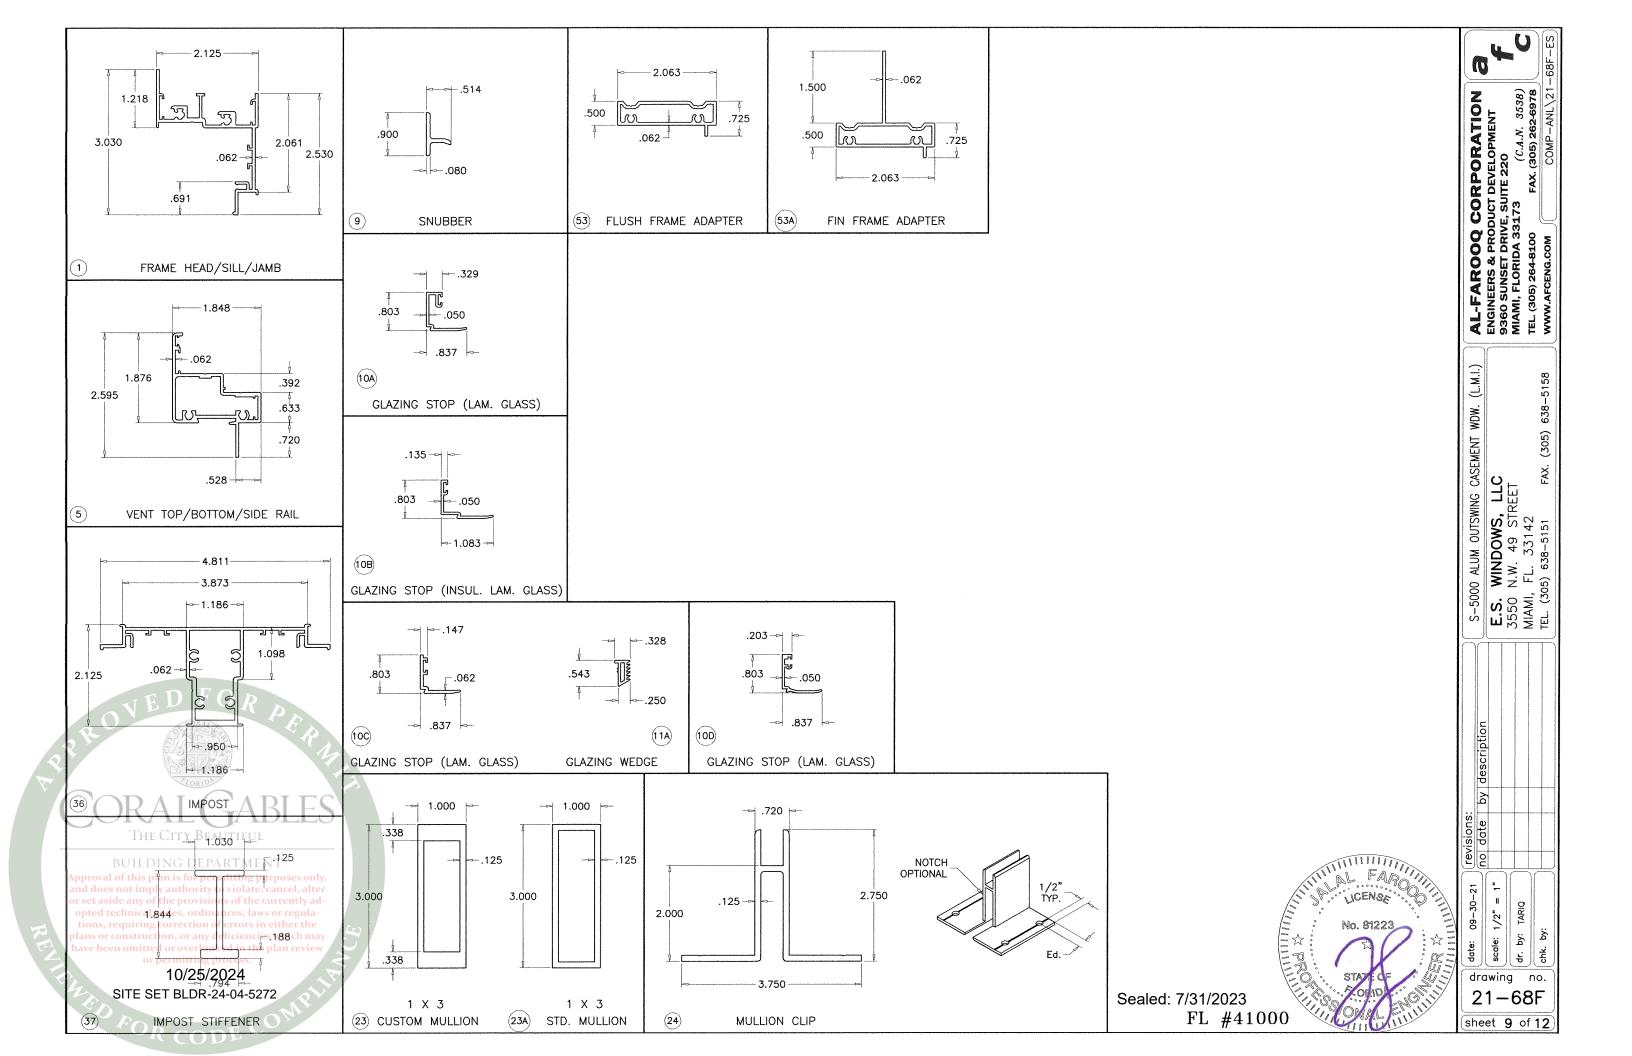

				T	
ITEM	PART #	QUANTITY	DESCRIPTION	MATERIAL	MANF./SUPPLIER/REMARKS
1	ES5001	1	FRAME HEAD/SILL/JAMB	6063-T6	
5	ES5002	1/ VENT	VENT TOP/BOTTOM/SIDE RAIL	6063-T6	
9	ES5004	2/ VENT	SNUBBERS, 2-1/2" LONG	6063-T6	-
10A	ES1103	AS REQD.	GLAZING BEAD (LAM. GLASS)	6063-T5	_
10B	_	AS REQD.	GLAZING BEAD (INSUL. LAM. GLASS)	6063-T5	_
10C	ES1008	AS REQD.	GLAZING BEAD (LAM. GLASS)	6063-T6	_
10D	ES-1017	AS REQD.	GLAZING BEAD (LAM. GLASS)	6063-T6	_
11	27-425	AS REQD.	GLAZING GASKET	EPDM	DUROMETER 60±5 SHORE 'A'
11A	ES1010	AS REQD.	GLAZING WEDGE	SOFT PVC	DUROMETER 65±5 SHORE 'A'
11B	5008A	AS REQD.	GLAZING WEDGE	SILICONE	DUROMETER 65±5 SHORE 'A'
12	_	AS REQD.	FRAME & VENT ASSEMBLY SCREWS	_	#10 X 1-1/2" PH SMS
12A	_	AS REQD.	FLUSH/FIN ADAPTER ASSEMBLY SCREWS		#10 X 1" PH SMS
13		2/ SNUBBER	SNUBBER INSTALLATION SCREWS	-	#8 X 1/2" PH SMS
14	E202	AS REQD.	OUTER WEATHERSTRIPPING (POLYPROPYLENE BASE, TPE BULB)		DUROMETER 65 SHORE 'A'
15	ES5005	AS REQD.	INNER WEATHERSTRIPPING	EPDM	DUROMETER 60 SHORE 'A'
16	PJS40-SS	AS REQD.	CORNER LOCK	ST. STEEL	SULLIVAN & ASSOCIATES
17	301SS	2/ VENT	4 BAR HINGES-HEAVY DUTY		TRUTH HARDWARE
18	-	3/ HINGE	HINGE MOUNTING SCREWS AT FRAME	_	#10 X 1/2" PH SMS
18A		4/ HINGE	HINGE MOUNTING SCREWS AT VENT		#10 X 1/2" PH SMS
19	23 SERIES	1/ VENT	SINGLE ARM OPERATOR (AT 8-1/2" FROM ENDS)		TRUTH HARDWARE
		1/ VENT	SINGLE ARM OPERATOR (AT 8-1/2" FROM ENDS)	_	INTERLOCK
19A	NOVA				#10-24 X 3/8" PH SMS
20	_	4/ OPER.	OPERATOR MOUNTING SCREWS	_	
20A		8/ OPER.	OPERATOR MOUNTING SCREWS	-	#8 X 1/2" FH SMS
21	30175	1/ OPER.	13–3/4" LONG TRACK	ST. STEEL	TRUTH HARDWARE
21A		1/ OPER.	OPERATOR TRACK	ST. STEEL	INTERLOCK
22		2/ TRACK	TRACK MOUNTING SCREWS	_	#10 X 3/8" PH SS SMS
22A		3/ TRACK	TRACK MOUNTING SCREWS	-	#8 X 1/2" FH SMS
23	_	AS REQD.	1X3 CUSTOM MULLION	6063-T6	
23A	Note:	AS REQD.	1X3 STANDARD MULLION	6063-T6	-
24	APAR	AS REQD.	MULLION CLIP	6063-T6	_
25	27-372	2/ LITE	SETTING BLOCK, 7/16" X 3/16" X 3-1/2" LONG	EPDM	AT 6" FROM EACH END, DUROMETER 75±5 SHORE A
25A	NS-25-B04A S	2/ LITE	SETTING BLOCK, 5/16" X 5/8" X 4" LONG	EPDM	AT 6" FROM EACH END, DUROMETER 75±5 SHORE A
26	-	8/ LITE	TAPE SPACER (1/4" X 1/2")	FOAM	AT 6" FROM GLASS ENDS
26A		AS REQD.	GLAZING TAPE (3/16" X 1/2")	POLYURETHANE	-
30		OPTIONAL	5/16" BOX SCREEN	_	_
33	ES5009	2/ VENT	ANTI SAG SKATE, 2" LONG	NYLON/CELCON	M&M PLASTICS
34		2/ SKATE	SKATE MOUNTING SCREWS	-	#6 x 1/2" PHSMS
36	ES5003	1	IMPOST	6063-T6	
37	ES5010	AS RQD.	IMPOST STIFFENER	6063-T6	
45	CL01-0500		MULTI-POINT LOCK MECHANISM		INTERLOCK
46	- CORA		LOCK FASTENER PLATE		-
47		2/ LOCK	LOCK FASTENER SCREWS		THREAD FORMING
48	CL01-2250-XXX	015) _	SNAP ON COVER		_
	CL01-1050-XXX	\$3/ <u> </u>	SNAP ON HANDLE		
50	CORIV	_	GUIDE (ACETAL)		
51	D AT (	LAR	KEEPER (ACETAL)		***
52			LOCK BAR (304 ST/ST)		
53	THES C5017 B1	AAS REQD.	FLUSH FRAME ADAPTER	6063-T5	OPTIONAL
53A	ES-5023	AS REQD.	FIN FRAME ADAPTER	6063-T6	OPTIONAL
54 BU	HEDING DE	1/ VENT	LOCKING HANDLE		SULLIVAN & ASSOC.
approvator	P	anni Simi	IOSES OHIV		
and <b>55</b> es no or set aside	ot imply authorit any of the provis	tc2/ioVENT, ca	LOCKING CAM (AT 11-1/2" & 50-1/2" FROM BOTTOM)	_	SULLICAN & ASSOC.
or set eside opted teck	mical codes, ordi	LOCK LOCK	LOCK MOUNTING SCREWS		#6-32 x 1/2 PH MS
tio57, req		of LIVENTIN ei	LOCK HANDLE/CAM CONNECTOR	***	1/4" x 1/2" ALUM. BAR
plan:58r cor have been (	struce\$5019r any omitted or overlo		CONNECTOR SCREWS		CUSTOM
59	CS-200K-SS	2/ VENT	KEEPERS (AT 12" & 51" FROM BOTTOM)	ST STEEL	SULLIVAN & ASSOC.
60	10/25/	2024 <sup>EPER</sup>	KEEPER MOUNTING SCREWS		#10 X 3/8" PH SMS

FL #41000

Sealed: 7/31/2023

drawing no. 21-68F sheet 10 of 12

scale: 1/2" = 1"

dr. by: chk. by:

revisions:

AL-FAROOQ CORPORATION
ENGINEERS & PRODUCT DEVELOPMENT
9360 SUNSET DRIVE, SUITE 220
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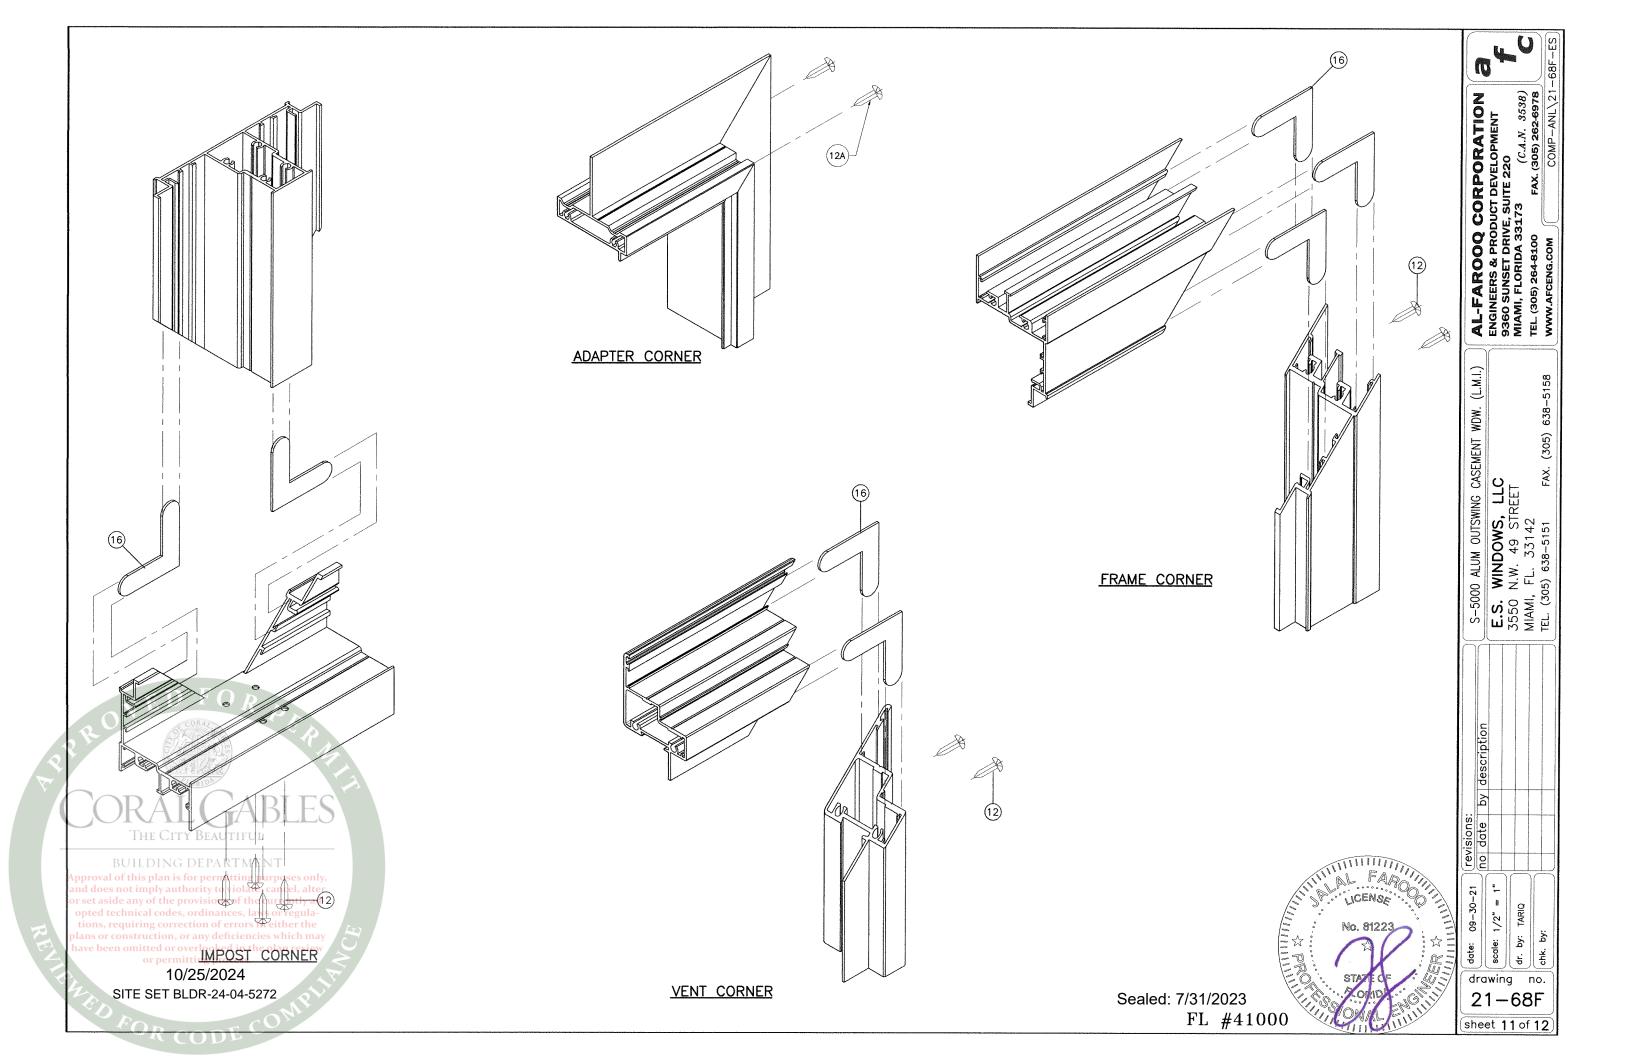
S-5000 ALUM OUTSWING CASEMENT WDW. (L.M.I.)

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MIAMI, FL. 33142
TEL. (305) 638-5151 FAX. (305) 638-5158

SEALANTS:


ALL FRAME AND VENT CORNERS AND INSTALLATION SCREWS SEALED WITH CLEAR/ALUMINUM COLORED SEALANT.


SITE SET BLDR-24-04-5272




WINDOW		MULLION LOAD CAPACITY - PSF				MULLION LOAD CAPACITY - PSF					
	DIMS.	1 X 3 STD. MULL	1 X 3 CUSTOM MULL	WINDO	V DIMS.	1 X 3 STD. MULL	1 X 3 CUSTOM MULL				
WIDTH (W)	LENGTH (L)	EXT.(+) INT.(-)	EXT.(+) INT.(-)	WIDTH (W)	LENGTH (L)	EXT.(+) INT.(-)	EXT.(+) INT.(-)				
26-1/2"		90.0	90.0	30"		90.0	90.0				
37"		90.0	90.0	36"		90.0	90.0				
42"		90.0	90.0	42"		90.0	90.0				
45"	58"	90.0	90.0	48"	54"	90.0	90.0				
48"		90.0	90.0	54"		90.0	90.0				
53-1/8"		90.0	90.0	60"		90.0	90.0				
62"	:	90.0	90.0	62"		90.0	90.0				
26-1/2"		90.0	90.0	30"		90.0	90.0				
37"		90.0	90.0	36"		90.0	90.0				
42"		90.0	90.0	42"		90.0	90.0				
45"	63"	90.0	90.0	48"	60"	90.0	90.0				
48"		90.0	90.0	54"		90.0	90.0				
53-1/8"		90.0	90.0	60"		90.0	90.0				
62"		90.0	90.0	62"		90.0	90.0				
26-1/2"		90.0	90.0	30"		90.0	90.0				
37"		90.0	90.0	36"		90.0	90.0				
42"	74 1/4"	83.3	90.0	42"	66"	90.0	90.0				
45"	74-1/4"	79.4	90.0	48"	00	90.0	90.0				
48"		76.1	90.0	54"		90.0	90.0				
53-1/8"		71.7	90.0	59"		90.0	90.0				
26-1/2"		90.0	90.0	30"		90.0	90.0				
37"		85.0	90.0	36"		90.0	90.0				
42"	76"	77.2	90.0	42"	72"	90.0	90.0				
45"	/0	73.5	90.0	48"		84.5	90.0				
48"		70.4	88.3	54"		79.2	90.0				
51"		67.8	85.0	30"		90.0	90.0				
				36"		86.9	90.0				
				42"	76"	77.2	90.0				
				48"	Ī	70.4	88.3				
				51"		67.8	85.0				


## CLIPPED MULLIONS

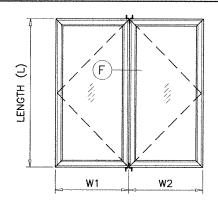

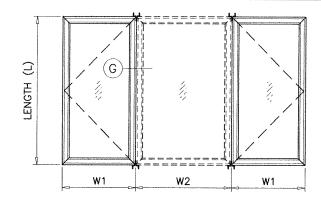

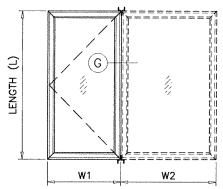

1/2"

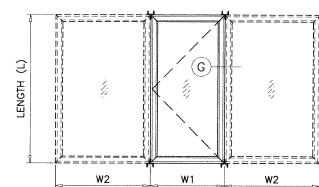


### TYPICAL ELEVATIONS SIDE BY SIDE WINDOWS

SIDE BY SIDE APPLIES TO TWO OR MORE WINDOWS

 $WIDTH (W) = \frac{W1 + W2}{2}$ 


### NOTES:

- 1. USE CHART ON THIS SHEET FOR SIDE BY SIDE CONNECTION CAPACITY OF WINDOW MULLION.
- 2. FOR CASEMENT WINDOW CAPACITY SEE SHEET 3 OF 12.
- 3. FOR FIXED WINDOW CAPACITY SEE SEPARATE APPROVAL.
- 4. LOWER VALUES FROM STEPS 1, 2 OR 3 WILL APPLY TO ENTIRE SYSTEM.

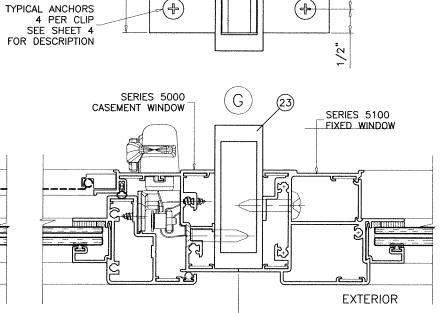

2 3/4"


(+)

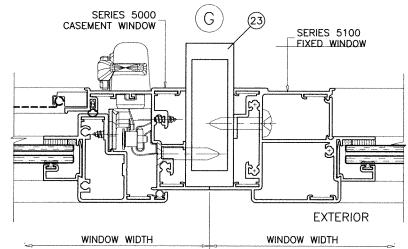

CASEMENT TO FIXED MULLION

Sealed: 7/31/2023

FL #41000

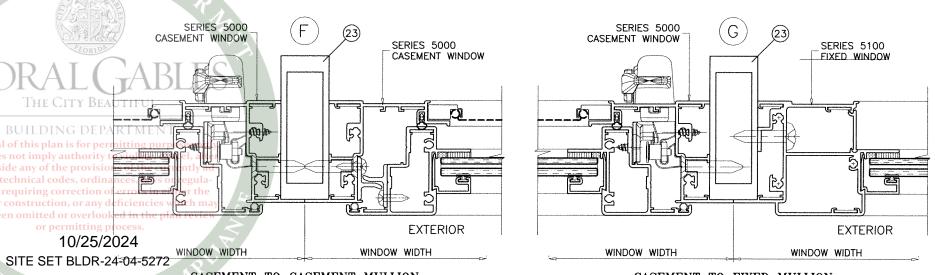

by description revisions: no date scale: 1/2" = 유 남 21-68F

CASEMENT TO CASEMENT MULLION

AL-FAROOQ CORPORATION
ENGINEERS & PRODUCT DEVELOPMENT
9360 SUNSET DRIVE, SUITE 220
MIAMI, FLORIDA 33173 (C.A.N. 3538)
TEL. (305) 264-8100
FAX. (305) 262-6978

WDW. S-5000 ALUM OUTSWING CASEMENT

E.S. WINDOWS, LLC 3550 N.W. 49 STREET MIAMI, FL. 33142 TEL. (305) 638-5151 FAX.

by:

drawing no.

sheet 12 of 12



DEPARTMENT OF REGULATORY AND ECONOMIC RESOURCES (RER) BOARD AND CODE ADMINISTRATION DIVISION

### **NOTICE OF ACCEPTANCE (NOA)**

MIAMI-DADE COUNTY PRODUCT CONTROL SECTION 11805 SW 26 Street, Room 208 Miami, Florida 33175-2474 T (786) 315-2590 F (786) 315-2599 www.miamidade.gov/building

PA-03

E.S. Windows, LLC 3550 NW 49<sup>th</sup> Street Miami, FL 33142

#### SCOPE:

This NOA is being issued under the applicable rules and regulations governing the use of construction materials. The documentation submitted has been reviewed and accepted by Miami-Dade County RER-Product Control Section to be used in Miami-Dade County and other areas where allowed by the Authority Having Jurisdiction (AHJ).

This NOA shall not be valid after the expiration date stated below. The Miami-Dade County Product Control Section (In Miami-Dade County) and/ or the AHJ (in areas other than Miami-Dade County) reserve the right to have this product or material tested for quality assurance purposes. If this product or material fails to perform in the accepted manner, the manufacturer will incur the expense of such testing and the AHJ may immediately revoke, modify, or suspend the use of such product or material within their jurisdiction. RER reserves the right to revoke this acceptance if it is determined by Miami-Dade County Product Control Section that this product or material fails to meet the requirements of the applicable building code.

This product is approved as described herein and has been designed to comply with the Florida Building Code, including the High Velocity Hurricane Zone.

### DESCRIPTION: Series "EL-150" Aluminum Fixed Window – L.M.I.

**APPROVAL DOCUMENT:** Drawing No. **W16-70**, titled "ES-EL150 Fixed Aluminum Wdw. (L.M.I)", sheets 1, 2, 2.1, 3, 3.1, 4 and 5 through 9 of 9, dated 11/13/16, with revision E dated 06/29/23, prepared by Al-Farooq Corporation, signed and sealed by Jalal Farooq, P.E., bearing the Miami–Dade County Product Control Revision stamp with the Notice of Acceptance number and expiration date by the Miami–Dade County Product Control Section.

### MISSILE IMPACT RATING: Large and Small Missile Impact Resistant

**LABELING:** Each unit shall bear a permanent label with the manufacturer's name or logo, **Barranquilla**, **Colombia**, model/series, and following statement: "Miami–Dade County Product Control Approved", unless otherwise noted herein.

**RENEWAL** of this NOA shall be considered after a renewal application has been filed and there has been no change in the applicable building code negatively affecting the performance of this product.

**TERMINATION** of this NOA will occur after the expiration date or if there has been a revision or change in the materials, use, and/ or manufacture of the product or process. Misuse of this NOA as an endorsement of any product, for sales, advertising or any other purposes shall automatically terminate this NOA. Failure to comply with any section of this NOA shall be cause for termination and removal of NOA.

**ADVERTISEMENT:** The NOA number preceded by the words Miami–Dade County, Florida, and followed by the expiration date may be displayed in advertising literature. If any portion of the NOA is displayed, then it shall be done in its entirety.

**INSPECTION:** A copy of this entire NOA shall be provided to the user by the manufacturer or its distributors and shall be available for inspection at the job site at the request of the Building Official.

Approv This NOA revises NOA No. 22-0105.01 and consists of this page 1 and evidence pages E-1, E-2, E-3 and or set a E-4, as well as approval document mentioned above.

The submitted documentation was reviewed by Manuel Perez, P.E.

plans or construction, or any deficiencies which may

MIAMI-DADE COUNTY APP10/25/2024

SITE SET BLDR-24-04-5272

8/15/23

NOA No. 23-0714.17 Expiration Date: May 18, 2027 Approval Date: August 24, 2023 Page 1

### NOTICE OF ACCEPTANCE: EVIDENCE SUBMITTED

#### 1. EVIDENCE SUBMITTED UNDER PREVIOUS NOA's

#### A. DRAWINGS

- 1. Manufacturer's die drawings and sections. (Submitted under NOA No. 16-0617.05)
- 2. Drawing No. W16-70, titled "ES-EL150 Fixed Aluminum Wdw. (L.M.I)", sheets 1, 2, 2.1, 3, 3.1, 4 and 5 through 9 of 9, dated 11/13/16, with revision **D** dated 06/15/21, prepared by Al-Farooq Corporation, signed and sealed by Jalal Farooq, P.E. (Submitted under NOA No. 21-0708.03)

#### B. TESTS

- 1. Test reports on: 1) Air Infiltration Test, per FBC, TAS 202-94
  - 2) Uniform Static Air Pressure Test, Loading per FBC, TAS 202-94
  - 3) Water Resistance Test, per FBC, TAS 202-94
  - 4) Large Missile Impact Test per FBC, TAS 201-94
  - 5) Cyclic Wind Pressure Loading per FBC, TAS 203-94
  - 6) Safety Performance Test, (class A) per ANSI Z97.1

along with marked-up drawings and installation diagram of a series EL-150 aluminum fixed window, prepared by Fenestration Testing Laboratory, Inc., Test Report No.

FTL-12002, dated 04/30/20, signed and sealed by Idalmis Ortega, P.E.

### (Submitted under NOA No. 20-1223.01)

- 2. Test reports on: 1) Air Infiltration Test, per FBC, TAS 202-94
  - 2) Uniform Static Air Pressure Test, Loading per FBC, TAS 202-94
  - 3) Water Resistance Test, per FBC, TAS 202-94
  - 4) Large Missile Impact Test per FBC, TAS 201-94
  - 5) Cyclic Wind Pressure Loading per FBC, TAS 203-94
  - 6) Safety Performance Test, (class A) per ANSI Z97.1

along with marked-up drawings and installation diagram of a series EL-150 aluminum fixed window, prepared by Fenestration Testing Laboratory, Inc., Test Report No.

FTL-11035, dated 04/30/20, signed and sealed by Idalmis Ortega, P.E.

### (Submitted under NOA No. 20-1223.01)

- 3. Test reports on: 1) Air Infiltration Test, per FBC, TAS 202-94
  - 2) Uniform Static Air Pressure Test, Loading per FBC, TAS 202-94
  - 3) Water Resistance Test, per FBC, TAS 202-94
  - 4) Large Missile Impact Test per FBC, TAS 201-94
  - 5) Cyclic Wind Pressure Loading per FBC, TAS 203-94
  - 6) Safety Performance Test, (class A) per ANSI Z97.1

THE CITY along with marked-up drawings and installation diagram of a series EL-150 aluminum fixed window, prepared by Fenestration Testing Laboratory, Inc., Test Report No.

FTL-11027, dated 04/23/20, signed and sealed by Idalmis Ortega, P.E.

and does not imply auth (Submitted under NOA No. 20-1223.01)

or set aside any of the provisions of the currently ad opted technical codes, ordinances, laws or regulations, requiring correction of errors in either the plans or construction, or any deficiencies which ma have been omitted or overlooked in the plan review

> 10/25/2024 SITE SET BLDR-24-04-5272

Manuel Perez, P.E. Product Control Examiner NOA No. 23-0714.17

Expiration Date: May 18, 2027 Approval Date: August 24, 2023

### NOTICE OF ACCEPTANCE: EVIDENCE SUBMITTED

- 1. EVIDENCE SUBMITTED UNDER PREVIOUS NOA'S (CONTINUED)
- B. TESTS (CONTINUED)
  - **4.** Test reports on: 1) Air Infiltration Test, per FBC, TAS 202–94
    - 2) Uniform Static Air Pressure Test, Loading per FBC, TAS 202-94
    - 3) Water Resistance Test, per FBC, TAS 202-94

along with marked-up drawings and installation diagram of aluminum fixed window, prepared by Blackwater Testing, Inc., Test Report No. **BT-ESW-16-004**, dated 11/14/16, and revised on 05/10/17, signed and sealed by Constantin Bortes, P.E.

(Submitted under NOA No. 16-0617.05)

- **5.** Test reports on: 1) Large Missile Impact Test per FBC, TAS 201-94
  - 2) Cyclic Wind Pressure Loading per FBC, TAS 203-94 along with marked-up drawings and installation diagram of aluminum fixed window, prepared by Blackwater Testing, Inc., Test Report No. **BT-ESW-17-012**, dated 05/10/17, signed and sealed by Constantin Bortes, P.E.

(Submitted under NOA No. 16-0617.05)

#### C. CALCULATIONS

1. Anchor verification calculations and structural analysis, complying with FBC 5<sup>th</sup> Edition (2014), dated 11/16/16, revised on 12/21/16, updated on 11/09/20 to comply with FBC 7<sup>th</sup> Edition (2020) and further revised on 06/29/21 to include additional window sizes, prepared by Al-Farooq Corporation, signed and sealed by Jalal Farooq, P.E.

(Submitted under NOA No. 21-0708.03)

2. Glazing complies with ASTM E1300-09

#### D. OUALITY ASSURANCE

1. Miami-Dade Department of Regulatory and Economic Resources (RER)

### E. MATERIAL CERTIFICATIONS

- 1. Notice of Acceptance No. 20-0915.22 issued to Kuraray America, Inc. for their "Trosifol® Ultraclear, Clear and Color PVB Glass Interlayers" dated 11/19/20, expiring on 07/08/24.
- 2. Notice of Acceptance No. 20-0915.19 issued to Kuraray America, Inc. for their "SentryGlas® (Clear and White) Glass Interlayers" dated 11/19/20, expiring on 07/04/23.
- 3. Notice of Acceptance No. 20-0622.03 issued to Eastman Chemical Company (MA) for their "Saflex Storm Saflex and Saflex HP Composite Glass Interlayers with The City PET Core" dated 08/06/20, expiring on 12/11/23.
- 4. Notice of Acceptance No. 20-0622.01 issued to Eastman Chemical Company (MA)

  BUILDING For their "Saflex PVB Clear and Color Glass Interlayers" dated 08/06/20, expiring

Approval of this plan is for permitting purposes only, and does not imply authon, 05/21/21/cancel, alter or set aside any of the provisions of the currently adopted technical codes, ordinances, laws or regulations, requiring correction of errors in either the plans or construction, or any deficiencies which may

10/25/2024 SITE SET BLDR-24-04-5272

E – 2

Manuel Perez, P.E.
Product Control Examiner
NOA No. 23-0714.17

NOA No. 23-0714.17 Expiration Date: May 18, 2027

**Approval Date: August 24, 2023** 

OR CODE C

### NOTICE OF ACCEPTANCE: EVIDENCE SUBMITTED

1. EVIDENCE SUBMITTED UNDER PREVIOUS NOA'S (CONTINUED)

#### F. STATEMENTS

1. Statement letter of conformance, complying with **FBC** 7<sup>th</sup> **Edition (2020)** dated February 20, 2020, issued by Al-Farooq Corporation, signed and sealed by Jalal Farooq, P.E.

(Submitted under NOA No. 22-0105.01)

- 2. Statement letter of conformance, complying with FBC 6<sup>th</sup> Edition (2017), with FBC 7<sup>th</sup> Edition (2020), and of no financial interest, dated November 09, 2020, issued by Al-Farooq Corporation, signed and sealed by Jalal Farooq, P.E. (Submitted under NOA No. 20-1223.01)
- 3. Proposal No. **18-0784** issued by the Product Control Section, dated June 29, 2018, signed by Manuel Perez, P.E. (Submitted under NOA No. 20-1223.01)
- 4. Proposal No. **19-1230** issued by the Product Control Section, dated November 18, 2019, signed by Manuel Perez, P.E. (Submitted under NOA No. 20-1223.01)

#### G. OTHERS

1. Notice of Acceptance No. **21-0708.03**, issued to E.S. Windows, LLC, for their Series "EL-150" Aluminum Fixed Windows – L.M.I., approved on 09/02/21 and expiring on 05/18/22.



Approval of this plan is for permitting purposes only and does not imply authority to violate, cancel, alter or set aside any of the provisions of the currently adopted technical codes, ordinances, laws or regulations, requiring correction of errors in either the plans or construction, or any deficiencies which may have been omitted or overlooked in the plan review

10/25/2024 SITE SET BLDR-24-04-5272 Manuel Pérez, P.E.
Product Control Examiner
NOA No. 23-0714.17

Expiration Date: May 18, 2027 Approval Date: August 24, 2023

#### E.S. Windows, LLC

### NOTICE OF ACCEPTANCE: EVIDENCE SUBMITTED

#### 2. NEW EVIDENCE SUBMITTED

#### A. DRAWINGS

1. Drawing No. W16-70, titled "ES-EL150 Fixed Aluminum Wdw. (L.M.I)", sheets 1, 2, 2.1, 3, 3.1, 4 and 5 through 9 of 9, dated 11/13/16, with revision E dated 06/29/23, prepared by Al-Farooq Corporation, signed and sealed by Jalal Farooq, P.E.

#### B. TESTS

1. None.

#### C. CALCULATIONS

1. None.

### D. QUALITY ASSURANCE

1. Miami-Dade Department of Regulatory and Economic Resources (RER)

#### E. MATERIAL CERTIFICATIONS

- 1. Notice of Acceptance No. 20-0915.22 issued to Kuraray America, Inc. for their "Trosifol® Ultraclear, Clear and Color PVB Glass Interlayers" dated 11/19/20, expiring on 07/08/24.
- 2. Notice of Acceptance No. 22-1116.01 issued to Kuraray America, Inc. for their "SentryGlas® (Clear and White) Glass Interlayers" dated 12/15/22, expiring on 07/04/28.
- 3. Notice of Acceptance No. 22-1130.05 issued to Eastman Chemical Company (MA) for their "Saflex Storm Saflex and Saflex HP Composite Glass Interlayers with PET Core" dated 01/26/23, expiring on 12/11/28.
- 4. Notice of Acceptance No. 21-0216.01 issued to Eastman Chemical Company (MA) for their "Saflex PVB Interlayers Clear and Colored for Glass" dated 04/29/21, expiring on 05/21/26.

#### F. STATEMENTS

1. Statement letter of conformance, complying with FBC 7<sup>th</sup> Edition (2020), with FBC 8<sup>th</sup> Edition (2023), and of no financial interest, dated July 12, 2023, issued by Al-Farooq Corporation, signed and sealed by Jalal Farooq, P.E.

#### G. OTHERS


Notice of Acceptance No. **22-0105.01**, issued to E.S. Windows, LLC, for their Series "EL-150" Aluminum Fixed Windows – L.M.I., approved on 02/10/22 and expiring on 05/18/27.

#### BUILDING DEPARTMENT

Approval of this plan is for permitting purposes only, and does not imply authority to violate, cancel, alter or set aside any of the provisions of the currently adopted technical codes, ordinances, laws or regulations, requiring correction of errors in either the plans or construction, or any deficiencies which may have been omitted or overlooked in the plan review

10/25/2024 SITE SET BLDR-24-04-5272 Manuel Pérez, P.E.
Product Control Examiner
NOA No. 23-0714.17

Expiration Date: May 18, 2027 Approval Date: August 24, 2023

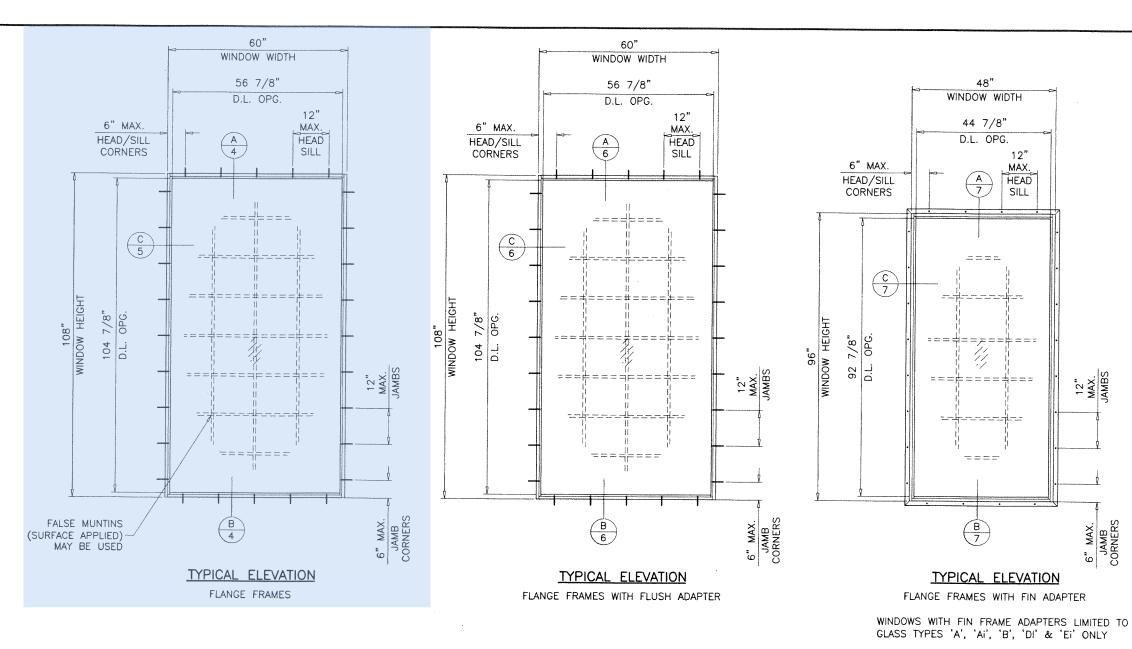

### ES-EL150 FIXED ALUMINUM WINDOW

DESIGN LOAD RATINGS FOR THESE WINDOWS TO BE AS PER CHARTS SHOWN ON SHEETS 3 AND 3.1.

APPROVAL APPLIES TO SINGLE UNITS OR SIDE BY SIDE COMBINATIONS OF FIX./FIX. OR FIXED WITH OTHER WINDOW TYPES IN MODULES OF TWO OR MORE WINDOWS USING MIAMI-DADE COUNTY APPROVED MULLIONS IN BETWEEN. LOWER DESIGN PRESSURE FROM WINDOWS OR MULLION APPROVAL WILL APPLY ITO ENTIRE ASYSTEM.

10/25/2024 SITE SET BLDR-24-04-5272

THIS PRODUCT HAS BEEN DESIGNED AND TESTED TO COMPLY WITH THE REQUIREMENTS OF THE 2020 (7TH EDITION)/2023 (8TH EDITION) FLORIDA BUILDING CODE INCLUDING HIGH VELOCITY HURRICANE ZONE (HVHZ).

1BY OR 2BY WOOD BUCKS & BUCK FASTENERS BY OTHERS, MUST BE DESIGNED AND INSTALLED ADEQUATELY TO TRANSFER APPLIED PRODUCT LOADS TO THE BUILDING STRUCTURE.

ANCHORS SHALL BE CORROSION RESISTANT, SPACED AS SHOWN ON DETAILS AND INSTALLED PER MANUF'S INSTRUCTIONS. SPECIFIED EMBEDMENT TO BASE MATERIAL SHALL BE BEYOND WALL DRESSING OR STUCCO.

A LOAD DURATION INCREASE IS USED IN DESIGN OF ANCHORS INTO WOOD ONLY.

ALL SHIMS TO BE HIGH IMPACT, NON-METALLIC AND NON-COMPRESSIBLE.

MATERIALS INCLUDING BUT NOT LIMITED TO STEEL/METAL SCREWS, THAT COME INTO CONTACT WITH OTHER DISSIMILAR MATERIALS SHALL MEET THE REQUIREMENTS OF THE 2020/2023 FLORIDA BLDG. CODE & ADOPTED STANDARDS.

THIS PRODUCT APPROVAL IS GENERIC AND DOES NOT PROVIDE INFORMATION FOR A SITE SPECIFIC PROJECT, i.e. LIFE SAFETY OF THIS PRODUCT, ADEQUACY OF STRUCTURE RECEIVING THIS PRODUCT AND SEALING AROUND OPENING FOR WATER INFILTRATION RESISTANCE ETC.

CONDITIONS NOT SHOWN IN THIS DRAWING ARE TO BE ANALYZED SEPARATELY, AND TO BE REVIEWED BY BUILDING OFFICIAL.

DESIGN LOADS SHOWN ARE BASED ON 'ALLOWABLE STRESS DESIGN (ASD)'.


DAYLITE OPENINGS: D.L.O. HEIGHT = WINDOW HEIGHT - 3.125" D.L.O. WIDTH = WINDOW WIDTH -3.125"

WINDOWS WITH GLASS TYPES 'AA', 'BB' & 'AAi' COMPLY WITH REQUIREMENTS OF ANSI Z97.1.

THESE WINDOWS ARE RATED FOR LARGE & SMALL MISSILE IMPACT. SHUTTERS ARE NOT REQUIRED.

**PRODUCT REVISED** As complying with the Florida Building Code NOA-No. 23-0714.17

**Expiration Date: 05/18/2027** Miami-Dade Product Control

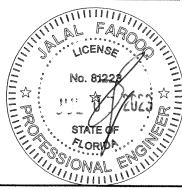

AL-FAROOQ CORPORATION
ENGINEERS & PRODUCT DEVELOPMENT
9360 SUNSET DRIVE, SUITE 220
MIAMI, FLORIDA 33173 (C.A.N. 3538)
TEL. (305) 264-8100 FAX. (305) 262-6978

WDW.

(302)

E.S. WINDOWS, LLC 3550 N.W. 49 STREET MIAMI, FL. 33142 TEL. (305) 638-5151 FAX. (


ES-EL150 FIXED ALUMINUM


description
NO CHANGE THIS
UPDATED TO 20
GENERAL REVISIC
NO CHANGE THIS 

0 13-16 الأذا <u>۾</u> ج


drawing W16 - 70

sheet 1 of 9

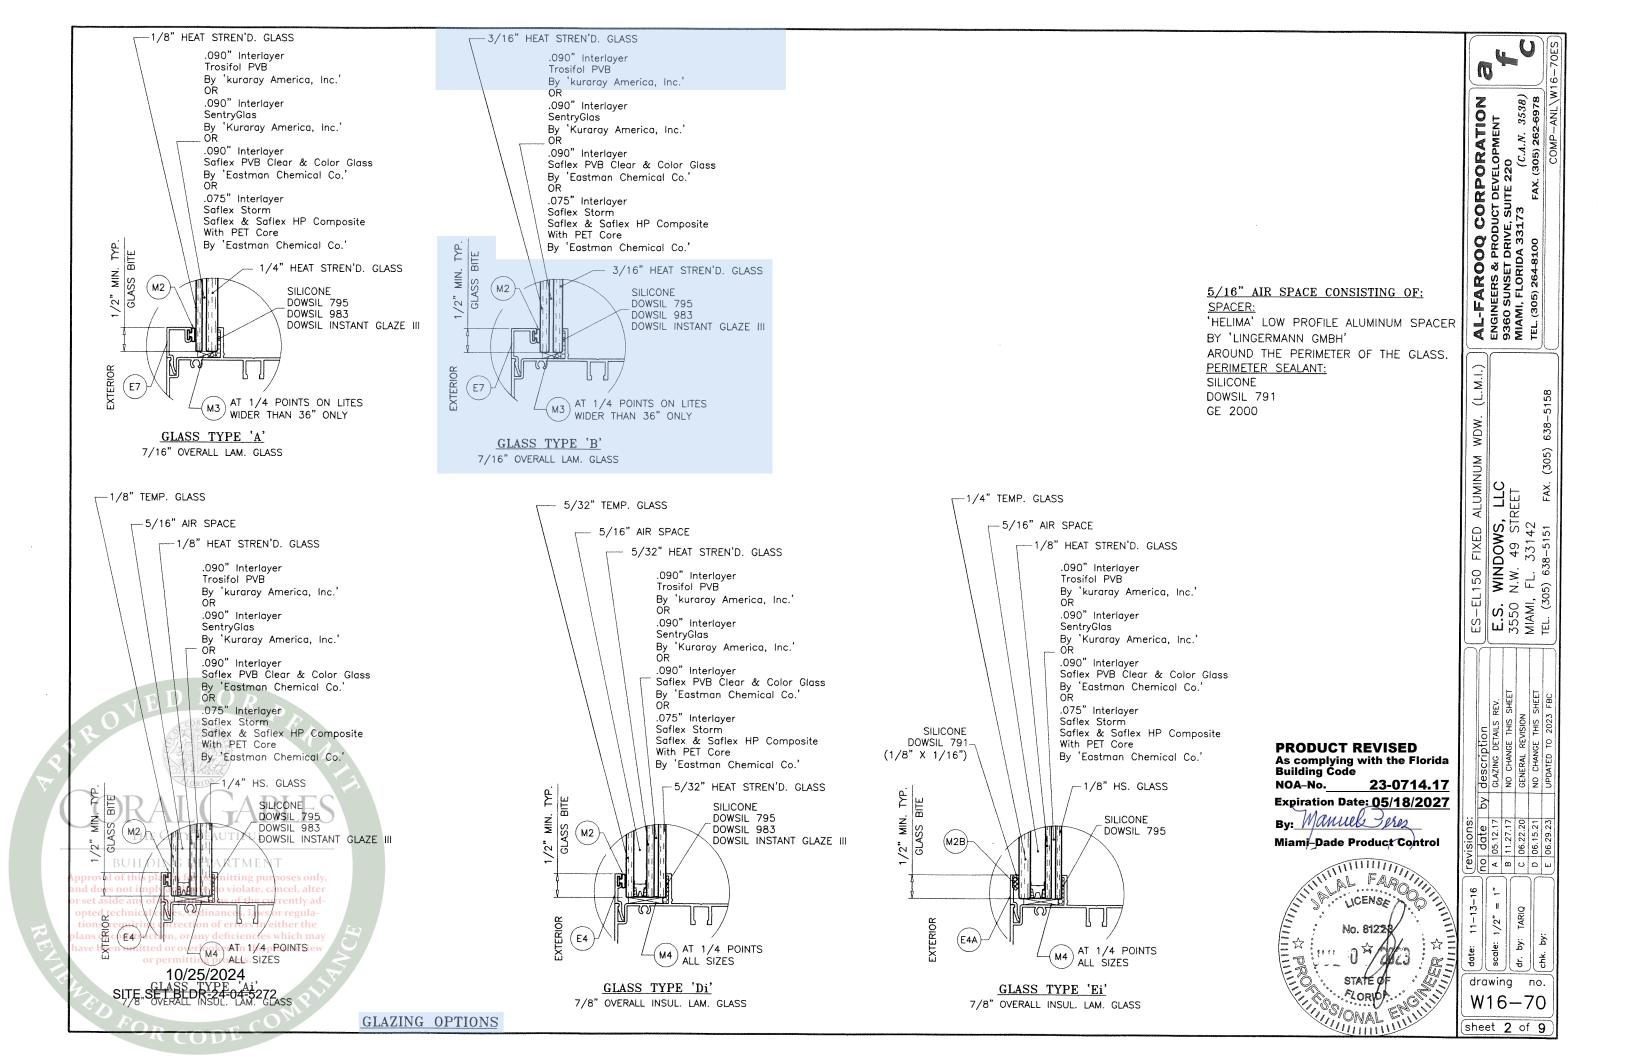


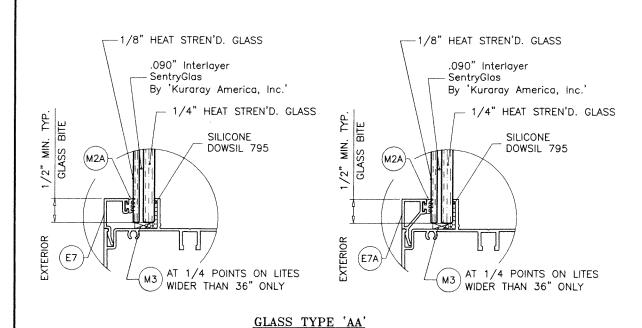

7/16" OVERALL LAM. GLASS

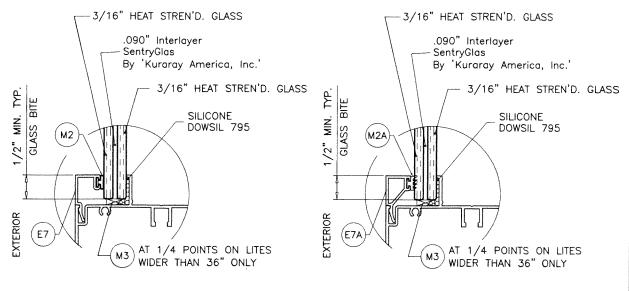

GLASS TYPE 'BB' 7/16" OVERALL LAM. GLASS

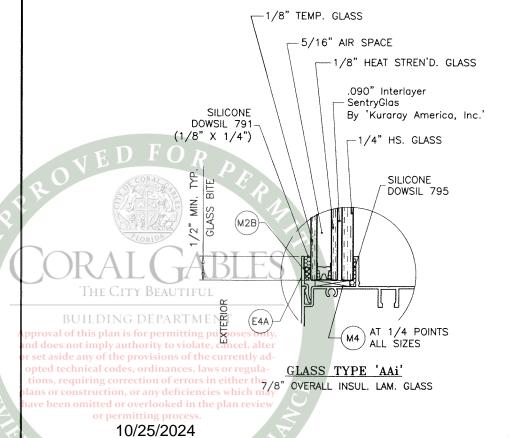


SITE SET BLDR-24-04-5272

5/16" AIR SPACE CONSISTING OF: SPACER: 'HELIMA' LOW PROFILE ALUMINUM SPACER BY 'LINGERMANN GMBH' AROUND THE PERIMETER OF THE GLASS. PERIMETER SEALANT: SILICONE DOWSIL 791 GE 2000



By: Manuel Perez Miami-Dade Product Control

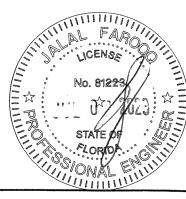

revisions: no date drawing W16 - 70sheet 2.1of 9

no.

 AL-FAROOQ CORPORATION

 ENGINEERS & PRODUCT DEVELOPMENT

 9360 SUNSET DRIVE, SUITE 220

 MIAMI, FLORIDA 33173
 (C.A.N. 3538)

 TEL. (305) 264-8100
 FAX. (305) 262-6978

(L.M.I.)

WDW.

ES-EL150 FIXED ALUMINUM

E.S. WINDOWS, LLC 3550 N.W. 49 STREET MIAMI, FL. 33142 TEL. (305) 638–5151 FAX. (

**GLAZING OPTIONS** 


F	DESIG		APACITY -		ES
WINDO	V DIMS.	1	TYPE A'		TYPES 'Di', 'Ei'
WIDTH	HEIGHT	EXT.(+)	1NT.(-)	EXT.(+)	1NT.(-)
30"		60.0	80.0	80.0	80.0
36"		60.0	80.0	80.0	80.0
42"	48"	60.0	68.6	80.0	80.0
48"		60.0	60.0	80.0	80.0
54"		60.0	60.0	80.0	80.0
60"		60.0	60.0	80.0	80.0
30"		60.0	80.0	80.0	80.0
36"		60.0	80.0	80.0	80.0
42"	54"	60.0	68.6	80.0	80.0
48"		60.0	60.0	80.0	80.0
54"		53.3	53.3	71.1	71.1
60"		53.3	53.3	71.1	71.1
30"		60.0	80.0	80.0	80.0
36"		60.0	80.0	80.0	80.0
42"	60"	60.0	68.6	80.0	80.0
48"		60.0	60.0	80.0	80.0
54"		53.3	53.3	71.1	71.1
60"		48.0	48.0	64.0	64.0
30"	. 715 13110-2222	60.0	80.0	80.0	80.0
36"		60.0	80.0	80.0	80.0
42"	66"	60.0	68.6	80.0	80.0
48"		60.0	60.0	80.0	80.0
54"		53.3	53.3	71.1	71.1
60"		48.0	48.0	64.0	64.0
30"		60.0	80.0	80.0	80.0
36"		60.0	80.0	80.0	80.0
42"	72"	60.0	68.6	80.0	80.0
48"		60.0	60.0	80.0	80.0
54"		53.3	53.3	71.1	71.1
60"		48.0	48.0	64.0	64.0
30"		60.0	80.0	80.0	80.0
36"		60.0	78.0	80.0	80.0
42"	78"	60.0	68.6	80.0	80.0
48"		60.0	60.0	80.0	80.0
54"	E D	53.3	53.3	71.1	71.1
30"	(Section 2)	AZ 60.0	80.0	80.0	80.0
36"		60.0	76.4	80.0	80.0
42"	84"	60.0	68.6	80.0	80.0
48"	A:BA	60.0	60.0	80.0	80.0
54"	~10	53.3	53.3	71.1	71.1
30"	ZAI	60.0	80.0	80.0	80.0
36"	HE 90"TY	60.0	75.0	80.0	80.0
42"	HE CITY	SE 60.0 IFU	<sup>JL</sup> 67.1	80.0	80.0
48" <sub>BUI</sub>	LDING D	ED60.0	60.0	80.0	80.0
pro30" of th	is plan is for	pe 60.0 <sub>ting</sub>	pu80.0ses	nly80.0	80.0
nd dogg"not i set aside an	mply author v of 96° prov	ity 60.0 ola	te, <b>73</b> 18el, a	lte:80.0	80.0
ppted techni	cal codes, or	60.0	65.8 aws 01.8egu	80.0	80.0
tion48'equir	ing correcti	on 60.0rors	in 60.0er t	ne 80.0	80.0
ans or const	tuction, or a	ny dencien	Lies Willell I	inay	

10/25/2024

SITE SET BLDR-24-04-5272

	F	DESIGI	N LOAD C			S	
┪				TYPE		TYPES	
	WINDO	W DIMS.	1	Α'	'B', 'Ai', 'Di', 'Ei'		
	WIDTH	HEIGHT	EXT.(+)	1NT.(-)	EXT.(+)	1NT.(-)	
1	30"		60.0	80.0	80.0	80.0	
	36"		60.0	78.1	80.0	80.0	
	36"	102"	60.0	72.9	80.0	80.0	
	39"		60.0	68.5	80.0	80.0	
	42"		60.0	64.8	80.0	80.0	
	45"		60.0	61.6	80.0	80.0	
	30"		60.0	80.0	80.0	80.0	
	33"		60.0	77.3	80.0	80.0	
	36"	108"	60.0	72.0	80.0	80.0	
	39"		60.0	67.6	80.0	80.0	
	42"		60.0	63.8	80.0	80.0	
	30"		60.0	80.0	80.0	80.0	
	33"	114"	60.0	76.5	80.0	80.0	
	36"	, , , ,	60.0	71.3	80.0	80.0	
	39"		60.0	66.8	80.0	80.0	
	30"		60.0	80.0	80.0	80.0	
	33"	120"	60.0	75.9	80.0	80.0	
╛	36"		60.0	70.6	80.0	80.0	
	30"		60.0	80.0	80.0	80.0	
	33"	126"	60.0	75.3	80.0	80.0	
	36"		60.0	70.0	80.0	80.0	
	30"	132"	60.0	80.0	80.0	80.0	
	33"	102	60.0	74.8	80.0	80.0	
	30"	138"	60.0	80.0	80.0	80.0	
	33"	130	60.0	74.3	80.0	80.0	
	30"	144"	60.0	80.0	80.0	80.0	

DESIGN LOAD CAPACITY — PSF FLANGE FRAMES, FLUSH FRAMES, FIN FRAMES									
		GLASS	TYPE	GLASS	TYPES				
WINDO	W DIMS.	e	A'	'B', 'Ai',	'Di', 'Ei'				
WIDTH	HEIGHT	EXT.(+)	1NT.(-)	EXT.(+)	1NT.(-)				
19-1/8"		60.0	80.0	80.0	80.0				
26-1/2"		60.0	80.0	80.0	80.0				
37"	26"	60.0	80.0	80.0	80.0				
48"		60.0	80.0	80.0	80.0				
53-1/8"		60.0	80.0	80.0	80.0				
19-1/8"		60.0	80.0	80.0	80.0				
26-1/2"		60.0	80.0	80.0	80.0				
37"	38-3/8"	60.0	77.8	80.0	80.0				
48"		60.0	75.0	80.0	80.0				
53-1/8"		60.0	75.0	80.0	80.0				
19-1/8"		60.0	80.0	80.0	80.0				
26-1/2"		60.0	80.0	80.0	80.0				
37"	50-5/8"	60.0	77.8	80.0	80.0				
48"		60.0	60.0	80.0	80.0				
53-1/8"		56.9	56.9	75.9	75.9				
19-1/8"		60.0	80.0	80.0	80.0				
26-1/2"		60.0	80.0	80.0	80.0				
37"	58"	60.0	77.8	80.0	80.0				
48"		60.0	60.0	80.0	80.0				
53-1/8"		54.2	54.2	72.3	72.3				
19-1/8"		60.0	80.0	80.0	80.0				
26-1/2"		60.0	80.0	80.0	80.0				
37"	63"	60.0	77.8	80.0	80.0				
48"		60.0	60.0	80.0	80.0				
53-1/8"		54.2	54.2	72.3	72.3				
19-1/8"		60.0	80.0	80.0	80.0				
26-1/2"		60.0	80.0	80.0	80.0				
37"	76"	60.0	77.2	80.0	80.0				
48"		60.0	60.0	80.0	80.0				
53-1/8"		54.2	54.2	72.3	72.3				

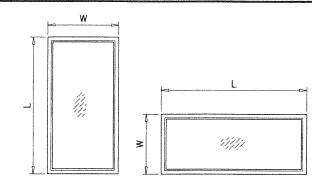


NOTE: WIDTH AND LENGTH DIMENSIONS CAN BE ORIENTED VERTICALLY OR HORIZONTALLY AS SHOWN ABOVE.

NOTE: GLASS CAPACITIES ON THIS SHEET ARE BASED ON ASTM E1300-09 (3 SEC. GUSTS).

**WINDOW** 

WIDTH

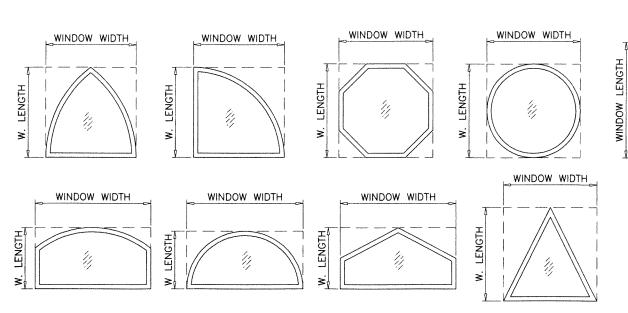

ALLOWABLE LOADS FOR ALTERNATE SHAPES AS SHOWN ABOVE OR SIMILAR CAN BE VERIFIED BY INSCRIBING PICTURE WINDOW SHAPE WITHIN SQUARE OR RECTANGLE AS SHOWN IN DOTTED LINES AND OBTAINING ALLOWABLE LOADS FROM THOSE SHAPES.

PRODUCT REVISED As complying with the Florida Building Code NOA-No. 23-0714.17

WINDOW LENGTH


WINDOW

WIDTH

Expiration Date: 05/18/2027

By: Manuel Pers

Miami-Dade Product Control

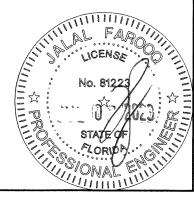

	des	GLAS	20	GENE	WDW.	S ON
	â					
revisions:	date	05.12.17	B 11.27.17	C 06.22.20	D 06.15.21	E 06.29.23
(je	o U	٧	В	ပ	Q	ш
date: 11-13-16		scale: $1/2" = 1"$		dr. by: TARIQ		cnk. by:
d	ra V	wii 1 (	ng <b>3-</b>		nc 7(	- 1
sh	e	et	3	0	f (	<u>3</u>

(C.A.N. 3538) FAX. (305) 262-6978

AL-FAROOQ CORPORATION
ENGINEERS & PRODUCT DEVELOPMENT
9360 SUNSET DRIVE, SUITE 220
MIAMI, FLORIDA 33173 (C.A.N. 3538)
TEL. (305) 264-8100 FAX. (305) 262-6978


WDW.


ES-EL150 FIXED ALUMINUM W
E.S. WINDOWS, LLC
3550 N.W. 49 STREET
MIAMI, FL. 33142
TEL. (305) 638-5151 FAX. (305)

WINDO	W DIMS.	1	TYPES	ł	TYPE BB'
WIDTH	HEIGHT	EXT.(+)	1NT.(-)	EXT.(+)	1NT.(-)
48"		80.0	105.0	80.0	100.0
54"		80.0	105.0	80.0	100.0
60"		80.0	105.0	80.0	100.0
66"	48"	80.0	105.0	80.0	100.0
72"		80.0	105.0	80.0	100.0
78"		80.0	105.0	80.0	100.0
48"		80.0	105.0	80.0	100.0
54"		71.1	93.3	80.0	88.9
60"		71.1	93.3	80.0	88.9
66"	54"	71.1	93.3	80.0	88.9
72"			_	80.0	88.9
78"			***	80.0	88.9
48"		80.0	105.0	80.0	100.0
54"		71.1	93.3	80.0	88.9
60"		64.0	84.0	80.0	80.0
66"	60"			80.0	80.0
72"		_	_	80.0	80.0
78 <b>"</b>			_	80.0	80.0
48"		80.0	105.0	80.0	100.0
54"		71.1	93.3	80.0	88.9
60"		_	_	80.0	80.0
66"	66"		_	72.7	72.7
72"		_		72.7	72.7
78"				72.7	72.7
48"		80.0	105.0	80.0	100.0
54"			•••	80.0	88.9
60"	_	***		80.0	80.0
66"	72"		_	72.7	72.7
72"		_	_	66.7	66.7
78"		***		66.7	66.7
48"		80.0	105.0	80.0	100.0
54"		_	_	80.0	88.9
60"		_		80.0	80.0
66"	78"		-	72.7	72.7
72"	ED	r U K		66.7	66.7
78"	(CO)	A/\		61.5	61.5
42"		80.0	105.0	80.0	100.0
48"		\$ 50 <u>E</u>	_	80.0	100.0
54"			_	80.0	88.9
60"	64 FLOI	EIDA	_	80.0	80.0
66"	ΔΙ	$( \pm \Delta$	13-1 1	72.7	72.7
72"				66.7	66.7
42" <sup>T</sup>	he City I	3E/ <b>8</b> 0.51FU	<sup>IL</sup> 105.0	80.0	100.0
48" <sub>BIII</sub>	I DING D	EDADTM	ENT	80.0	100.0
roval of th	is ploors for	permitting	purposes	80.0	80.0
i di 600 HOLI	mpry author		e, câ <del>n</del> cel, a	ltei80.0	80.0
et aside an 66 oted techni	y of the prov cal codes, or	isions of th dinances. I	e currently ws or regu	ad- 72.7	72.7
on7,2"equir	ing correcti	on of errors	in either tl	ne 66.7	66.7
ns or sonst ve been om	ruction, or a itted or over	ny 80.0 <sup>ien</sup>	105.0 <sup>ch</sup>	10.08 may	100.0
42"	or permitti		- Paurick	80.0	100.0
48"	<sub>96</sub> 1.0/2	5/2024	_	80.0	100.0
54'SITE	SET BLD		272	80.0	80.0
60"		_		80.0	80.0
66"			$^{\wedge}$	72.7	72.7

7	DESIGN LOAD CAPACITY - PSF FLANGE FRAMES & FLUSH FRAMES ONLY										
1				TYPES	<del></del>	TYPE					
	WINDO	V DIMS.		k 'AAi'	,BB,						
7	WIDTH	HEIGHT	EXT.(+)	1NT.(-)	EXT.(+)	1NT.(-)					
٦	36"		80.0	105.0	80.0	100.0					
	42"		_	_	80.0	100.0					
	48"	102"	_	_	80.0	80.0					
	54"			-	80.0	80.0					
	60"		-	-	80.0	80.0					
	30"		80.0	105.0	80.0	80.0					
	42"			_	80.0	100.0					
	48"	108"	_		80.0	80.0					
	54"		-	-	80.0	80.0					
	60"			_	80.0	80.0					
	30"		80.0	105.0	80.0	80.0					
╝	48"	114"			80.0	80.0					
	54"				80.0	80.0					
	30"		80.0	105.0	80.0	80.0					
	48"	120"			80.0	80.0					
┨┃	54"		-	_	80.0	80.0					
	30"	126"	80.0	105.0	80.0	80.0					
╝	24"		80.0	105.0	80.0	80.0					
	42"	132"			80.0	80.0					
╝	48"				80.0	80.0					
	24"	138"	80.0	105.0	80.0	80.0					
	42"	100			80.0	80.0					
	24"	144"	80.0	105.0	80.0	80.0					
	42"	177	-		80.0	80.0					

			APACITY - FLUSH FRAI		
			TYPES	1	TYPE
WINDO	W DIMS.	<del> </del>	k 'AAi'		В'
WIDTH	HEIGHT	EXT.(+)	1NT.(-)	EXT.(+)	1NT.(-)
19-1/8"		80.0	105.0	80.0	100.0
26-1/2"		80.0	105.0	80.0	100.0
37"	26"	80.0	105.0	80.0	100.0
48"		80.0	105.0	80.0	100.0
53-1/8"		80.0	105.0	80.0	100.0
19-1/8"		80.0	105.0	80.0	100.0
26-1/2"		80.0	105.0	80.0	100.0
37"	38-3/8"	80.0	105.0	80.0	100.0
48"		80.0	105.0	80.0	100.0
53-1/8"		80.0	105.0	80.0	100.0
19-1/8"		80.0	105.0	80.0	100.0
26-1/2"		80.0	105.0	80.0	100.0
37"	50-5/8"	80.0	105.0	80.0	100.0
48"		80.0	105.0	80.0	100.0
53-1/8"		75.9	99.6	80.0	94.8
19-1/8"		80.0	105.0	80.0	100.0
26-1/2"		80.0	105.0	80.0	100.0
37"	58"	80.0	105.0	80.0	100.0
48"		80.0	105.0	80.0	100.0
53-1/8"		72.3	94.9	80.0	90.4
19-1/8"		80.0	105.0	0.08	100.0
26-1/2"		80.0	105.0	80.0	100.0
37"	63"	80.0	105.0	80.0	100.0
48"		80.0	105.0	80.0	100.0
53-1/8"		72.3	94.9	80.0	90.4
19-1/8"		80.0	105.0	80.0	100.0
26-1/2"		80.0	105.0	80.0	100.0
37"	76"	80.0	105.0	80.0	100.0
48"		80.0	105.0	80.0	100.0
53-1/8"		_		80.0	90.4

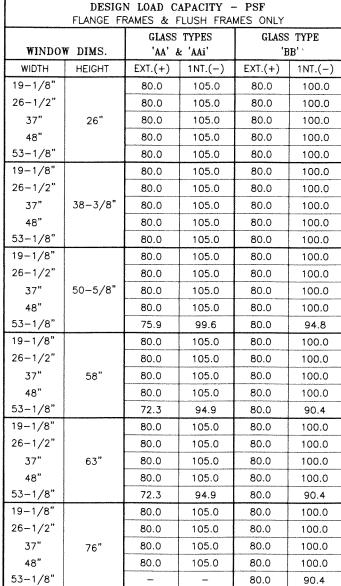

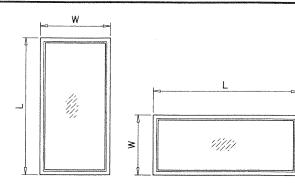


NOTE: WIDTH AND LENGTH DIMENSIONS CAN BE ORIENTED VERTICALLY OR HORIZONTALLY AS SHOWN ABOVE. (C.A.N. 3538) FAX. (305) 262-6978

AL-FAROOQ CORPORATION
ENGINEERS & PRODUCT DEVELOPMENT
9360 SUNSET DRIVE, SUITE 220
MIAMI, FLORIDA 33173 (C.A.N. 3538)
TEL. (305) 264-8100 FAX. (305) 262-6978

E.S. WINDOWS, LLC 3550 N.W. 49 STREET MIAMI, FL. 33142 TEL. (305) 638–5151 FAX. (305) 6

NOTE: GLASS CAPACITIES ON THIS SHEET ARE BASED ON ASTM E1300-09 (3 SEC. GUSTS).

> WINDOW WIDTH

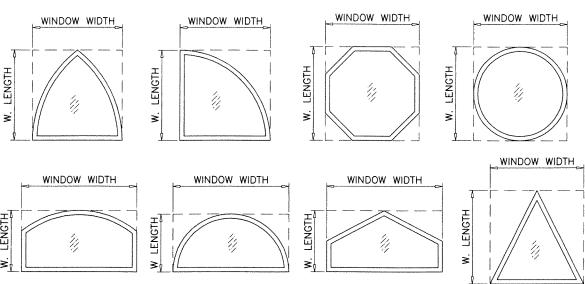

ALLOWABLE LOADS FOR ALTERNATE SHAPES AS SHOWN ABOVE OR SIMILAR CAN BE VERIFIED BY INSCRIBING PICTURE WINDOW SHAPE WITHIN SQUARE OR RECTANGLE AS SHOWN IN DOTTED LINES AND OBTAINING ALLOWABLE LOADS FROM THOSE SHAPES.



WINDOW WIDTH


WINDOW LENGTH

Expiration Date: 05/18/2027

By: Manuel Pers


Miami-Dade Product Control

WINDOW LENGTH

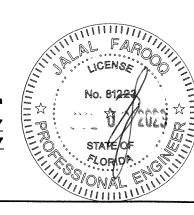

	isions:	no date b			C 06.22.20	D 06.15.21	E 06.29.23
	date: 11-13-16		scale: 1/2" = 1"		dr. by: TARIQ		CNK. by:
	dr <b>V</b>		wir 1 6	ng 5-	-	no 7(	
<i>y</i>	(sh	ee	et ;	3. '	0	· (	<u>)</u>

y description

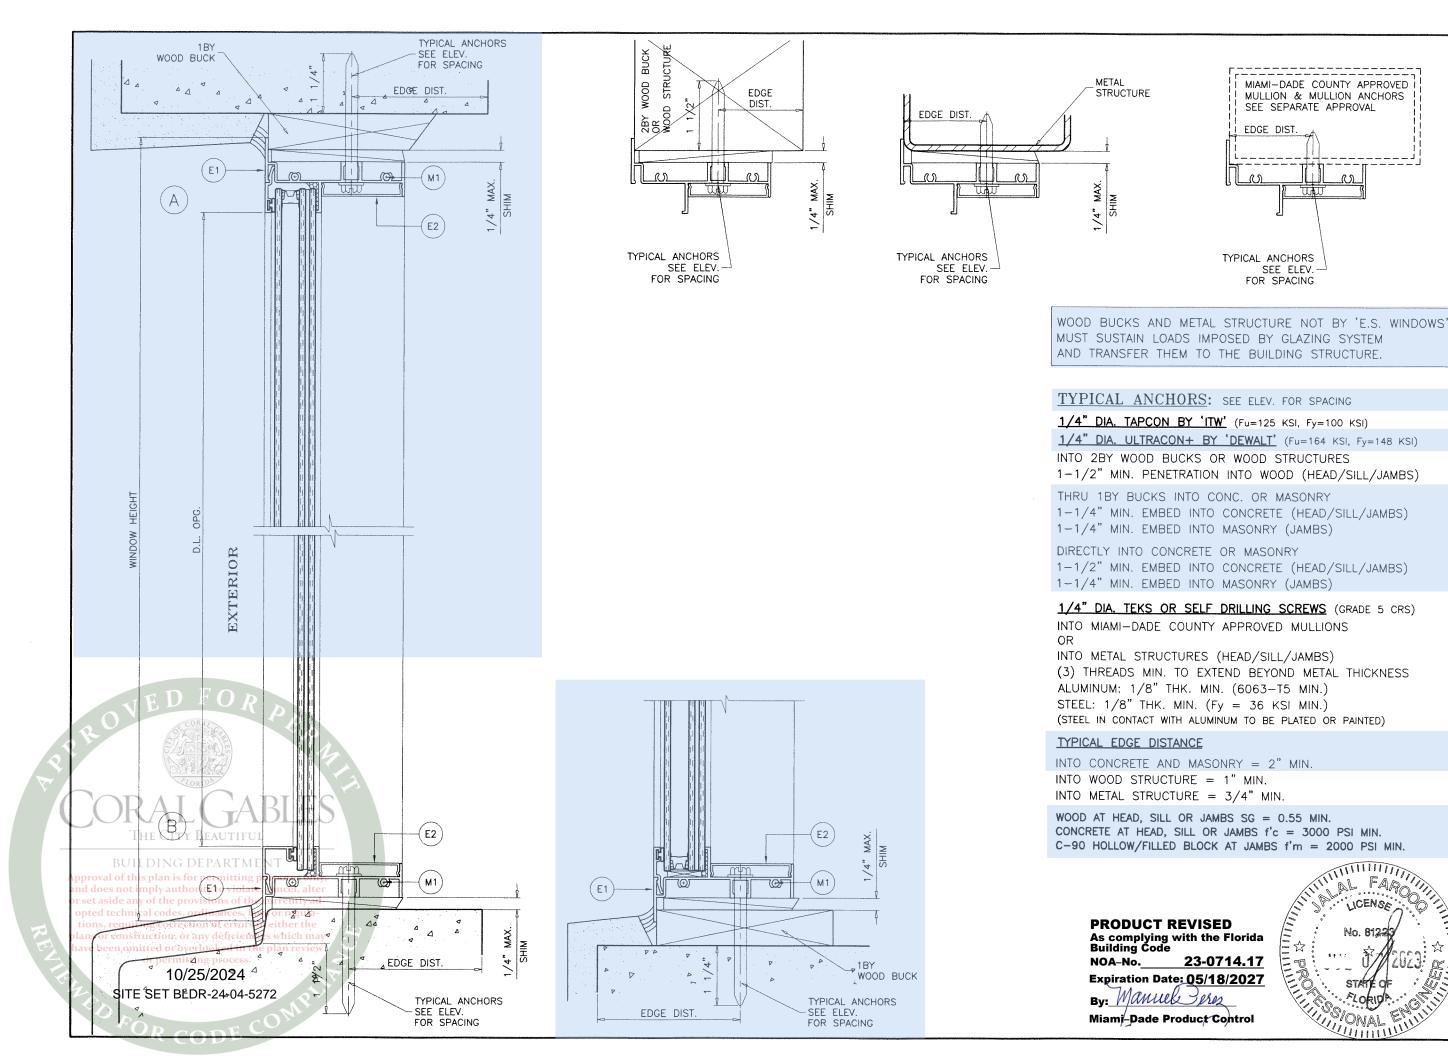

(C.A.N. 3538) 305) 262-6978

CORPORATION DUCT DEVELOPMENT

AL-FAROOQ CORPOR/
ENGINEERS & PRODUCT DEVELOPI
9360 SUNSET DRIVE, SUITE 220
MIAMI, FLORIDA 33173 (C.A
TEL. (305) 264-8100 FAX. (305)

M.E.

WDW.


E.S. WINDOWS, LLC 3550 N.W. 49 STREET MIAMI, FL. 33142 TEL. (305) 638–5151 FAX. (


FIXED ALUMINUM ES-EL150

11-13-16 1/2" ρχ̈́

₽. drawing W16 - 70


sheet 4 of 9

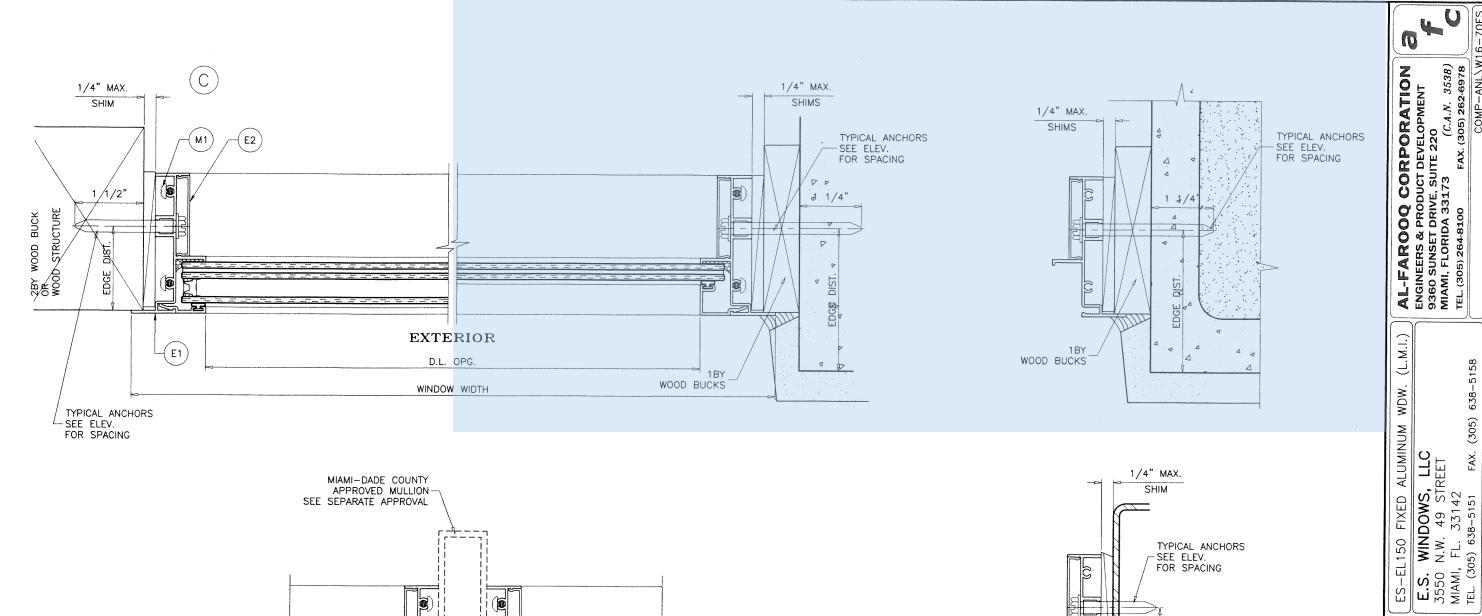

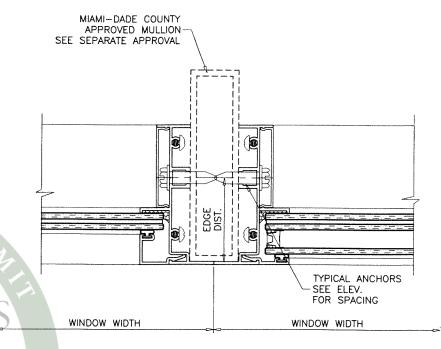

# THE CITY BEAUTIFUL

10/25/2024 SITE SET BLDR-24-04-5272

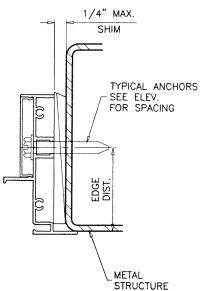


**PRODUCT REVISED** As complying with the Florida Building Code NOA-No. 23-0714.17

Expiration Date: 05/18/2027


By: Manuel Peres


Miami-Dade Product Control

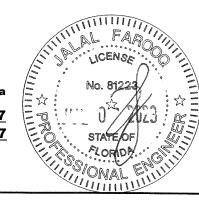

	revisions:	no date	A 05.12.17	B 11.27.17	C 06.22.20	D 06.15.21	2000 30 3
	date: 11-13-16		scale: $1/2" = 1"$		dr. by: TARIQ		cnk. by:
3/	d	ra	wir	ng		no	
	۷	V.	16	3-	- 7	70	)

sheet 5 of 9

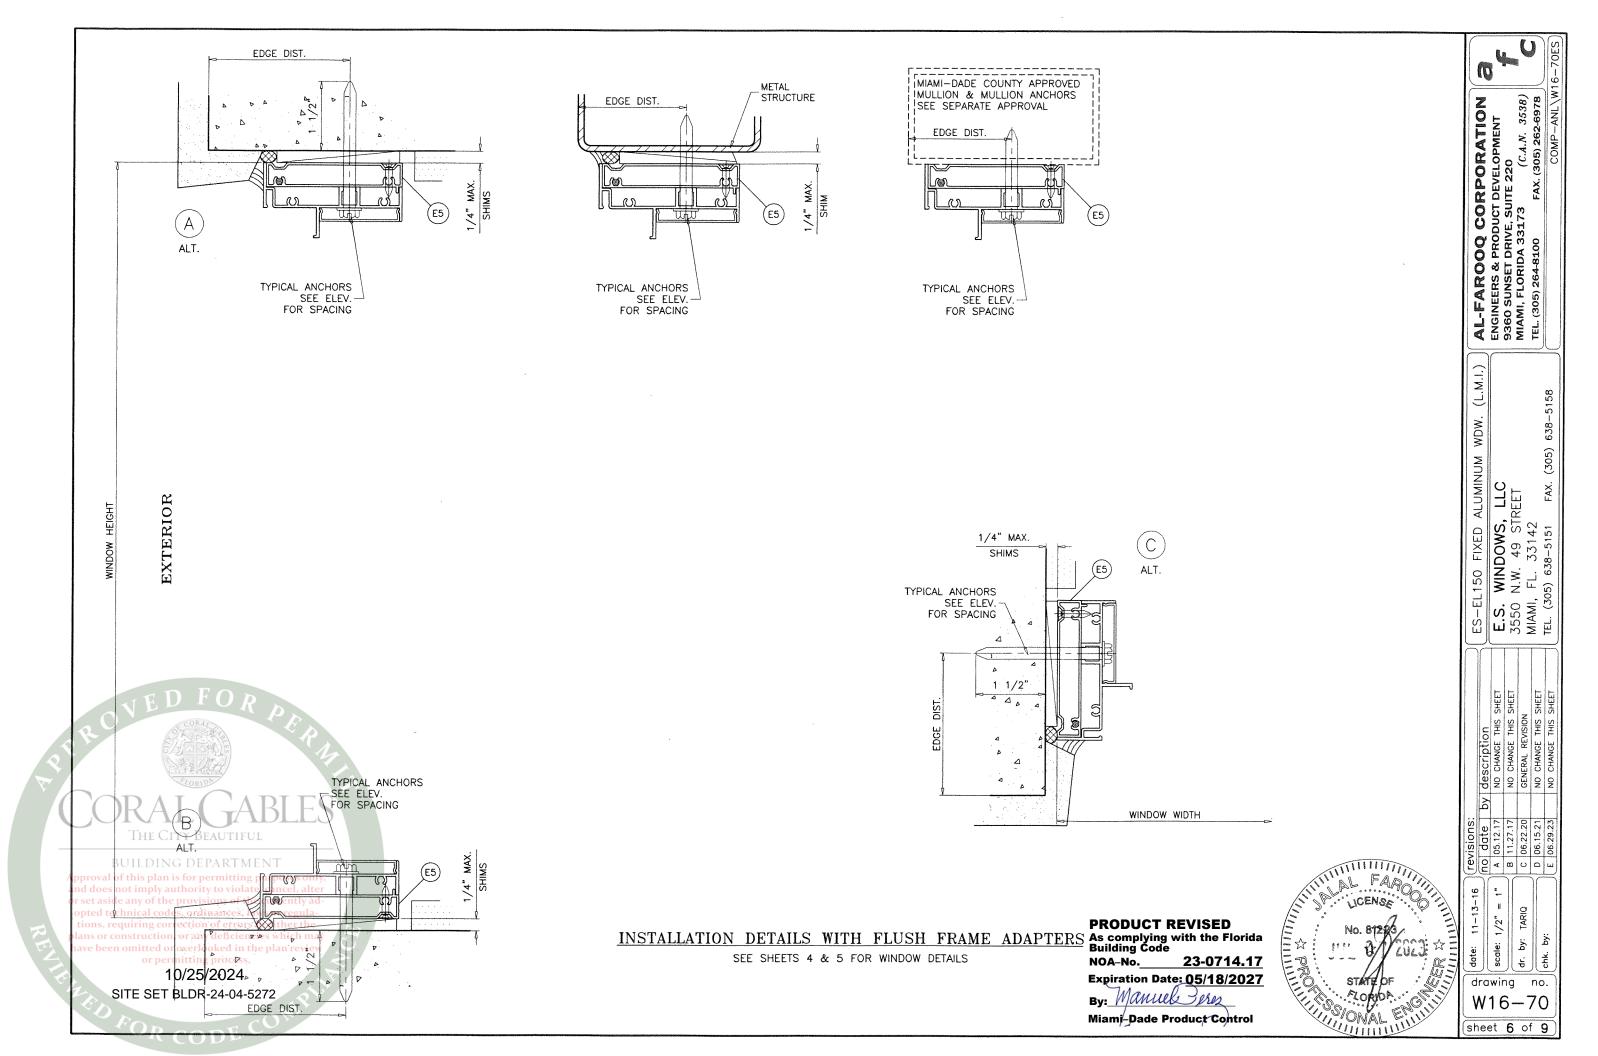


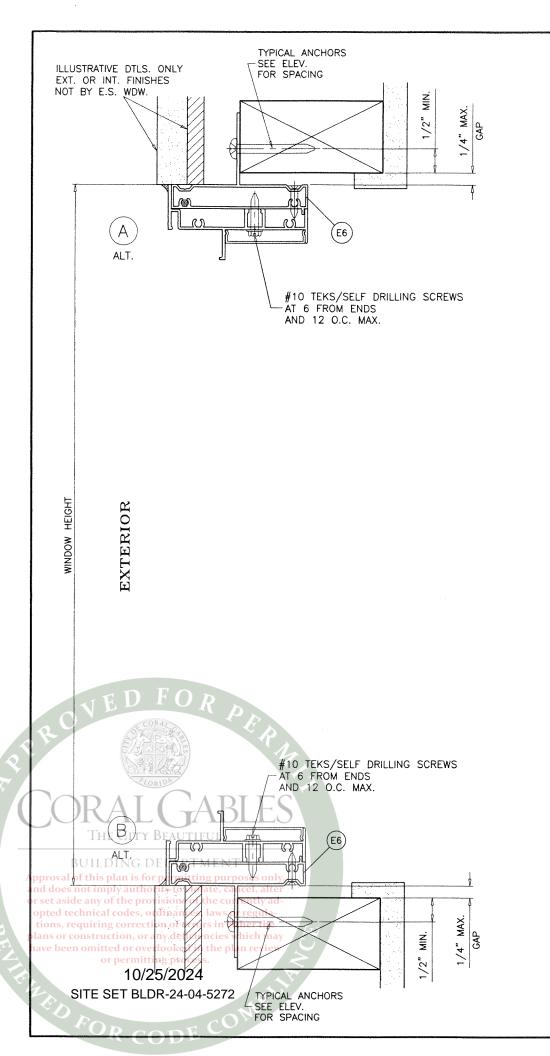

TYPICAL ANCHORS: SEE ELEV. FOR SPACING

#10 WOOD SCREWS (GRADE 2 CRS)

INTO 2BY WOOD BUCKS OR WOOD STRUCTURES 1-1/2" MIN. PENETRATION INTO WOOD

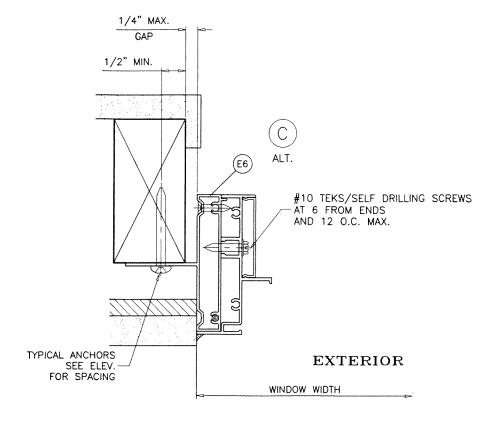


# INSTALLATION DETAILS WITH FIN FRAME ADAPTERS

SEE SHEETS 4 & 5 FOR WINDOW DETAILS

PRODUCT REVISED
As complying with the Florida
Building Code
NOA-No. 23-0714.17

NOA-No. 23-0714.17 Expiration Date: 05/18/2027

Miami-Dade Product Control

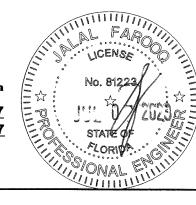

revision	A 05.12.1	B 11.27.1	
1	awi scale: 1/2" = 1"	_	


by:

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7 of 9

no.

AL-FAROOQ CORPORATION
ENGINEERS & PRODUCT DEVELOPMENT
9360 SUNSET DRIVE, SUITE 220
MIAMI, FLORIDA 33173 (C.A.N. 3538)
TEL. (305) 264-8100 FAX. (305) 262-6978 ES-EL150 FIXED ALUMINUM W
E.S. WINDOWS, LLC
3550 N.W. 49 STREET
MIAMI, FL. 33142
TEL. (305) 638-5151 FAX. (305) by description
NO CHANGE THIS
NO CHANGE THIS
GENERAL REVISIO
NO CHANGE THIS
NO CHANGE THIS

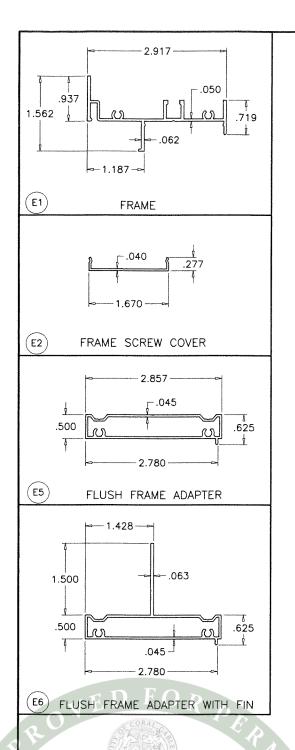

THE CITY BEAUTIFUL


10/25/2024

SITE SEP BLDR-24-04-5272

(E7)

.519-

.050

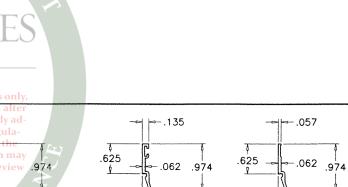

-- .202

**E4** 


GLAZING BEADS

E4A)

ITEM #	PART #	REQD.	DESCRIPTION	MATERIAL	MANF./SUPPLIER/REMARKS
E1	ES-EL151	1	FRAME	6063-T6	-
E2	ES-EL152	AS REQD.	FRAME SCREW COVER	6063-T6	-
E4	ES-EL111	AS RQD.	GLAZING BEAD (INSUL. LAM. GLASS)	6063-T6	-
E4A	ES-EL116	AS RQD.	GLAZING BEAD (INSUL. LAM. GLASS)	6063-T6	
E5	ES-EL112	AS REQD.	FLUSH FRAME ADAPTER	6063-T6	_
E6	ES-EL115	AS REQD.	FLUSH FRAME ADAPTER WITH FIN	6063-T6	Au-
E7	ES-EL110	AS RQD.	GLAZING BEAD (7/16" LAM. GLASS)	6063-T6	-
E7A	ES-EL123	AS RQD.	GLAZING BEAD (7/16" LAM. GLASS)	6063-T6	
M1	#8 X 1"		FRAME ASSEMBLY FASTENERS	ST. STEEL	PH SMS
M2	ES-5008A	AS REQD.	EXTERIOR BULB GASKET	SILICONE	DUROMETER 60±5 SHORE A
M2A	EL100-G02	AS REQD.	EXTERIOR LEAF GASKET	SILICONE	DUROMETER 60±5 SHORE A
м2В	ES-H-340-G05	AS REQD.	EXTERIOR WEDGE GASKET	SILICONE	DUROMETER 65±5 SHORE A
мз	80-372A	2/ LITE	SETTING BLOCK AT 1/4 POINTS (LAM. GLASS)	SILICONE	DUROMETER 80±5 SHORE A
M4	EL100-B01	2/ LITE	SETTING BLOCK AT 1/4 POINTS (INSUL. LAM. GLASS)	SILICONE	DUROMETER 80±5 SHORE A
M5	#8 X 1"	-	FLUSH/FIN FRAME ADAPTER ASSEMBLY FASTENERS	ST. STEEL	FH SMS

As complying with the Florida Building Code NOA-No. 23-0714.17

Miami-Dade Product Control

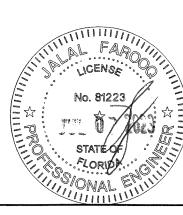

Mate: 11–13–16   Tevisions:   A   Discrete   1/2" = 1"   A   05.12.17   REV.     A   Discrete   1/2" = 1"   A   05.12.17   REV.     A   Discrete   Discr
$\begin{array}{c c} MIIIIIMM\\ \hline MIIIIIMM\\ \hline Mote: 11-13-16\\ \hline Mus by: TARIQ\\ \hline Outher by: TARIQ\\ \hline Other by: TARIQ\\ \hline Other by: TARIQ\\ \hline \end{tabular}$
$\begin{array}{c c} MIIIIIMM\\ \hline MIIIIIMM\\ \hline Mote: 11-13-16\\ \hline Mus by: TARIQ\\ \hline Outher by: TARIQ\\ \hline Other by: TARIQ\\ \hline Other by: TARIQ\\ \hline \end{tabular}$
drawing no. W16-70
W16-70

AL-FAROOQ CORPORATION
ENGINEERS & PRODUCT DEVELOPMENT
9360 SUNSET DRIVE, SUITE 220
MIAMI, FLORIDA 33173 (C.A.N. 3538)
TEL. (305) 264-8100 FAX. (305) 262-6978

(L.M.I.)


ES-EL150 FIXED ALUMINUM W


E.S. WINDOWS, LLC
3550 N.W. 49 STREET
MIAMI, FL. 33142
TEL. (305) 638-5151 FAX. (305) 4


PRODUCT REVISED

Expiration Date: 05/18/2027

By: Manuel Perez

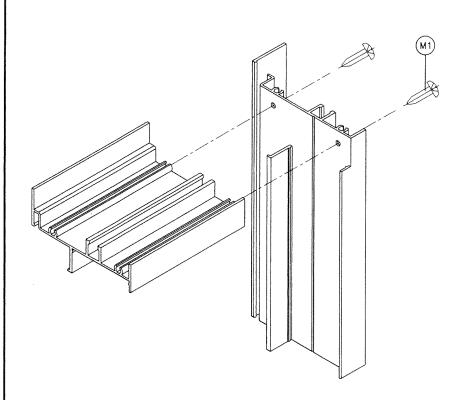

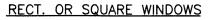


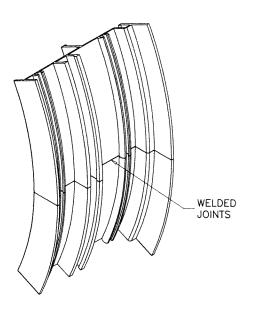


CIRCULAR WINDOWS



10/25/2024 SITE SET BLDR-24-04-5272

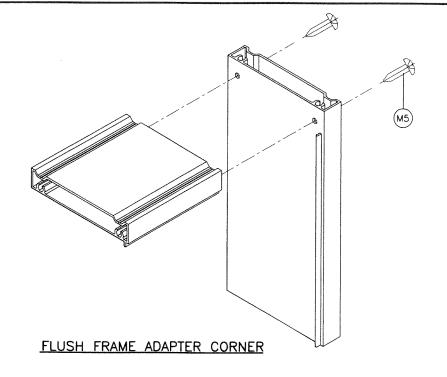

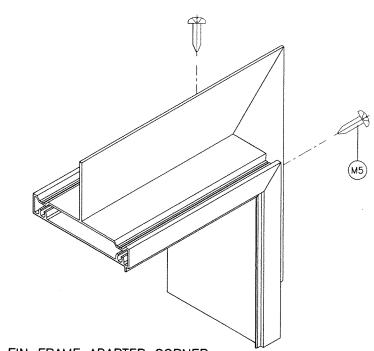


FIN FRAME ADAPTER CORNER

PRODUCT REVISED
As complying with the Florida
Building Code NOA-No. 23-0714.17

Expiration Date: 05/18/2027

By: Manuel Peres

Miami-Dade Product Control

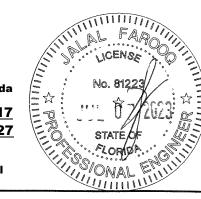

FS_FI 150 FIXED	LS LE 1 00 - 1 1 NED	E.S. WINDOWS,
VALLALARAMENTA DE LE PRESENTA DE LA PRESENTA DEL PRESENTA DEL PRESENTA DE LA PRES	/ description	NO CHANGE THIS SHEET
revisions:	no date by	A 05.12.17
a date: 11-13-16		scale: $1/2$ " = 1"
d	ra V	wir

by:

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sheet 9 of 9





CITY OF CORAL GABLES

## DEVELOPMENT SERVICE DEPARTMENT

Permit Application

Development Services Department 427 Biltmore Way, 1<sup>st</sup> Floor Coral Gables, Florida, 33134

Tel: 305-460-5245

Website: www.coralgables.com

Email: developmentservices@coralgables.com

1 CI IIII	Type: Master Permit #:
Permit Change: Building	
Change of Contractor Electrica	al Project Information:
Permit Extension Mechan	
Permit Renewal Plumbin	Linear Feet:
Permit Revision Misc.	Square Feet:
Permit Supplement App.	Date: Cost of Work: 19915.90
DESCRIPTION OF WORK (PRINT):	Job Address: 405 VISCAYA AVE
new 16 windows	Folio #: 03-4117-016-0050
	Lot: Block:
	Subdivision:
	Plat book: Page:
PROPERTY OWNER:	CONTRACTOR COMPANY NAME: PATRIOT WINDOWS AND D
Name: HARRIS LEVINE & KAMILA PRZYTULA	Qualifier Name: ALAIN ANGUERA
Address: 9700 SW 67 AVE	Address: 6073 NW 167 ST UNIT C15
City/State/Zip: PINECREST, FL 33156	City/State/Zip: MIAMI LAKES, FL 33015
Telephone No.: 786-985-0174	License No.: CGC1531016 Telephone No.: 305-206-5292
Email: citypermittingservices@gmail.com	Email: brandon@patriotwindowsdoors.com
ARCHITECT:	ENGINEER:
Name:	Name:
Address:	Address:
BONDING:	MORTGAGE LENDER:
Name:	Name:
Address:	Address:

ATTORNEY BEFORE COMMENCING WORK OR RECORDING YOU Department's approval is required prior to the issuance of a demolition prior to the issuance of

SITE SET BLDR-24-04-527202

Qualifier Name (Print): MCI M POCCO

STATE OF FLORIDA )
ss
COUNTY OF MIAMI-DADE )

The foregoing instrument was acknowledged before me by means of [1] physical presence or [1] online notarization, this O day of 102 by who [1] is personally known to me or 11 who has produced as identification.

My Commission Expires:

Signature of Qualifier:

Notary Public ZURAYAM GONZALE

7 JURAYAM GONZALEZ

Motary Public - State of Florida Commission # HH 160053 My Comm. Expires Sep 12, 2025 Bonded through National Notary Assn.

Form 101 7/24/2023