

LEGAL DESCRIPTION AND CERTIFICATION

Lots 6 and 7, Block 8, CORRECTED PLAT OF CORAL GABLES, SECTION C, according to the Plat thereof, as recorded in Plat Book 8, Page 26, of the Public Records of MIAMI-DADE County, Florida.

Community Number: 120639 Panel: 0239 Suffix: L Flood Zone: X Field Work: 9/6/2019

Certified To:

REBECCA CHARLTON AND STEPHEN WINNER; FLORIDA TITLE AND GUARANTEE AGENCY; FIDELITY NATIONAL TITLE INSURANCE GROUP; CHASE, its successors and/or assigns.

Property Address: 1024 ASTURIA AVENUE CORAL GABLES. FL 33134

Survey Number: 384845

Client File Number: 782-19-0148

	1	ADDREVIA	TION DESCRIPTION:	
A.E. A/C B.M. B.R. (C) Δ CH (D) D.H. D/W E.O.W. F.C.M.	ANCHOR EASEMENT AR CONDITIONER BENCH MARK BEARING REFERENCE CALCULATED CENTRAL / DELTA ANGLE CHORD DEED / DESCRIPTION DRAINAGE EASEMENT DRILL HOLE DRIVEWAY EDGE OF WATER FOUND CONCRETE MONUMENT	F.I.P. F.I.R. F.P.K. (L) L.A.E. (M) M.H. N&D N.R. N.T.S.	FINISH FLOOR ELEVATION FOUND IRON PIPE FOUND IRON ROD FOUND PARKER-KALON NAIL LENGTH LIMITED ACCESS EASEMENT LAKE MAINTENANCE EASEMENT MEASURED / FIELD VERIFIED MANHOLE NAIL & DISK NOT RADIAL NOT TO SCALE OVERHEAD UTILITY LINES	0.R P.B. P.C. P.O. P.C. P.C. P.C. P.C. P.C. P.C

APPREVIATION DESCRIPTION

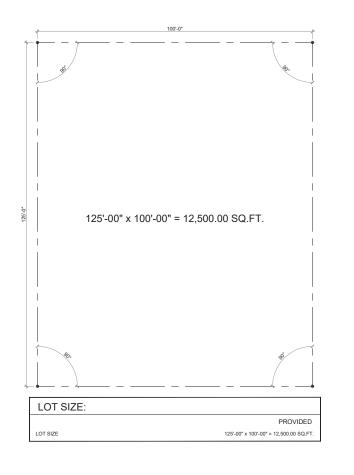
GENERAL NOTES:

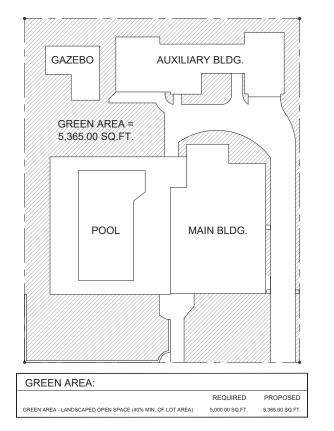
- LEGAL DESCRIPTION PROVIDED BY OTHERS THE LANDS SHOWN HEREON WERE NOT ABSTRACTED FOR EASEMENTS OR OTHER RECORDED ENCUMBRANCES NOT SHOWN ON THE PLAT. UNDERGROUND PORTIONS OF FOOTINGS, FOUNDATIONS OR OTHER IMPROVEMENTS WERE NOT LOCATED. WALL TIES ARE TO THE FACE OF THE WALL AND ARE NOT TO BE USED TO RECONSTRUCT BOUNDARY LINES.
- 4)

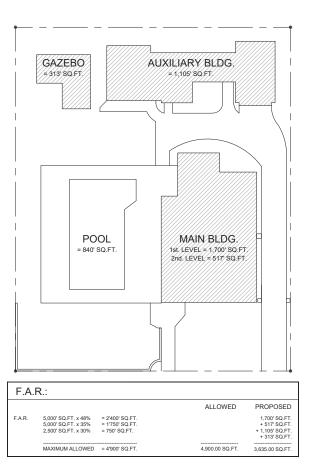
- BOUNDARY LINES. ONLY VISIBLE ENCROACHMENTS LOCATED. DIMENSIONS SHOWN ARE PLAT AND MEASURED UNLESS OTHERWISE SHOWN. FENCE OWNERSHIP NOT DETERMINED. ELEVATIONS INDICATED HEREON ARE IN FEET AND DECIMALS REFRENCED TO N.G.V.D. 1929 IN SOME INSTANCES, GRAPHIC REPRESENTATIONS HAVE BEEN EXAGGERATED TO MORE OF CADI VILUESTBATE DEL ATIONEURS DE TATIONS HAVE BEEN EXAGGERATED TO MORE CLEARLY ILLUSTRATE RELATIONSHIPS BETWEEN PHYSICAL IMPROVEMENTS AND/OR LOT LINES. IN ALL CASES, DIMENSIONS SHALL CONTROL THE LOCATION OF THE IMPROVEMENTS OVER SCALED POSITIONS.

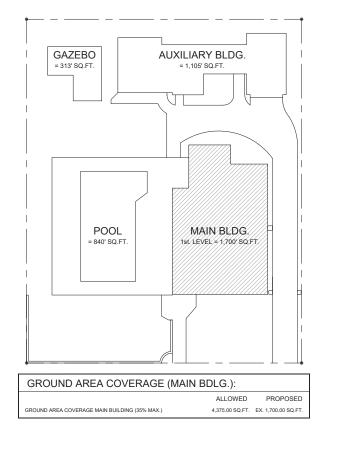


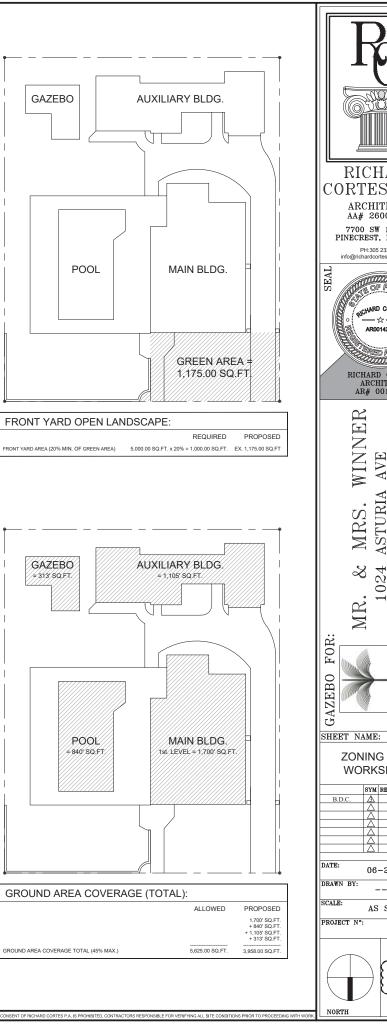
ZONING DATA			
ADDRESS:	1024 ASTURIA AVE, CORAL GAB	LES, FL 33134	
FOLIO #:	03-4107-014-0780		
LEGAL DESCRIPTION:	CORAL GABLES SEC C PB 8-26 LOTS 6 & 7 BLK 8		
	LOT SIZE 100 X 125 OR 18408-1491 1298 5		
	COC 21707-4005 06 2003 5		
SCOPE OF WORK:	NEW AUXILIARY STRUCTURE - O NEW DRIVEWAY (REMOVE AND		ON OF EX. BRIC
	DRIVEWAY) NEW WALKWAY (REMOVE AND I		
PRINCIPAL BUILDING SET	BACKS	REQUIRED	PROVIDED
FRONT	БЛОКО	25'-0"	EX. 25'-0
RIGHT SIDE		20% OF LOT WIDTH MAX. 20'-0" COMB.	EX. 12'-4 EX. 53'-0
SIDE (STREET) REAR		15'-0" 10'-0"	N// EX. 45'-8
The U.C.		10 0	270.400
AUXILIARY BUILDING SET	BACKS (NEW GAZEBO)	REQUIRED	PROVIDED
RIGHT SIDE		25'-0" 20% OF LOT WIDTH	EX. 12'-4
LEFT SIDE SIDE (STREET)		MAX. 20'-0" COMB. 15'-0"	7'-8 N//
REAR		10'-0"	10'-0
	(CORAL GABLES)		
Tend Luttu	다 말 같이 있는 것이 없이 않는 것이 없다.		A
Barst Turter	지금지 글린 옷은 [주요] 같은 것을 다.		
	키운데한 바이트리 한 나무	1011 P.C. 21942	
· [주말] 플레이드는 프 사이드	미승리 김 모양 문양 승규는 부분	a second filter	
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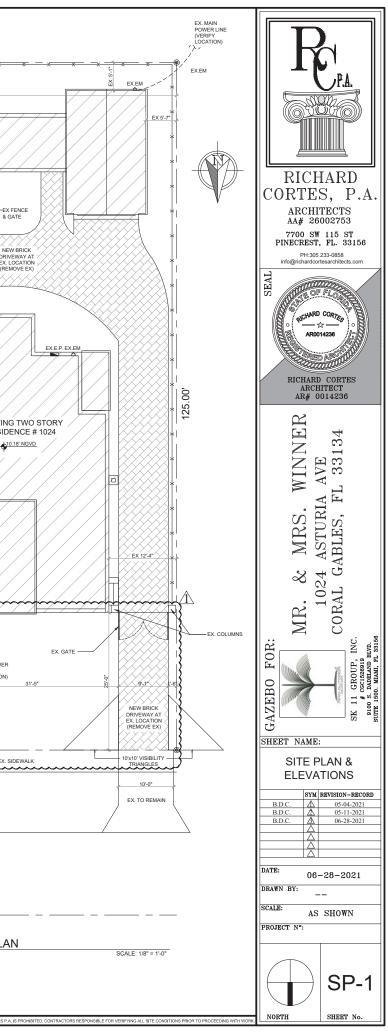






			EX. MAIN POWER LINE (VERIFY LOCATION)		
_ آ} د	ZONING DATA / BUILDING INFORMATION:	FLOOD LEGEND / NEW GAZEBO:		<u> </u>	
	PROPOSED USE: MAIN BUILDING AREA: EX. SINGLE-FAMILY RESIDENTIAL DISTRICT STR: SINGLE-FAMILY RESIDENTIAL DISTRICT STR: SINGLE-FAMILY RESIDENTIAL DISTRICT 313.00 SQ.FT. DOT SIZE: AUXILIARY BLDG. AREA (GAZEBO): 10'9' BUILDING SQUARE FOOT CALCULATION (MAX. FAR ALLOWED = 4,900'SQ.FT.) EX. MAN BUILDING AREA - 1ST LEVEL (EVERYTHING UNDER THE ROOF) EX. MAN BUILDING AREA - 1ST LEVEL (EVERYTHING UNDER THE ROOF) EX. MAN BUILDING AREA - 1ST LEVEL (EVERYTHING UNDER THE ROOF) EX. MAN BUILDING AREA - 1ST LEVEL (EVERYTHING UNDER THE ROOF) EX. MAN BUILDING AREA - 1ST LEVEL (EVERYTHING UNDER THE ROOF) EX. MAN BUILDING AREA - 1ST LEVEL (EVERYTHING UNDER THE ROOF) EX. MAN BUILDING AREA - 1ST LEVEL (EVERYTHING UNDER THE ROOF) EX. MAN BUILDING SETBACKS REQUIRED PROVIDED FRONT EX. 25'0' EX. 35'0' RIGHT SIDE EX. MAN BUILDING SETBACKS (NEW GAZEBO) SIDE (STREET) AUXILIARY BUILDING SETBACKS (NEW GAZEBO) REAR AUXILIARY BUILDING SETBACKS (NEW GAZEBO) TOTAL PROVODED FRONT EX. 43'3' AUXILIARY BUILDING SETBACKS (NEW GAZEBO) REAR AUXILIARY BUILDING SETBACKS (NEW GAZEBAC DOT WORD NO TO THE REAR AUXILIARY BUILDING SETBACK	FLOOD LEGEND / NEW GAZEBO: ADDRESS. 103 ASTURIA AVE. CORAL GABLES, FL 33134 FOLD: State of the 303 CORE STATE State of the 304 CORE STATE St			DVE PORTION OF RICK DRIVEWAY EX. CONCRETE DECK
	FENCE LEFT SIDE ELEVATION (EAS' SCALE: ¼" = 1'-0			ASTURIA AV	EX. WOOD GATE TENUE TENUE

3HT 2017 ALL RIGHTS RESERVED. THESE DRAWINGS AND DOCUMENTS ARE INSTRUMENTS OF SERVICE SHALL REMAIN THE PROPERTY OF RICHARD



GENERAL NOTES:

1. THE CONTRACTOR SHALL VERIFY ALL DIMENSIONS, ELEVATIONS AND ANGLES AND ALL OTHER EXISTING CONDITIONS PRIOR TO COMMENCING ANY WORK, PLEASE NOTIFY ARCHITECT BY CERTIFIED MAIL OF ANY CONFLICTS OR DISCREPANCIES IF ANY.

2. THE CONTRACTOR SHALL FURNISH AND BE SOLELY RESPONSIBLE FOR ALL TEMPORARY BRACING AND SHORING REQUIRED TO MAINTAIN PLUMBNESS AND STABILITY OF ALL STRUCTURAL LELMENTS DURING CONSTRUCTION.

3. THE CONTRACTOR SHALL OBTAIN FROM ALL SUBCONTRACTORS THE FINAL APPROVED SITE AND LOCATION OF ALL OPENINGS TO BE PROVIDED FOR RESPECTIVE TRADES. HE SHALL BE RESPONSIBLE FOR LOCATION AND DETAILS.

4. ALL CONCRETE FOR FOUNDATIONS & SLABS ON GRADE SHALL REACH 2500 PSI COMPRESSIVE STRENCTH AT 28 DAYS, AND ALL COLUMNS, GROUTED CELLS, SLABS ABOVE GRADE AND THE BEAMS SHALL REACH 3000 PSI COMPRESSIVE STRENGTH MINIMUM AT 28 DAYS UNLESS OTHERWISE NOTED.

5. CONTRACTOR/OWNER SHALL BE RESPONSIBLE FOR VERIFYING REQUIRED GRADE & FINISHED FLOOR ELEVATION WITH RESPECT TO DADE COUNTY FLOOD CRITERIA, EXISTING CROWN OF ROAD ELEVATIONS, FEDERAL FLOOD CRITERIA OR ANY OTHER GOVERNING BODY.

- 6. CONTRACTOR/OWNER SHALL NOTIFY ARCHITECT IN WRITING, BY CERTIFIED MAIL UPON COMMENCEMENT PROJECT. 13. H
- 7. ELECTRICAL INSTALLATION DESIGN OF THIS PLAN IS IN COMPLIANCE AS SET FORTH BY STATE OF FLORIDA STATUS MODEL ENERGY EFFICIENCY CODE.
- 8. ALL WORK SHALL BE IN STRICT ACCORD WITH THE FBC THE NEC AND ALL APPLICABLE FEDERAL, STATE AND COUNTY REGULATIONS.
- 9. ALL LUMBER IN CONTACT WITH CONCRETE OR MASONRY SHALL BE PRESSURE TREATED. 10. CONTRACTOR SHALL VERIFY ALL DIMENSIONS AND CONDITIONS ON THE DRAWINGS AND AT THE JOB SITE AND REPORT ANY INCONSISTENCIES TO THE ARCHITECT OR DESIGNER.
- 11. THE ELECTRIC SERVICE SHALL BE INCREASED IF THE AMPERAGE IS NOT OF ADEQUATE CAPACITY TO ACCEPT THE ADDITIONAL LOADS.
- 12. ALL LOCKS ON EXTERIOR DOORS SHALL BE CAPABLE OR RESISTING A FORCE OF 300 POUNDS APPLIED IN ANY MOVABLE DIRECTION AND IN ACCORDANCE WITH RESISTANCE STANDARDS SET FORTH IN METRO CODE &C

13. HINGES ON EXTERIOR OUT SWINGING DOORS SHALL HAVE NON-REMOVABLE PINS.
14.N/A
15.N/A
16.N/A
17.N/A

18. SLAB ON FILL: SHALL BE PLACED ON CLEAN ORGANIC SOIL, THROUGHLY MOISTENED BEFORE CONCRETE IS POURING. SHALL BE POURING IN A CHECKERBOARD SEQUENCE EACH FRAGMENT OF WHICH IS NOT EXCEED A MAXIMUM AREA OF 625 SF OR 30 LF IM ANY DIRECTION.

19. FIRESTOPPING: FIRESTOPPING SHALL BE PROVIDED TO CUT OFF ALL CONCEALED DRAFT SPACES BOTH VERTICAL AND HORIZONTAL. REQUIRE FIRESTOPS SHALL BE CONTINUOUS AND SUCH CONTINUTY SHALL BE MAINTAINED THROUGHOUT. 'Y X 'P T.A. T LEAST SHALL BE CONSIDERED AS FIRESTOPPING DEVICE. AND SHALL CONFORM EFFECTIVE FIRE BARRIERS BETWEEN A STORY AND ROO'S FACE.

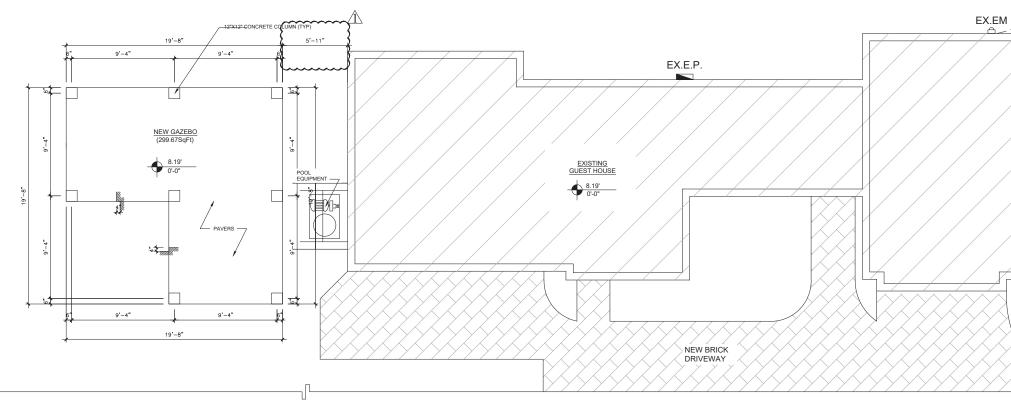
20. FURRING: 1" X 2" P.T. FURRINGS SHALL BE INSTALLED SPACED 16" O/C WITH AT LEAST ONE CUT NAIL IN ALTERNATE COURSE OF BLOCK.

21. SOFFIT VENTILATION: SHALL BE AN INTERMITTENT VENT WITH BREAKS NOT GREATER THAN


4 FEET. SHALL BE KEPT CLEAR OF OBSTRUCTIONS, INCLUDING INSULATION TO ALLOW PROPER


22. DRIP STRIP ON EAVES AND GABLE SHALL HAVE A ROOF FLANGE NOT LESS THAN 2" WIDE. THE METAL PROFILE SHALL BE NAILED WITH A MINIMUM 12 GAGE ANNULAR RING SHANK NAIL AT 4" O.C. WITH A.


23. PLANS MUST COMPLY WITH THE NEW "FLORIDA BUILDING CODE 2020, 7TH EDITION". THE CONSTRUCTION DOCUMENTS HAVE BEEN PREPARED IN COMPLANCE WITH THE 2020, 7th EDITION OF B.C. INCLUDING THE FLORIDE EXISTING BUILDING CODE IF APPLICABLE.




PROPOSED FLOOR PLAN

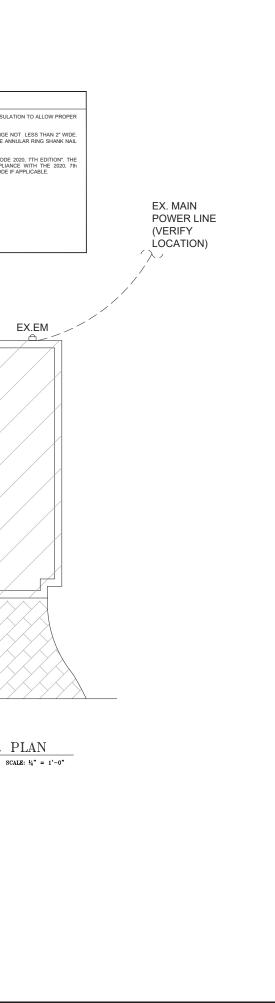

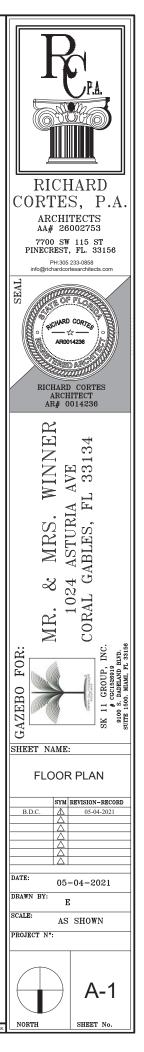


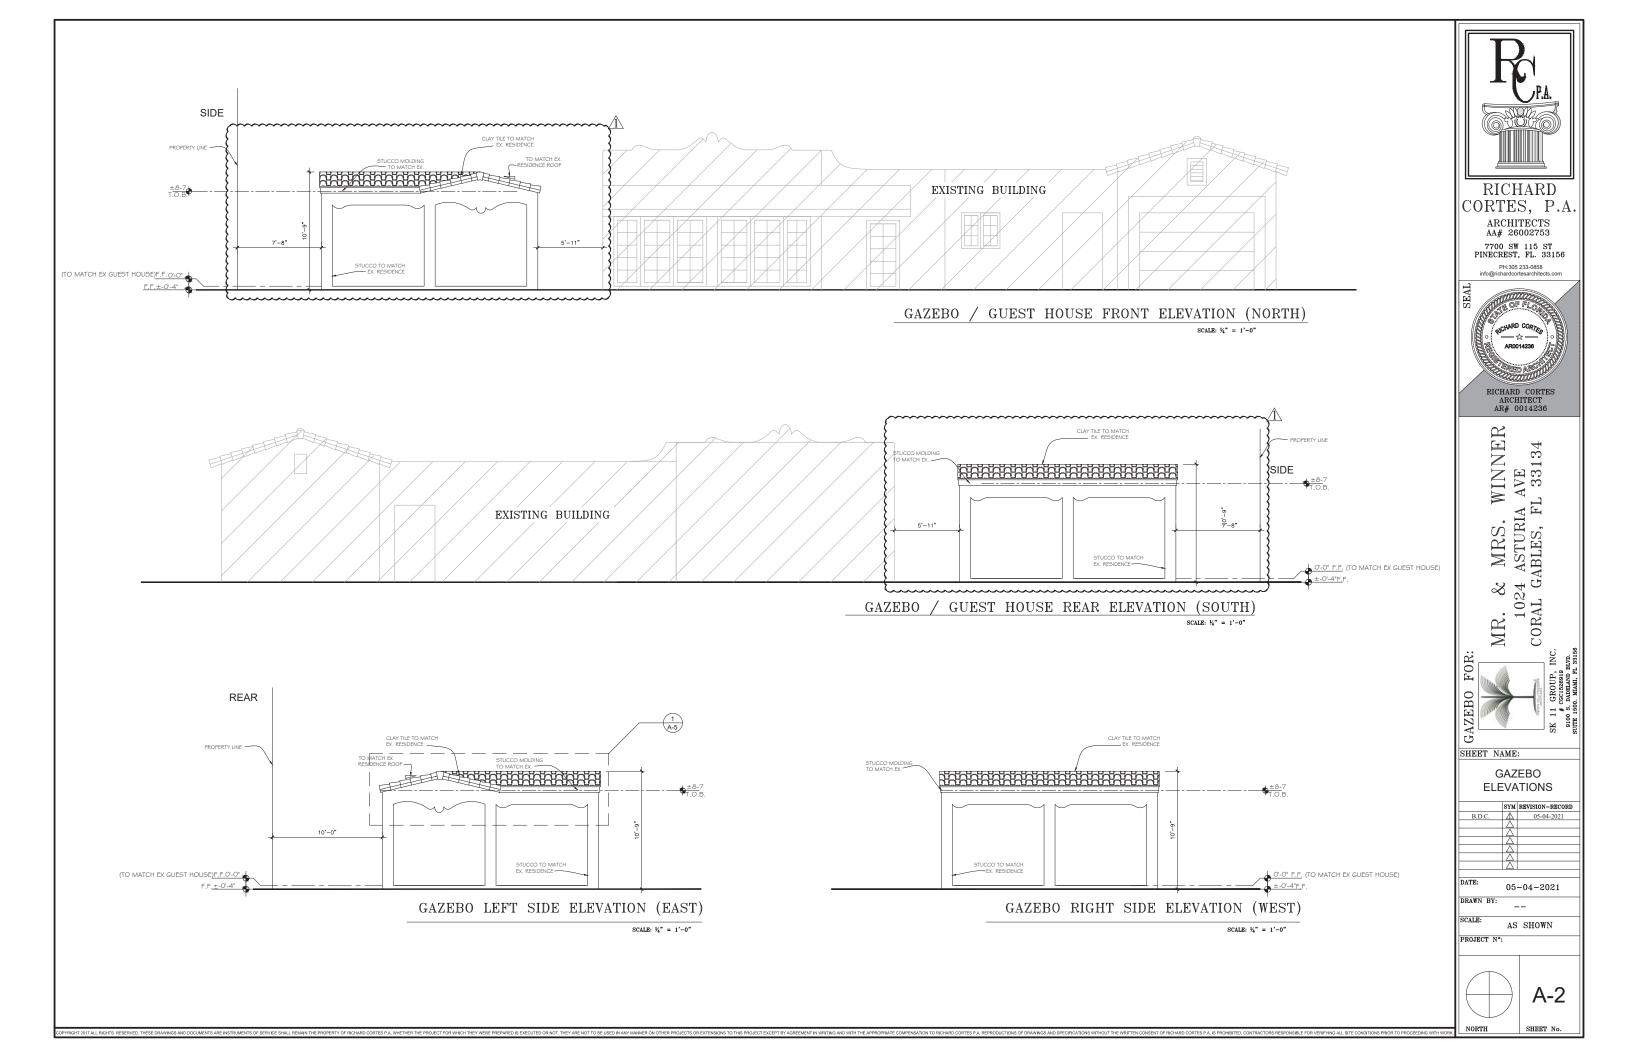


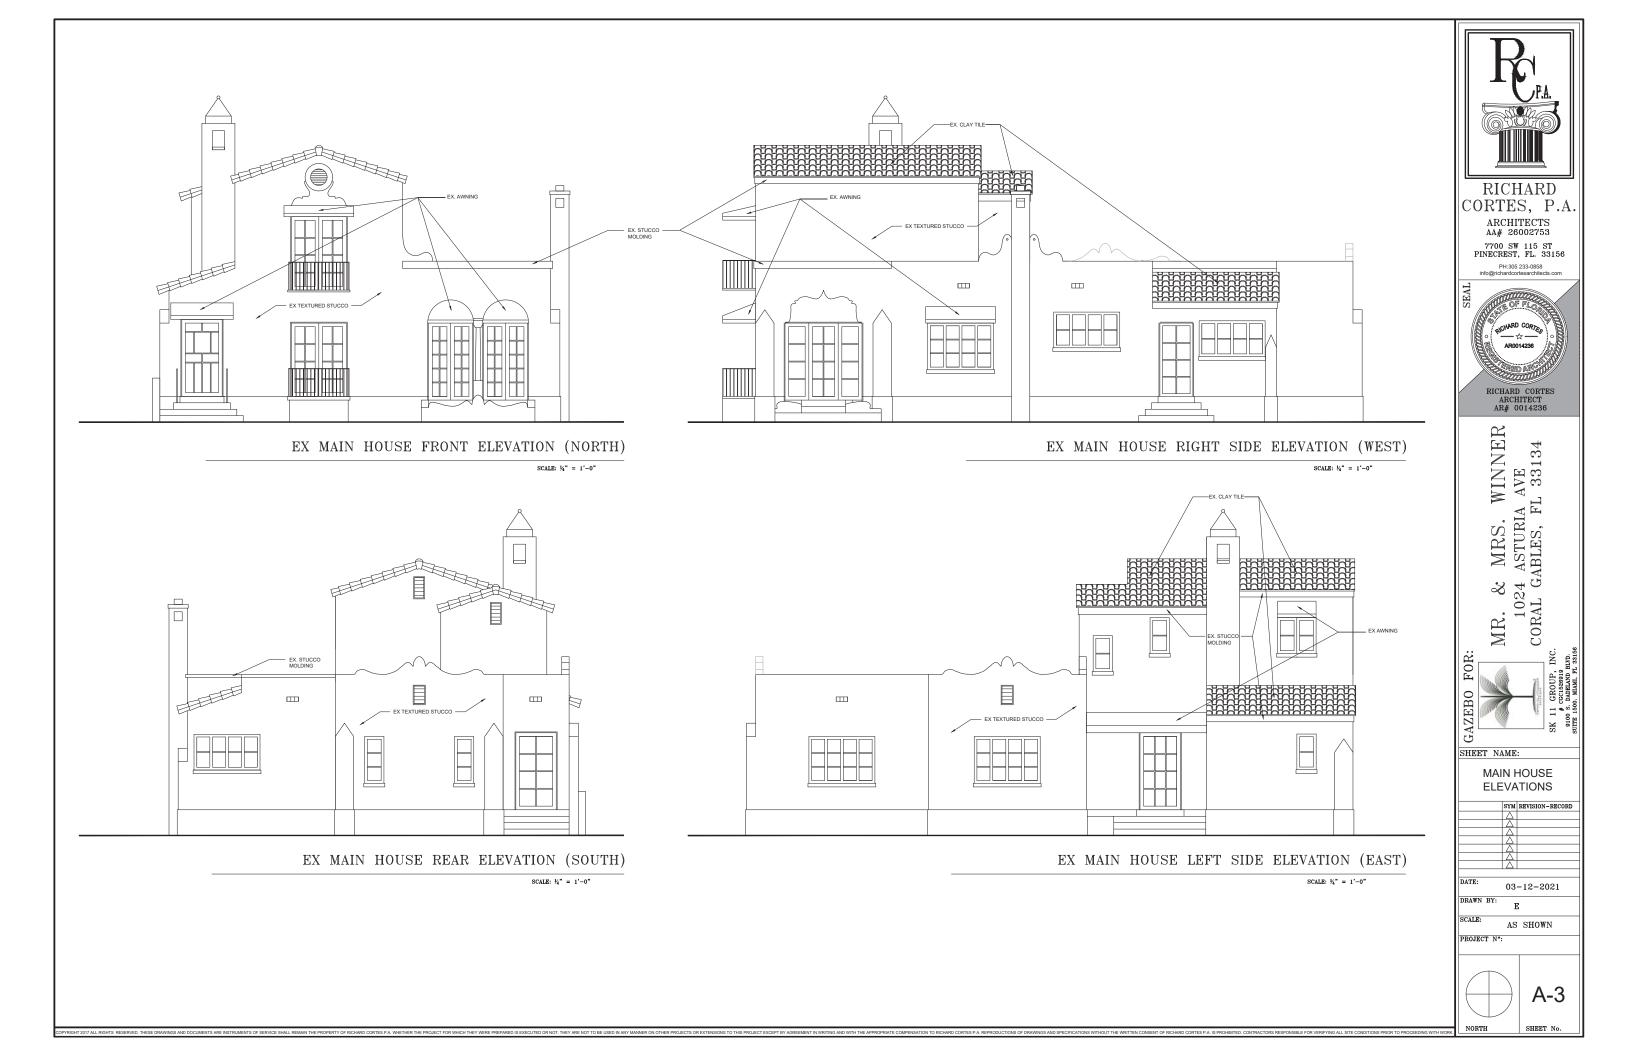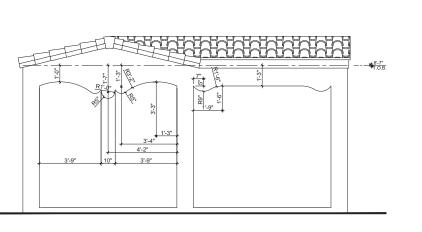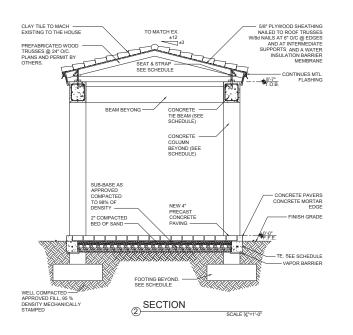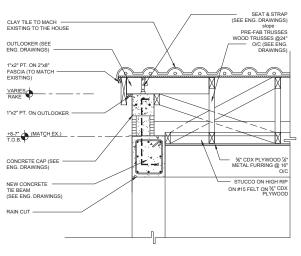













3 TYPICAL GABLE END WALL SECTION



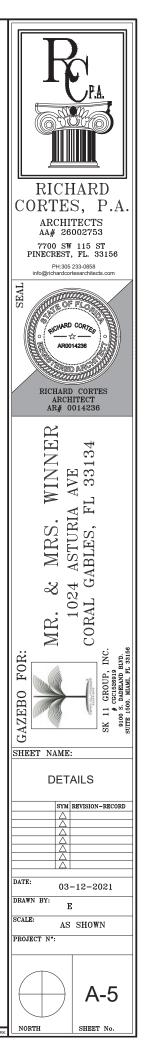













LEGEND:

- A. MAIN HOUSE FRONT VIEW (NORTH)
- B. MAIN HOUSE RIGHT SIDE VIEW (WEST)
- C. MAIN HOUSE REAR VIEW (SOUTH) D. MAIN HOUSE LEFT SIDE VIEW (EAST)
- E. GUEST HOUSE FRONT VIEW (NORTH)F. GUEST HOUSE FRONT VIEW FROM RIGHT SIDE VIEW (WEST)
- G. GUEST HOUSE REAR VIEW (SOUTH) H. GUEST HOUSE LEFT SIDE VIEW (EAST)





RICHARD CORTES RICHARD CORTES ARE DISCOUNTING CORTES RECEIPTION OF FLORE RECEIPTION OF
AZEBO FOR: MR. & MRS. WINNER 1024 ASTURIA AVE CORAL GABLES, FL 33134 sk 11 GROUP, INC. CORAL GABLES, FL 33134 st 11 GROUP, INC.
SHEET NAME: MAIN HOUSE & GUEST HOUSE PHOTOS SYM REVISION-RECORD B.D.C. A 06-28-2021 A A DATE: 06-28-2021 DRAWN BY: SCALE: AS SHOWN PROJECT N°: A-6 SHEET No.





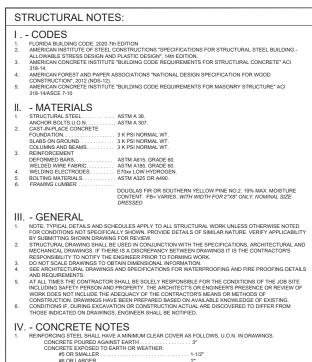








RICHARD CORTES, P.A. ARCHITECTS AR# 26002753 7700 SW 115 ST PINECREST, FL. 33156 DGB/richardcorlesarchiteds.com
GAZEBO FOR: MR. & MRS. WINNER 1024 ASTURIA AVE coral GABLES, FL 33134 sk 11 GROUP, INC. store 1500, MAM. FL 33134
SHEET NAME: RENDERING
SYM REVISION-RECORD B.D.C. 06-28-2021 A A A A A A A A A A A A BATE: 05-04-2021 DRAWN BY: SCALE: AS SHOWN PROJECT N*:
NORTH SHEET No.



- ALL REINFORCEMENT SHALL BE SECURELY HELD IN POSITION WHILE PLACING CONCRETE IF NECESSARY, ADDITIONAL BARS SHALL BE RECVIDED BY THE CONTRACTOR TO FURNISH SUPPORT. THE CONTRACTOR SHALL USERNITY THE DIMENSIONS AND LOCATIONS OF ALL DORENIOS, PIPES SLEEVES, ETC ... AS REQUIRED BY ALL TRADES, BEFORE THE CONCRETE IS POURED. THE CONTRACTOR SHALL CONSULT THE ARCHITECTURAL MECHANICAL, AND ELECTRICAL DRAWINGS, AS WELL AS THE STRUCTURAL DRAWING FOR THE LOCATION, NUMBER AND SIZE OF ALL OPENINGS, SLEEVES, ETC ... HOWEVER, OPENINGS NOT SHOWN ON THE STRUCTURAL DRAWING SHALL BE INSTALLED IN Y AFTER PAPROVAL BY THE SIGNATION OF LOCATION, DURING THE DRAWING SHALL BE SUBMITTED TO ENGINEER FOR APPROVAL PRIOR TO DETAILING OF REINFORCING, ALL CONSTRUCTION JOINTS TO BE CLEARLY SHOWN IN REBAR DETAIL DRAWINGS. ENGINEER MAY REQUIRE ADDITIONAL REINFORCING AT CONSTRUCTION YONTS.
- JOINTS. CONCRETE FINISH FOR SLAB ON GROUND SHALL BE "LIGHT BROOM FINISH". CONCRETE FINISH FOR BEAMS
- CORCHETE EINIGH FOR SLAB OF ORUMUN SHALL BE LIGHT BROOM FINISH. COMCHETE FINISH FOR BEAM AND COLUMNS SHALL BE "SMOOTH FORM FINISH, ACI 301-89 (10:22). CONCHETE EXPOSED TO SALTWATER, BRACKISH WATER, SEAWATER, OR SPRAY FROM THESE SOURCES. SHALL BEAR THE MINIMUM FC3:000 FRI WITH A MAXIMUM WATER-CEMENTITIOUS MATERIAL RATIO (W/CM) OF 0.40. AS PER ACI 318-08 TABLE 4.2.2.

VI. - WOOD NOTES

- ALL WOOD IN CONTACT W CONCRETE, MASONRY OR LATH SHALL BE PRESSURE TREATED AS PER "AMERICAN WOOD-PRESERVES ASSOCIATION". ALL STRUCTURAL WOOD MEMBERS TO BE SAWN LUMBER. "DIMENSIONS LUMBER TO BE "SOUTHERN PINE" WITH A MINIMUM COMMERCIAL GRADE OF NO. 1. DESIGN BENDING STRESS OF FB= VARIES WITH WIDTH PSI.
- ALL MEMBERS TO HAVE VISIBLE GRADE STAMP

V. - MASONRY NOTES

- HOLLOW CONCRETE MASONRY SHOWN ON THESE DRAWINGS SHALL BE ASTM C80, ON GRADE N, TYPE I, NORMAL WEIGHT FC= 1900 P.S.I. MORTAR SHALL CONFORM TO ASTM C270, TYPE "M" OR "S" FOR ABOVE GRADE, TYPE "M" FOR BELOW GRADE,

SOIL STATEMENT NOTE:

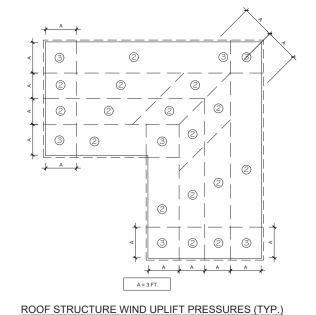
INSPECTION OF THE SITE INDICATES THE PRESENCE OF UNDISTURBED SAND, OR SAND AND ROCK, WITH A MINIMUM BEARING CAPACITY OF 2,000 POUNDS PER SOLVARE FOOT. AT THE TIME OF CONSTRUCTION, A LICENSED ARCHITECT OR REGISTERED PROFESSIONAL ENGINEER, SHALL SUBMIT TO THE BUILDING OFFICIAL A LETTER ATTESTING THAT THE SITE HAS BEEN OBSERVED AND THAT THE FOUNDATION SOIL CONDITIONS ARE SMILLAR TO THOSE UPON WHICH THE DESIGN IS BASED. THE LETTER SHALL BE SIGNED AND BEAR THE MIRRESSED SEAL OF THE ARCHITECT OR ENGINEER, AS APPLICABLE. EFFORMED FOR DEPORT THE MIRRESSED SEAL OF THE ARCHITECT OR ENGINEER, AS APPLICABLE.

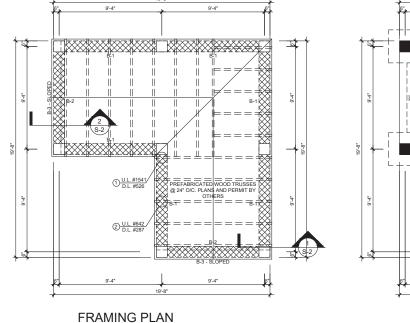
THE ARCHITECT DE REMOINEER, AS APPLICABLE. IF THE CONDITIONS FOUND ARE DIFFERENT, A GEOTECHNICAL REPORT WITH A NEW SOIL LOAD BEARING CAPACITY EVALUATION SHALL BE SUBMITTED AND THE FOUNDATION DESIGN REVISED ACCORDINGLY.

WELL COMPACTED APPROVED FILL 95 % DENSITY MECHANICALLY STAMPED

TERMITE PROTECTION:









IAXIMUM COMBINED DEAD LOAD USED TO RESIST UPLIFT LOADS SHALL NOT EXCEED 10 PS

BEAM SCHEDULE								
MARK	SIZE	MAT.		STEEL		TIES	REMARKS	
WARK	SIZE	WAT.	Т	М	В	TIES	REIMARKS	
B-1	12" x 15"	CONC.	3#5Ø	-	3#5Ø	8 #3Ø @5" O/C E.E. BAL. @12" O/C		
B-2	12" x 12"	CONC.	3#5Ø	-	3#5Ø	8 #3Ø @5" O/C E.E. BAL. @12" O/C		
B-3	8" x 8"	CONC.	-	2#5Ø	-			
* PROVIDE 2-#5 X 5'-0" BENT 30" E.W. @ CORNER								


FOOTING SCHEDULE								
MARK	MAT'L	SIZE	STL TOP	STL BO	REMARKS			
F-3	CONC.	36"x36"x16"	4#5 E/W	4#5 E/W				
TE	CONC.	8"x8"		1#5				
PROVIDE 2-#5 X 5'-0" BENT 30" E.W. @ CORNER								


COLUMN SCHEDULE								
MARK	MAT.	SIZE	STEEL	TIES	REMARKS			
C-1	CONC.	12" X 12"	4 #6Ø	#3Ø @ 12"				


TRUSSES CONNECTORS SCHEDULE								
MARK	MANE.	MODEL	ALLOWABL	E WIND LOA	D CAP. (lbs)	FASTENERS	NOA	
WARK	WANE.	MODEL	UPLIFT	L1	L2	FASTENERS	NOA	
1	NU-VUE	NVHTA-16	1695	1181	1631	12 FASTENERS IN 2 STRAPS 10D X 1 1/2" 6 FASTENERS IN 20 GA. SEAT 10D X 1 1/2"	NOA #: 16-0201.22	
2	NU-VUE	NVHTA-12	1506	1050	1450	10 FASTENERS IN 2 STRAPS 10D X 1 1/2" 6 FASTENERS IN 20 GA. SEAT 10D X 1 1/2"	NOA #: 16-0201.22	


ROOF DESIGN L	OAD
LIVE LOAD	30 PSF
DEAD LOAD	
ROOF FINISH	19 PSF
TRUSS & DECKING	6 PSF
CEILING	2 PSF
TOTAL DEAD LOAD	27 PSF
TOTAL GRAVITY LOAD	55 PSF
TOTAL UPLIFT ZONE-2	60.30 PSF
MINUS MIN.DEAD LOAD	27.00 PSF
NET UPLIFT	33.30 PSF
TOTAL UPLIFT ZONE-3	90.80 PSF
MINUS MIN.DEAD LOAD	23.00 PSF
NET UPLIFT	63.80 PSF

ZONE	WIND UPLIFT PRESSURES			
1	35.9 PSF			
2	60.3 PSF			
3	90.8 PSF			
BY ANY DEAD PRESSURE A	* DO NOT REDUCE WIND UPLIFT PRESSUR BY ANY DEAD LOAD PRESSURE ARE CALCULATED WITH ALLOWED STRESS DESIGN METHOD			

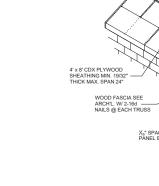


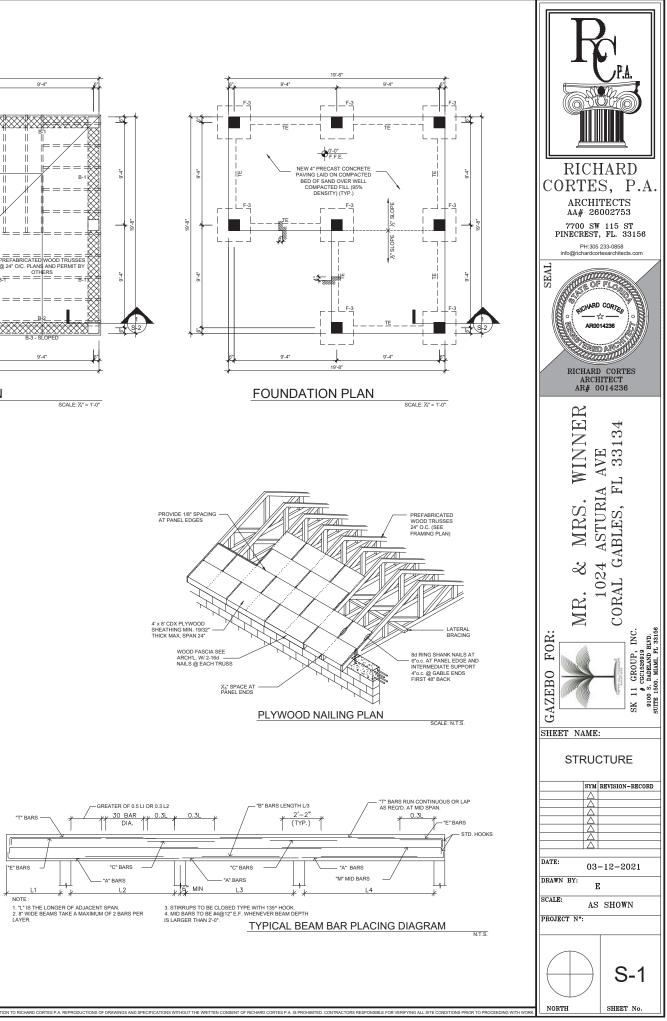


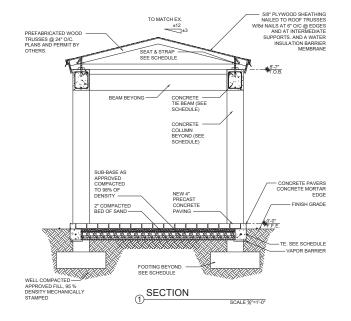


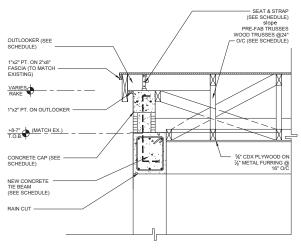

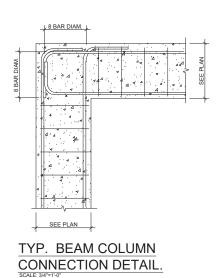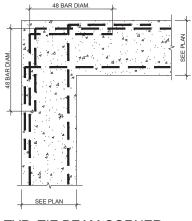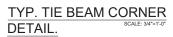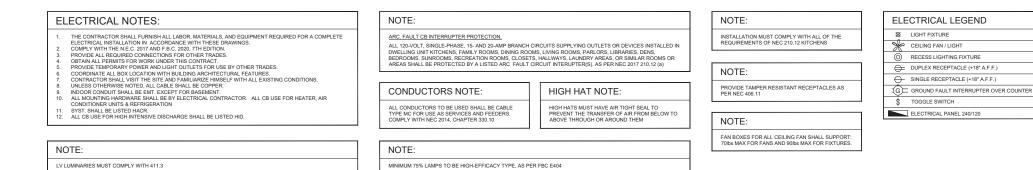
(2) TYPICAL GABLE END WALL SECTION

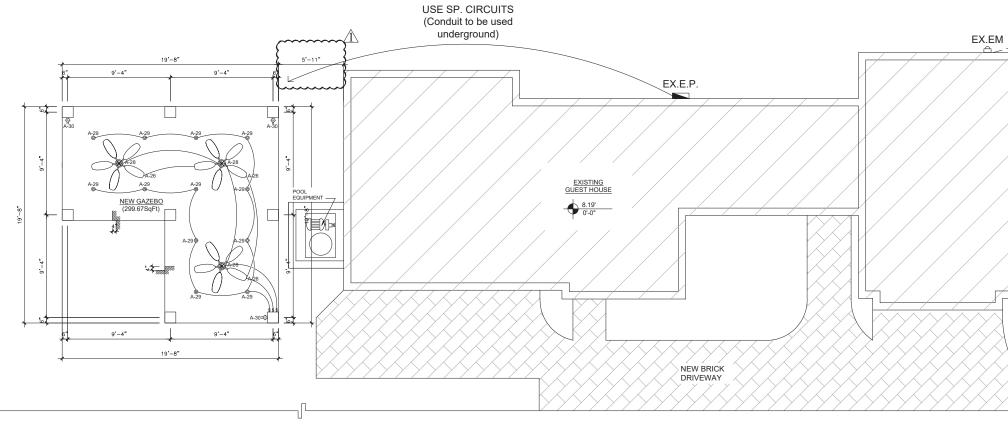






	RICHARD CORTES, P.A. ARCHITECTS AA# 26002753 7700 SW 115 ST PINECREST, FL 33156 PH:305 233-0858 Into@richardcortesarchitects.com
<image/>	DATE: 03-12-2005: BRANK BALES, FL 33134 CORAL GABLES, FL 33134 SK 11 GROUP, INC. BRANK BALES, FL 33134 CORAL GABLES, FL 33134 SK 11 GROUP, INC. BRANK BALES, FL 33134 SK 11 GROUP, INC. SK 11 GROUP, INC. BRANK BALES, FL 33134 SK 1355 SK 1355
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