PONCE CIRCLE PARK PHASE 2

2810 PONCE DE LEON :: CORAL GABLES, FL 33134

LANDSCAPE ARCHITECT:



420 LINCOLN RD S. 600 | MIAMI BEACH FL 33139

T. 786.246.4857 | F. 786.768.2537 HTTP://WWW.URBANROBOT.NET URBAN ROBOT LLC





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APPLICABLE CODES:

FLORIDA DEPARTMENT OF TRANSPORTATION THE AMERICAN ASSOCIATION OF STATE HIGHWAY AND TRANSPORTATION OFFICIALS - THE GREEN BOOK CITY OF CORAL GABLES ZONING CODE ALL OTHER APPLICABLE LOCAL, STATE AND FEDERAL REGULATIONS

SHEET#	DRAWING NAME	SHEET #	DRAWING NAME
L-000	COVER PAGE	L-204.1	PLANTING PALETTE
L-001	1/4 MILE CONTEXT PLAN	L-204.2	PLANTING PALETTE
L-002	CONTEXT ANALYSIS	L-204.3	PLANTING PALETTE
L-003	GENERAL LANDSCAPE NOTES	L-204.4	PLANTING PALETTE
L-004	TREE PROTECTION AND REPLACEMENT PLAN	L-301	PERGOLA DETAILS
L-005	TREE PROTECTION AND REPLACEMENT SCHEDULE	L-400	LIGHTING PLAN
L-006	PROPERTY APPRAISAL	L-401	LIGHTING SCHEDULE AND SPECIFICATIONS
L-007	NEIGHBORHOOD CONTEXT PHOTOGRAPHS	L-500	HARDSCAPE MATERIALS BOARD
L-008	SITE PHOTOGRAPHS	L-500.1	HARDSCAPE MATERIALS BOARD
L-009	SITE PHOTOGRAPHS	L-501	SOUTH LAWN BENCH
L-100	HARDSCAPE PLAN	L-502	STANDARD BENCHES
L-101	HARDSCAPE PLAN - SOUTH HALF	S-001	SITE SURVEY - SOUTH HALF
L-102	HARDSCAPE PLAN - NORTH HALF	S-002	SITE SURVEY - NORTH HALF
L-200	CANOPY PLANTING RENDERED PLAN		
L-201	CANOPY PLANTING PLAN		
L-202	UNDERSTORY PLANTING PLAN		

SCOPE OF WORK AND CLASSIFICATION:

- STREETSCAPE AND ROADWAYS

PLANTING SCHEDULE


- PUBLIC PARK


REVISIONS									
No.	DESCRIPTION	DATE							
CLIDMIT	TAL. CITY OF CODAL CADLES DOADD OF ADCLUTECTS DUASE 3, DADIC								

SUBMITTAL: CITY OF CORAL GABLES - BOARD OF ARCHITECTS PHASE 2: PARK

DATE: OCTOBER 7, 2021

COVER PAGE

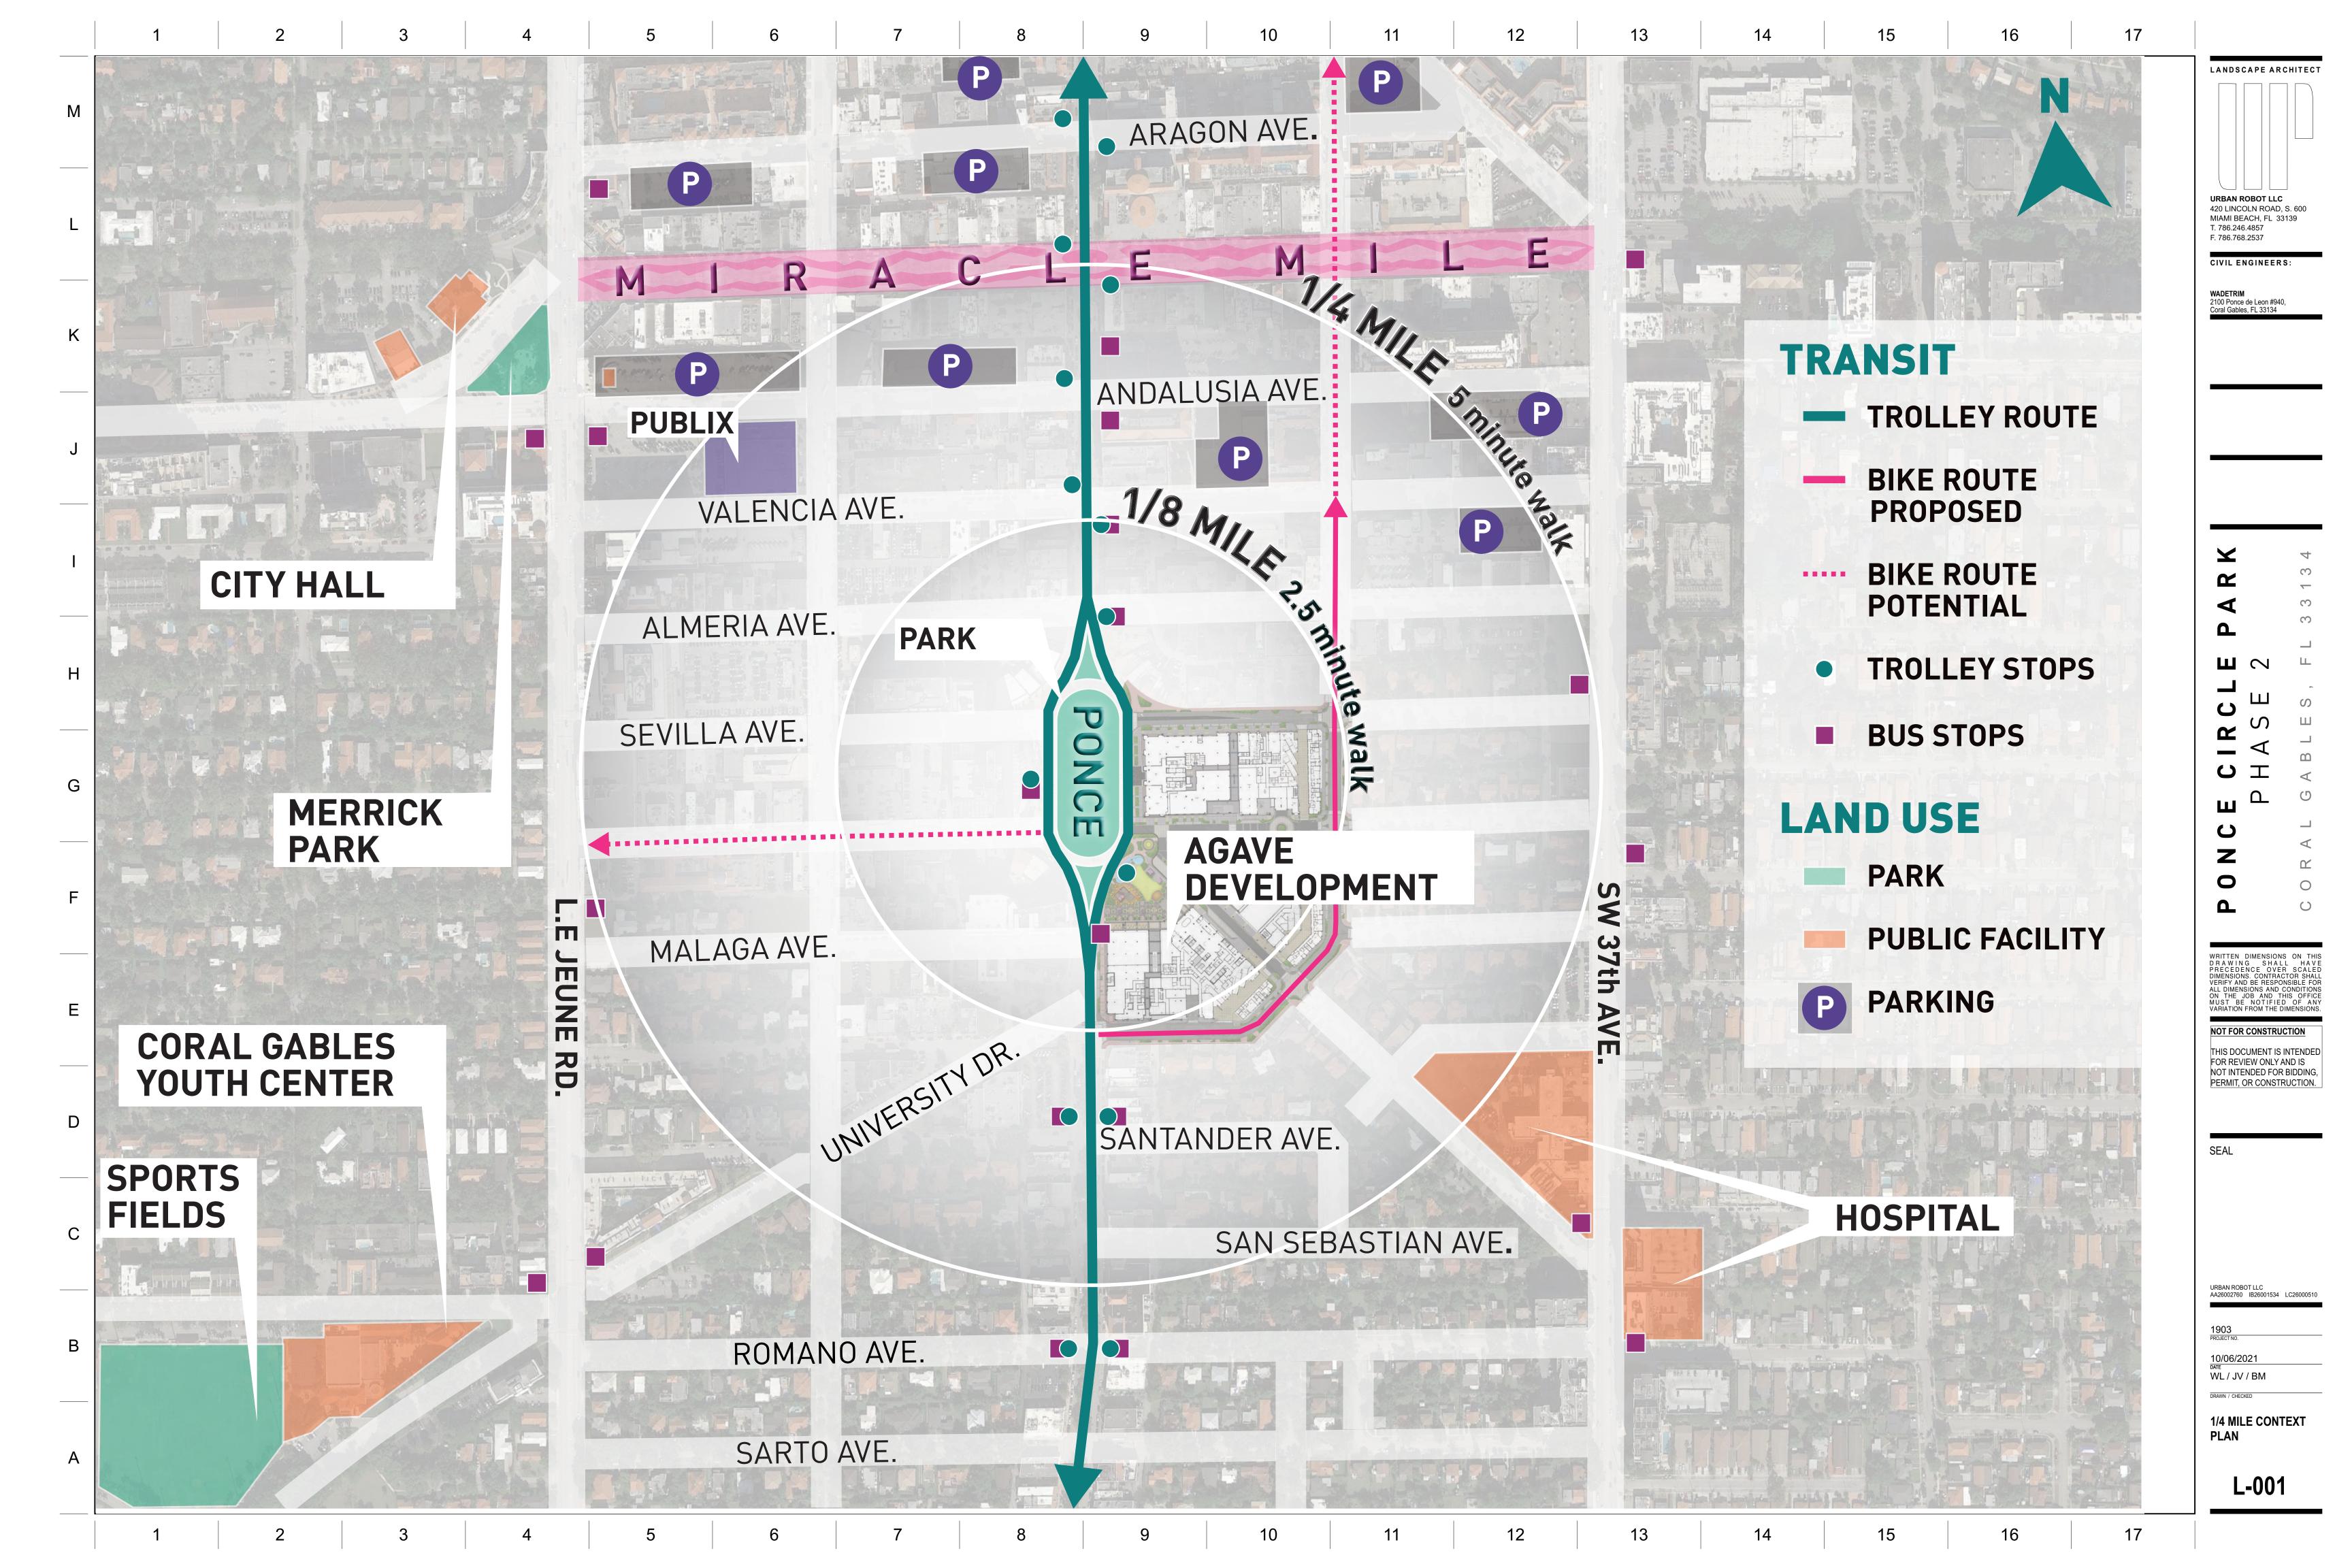

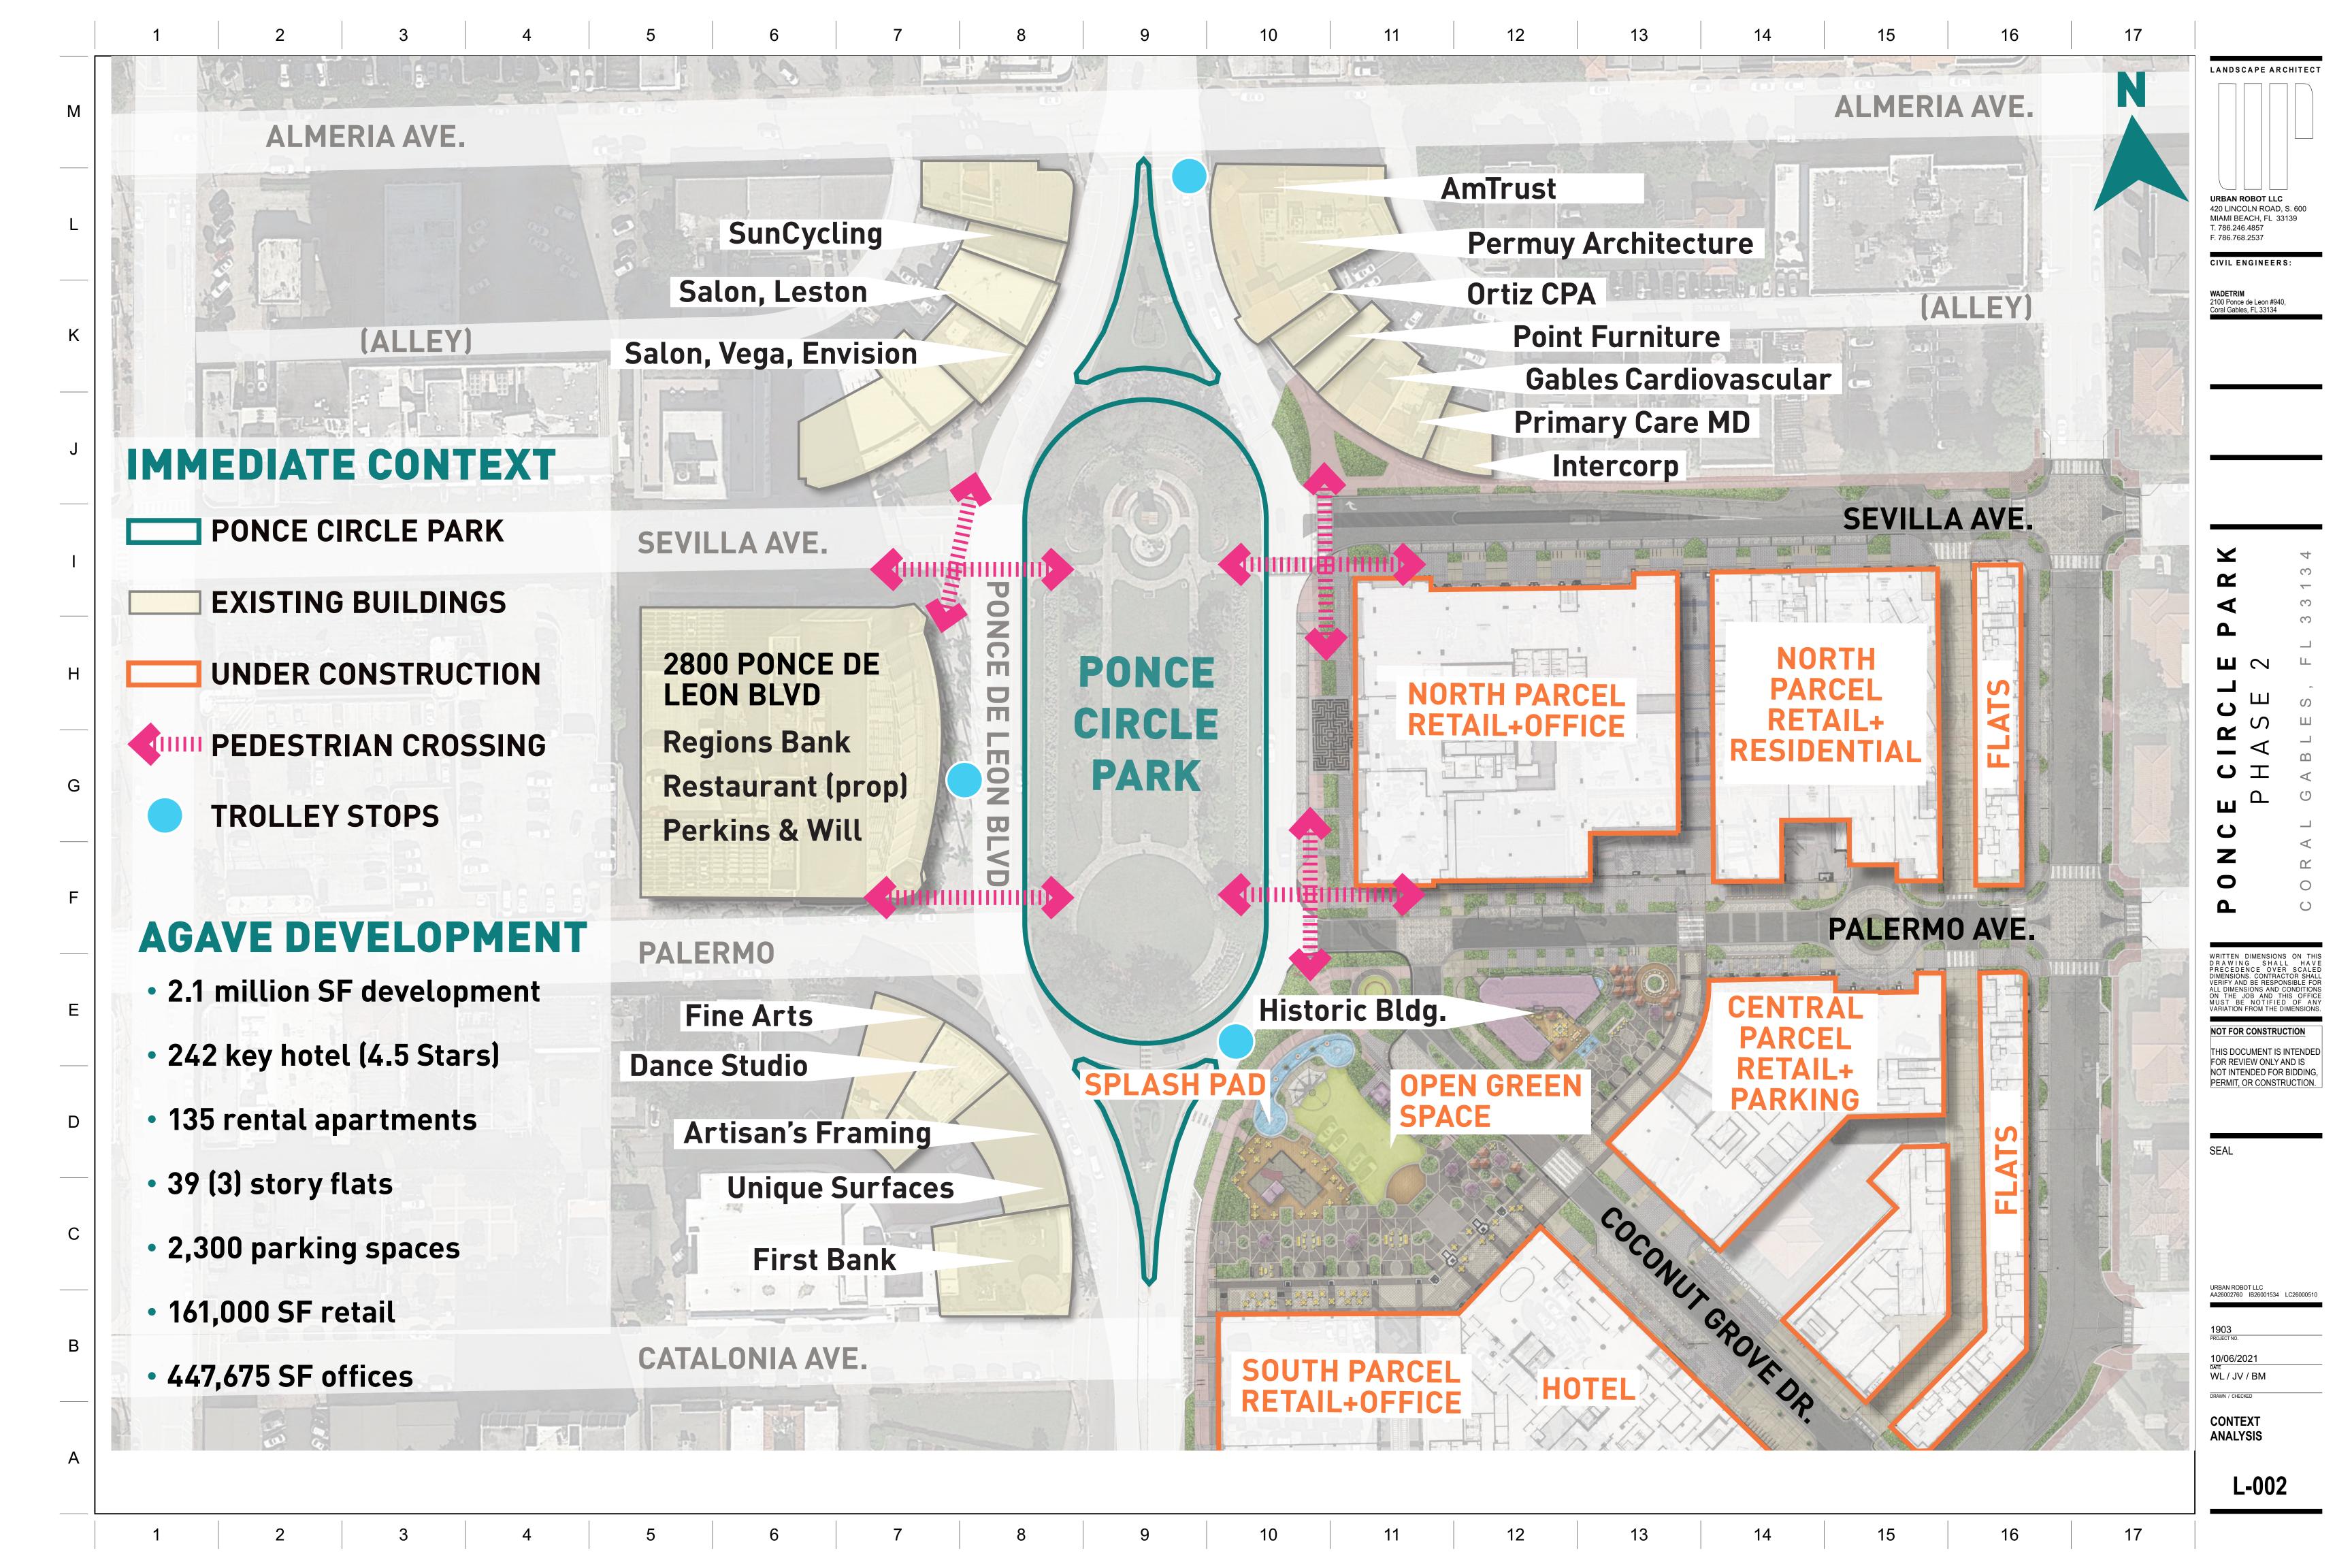

32. All dimensions are square (parallel or perpendicular) unless otherwise noted. The contractor shall notify the owner/owner's representative immediately in the event of any discrepancies found in the documents and/or field, or of conditions uncovered in the work which are not reflected in the plans.

33. The contractor shall take every precaution to prevent damage to all utilities (both above and below ground) within the project area. Damage to any utilities as a result of actions by the contractor shall be restored by the contractor, at his expense, to conditions equal to or better than before the damage was done.

34. Any areas disturbed by equipment, material storage, demolition and/or installation procedures are to be restored to original (or better) condition by contractor before completion of project and are subject to approval by owner's representative. All existing grassed areas not adequately protected and therefore damaged during construction, shall be replaced by the contractor at no additional cost to the owner.

35. The contractor is responsible for keeping the site clean of miscellaneous debris throughout the construction period. All waste material is to be disposed of immediately to an off-site location, unless otherwise indicated on the plans.

36. Contractor is responsible for general clean-out of all drainage basins (new and existing), manholes and/or other drainage features which have accumulated sediment as a result of construction activities.

37. The contractor shall provide all equipment, labor, materials and related work necessary for the prevention and control of dust resulting from operations in the performance of work of this contract. All cost in connection there with shall be considered to be included in the various unit and/or lump sum prices bid for the various item as listed in the bid.

38. Contractor shall submit shop drawings and/or samples of all materials to landscape architect as required within the detail drawings and notes.

39. All installation shall comply with Miami-Dade County ordinances as stated in Section 47-21.9. All discrepancies shall be notified to Landscape Architect



DRAWING SHALL HAVE
PRECEDENCE OVER SCALED
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LANDSCAPE ARCHITECT

URBAN ROBOT LLC

CIVIL ENGINEERS:

2100 Ponce de Leon #940, Coral Gables, FL 33134

T. 786.246.4857 F. 786.768.2537

420 LINCOLN ROAD, S. 600 MIAMI BEACH, FL 33139

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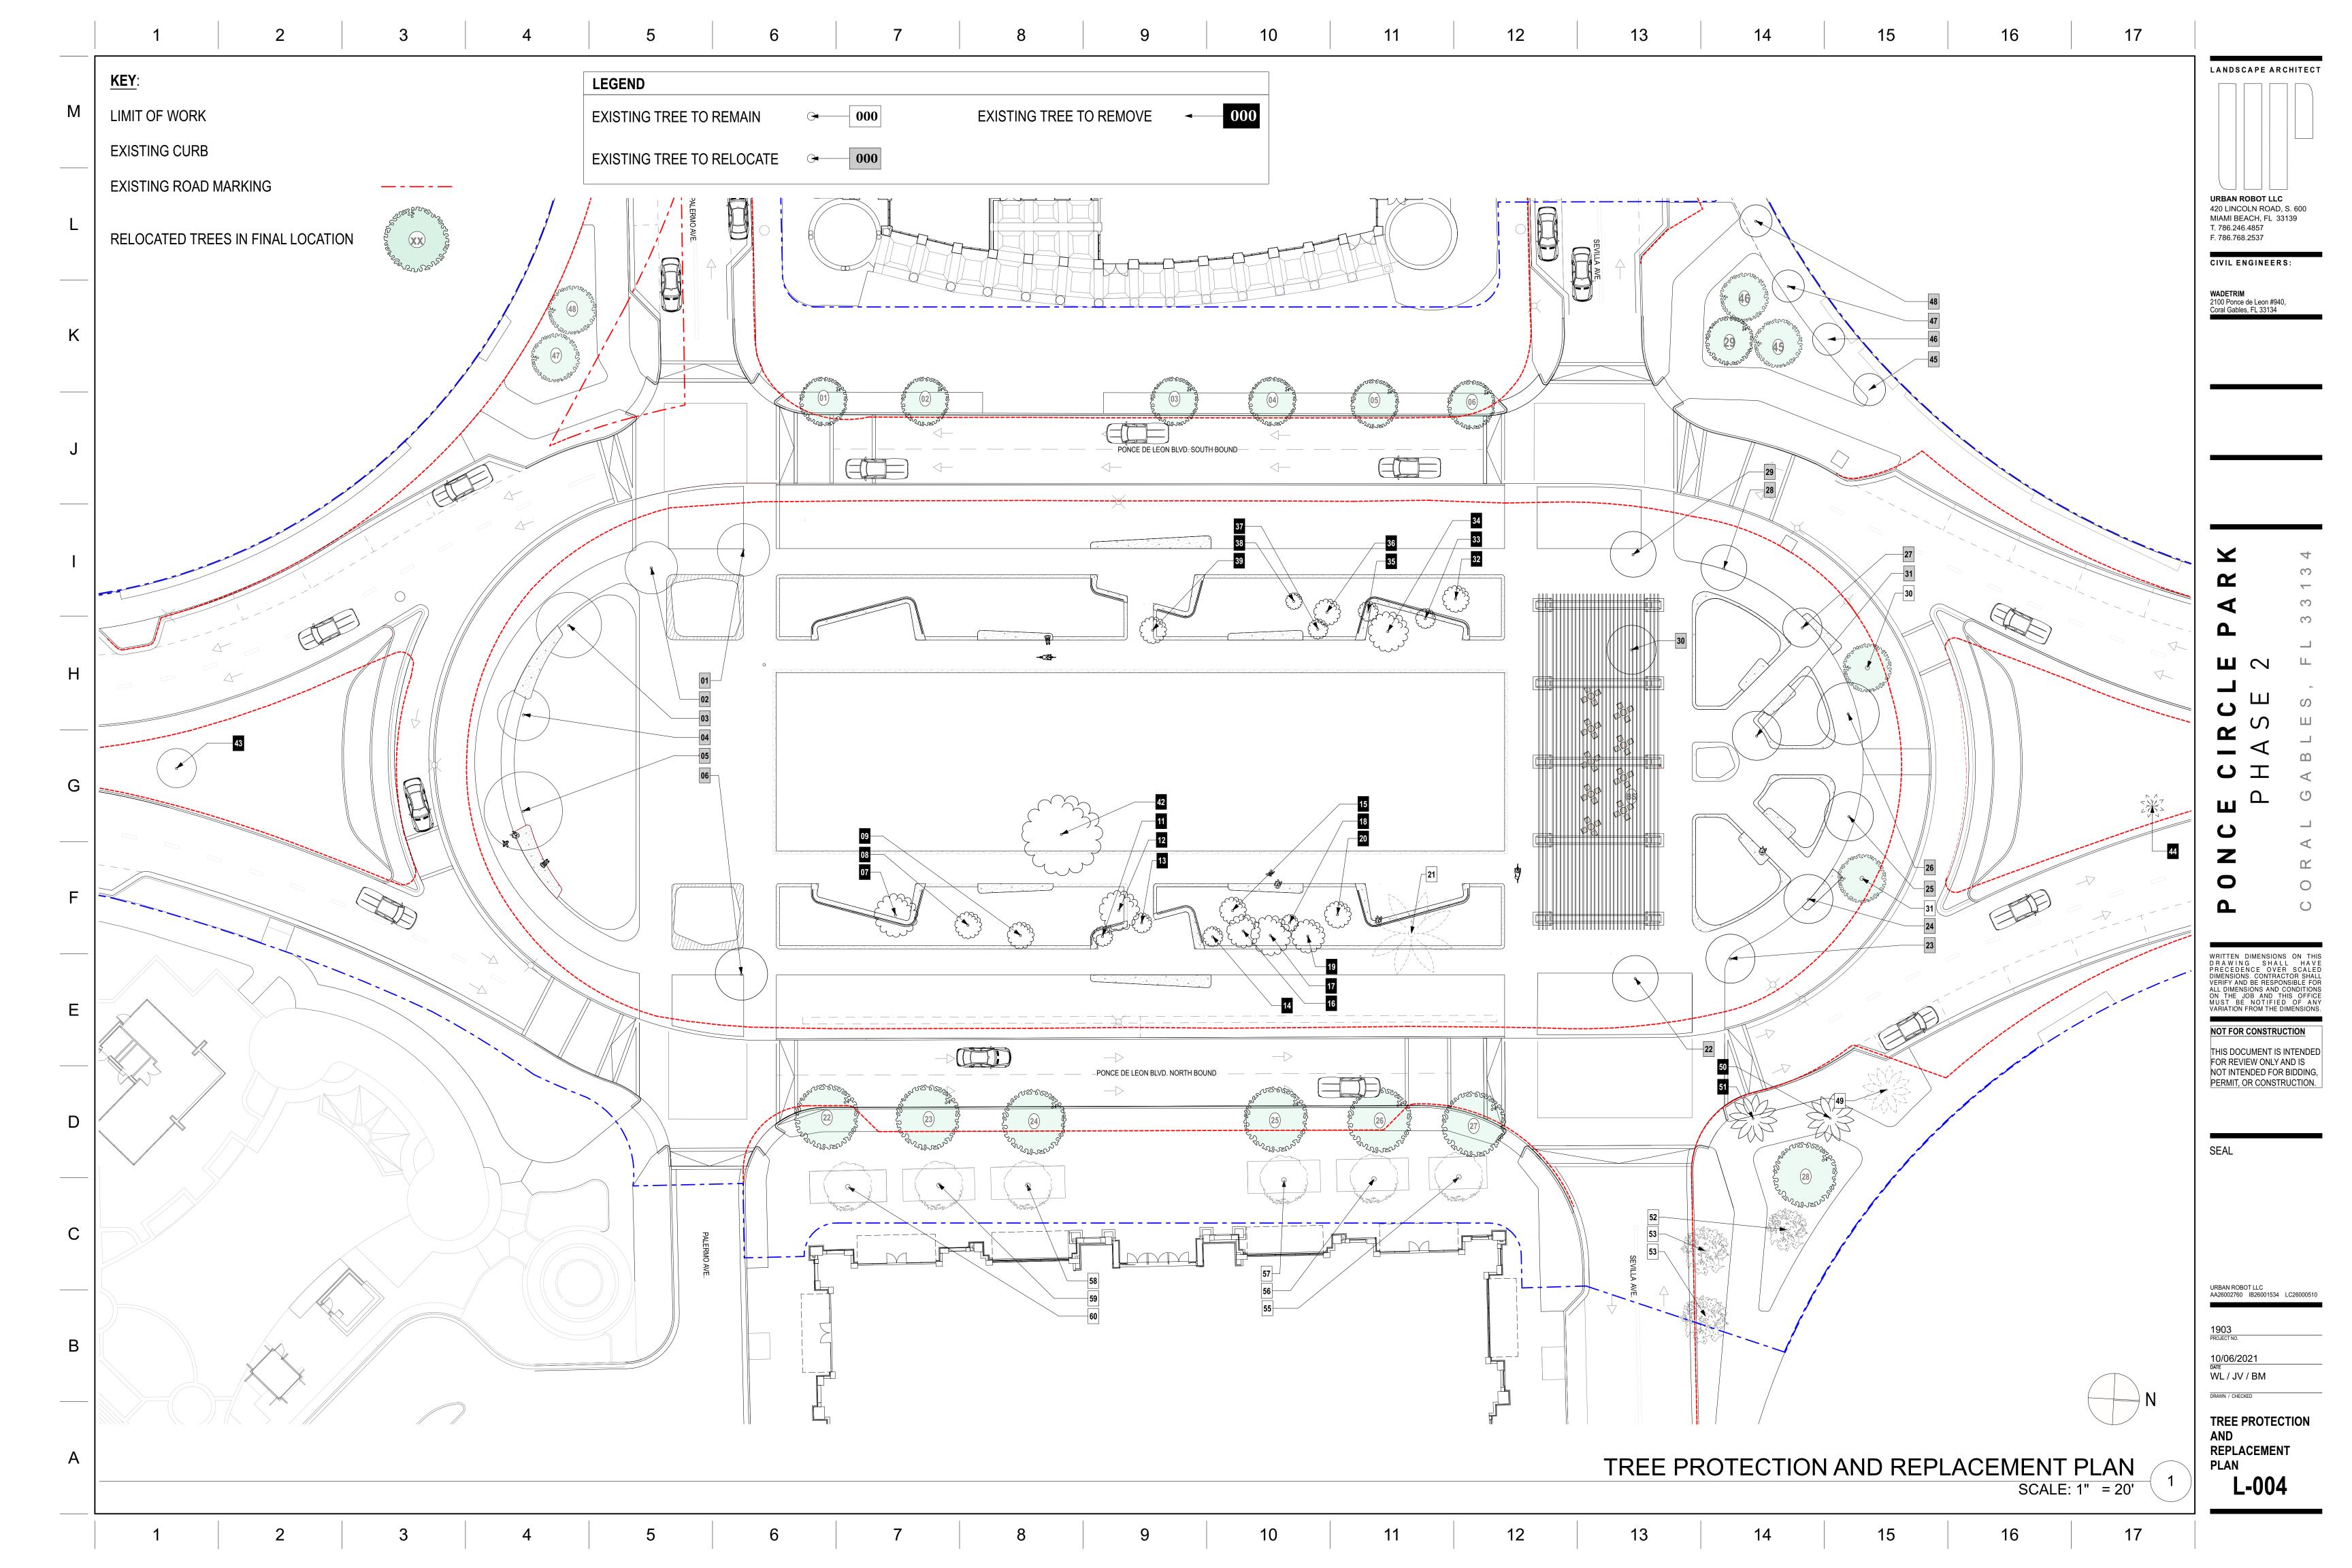
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AA26002760 IB26001534 LC2600051

10/06/2021 WL/JV/BM

DRAWN / CHECKED

GENERAL LANDSCAPE NOTES



Symbol	ID	Botanical Name	Tree Dispo				Protect	Remove	Relocate	Remarks	
	01	Quercus virginiana	Live Oak Tree	12"	18'	16'	. 101661	INGILIOVE	X	r.Gilial N3	-
	02	Quercus virginiana	Live Oak Tree	12"	18'	16'			X		
	03	Quercus virginiana	Live Oak Tree	19"	24'	20'			X		
	04	Quercus virginiana	Live Oak Tree	12"	18'	16'			X		
	05	Quercus virginiana	Live Oak Tree	32"	30'	24'					
	06			18"	18'	16'			X		
		Quercus virginiana	Live Oak Tree					.,	X		
- C	07	Pinus elliottii	Slash Pine	7"	15'	13'		Х			
	08	Pinus elliottii	Slash Pine	9"	18'	8'		Х			
\(\xi_{\text{\ti}\text{\ti}\tint{\text{\text{\text{\text{\text{\text{\text{\text{\text{\ti}\ti}\text{\text{\text{\text{\text{\text{\text{\text{\tet{\te	09	Pinus elliottii	Slash Pine	8'	16'	8'		X			
	10	Pinus elliottii	Slash Pine					X		Removed	_
\(\text{\tint{\text{\tint{\text{\tin\text{\texi}\titt{\text{\text{\text{\text{\text{\texi}\text{\text{\texit{\text{\texi}\titt{\text{\texi}\text{\text{\text{\text{\text{\tex{	11	Pinus elliottii	Slash Pine	6"	18'	6'		Х			_
	12	Pinus elliottii	Slash Pine	8"	20'	12'		X			
	13	Pinus elliottii	Slash Pine	5"	18'	6'		Х			
(4)	14	Pinus elliottii	Slash Pine	8"	18'	6'		Х			
£(4)	15	Pinus elliottii	Slash Pine	7"	18'	8'		Х			
	16	Pinus elliottii	Slash Pine	9"	20'	10'		X			
	17	Pinus elliottii	Slash Pine	3"	18'	12'		Х			
(°)	18	Pinus elliottii	Slash Pine	6"	20'	5'		х			
£(,,,)	19	Pinus elliottii	Slash Pine	9"	20'	10'		Х			
£(,,)	20	Pinus elliottii	Slash Pine	6"	18'	8'		Х			
	21	Livistona chinensis	Chinese Fan Palm	32"	14'	18'	х			3 Trunks	
	22	Quercus virginiana	Live Oak Tree	12"	16'	14'			Х		_
0	23	Quercus virginiana	Live Oak Tree	20"	20'	15'			Х		
0	24	Quercus virginiana	Live Oak Tree	16"	20'	15'			X		_
0	25	Quercus virginiana	Live Oak Tree	18"	20'	15'			Х		_
	26	Quercus virginiana	Live Oak Tree	14"	18'	19'			X		
0	27	Quercus virginiana	Live Oak Tree	13"	16'	12'			X		
0	28	Quercus virginiana	Live Oak Tree	16"	18'	14'			X		_
	29	Quercus virginiana	Live Oak Tree	13"	10'	14'			X		
0	30	Tabebuia caraiba	Yellow Trumpet Tree	14"	20'	15'	X				
	31	Tabebuia caraiba	Yellow Trumpet Tree	20"	20'	15'	X				
£(.)	32	Pinus elliottii	Slash Pine	8"	15'	8'		X			
\(\frac{\fir}}}}}}}{\frac}\frac{\frac{\frac{\frac{\frac}}}}}}}{\firan{\frac{\frac{\frac{\frac{\frac{\frac}}}}}}{\	33	Pinus elliottii	Slash Pine	5"	10'	6'		X			
(4,00)	34	Pinus elliottii	Slash Pine	10"	20'	12'		X			
		Pinus elliottii	Slash Pine		 16'	6'					
()	35			7"				X			
	36	Pinus elliottii	Slash Pine	7"	18'	8'		X			
- Z	37	Pinus elliottii	Slash Pine	5"	16'	6'		Х			
\(\frac{\xi_0}{\chi_0}\)	38	Pinus elliottii	Slash Pine	3"	14'	5'		Х			
\(\xi_{\text{\tin}}\text{\tin}\text{\tett{\text{\tett{\text{\text{\text{\text{\text{\text{\text{\text{\text{\text{\ti}\}\text{\text{\text{\text{\text{\text{\text{\text{\tex{\tex	39	Pinus elliottii	Slash Pine	7"	18'	8'		X			
	40	Pinus elliottii	Slash Pine							Removed	
	41	Pinus elliottii	Slash Pine							Removed	_
\(\frac{\tau_{\tau_{\tau}}}{\tau_{\tau_{\tau}}}\)	42	Pinus elliottii	Slash Pine	16"	30'	24'	X				


	Tree Disposetion Schedule												
Symbol	ID	Botanical Name	Common Name	DBH	Height	Spread	Protect	Remove	Relocate	Remarks			
0	43	Conocarpus erectus var. sericeus	Silver Buttonwood	18"	10'	12'		Х					
~ \ \ \ \ \ \ \ \ \ \ \ \ \ \ \ \ \ \ \	44	Ptychosperma elegans	Solitaire Palm	4"	30'	4'		X					
0	45	Quercus virginiana	Live Oak Tree	4.5"	13'	7'	х	х					
0	46	Quercus virginiana	Live Oak Tree	4.5"	13'	7'	х						
0	47	Quercus virginiana	Live Oak Tree	4.5"	13'	7'	х						
0	48	Quercus virginiana	Live Oak Tree	4.5"	13'	7'	х						
	49	Phoenix canariensis	Canary Island Date Palm	24"	14'	12'	х						
	50	Phoenix canariensis	Canary Island Date Palm	24"	14'	12'	х						
	51	Phoenix canariensis	Canary Island Date Palm	24"	14'	12'	х						
	52	Caesalpinia granadillo	Bridalveil	3"	8'	8'		Х					
	53	Caesalpinia granadillo	Bridalveil	3"	8'	8'	х						
0	55	Quercus virginiana 'Highrise	Southern Live Oak 'Highrise'	4"	16'	8'	х						
0	56	Quercus virginiana 'Highrise	Southern Live Oak 'Highrise'	4"	16'	8'	х						
0	57	Quercus virginiana 'Highrise	Southern Live Oak 'Highrise'	4"	16'	8'	х						
0	58	Quercus virginiana 'Highrise	Southern Live Oak 'Highrise'	4"	16'	8'	х						
0	59	Quercus virginiana 'Highrise	Southern Live Oak 'Highrise'	4"	16'	8'	х						
0	60	Quercus virginiana 'Highrise	Southern Live Oak 'Highrise'	4"	16'	8'	Х						


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TREE ROOT PROTECTION ZONE
TO BE POSTED ON TREE PROTECTION FENCE - PROTECTED WITH
PLASTIC COVER

NO EXCAVATION

15

16

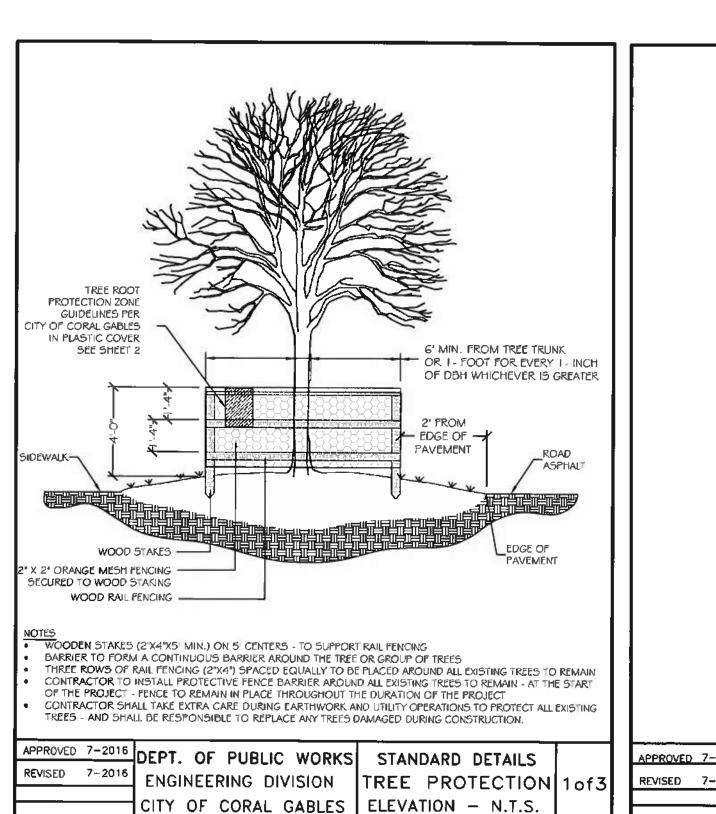17

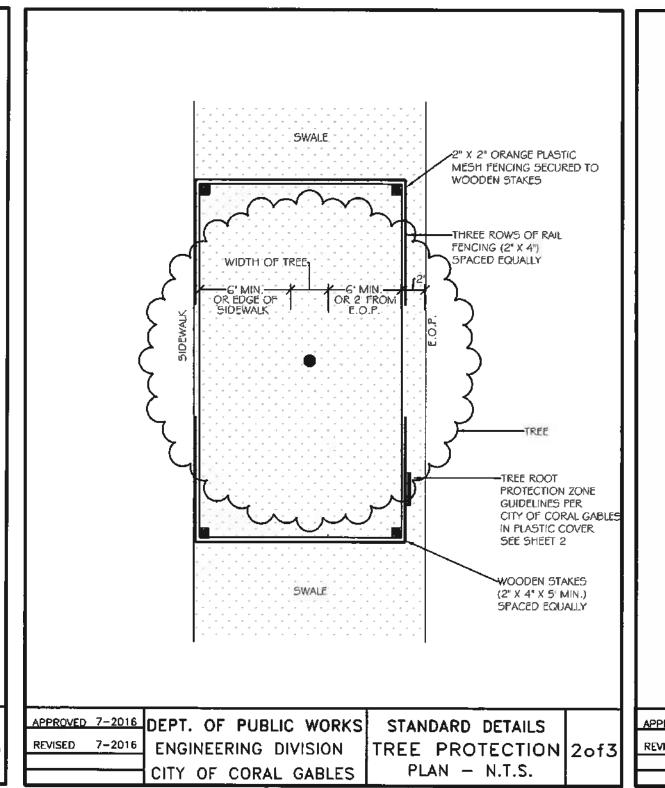LANDSCAPE ARCHITECT

URBAN ROBOT LLC 420 LINCOLN ROAD, S. 600 MIAMI BEACH, FL 33139

CIVIL ENGINEERS:

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T. 786.246.4857 F. 786.768.2537

WADETRIM

- NO STORAGE OF CONSTRUCTION
- BUILDING MATERIALS OR TRAILERS
- NO SPILLAGE OR DUMPING OF FUEL
 OR OTHER CHEMICALS OR LIQUIDS
- NO GRADE CHANGES
- NO EQUIPMENT OPERATION
- NO ENTRANCE INTO ENCLOSURE
- NO TEMPORARY REMOVAL OF ENCLOSURE
- CONTACT PERSON RESPONSIBLE
 FOR SITE INFORMATION

APPROVED 7-2016 DEPT. OF PUBLIC WORKS STANDARD DETAILS
REVISED 7-2016 ENGINEERING DIVISION TREE PROTECTION 3of3
CITY OF CORAL GABLES GUIDELINES TO POST

TREE PROTECTION DETAILS

NOT TO SCALE

1903 PROJECT NO.

URBAN ROBOT LLC AA26002760 IB26001534 LC26000510

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10/06/2021 DATE WL / JV / BM

DRAWN / CHECKED

TREE PROTECTION AND REPLACEMENT SCHEDULE L-005

1 2 3 4 5 6 7 8 9 10 11 12 13 14 15 16 *'*



LANDSCAPE ARCHITECT

URBAN ROBOT LLC 420 LINCOLN ROAD, S. 600 MIAMI BEACH, FL 33139 T. 786.246.4857 F. 786.768.2537

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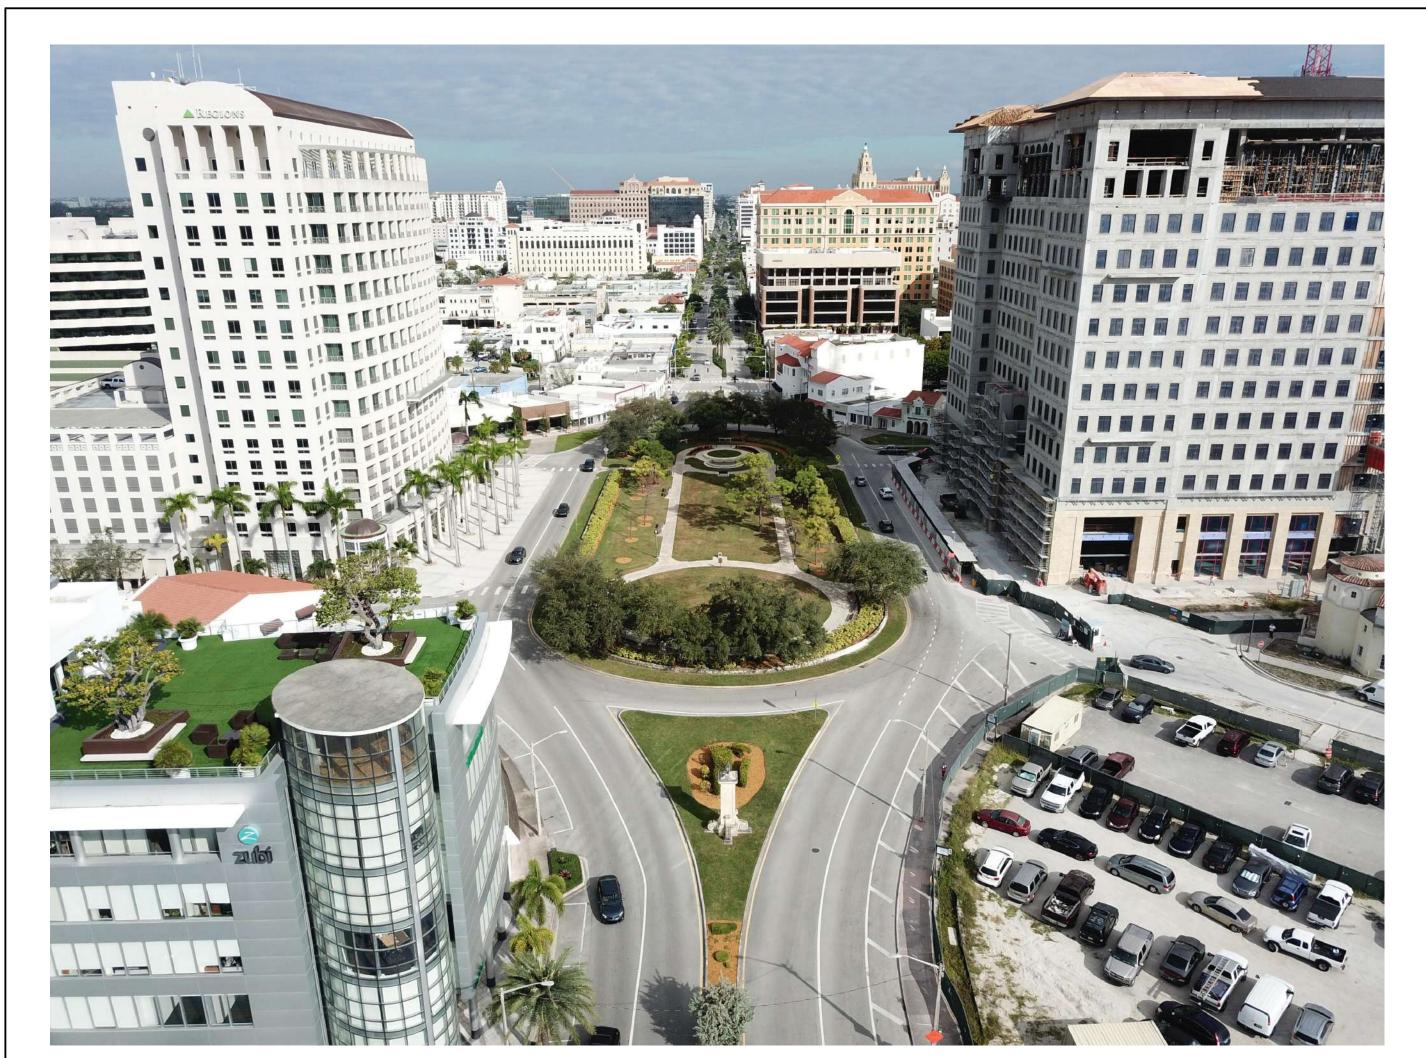
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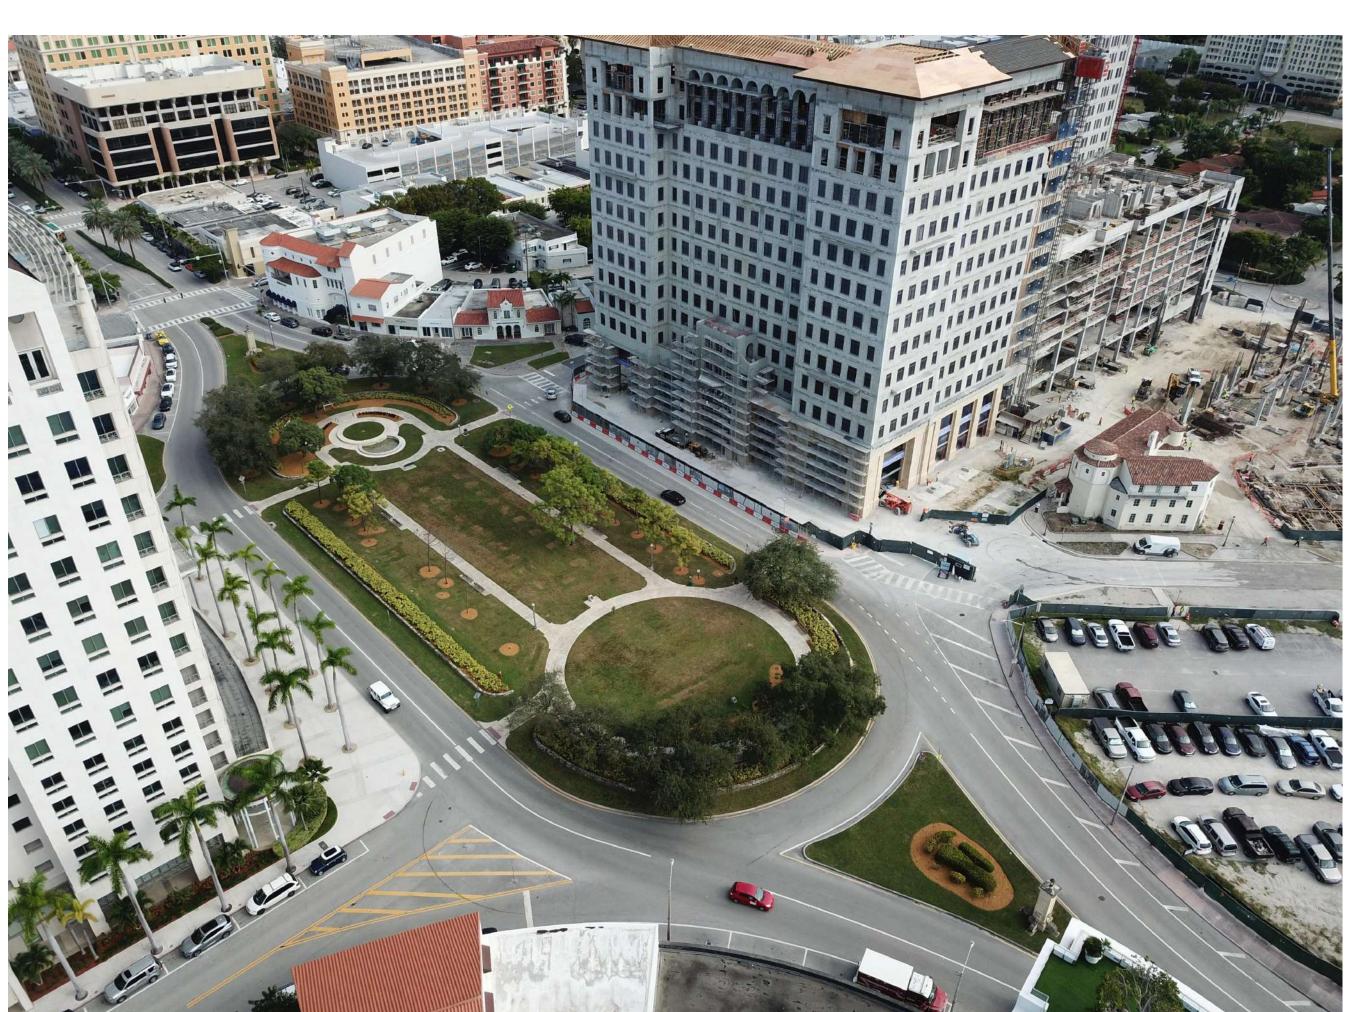
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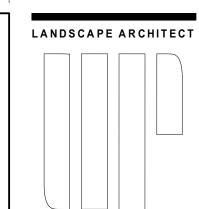
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PROPERTY APPRAISAL









URBAN ROBOT LLC 420 LINCOLN ROAD, S. 600 MIAMI BEACH, FL 33139 T. 786.246.4857 F. 786.768.2537

F. 786.768.2537 CIVIL ENGINEERS:

WADETRIM 2100 Ponce de Leon #940, Coral Gables, FL 33134

PONCE CIRCLE PARK

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SEAL

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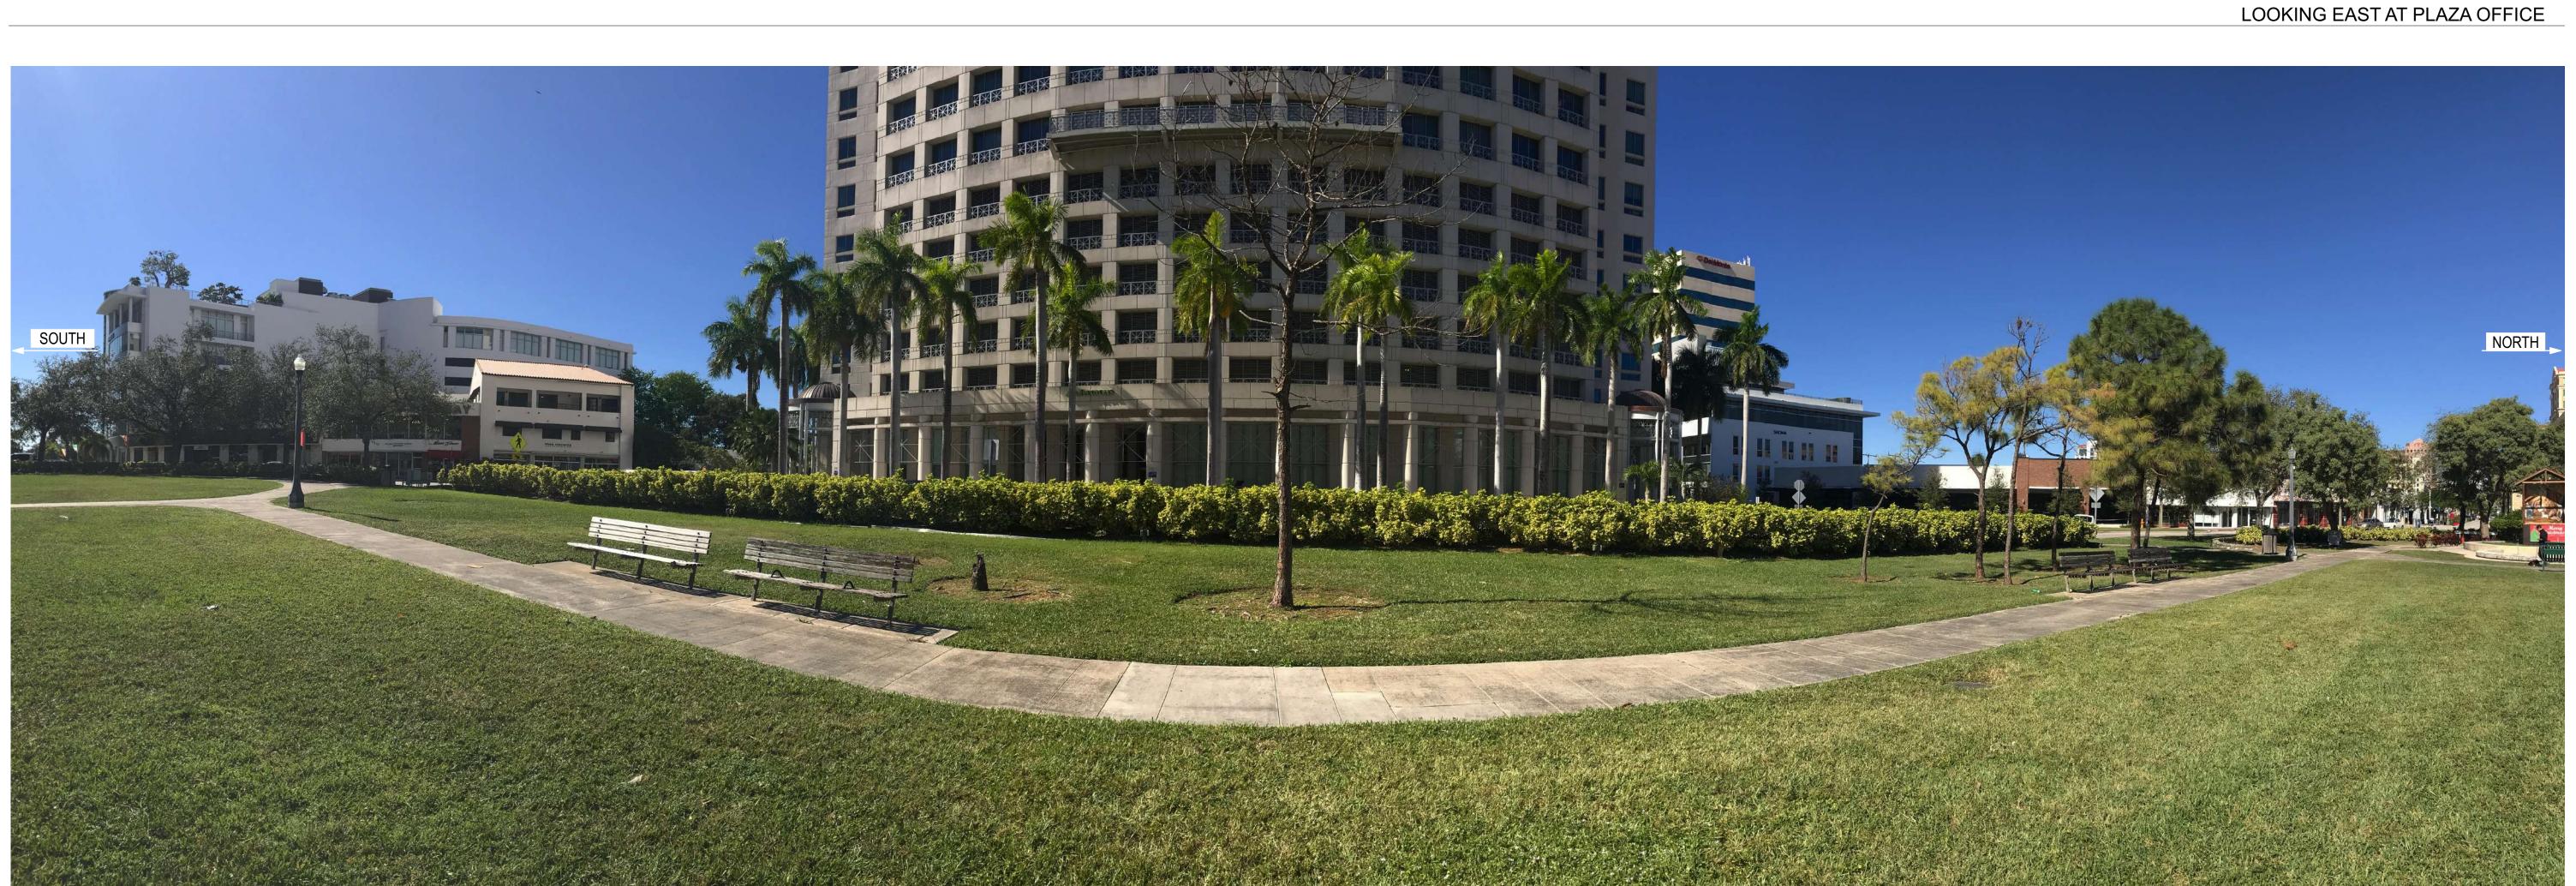
10/06/2021 DATE WL / JV / BM

NEIGHBORHOOD CONTEXT PHOTOGRAPHS

L-007

1 2 3 4 5 6 7 8 9 10 11 12 13 14 15 16





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LOOKING WEST AT 2800 BUILDING

LANDSCAPE ARCHITECT

URBAN ROBOT LLC
420 LINCOLN ROAD, S. 600
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T. 786.246.4857
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CIVIL ENGINEERS:

WADETRIM 2100 Ponce de Leon #940, Coral Gables, FL 33134

PHASE 2

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SITE PHOTOGRAPHS

L-008

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LOOKING SOUTH

LANDSCAPE ARCHITECT

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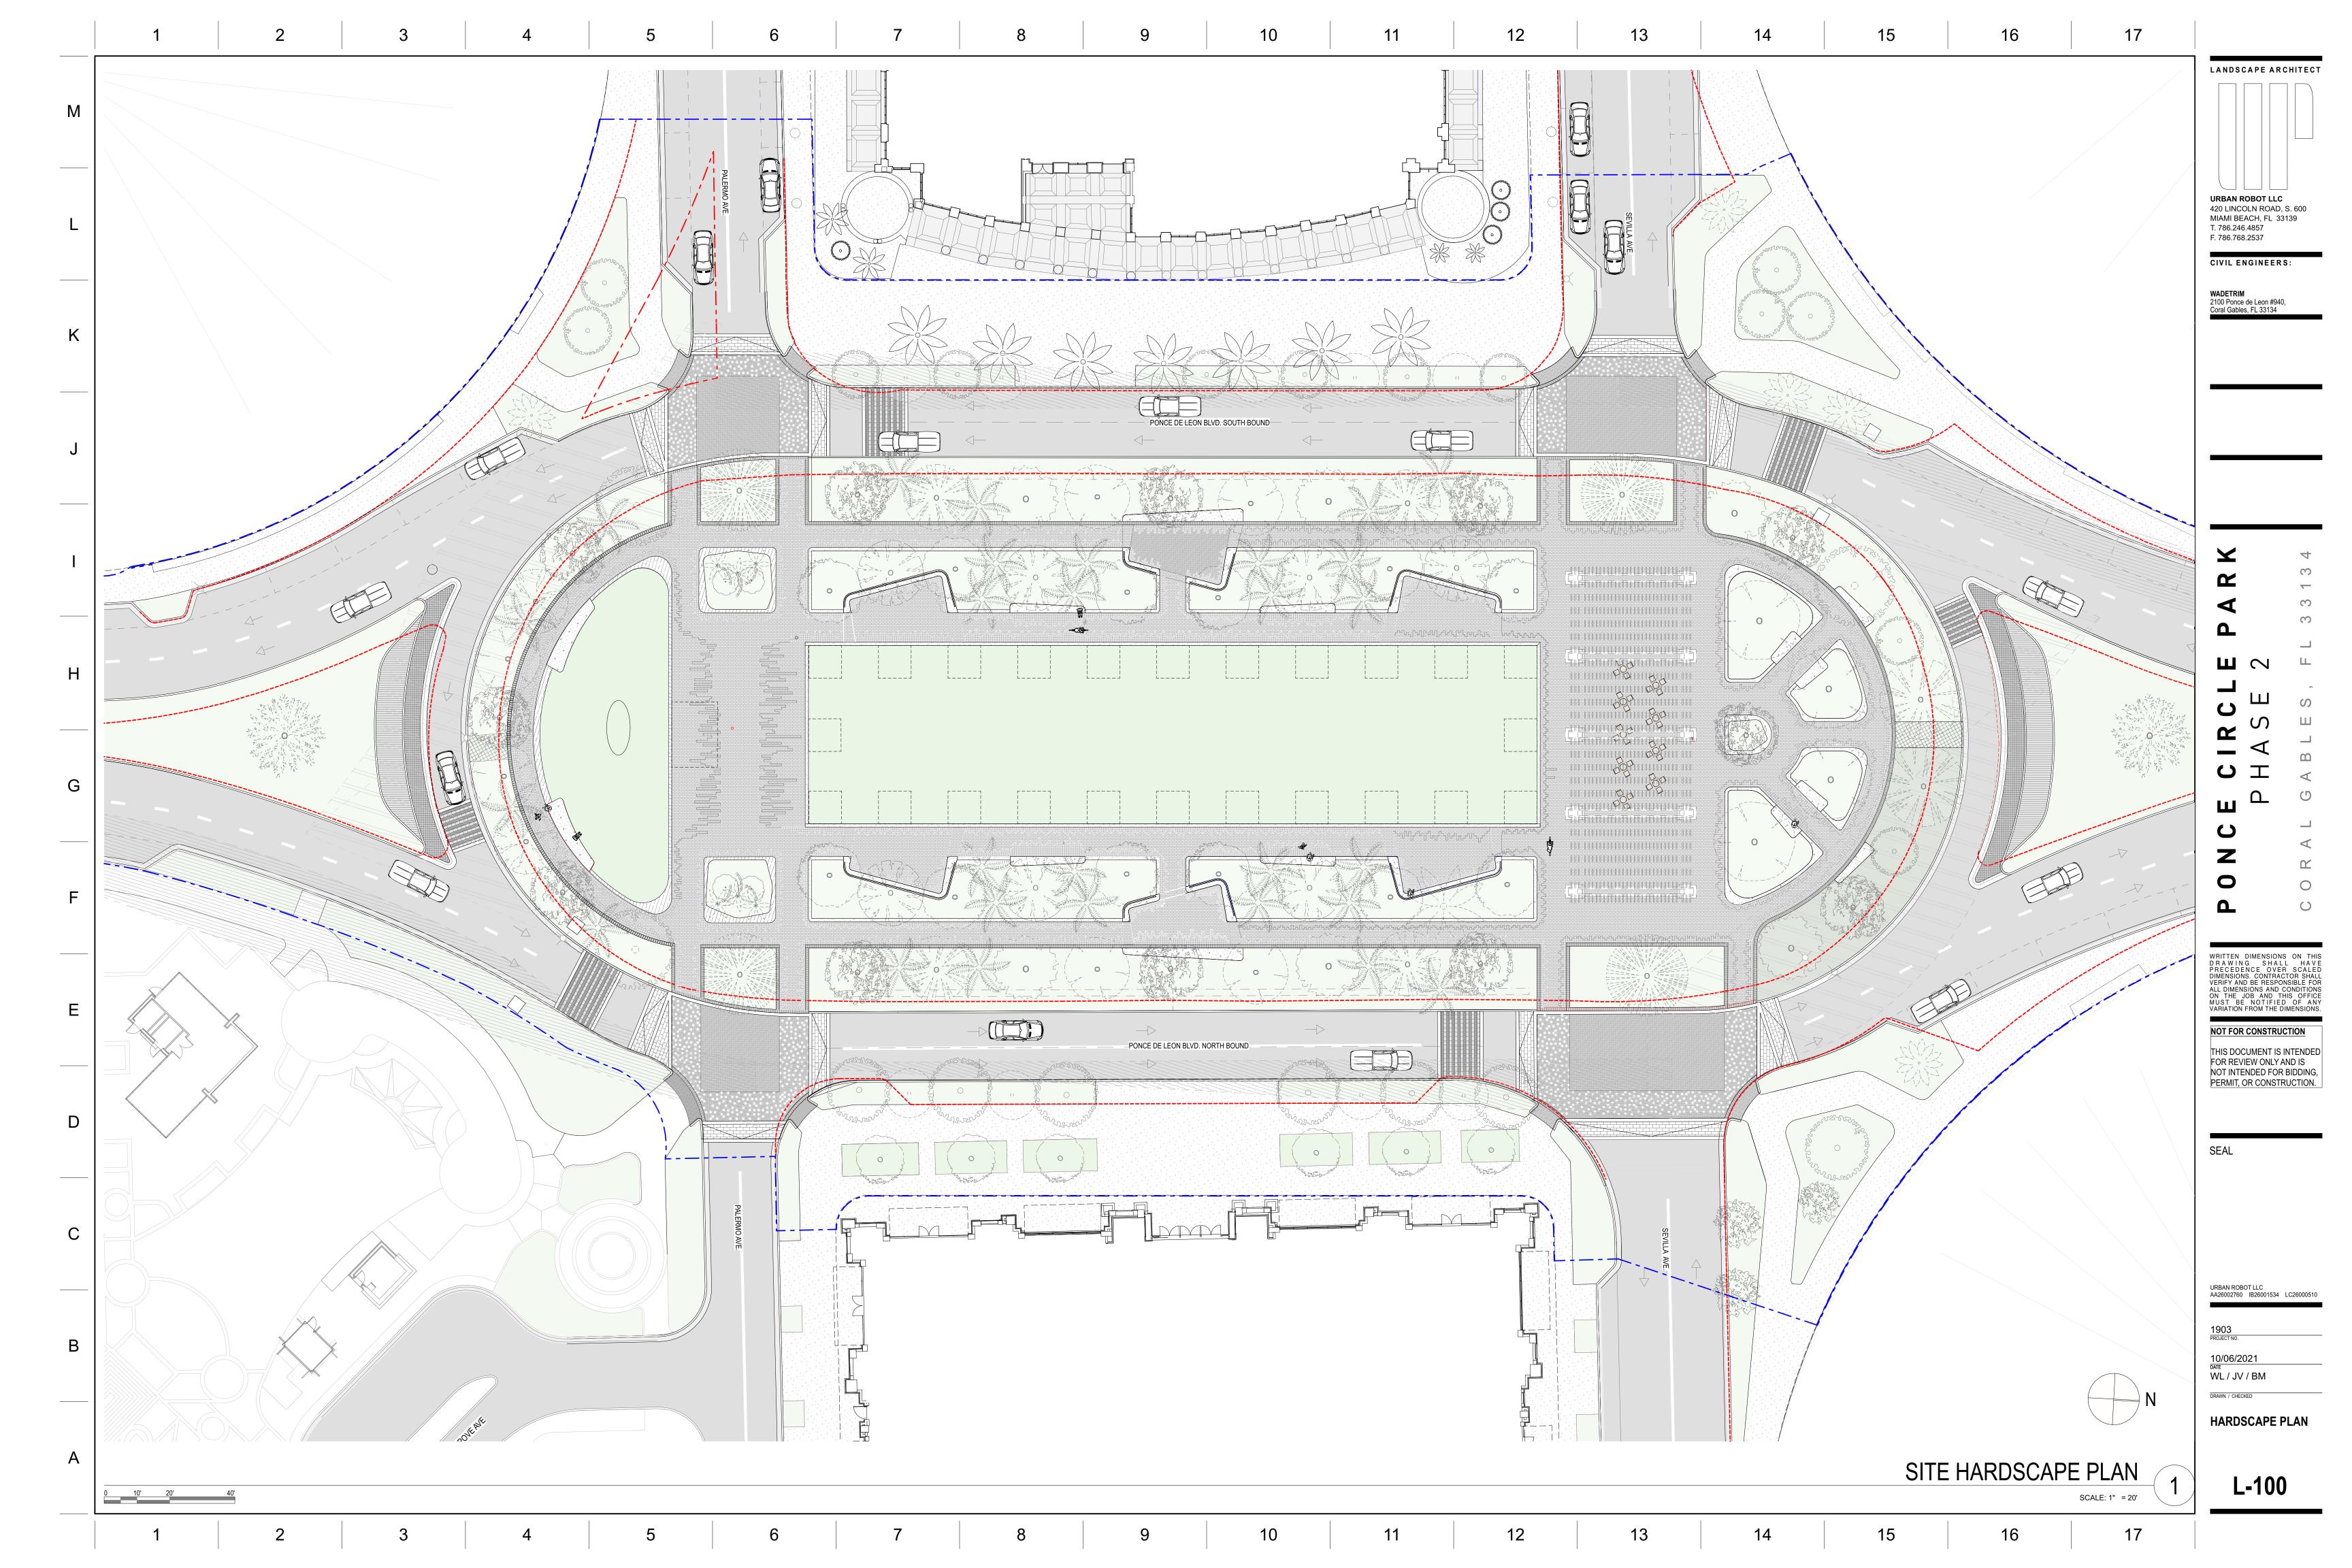
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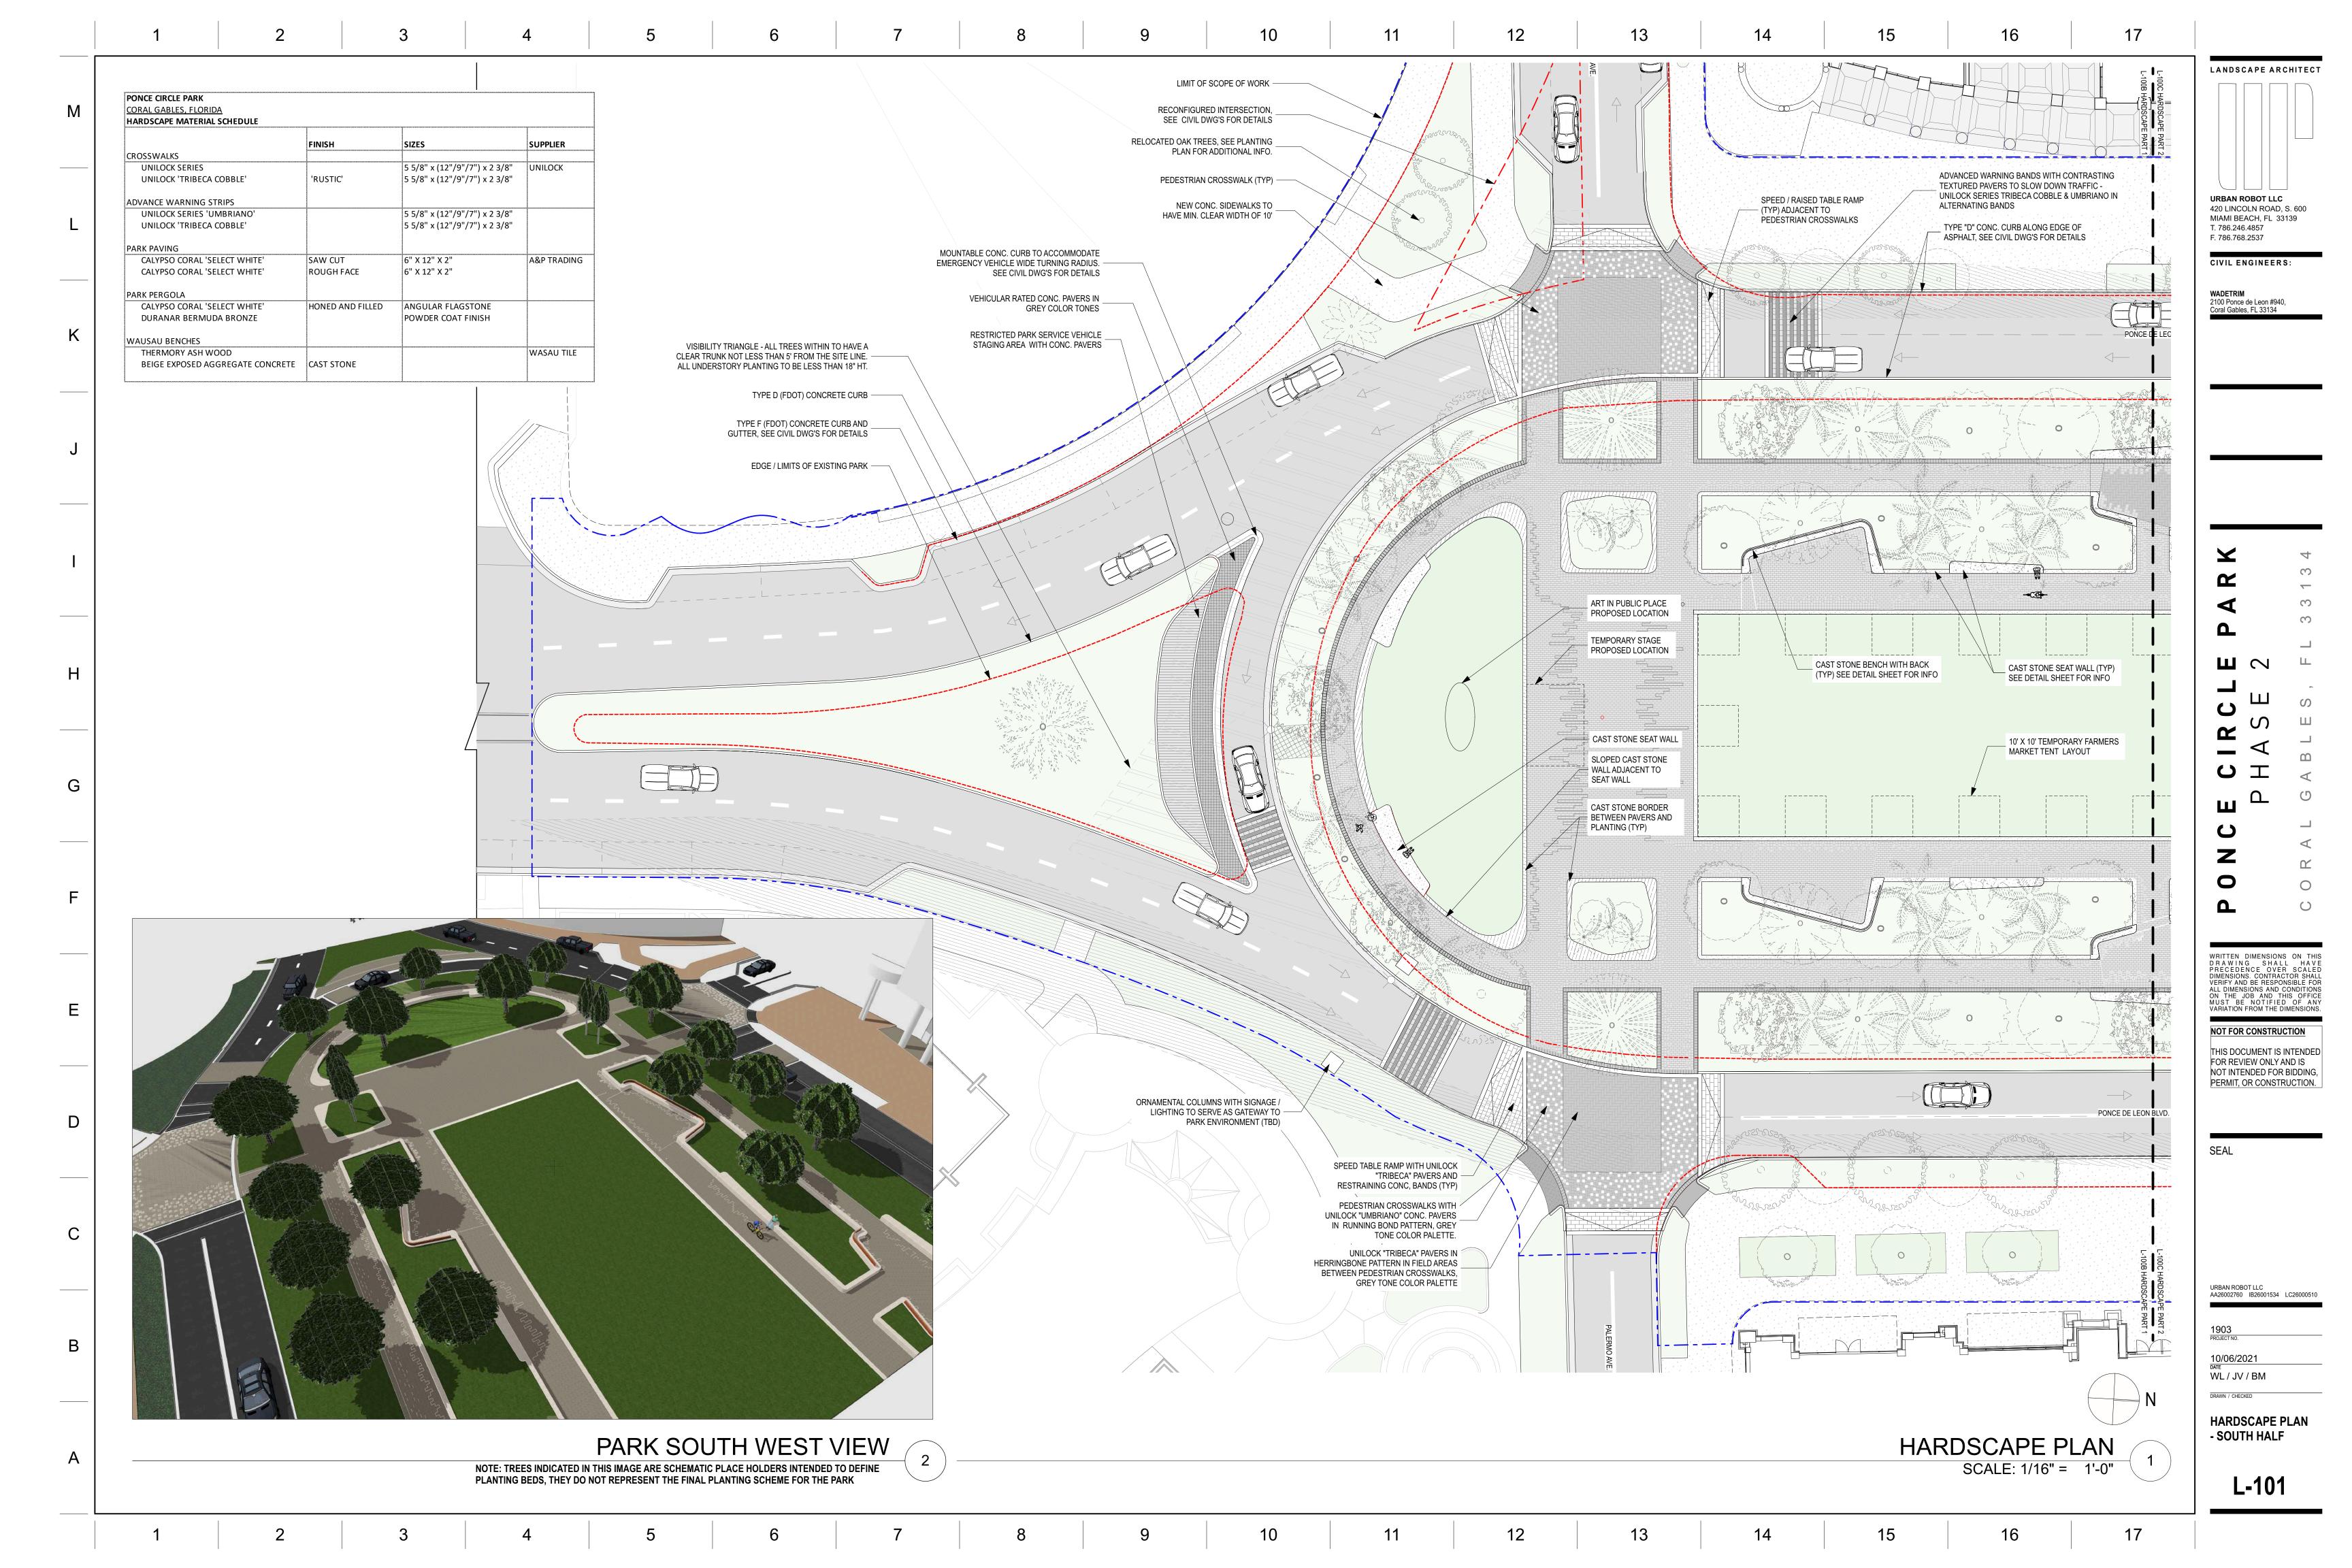
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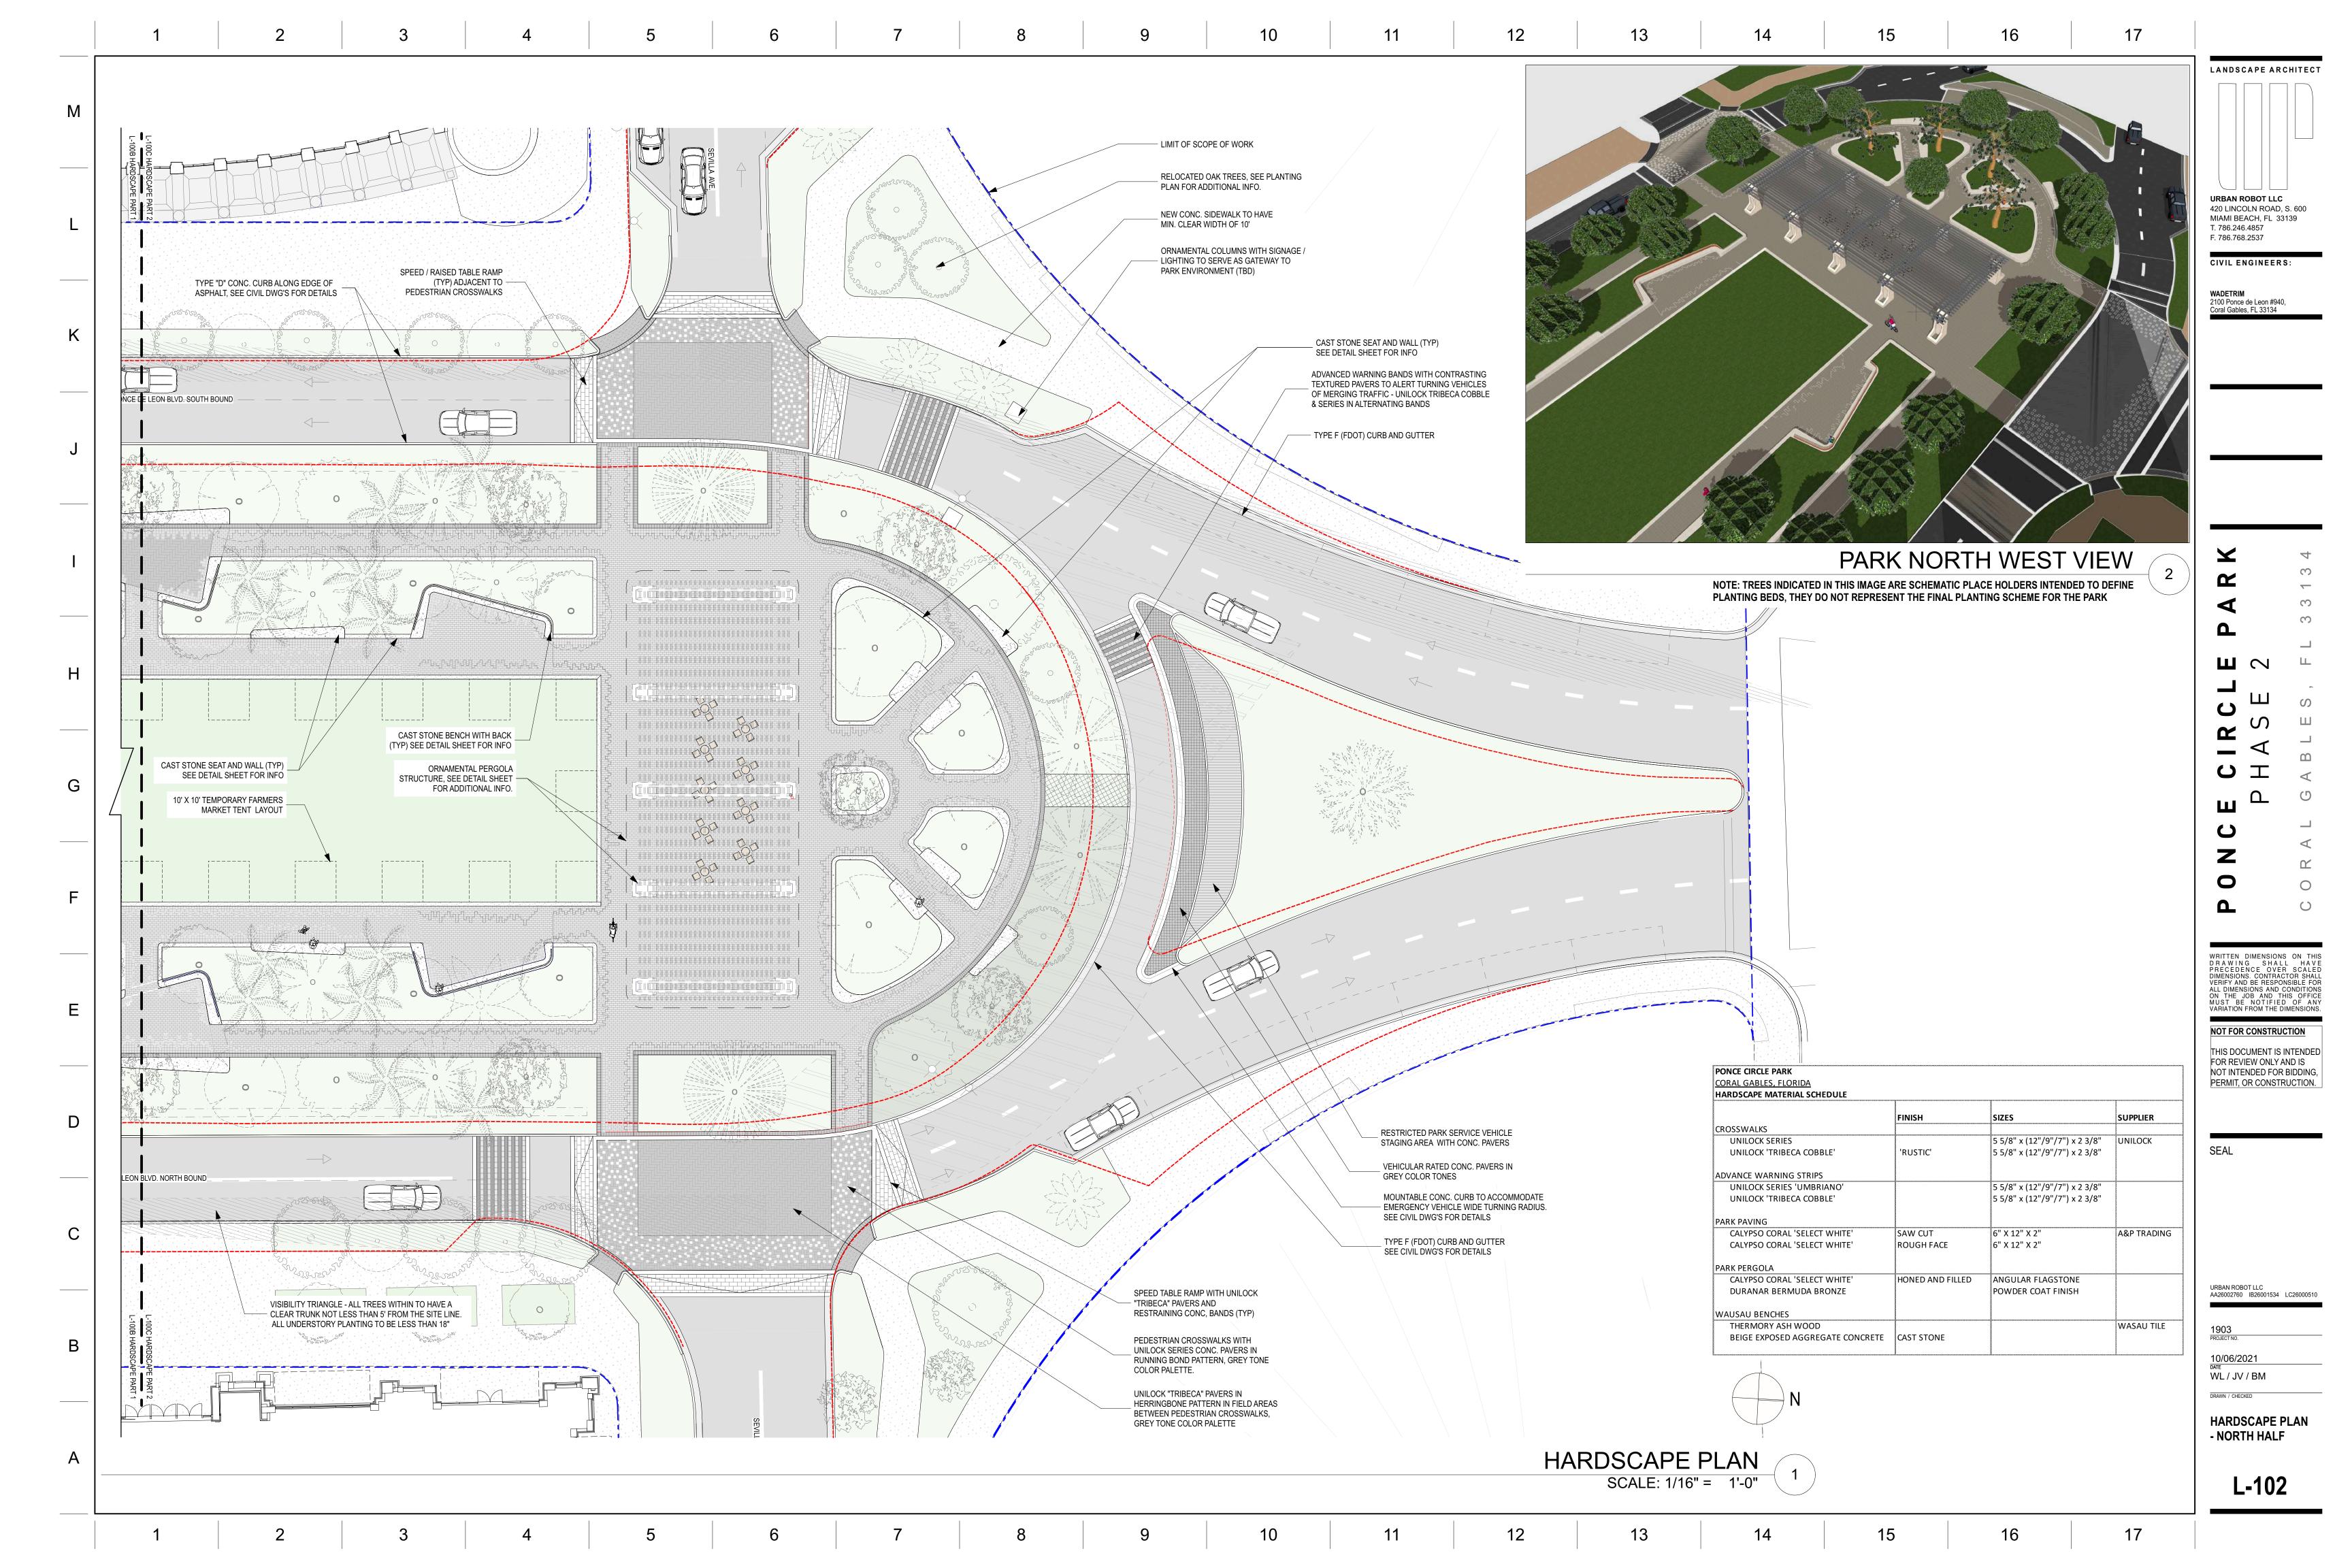
SITE PHOTOGRAPHS


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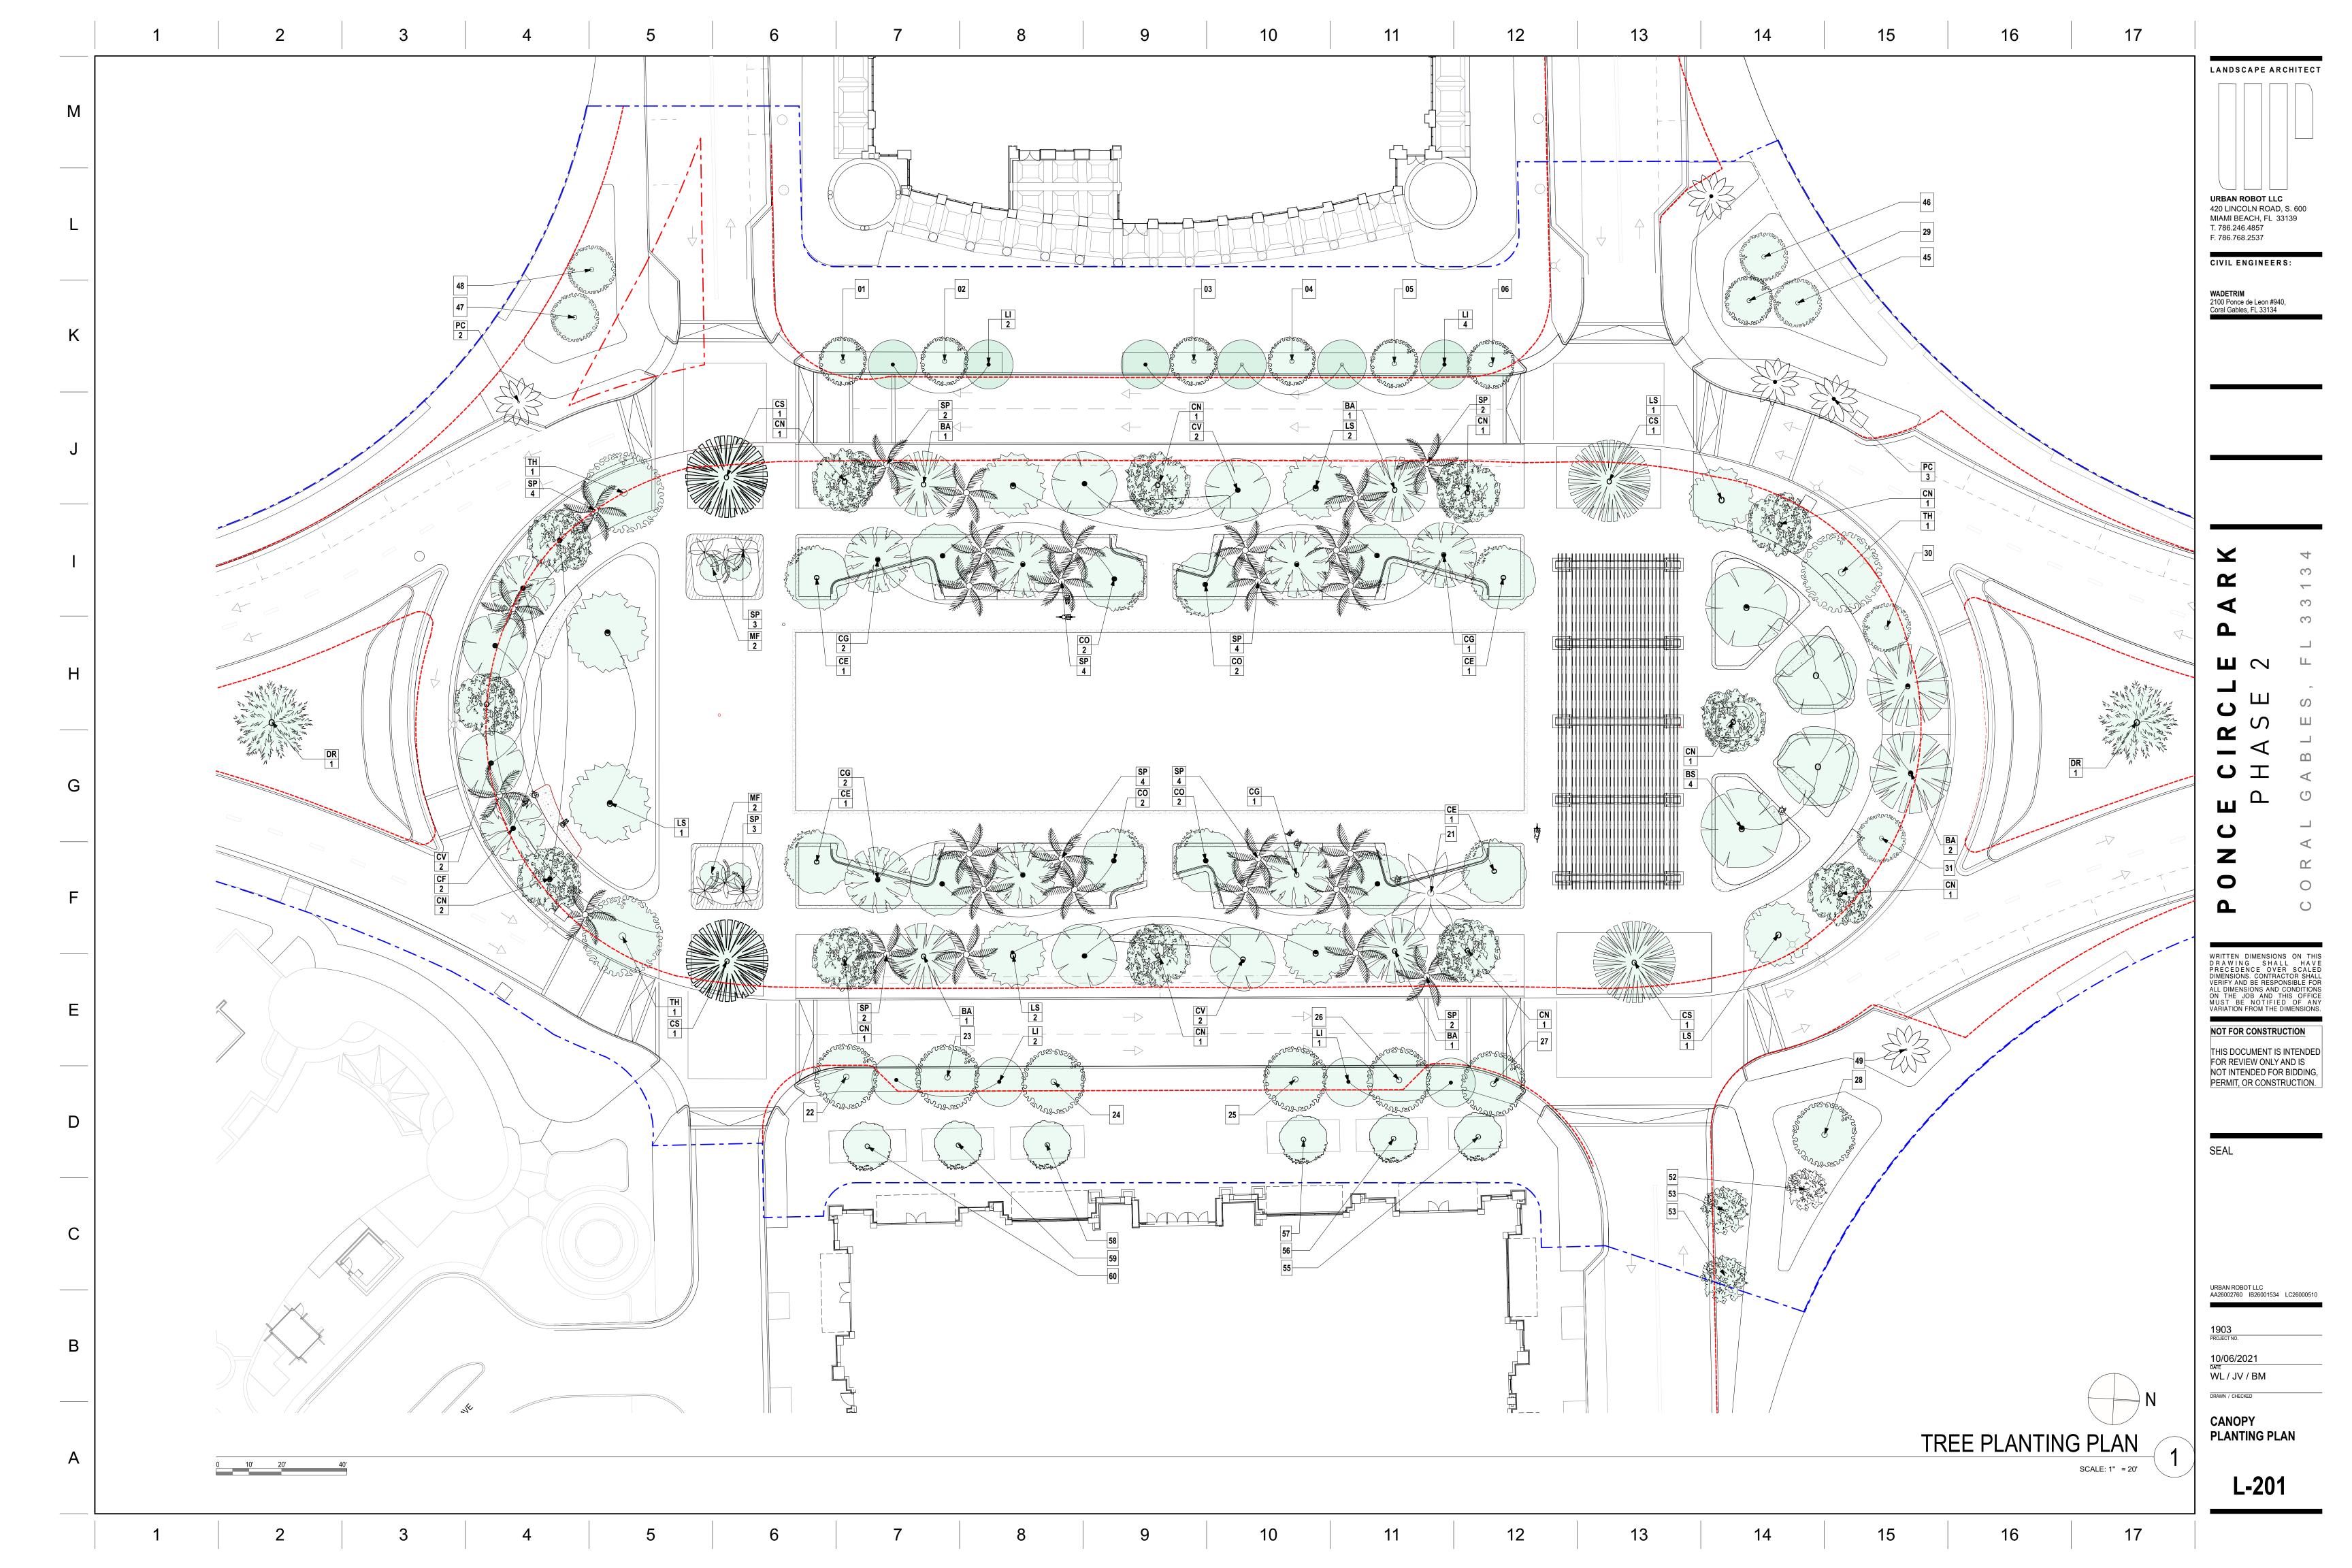
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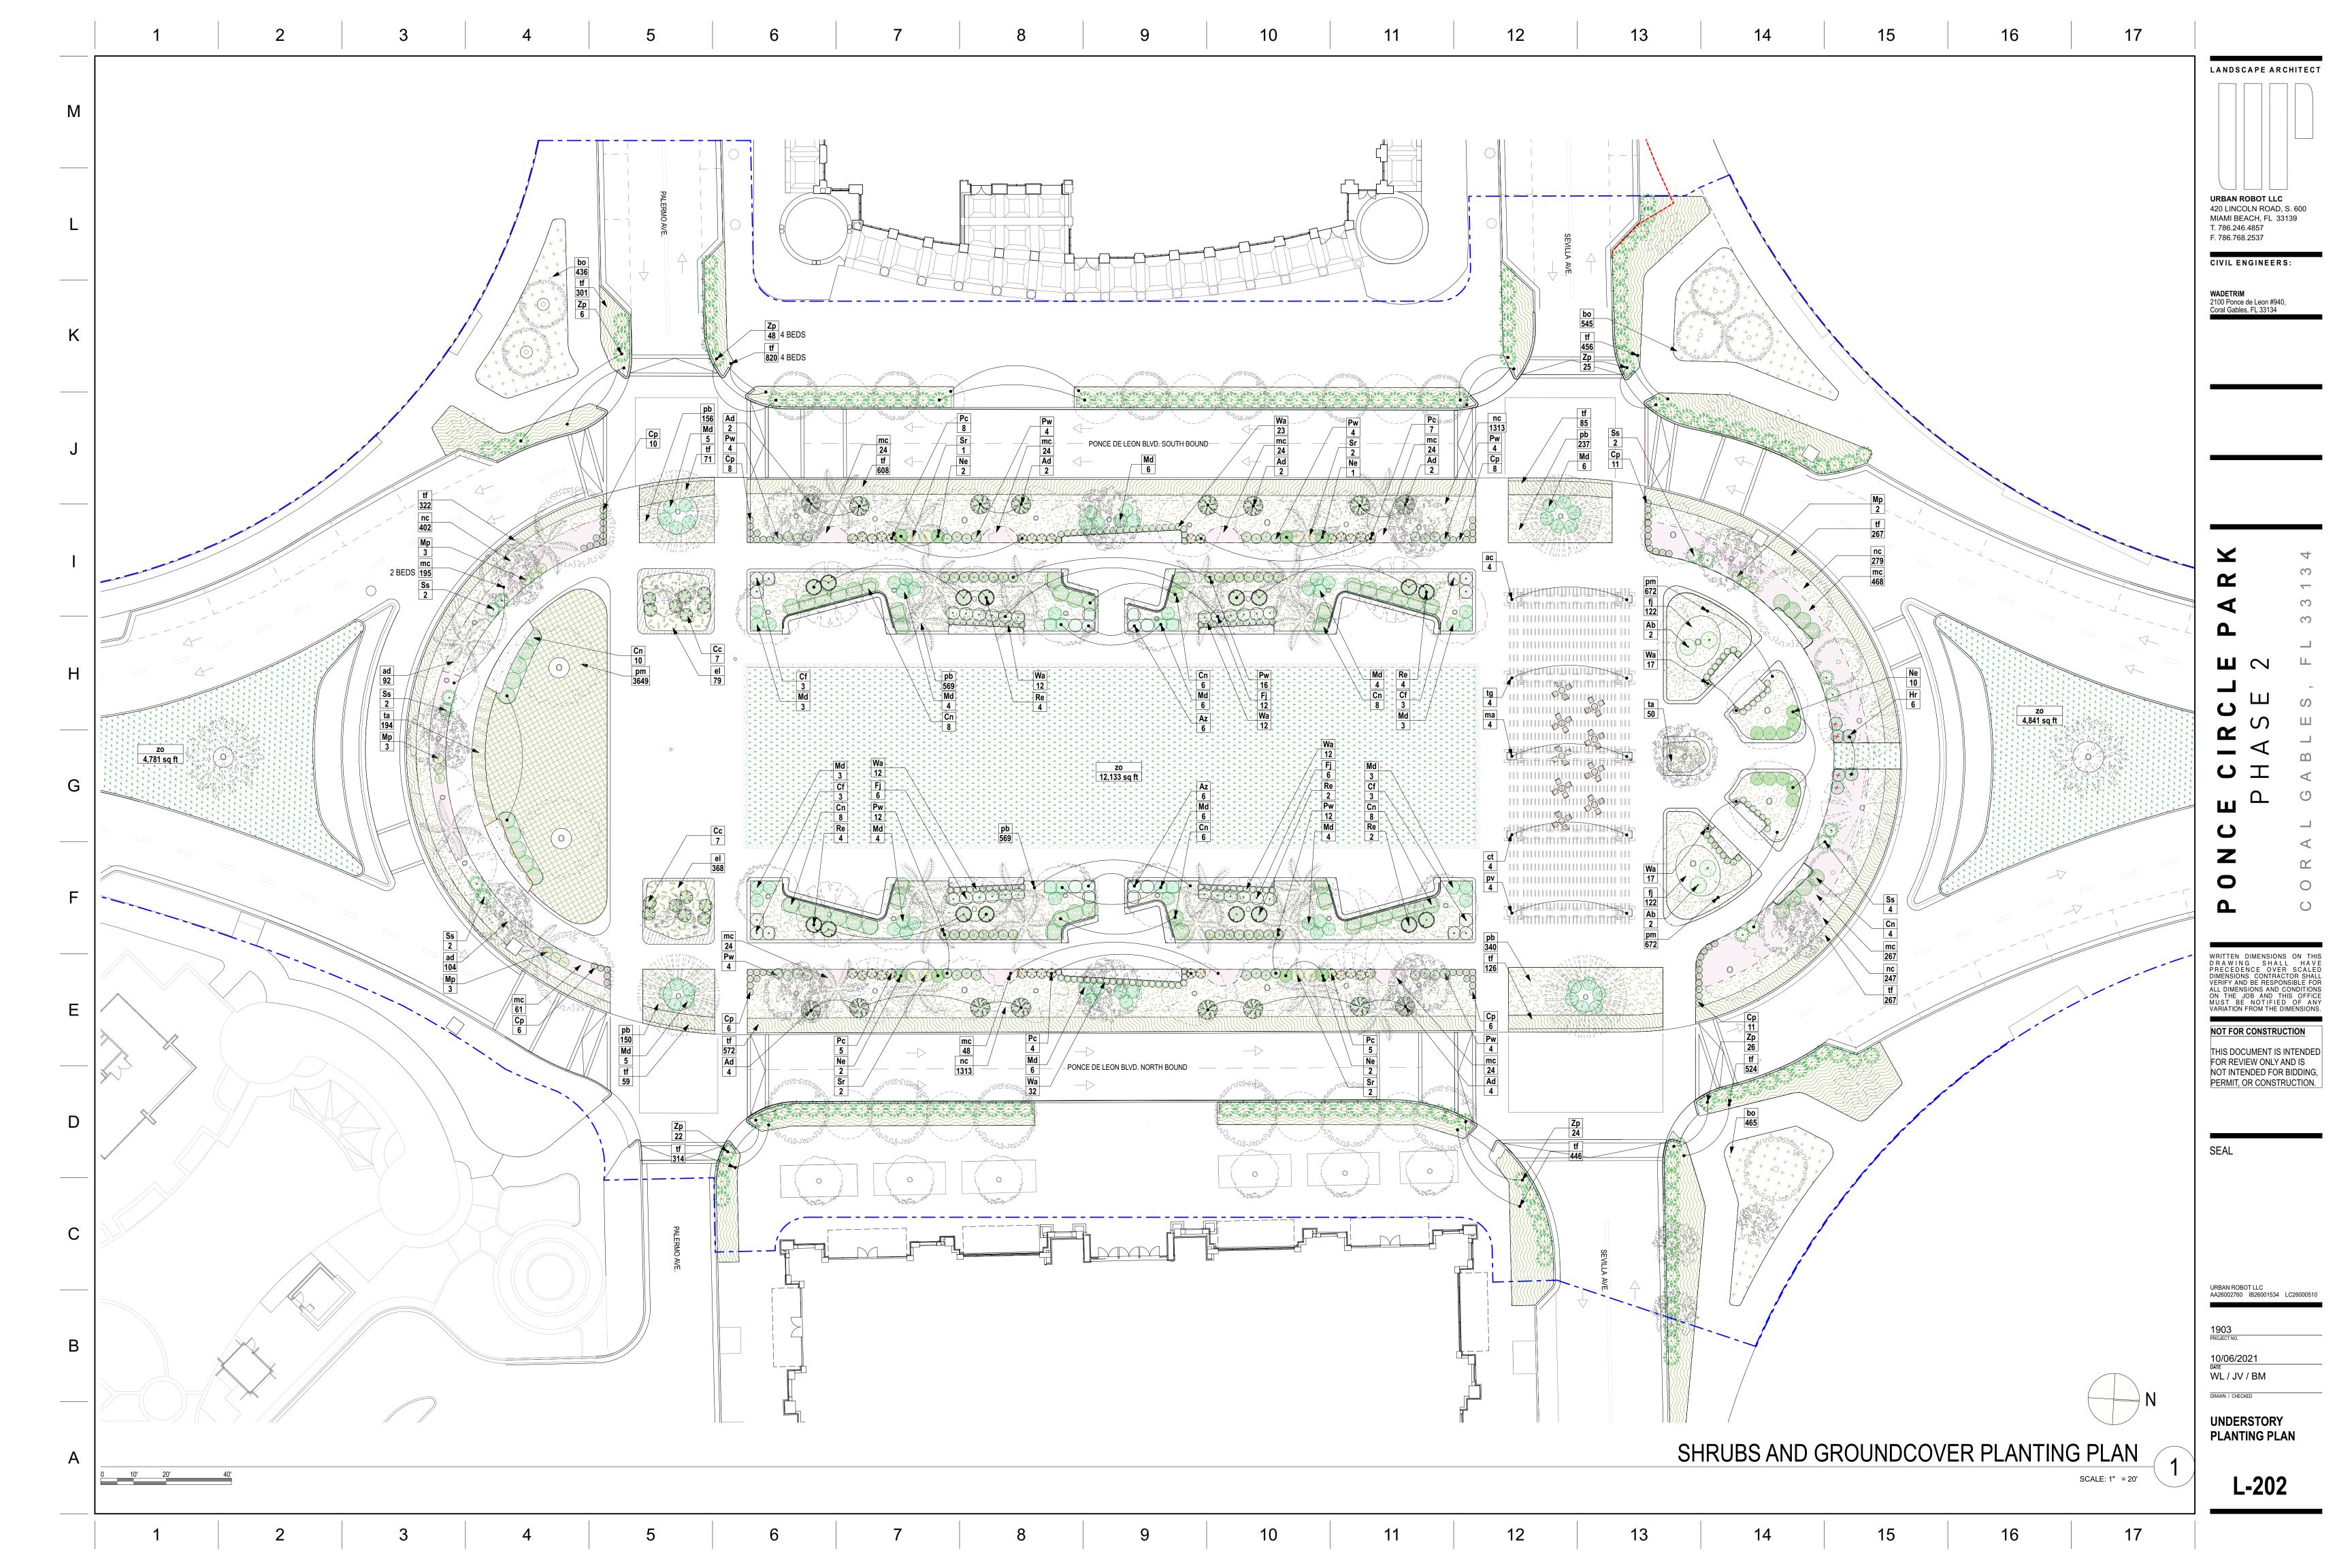










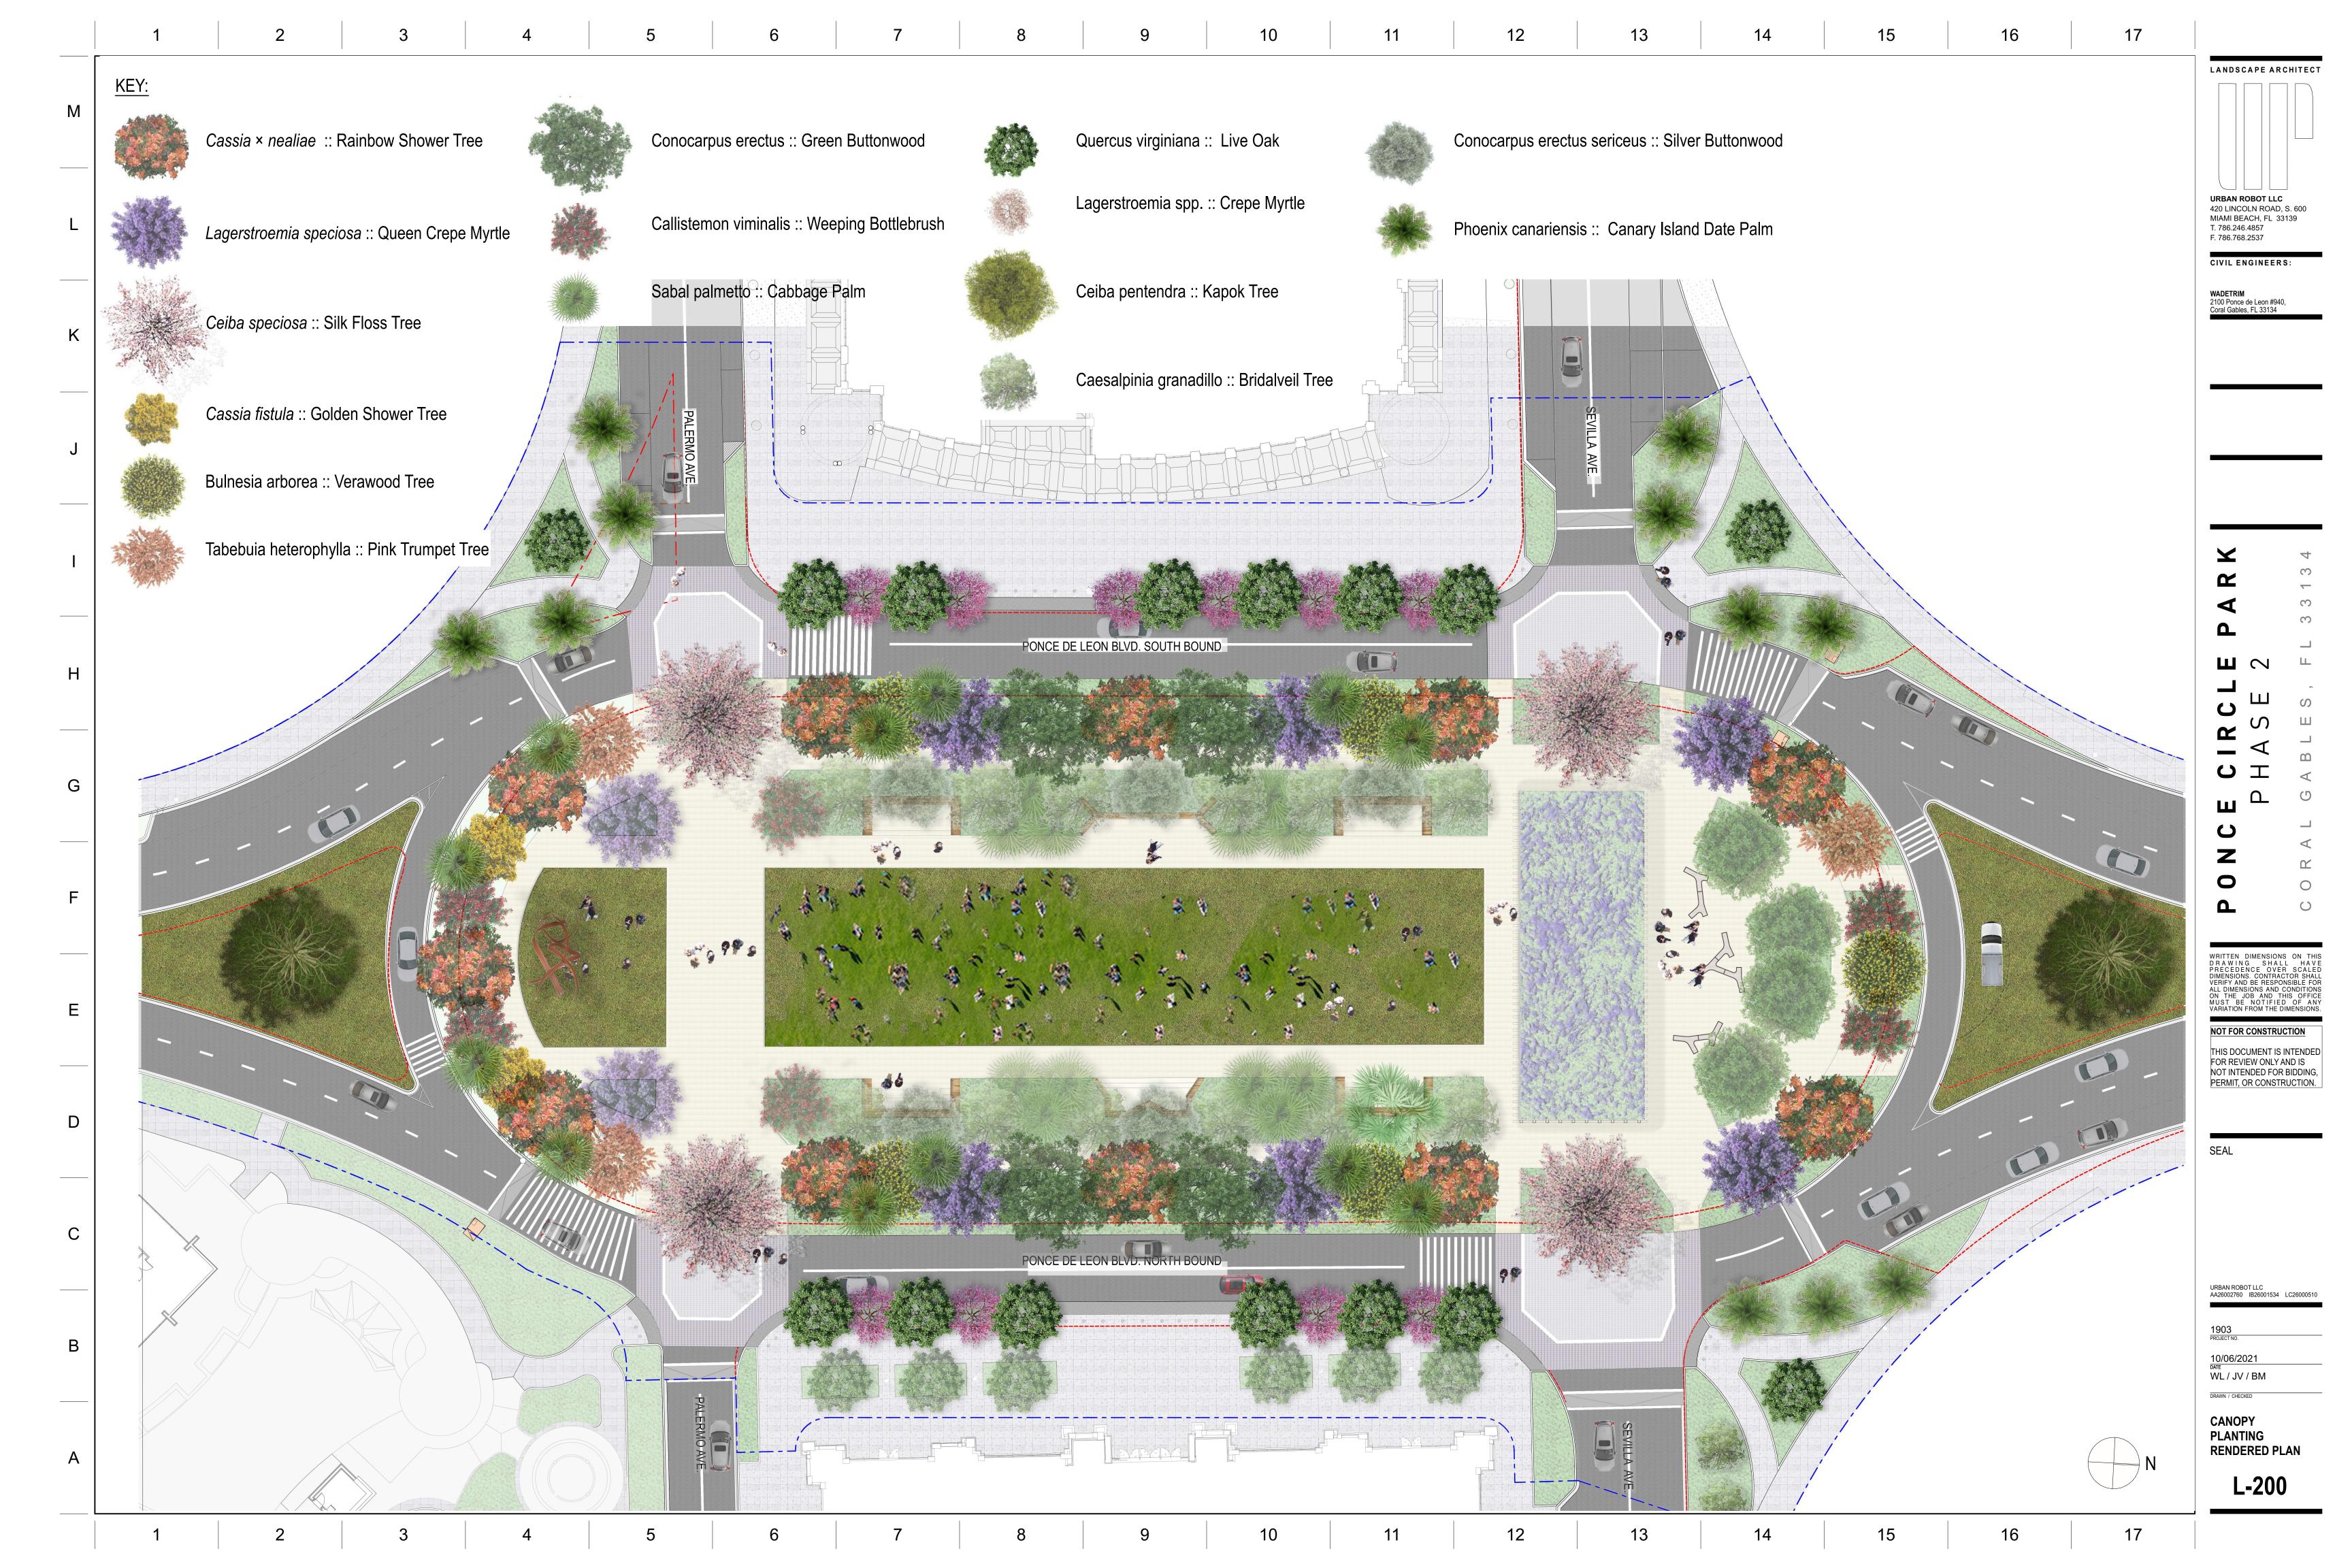

	Tree Schedule											
Symbol	ID	QTY	Botanical Name	Common Name	Cal	Size	Height	Spread	Native	Remarks		
	ВА	6	Bulnesia arborea	Verawood Tree	6"	300 G	15'	15'	N			
	BS	4	Bursera simaruba	Gumbo Limbo	5"	300 G	12'	12'	N			
O	CE	4	Conocarpus erectus	Green Buttonwood	-	100 G	25'	-	Υ	Collected Specimen - Multi Trunk		
	CF	2	Cassia Fistula	Golden Shower Tree	6"	300 G	15'	15'	N			
	CG	7	Caesalpinia granadillo	BridalVeil Tree	-	-	15'	20'	N			
	CN	12	Cassia × nealiae	Rainbow Shower Tree	6"	300 G	15'	15'	N			
O CONTRACTOR OF THE PARTY OF TH	СО	8	Conocarpus erectus 'Sericeus'	Silver Buttonwood	-		14'	-	Υ	Collected Specimen - Multi Trunk		
	CS	4	Chorisia speciosa	Silk Floss Tree	12"	-	25'	30'	N	Collected Specimen		
	CV	6	Callistemon viminalis	Weeping Bottlebrush	-	-	20'	-	N	Collected Specimen, Multi Trunk		
	DR	2	Delonix regia	Royal Poinciana	6"	200 G	13'	15'	Υ	Collected Spicemen		
0	LI	10	Lagerstroemia Indica	Crape Myrtle	2" min		12'	10'	N	Multi Trunk		
The state of the s	LS	8	Lagerstroemia speciosa	Queen Crape Myrtle	2"	100 G	8'	6'	N	Collected Specimen - Multi Trunk		
	MF	4	Myrcianthes fragrans	Simpson's Stopper	3"	100 G	12'	-	Υ	Collected Specimen - Multi Trunk		
	PC	4	Phoenix canariensis	Canary Island Date Palm	24"		12'	14'	N			
	SP	6	Sabal Palmetto	Sabal Palm	-	-	14'	5'	Υ	Curved Trunk		
	SP	28	Sabal Palmetto	Cabbage Palm	-	-	15'	10'	Υ	Curved Trunk		
Sovery Construction of the second of the sec	TH	3	Tabebuia heterophylla	Pink Trumpet Tree	6"	200 G	15'	15'	N			


				Shrub Scl	nedule					
Symbol	ID	Qty	Botanical Name	Common Name	Size	Height	Spread	Spacing	Native	Remarks
•	Ab	4	Alocasia macrorrhiza 'Borneo Giant	Alocasia	15 G	5'	-	Plan	N	
	Ad	16	Acrostichum danaeifolium	Leather Fern	3 G	36"	-	-	N	
	Az	12	Alpinia zerumbet	Shell Ginger	15 G	5'	4'	-	N	-
	Сс	14	Capparis cynophallophora	Jamaiacn Caper	15 G	4'	4'	Plan	Υ	-
•	Cf	12	Cordyline fruticosa 'Auntie Lou'	Cordyline terminalis	3 G	3'	3'	3'	N	
	Cn	62	Cestrum nocturnum	Night Blooming Jasmine	1 G	2'	2'	2'	Υ	
lacksquare	Ср	69	Canna 'Carolina Pink'	Canna	3 G	36"	18"	Plan	N	Pink Flower
•	Fj	24	Fatsia japonica	Paperplant	7 G	5'	5'	-	N	Lot Shrub
X	Hr	6	Heliconia rostrata	Lobster Claw Heliconnia	15 G	8'	6'	Plan	N	-
·	Md	74	Monstera deliciosa	Swiss Cheese Vine	3 G	2'	2.5'	2.5'	N	
	Мр	12	Mussaenda philippica	Peach/Pink Mussaenda	15 G	3'	6'	-	N	Full, Heavy.
•	Ne	18	Nephrolepis exaltata	Boston Fern	3 G	1'	3'	3'	Υ	
	Рс	32	Philodendron 'Rojo Congo'	Red Congo Philodendron	3 G	24"	24"	Plan	N	-
$\overline{}$	Pw	64	Philodendron wilsonii	Philodendron wilsonii	15 G	24"	24"	Plan	N	-
A CONTRACTOR OF THE STATE OF TH	Re	16	Rhapis excelsa	Lady Palm	45 G	7'	5'	Plan	N	-
*	Sr	8	Strelitzia reginae	Orange bird of paradise	25 G	4'	4'	Plan	N	-
£ • 3	Ss	14	Serenoa repens 'Cinerea'	Silver Saw Palmetto	45 G	4'	5'	-	N	
*	Wa	128	Wrightia antidysenterica	Asian Snow	7 G	3'	2'	Plan	N	-
	Zp	151	Zamia pumila	Coontie	15 G	4'	4'	4'	Υ	

10

11

12

	Groundcover Schedule											
Symbol	ID	QTY	Botanical Name	Common Name	Size	Height	Spread	Spacing	Native	Area (sf)	Remarks	
	ac		Allamanda cathartica	Brown Bud Allamanda	7 G	36"	12"	18"	N	14		
V V V V V V V V V V V V V V V V V V V	ad		Asparagus densiflorus 'Meyerii'	Foxtail Fern	3 G	18"	-	15"	N	266	-	
× × × × ×	bo		Begonia odorata 'Alba'	White Begonia	3 G	12"	12"	18"	N	2,795		
	ct		Clerodendrum thomsoniae	Bleeding Heart Vine	7 G	36"	12"	18"	N	14		
	el		Ernodea littoralis	Golden Beach Creeper	3 G	12"	12"	12"	Υ	600		
9	fj		Farfugium japonicum 'Gigantea'	Leopard Plant	3 G	12"	12"-24"	15"	N	330	-	
	ma		Mandevilla dipladenia	Pink Mandevilla	7 G	36"	12"	18"	N	14		
	mc		Muhlenbergia capillaris	Pink Muhly Grass	1 G	18"	18"	18"	N	2,899		
なない	nc		Neomarica caerulea	Apostles Iris	3 G	24"	18"	18"	Υ	6,829		
	pb		Philodendron 'Burle Marx'	'Burle Marx'	3 G	12"	12"	18"	N	5,844		
	pm		Pilea microphylla	Artillery Fern	1 G	12"	-	12"	N	4,071		
	pv		Petrea volubilis	Purple Queen's Wreath	7 G	36"	12"	18"	N	14		
	ta		Trachelospermum asiaticum	Asiatic Jasmine	1 G	18"	-	6"	N	268		
	tf		Tripsacum floridana	Dwarf Fakahatchee	3 G	18"	18"	18"	Υ	11,312		
	tg		Thunbergia grandiflora	Blue Sky Vine	7 G	36"	12"	18"	N	14		
7 7 7 × V	ZO		Zoysia	Zoyzia Empire						20,763	Solid, even sod	

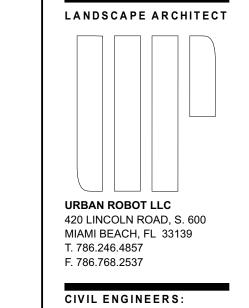

16

WADETRIM 2100 Ponce de Leon #940, Coral Gables, FL 33134

> CECIRCLE PARK PHASE 2

WRITTEN DIMENSIONS ON THIS DRAWING SHALL HAVE PRECEDENCE OVER SCALED DIMENSIONS. CONTRACTOR SHALL VERIFY AND BE RESPONSIBLE FOR ALL DIMENSIONS AND CONDITIONS ON THE JOB AND THIS OFFICE MUST BE NOTIFIED OF ANY VARIATION FROM THE DIMENSIONS.

NOT FOR CONSTRUCTION

THIS DOCUMENT IS INTENDED FOR REVIEW ONLY AND IS NOT INTENDED FOR BIDDING, PERMIT, OR CONSTRUCTION.

SEAL

URBAN ROBOT LLC AA26002760 IB26001534 LC26000510

1903 PROJECT NO. 10/06/2021 DATE


WL / JV / BM

PLANTING

SCHEDULE

L-203

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LANDSCAPE ARCHITECT

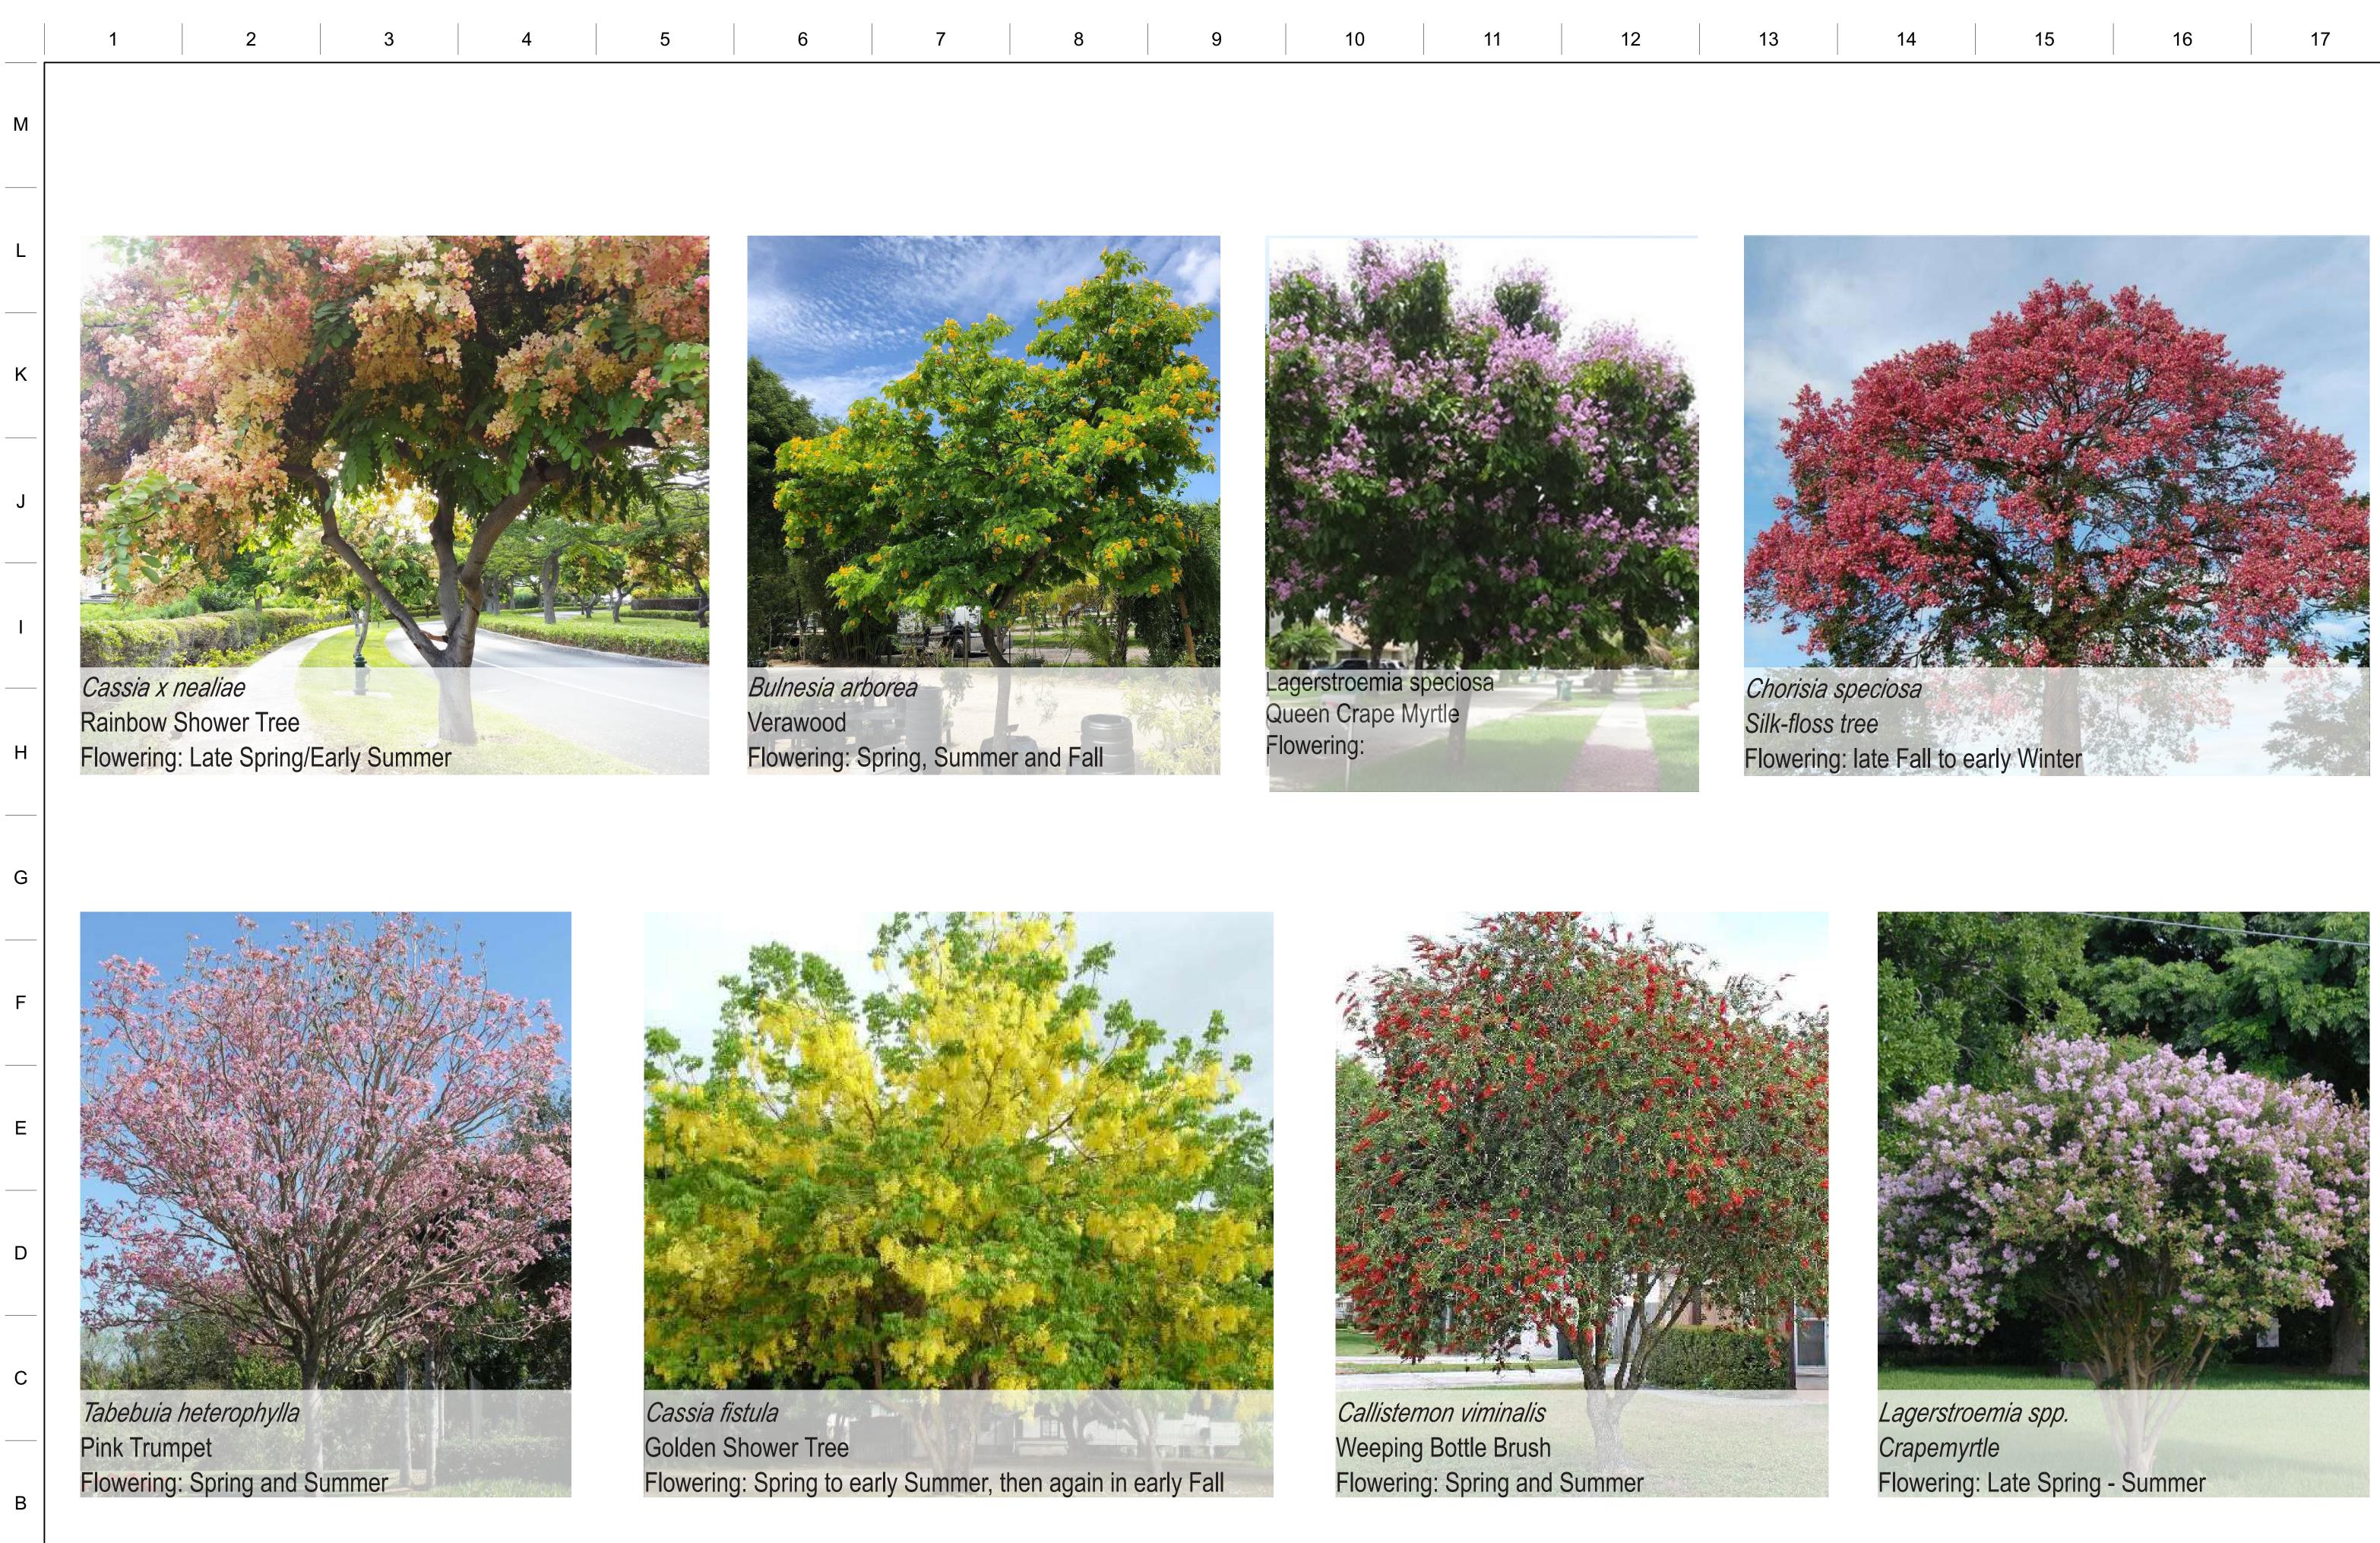URBAN ROBOT LLC

URBAN ROBOT LLC
420 LINCOLN ROAD, S. 600
MIAMI BEACH, FL 33139
T. 786.246.4857
F. 786.768.2537

F. 786.768.2537

CIVIL ENGINEERS:

WADETRIM 2100 Ponce de Leon #940, Coral Gables, FL 33134

PONCE CIRC PHAS

RITTEN DIMENSIONS ON THIS RAWING SHALL HAVE RECEDENCE OVER SCALED MENSIONS. CONTRACTOR SHALL ERIFY AND BE RESPONSIBLE FOR L DIMENSIONS AND CONDITIONS N THE JOB AND THIS OFFICE UST BE NOTIFIED OF ANY ARIATION FROM THE DIMENSIONS.

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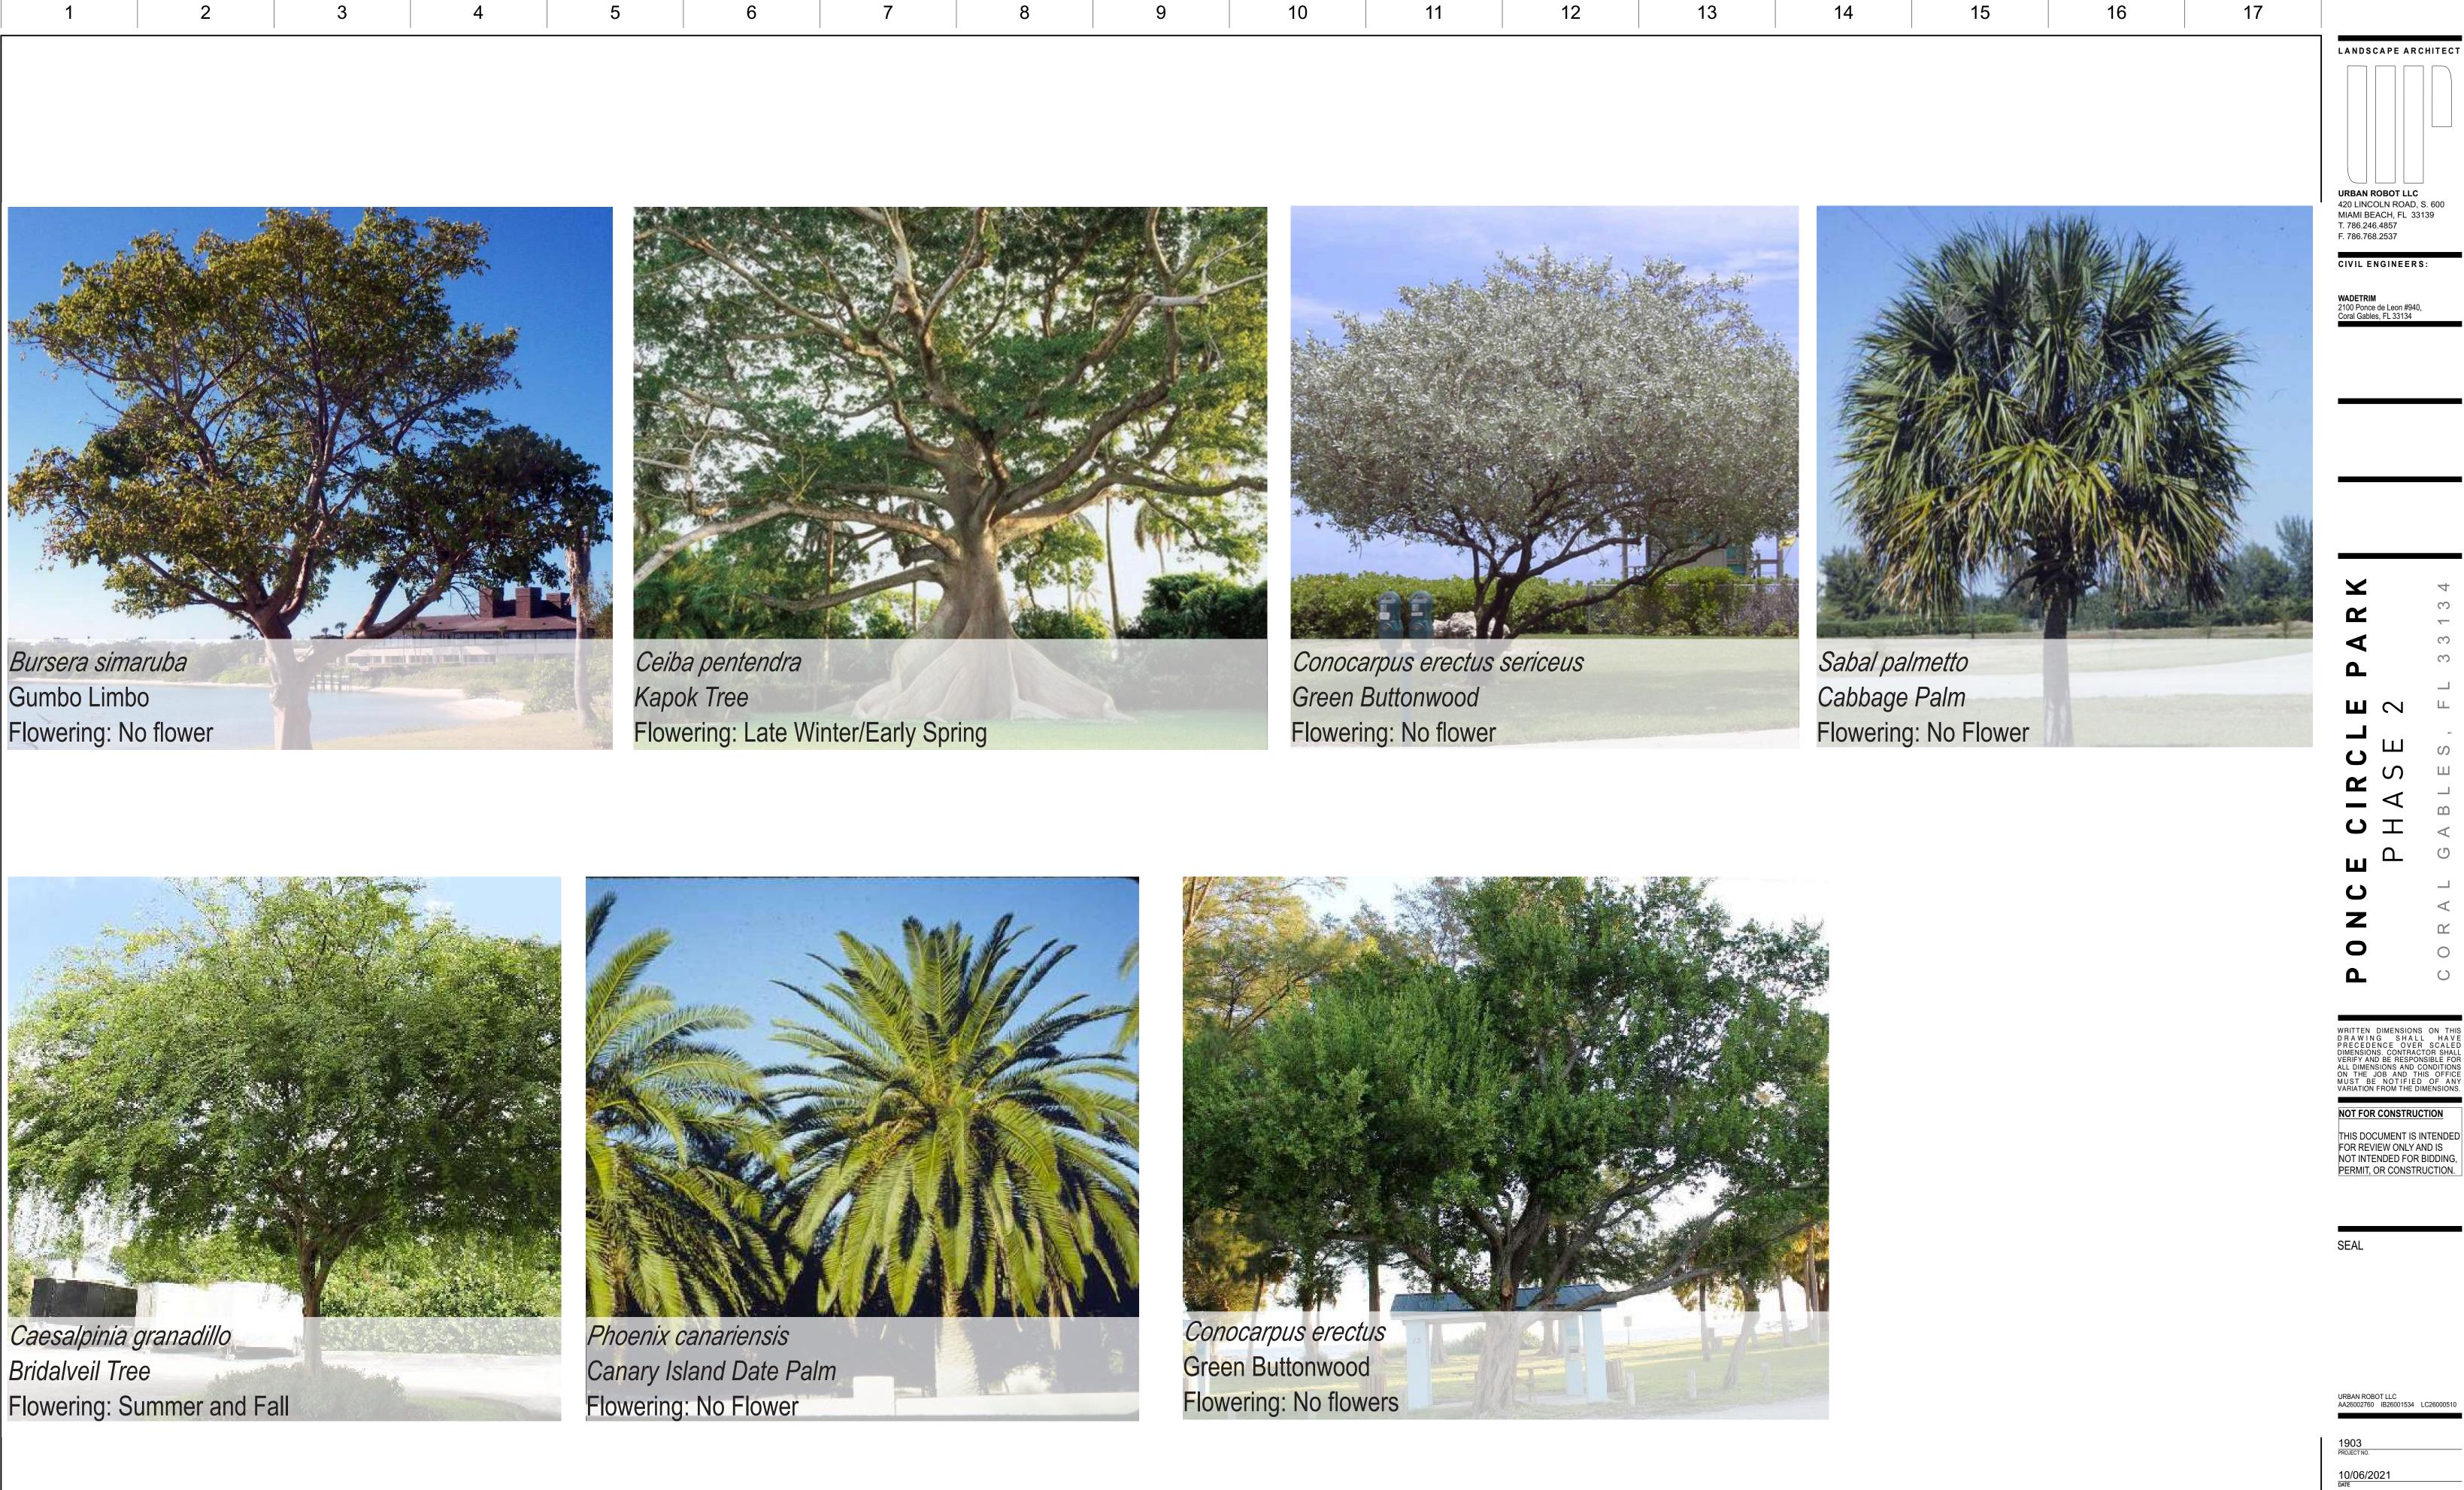
URBAN ROBOT LLC AA26002760 IB26001534 LC2600

1903 PROJECT NO.

DATE
WL / JV / BM

PLANTING PALETTE

L-204.1



PLANTING PALETTE

L-204.2

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В



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URBAN ROBOT LLC AA26002760 IB26001534 LC26000510

10/06/2021 DATE WL/JV/BM

PLANTING


PALETTE L-204.3


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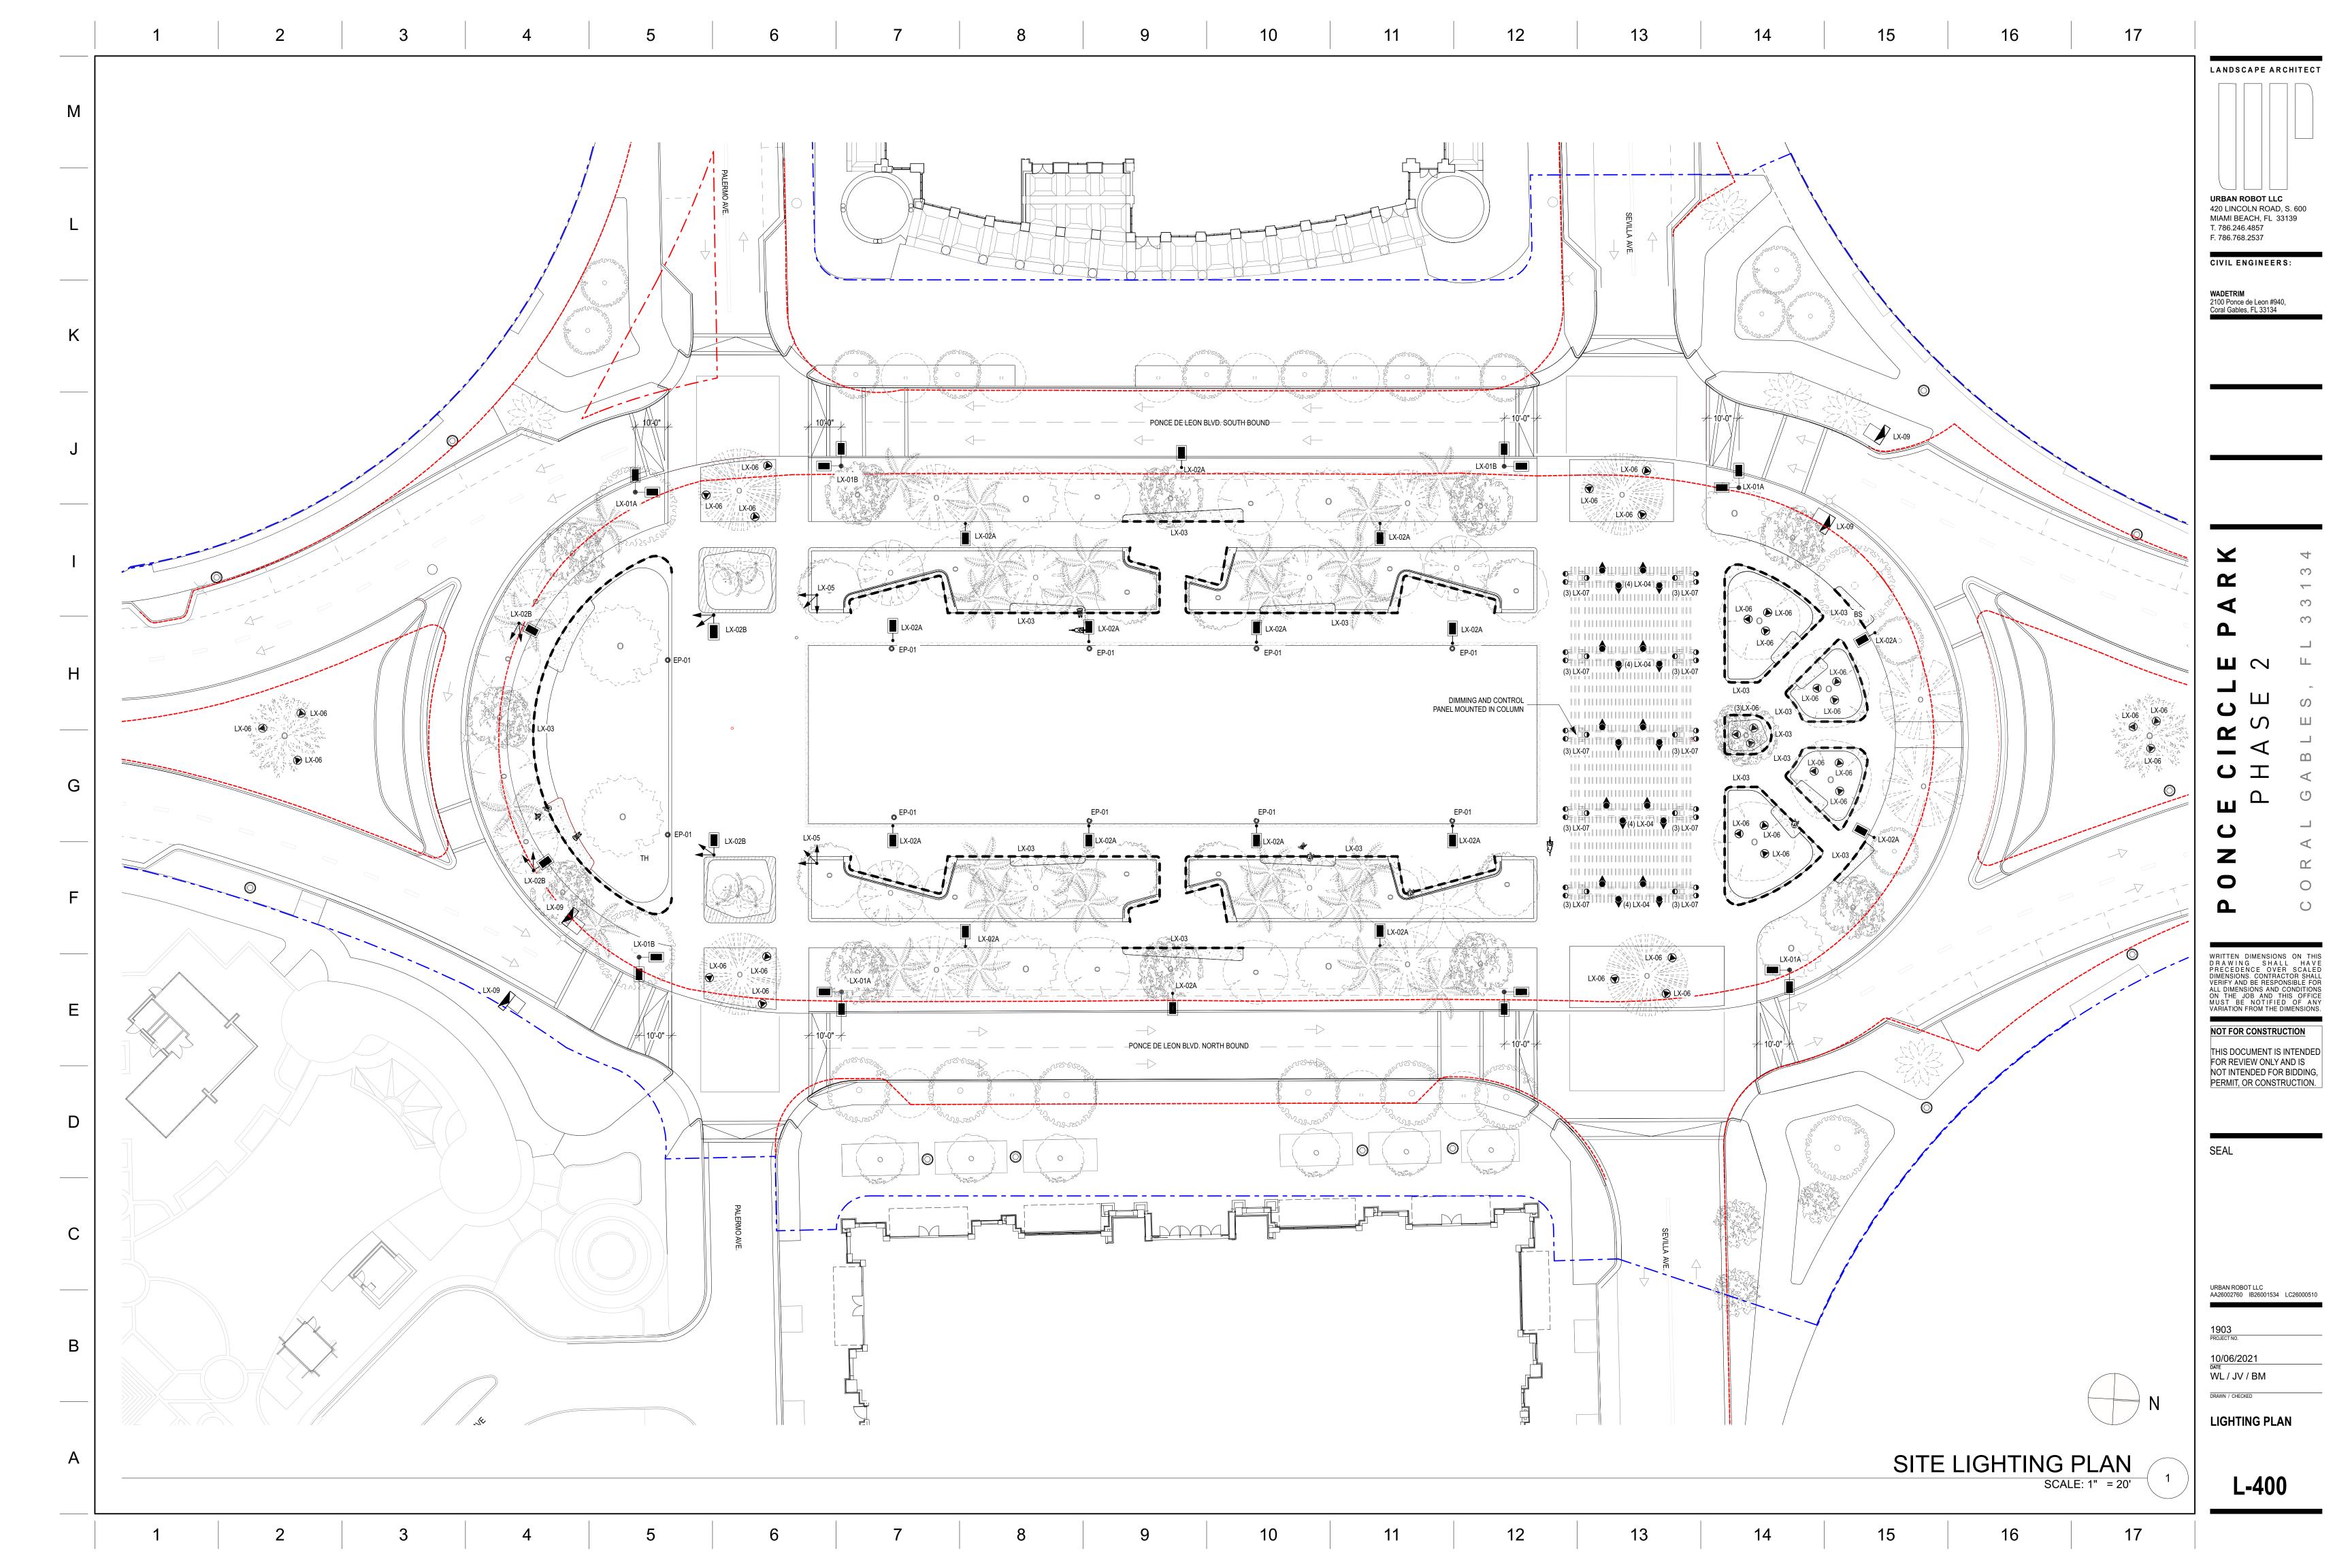
Muhlenbergia capillaris


Muhly grass

Flowering: fall



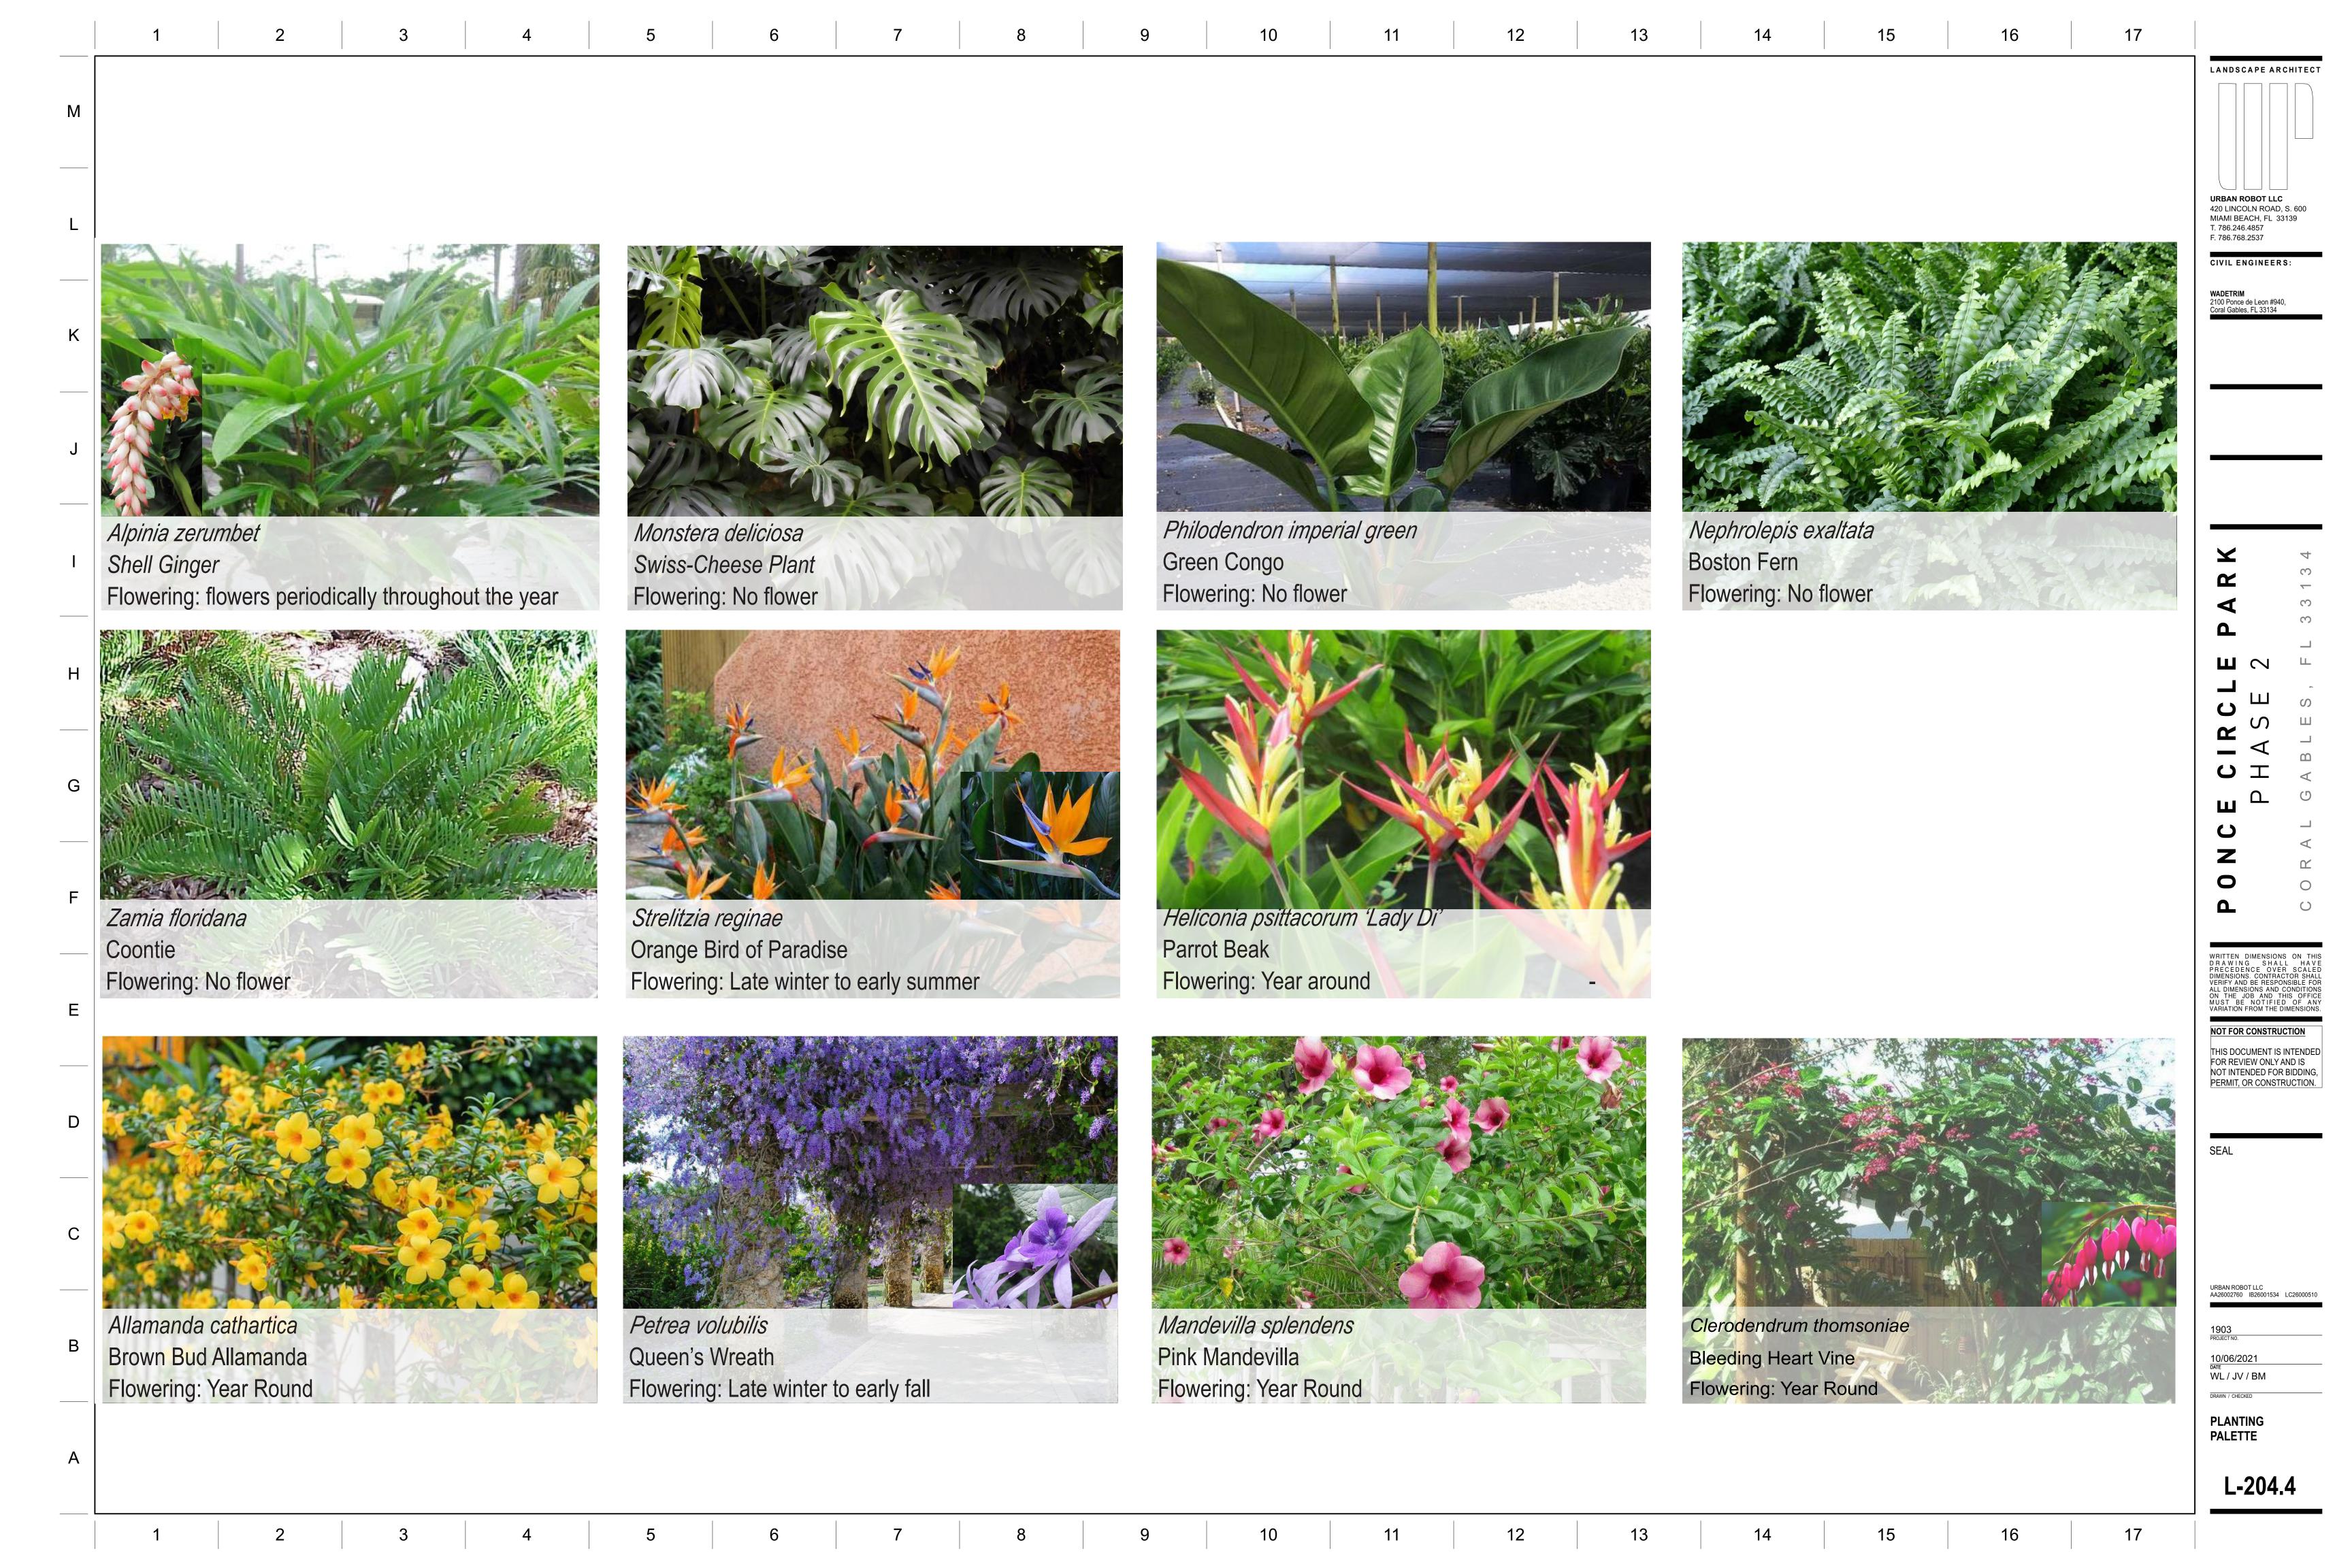

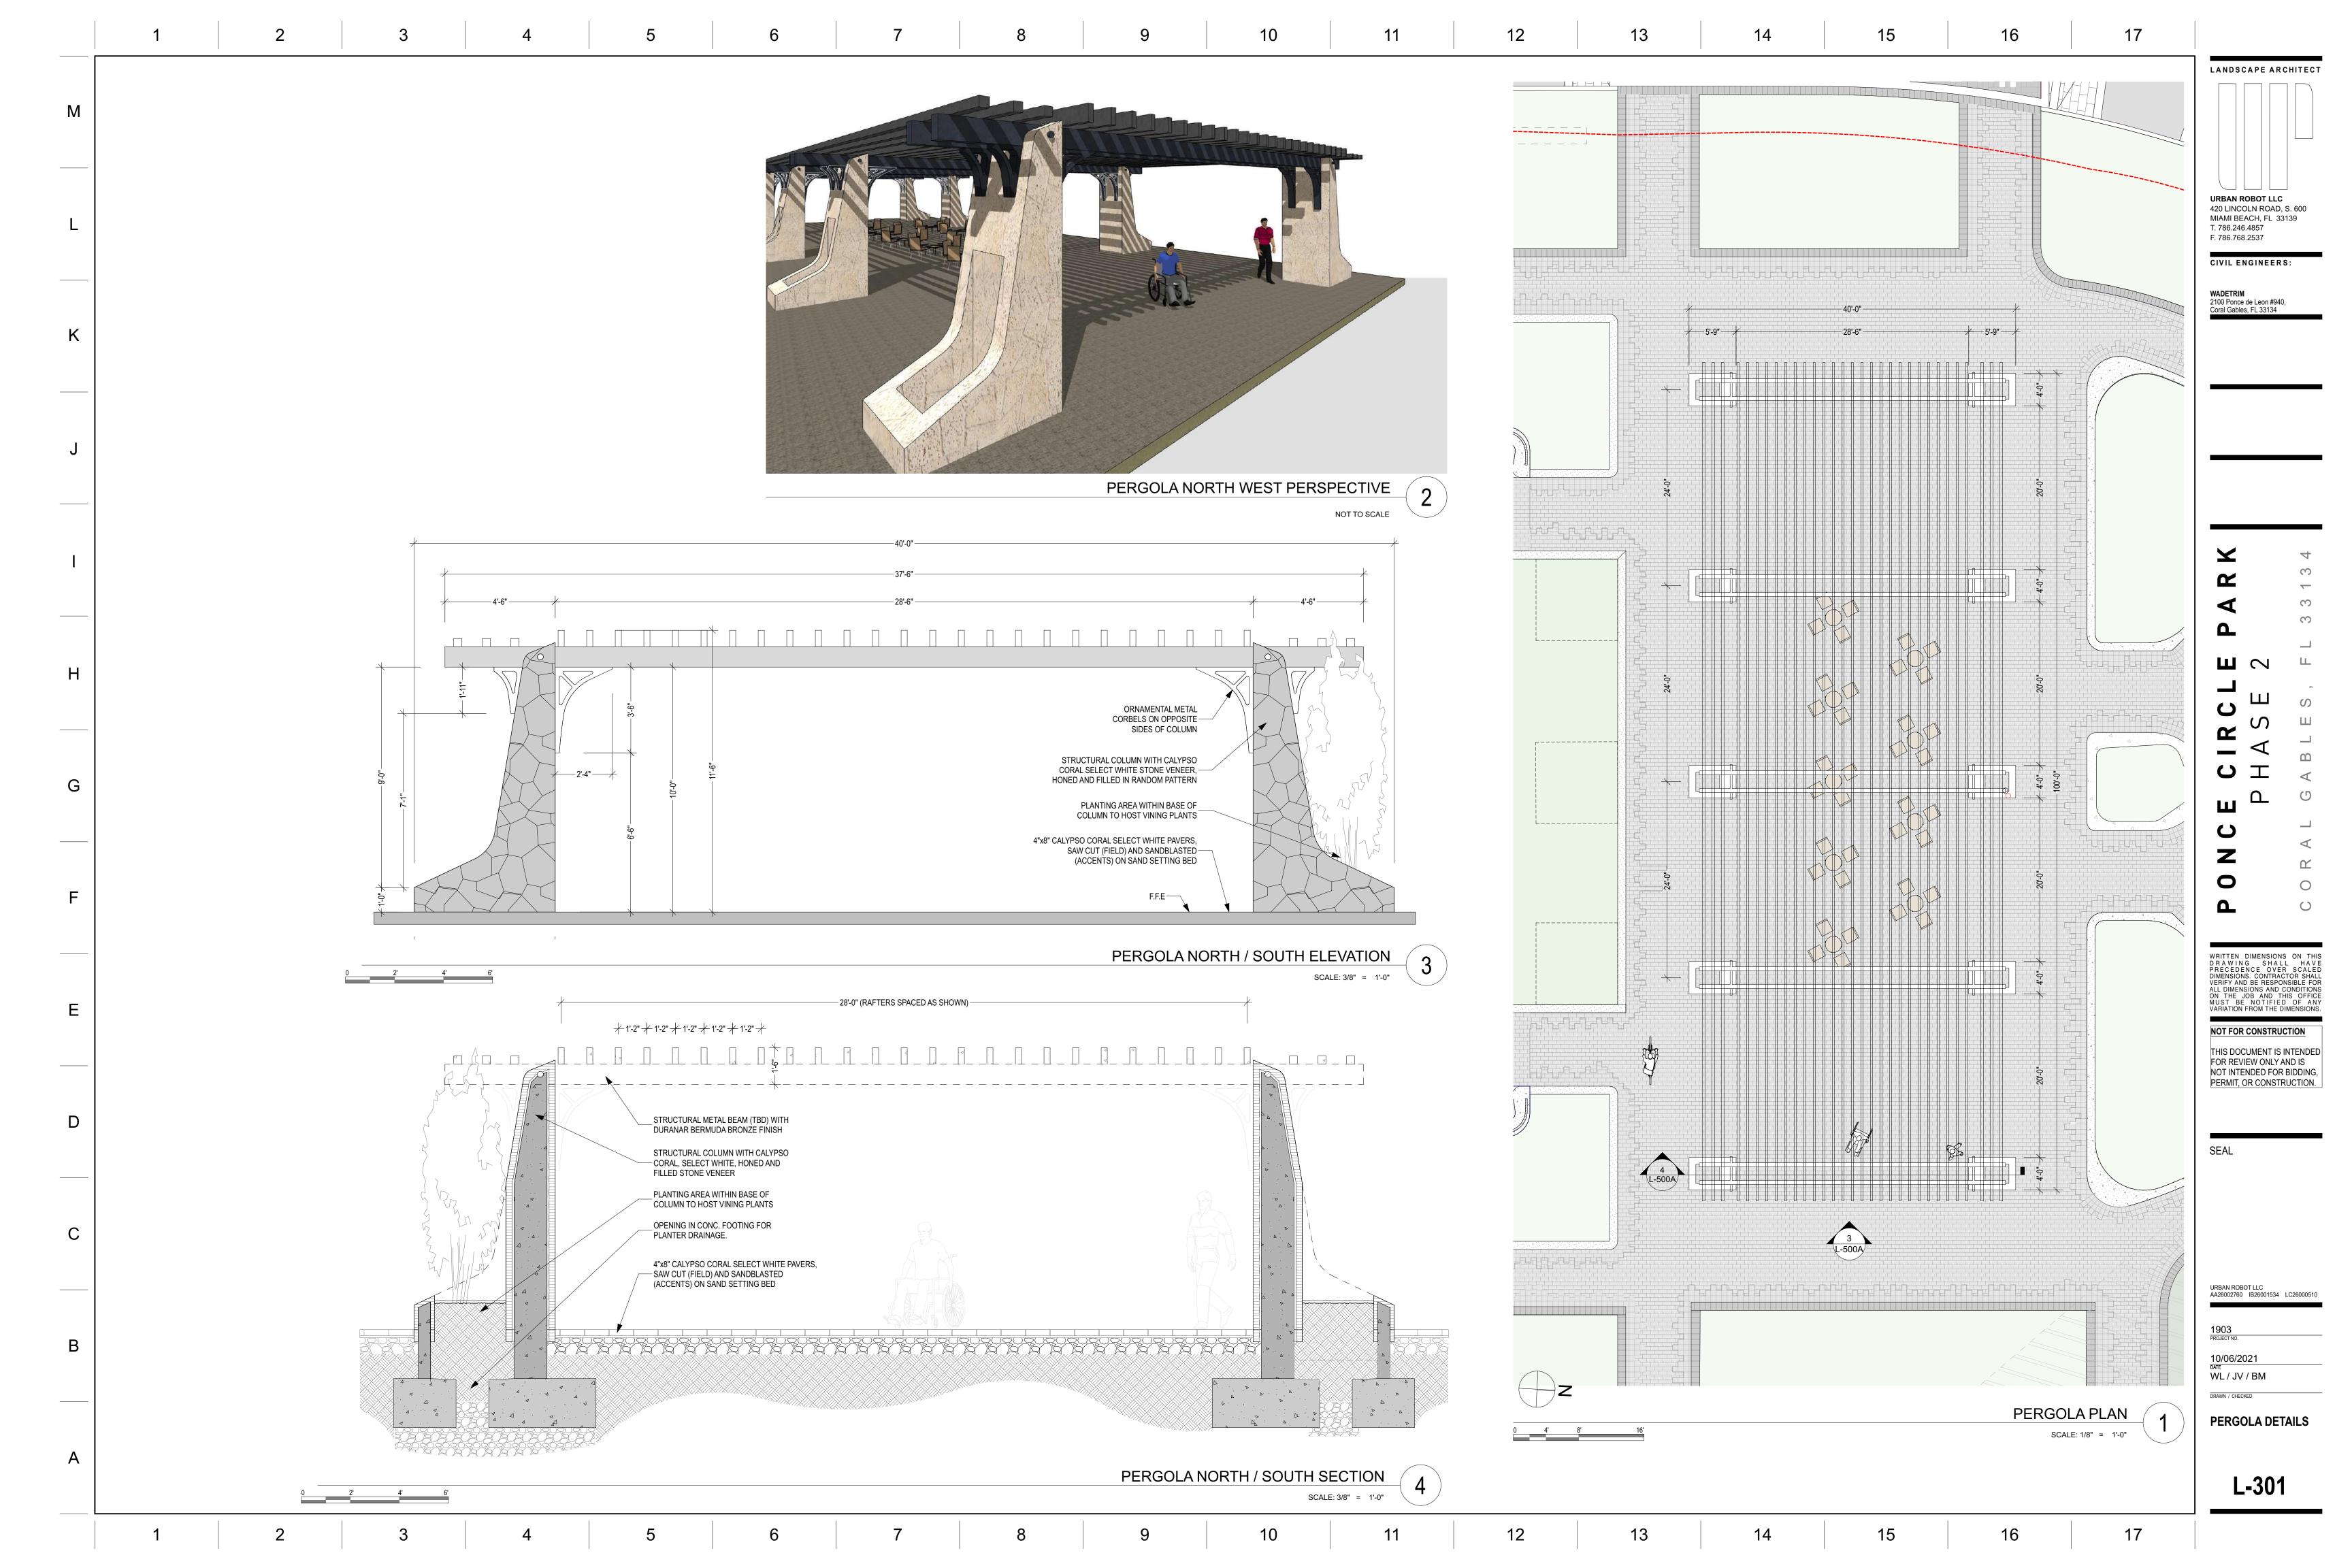

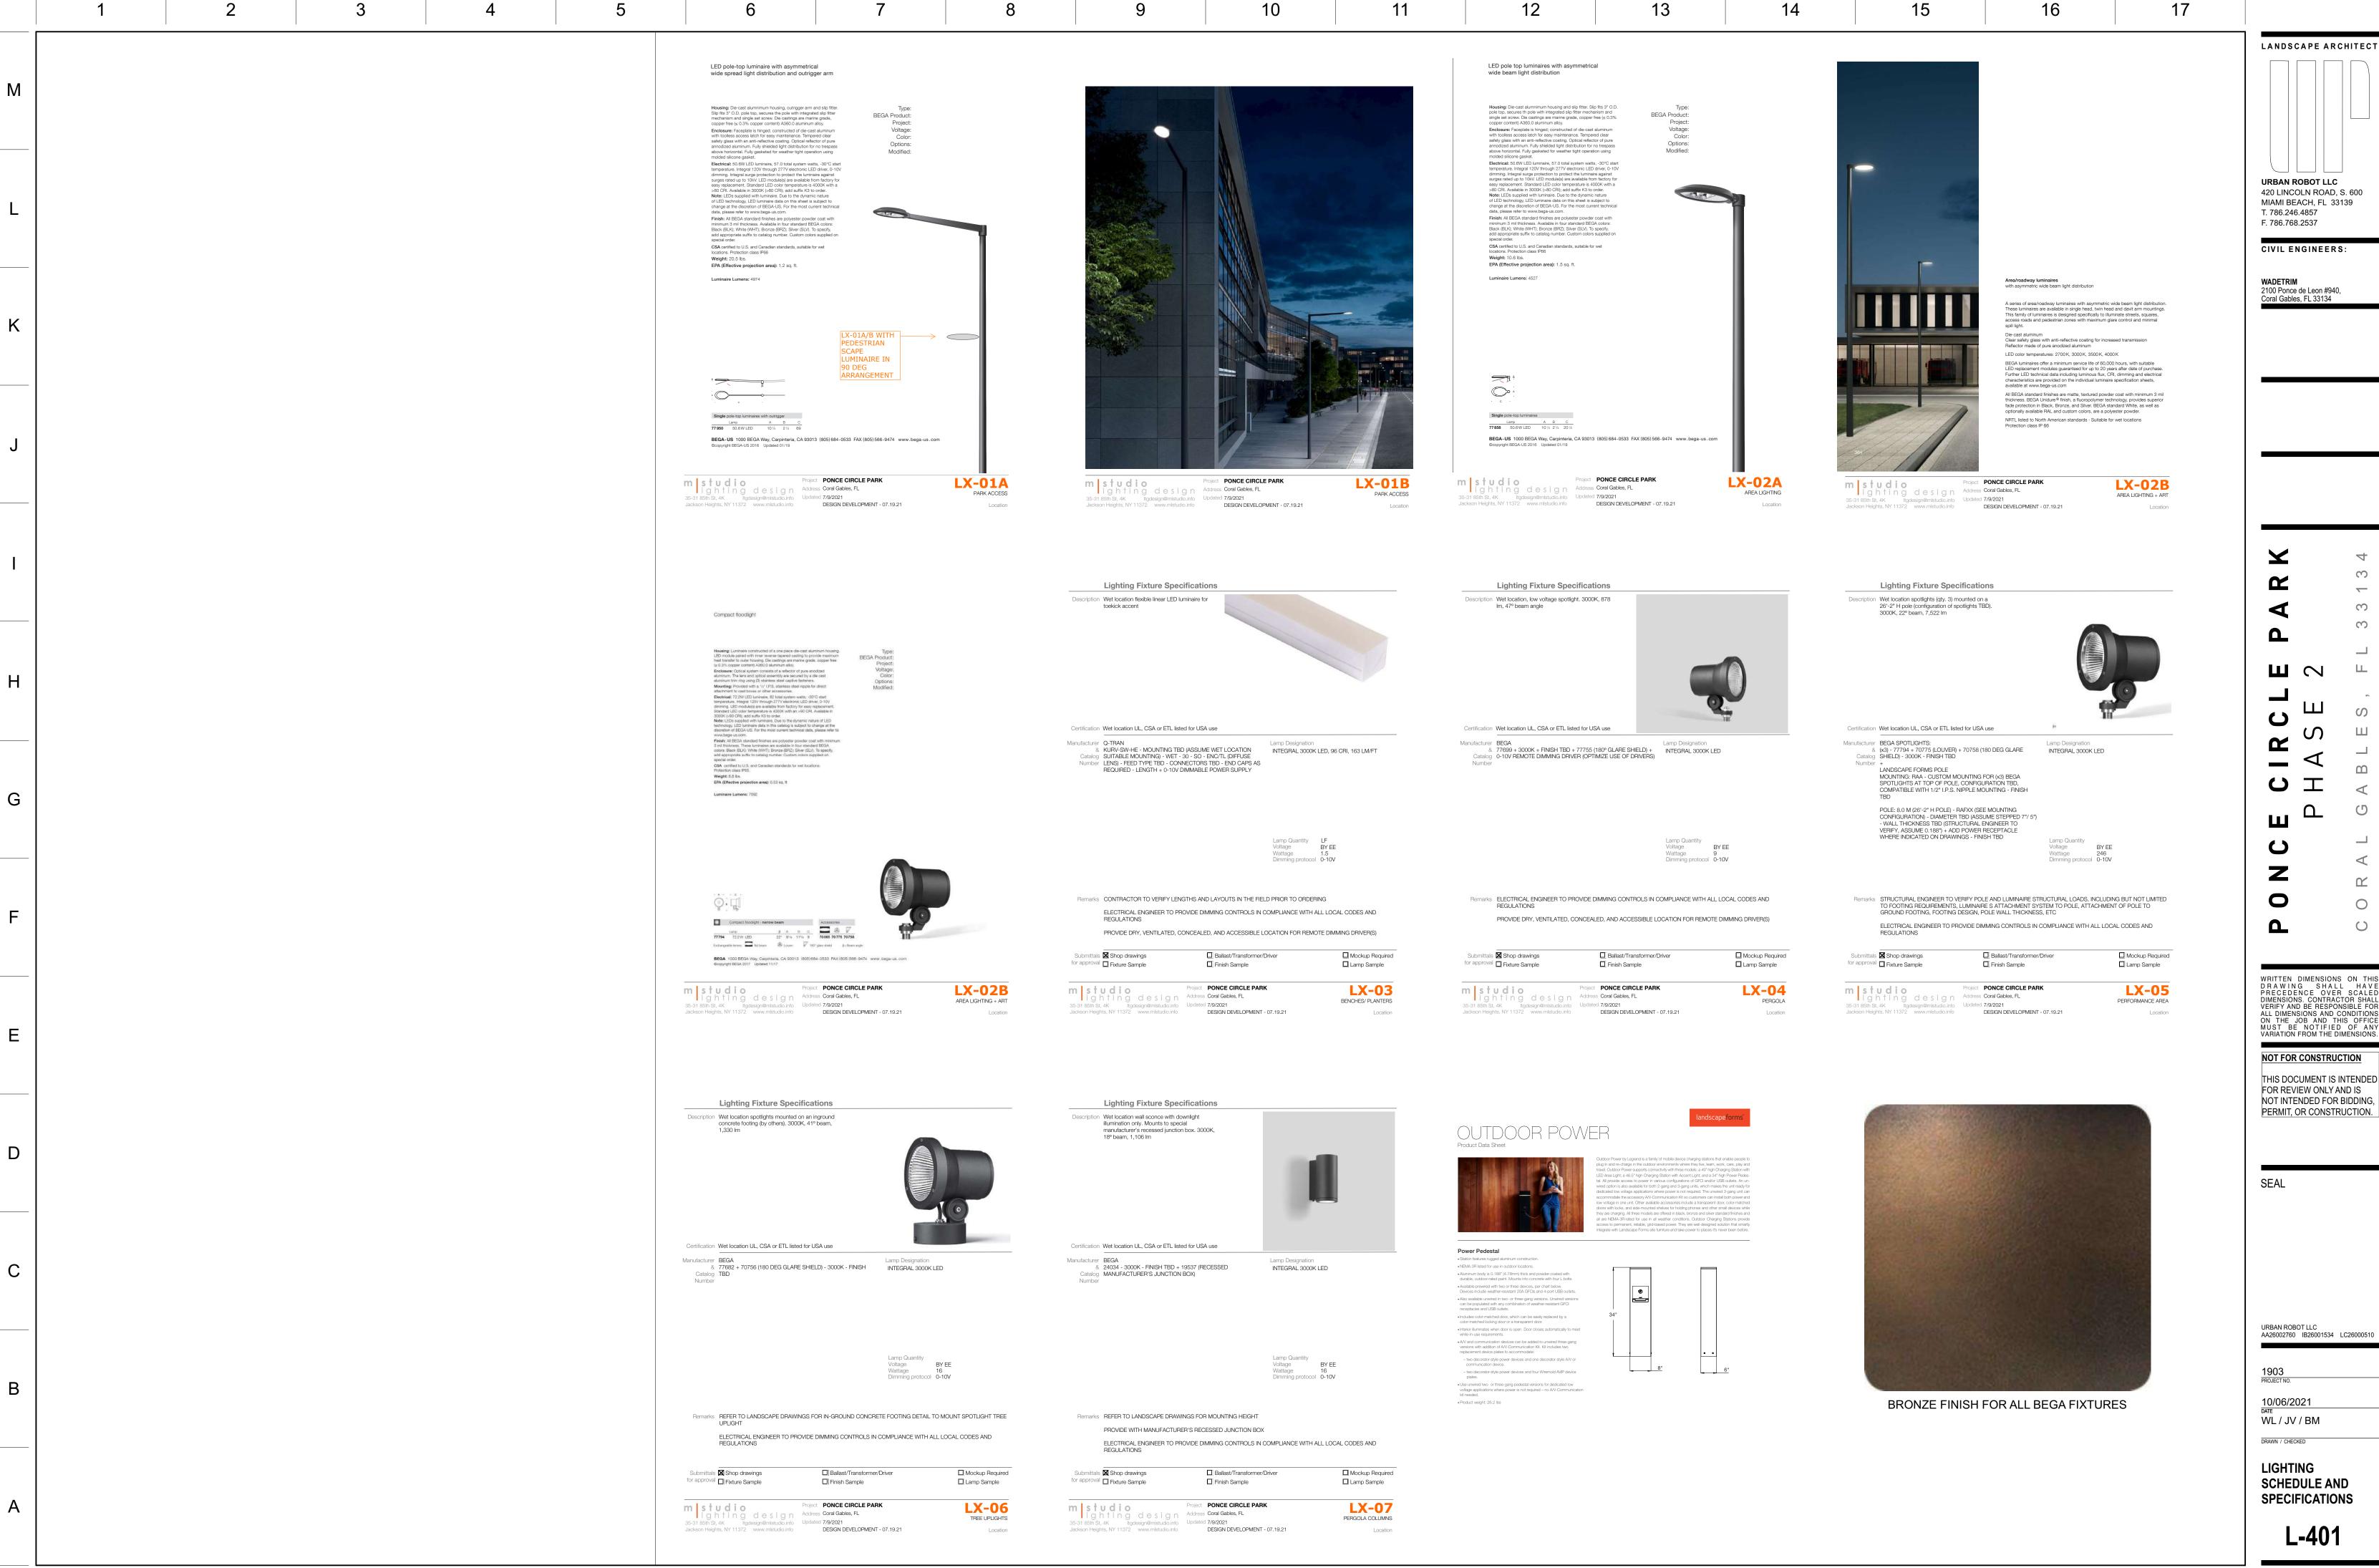

LANDSCAPE ARCHITECT URBAN ROBOT LLC 420 LINCOLN ROAD, S. 600

MIAMI BEACH, FL 33139 T. 786.246.4857 F. 786.768.2537

CIVIL ENGINEERS:

WADETRIM 2100 Ponce de Leon #940, Coral Gables, FL 33134

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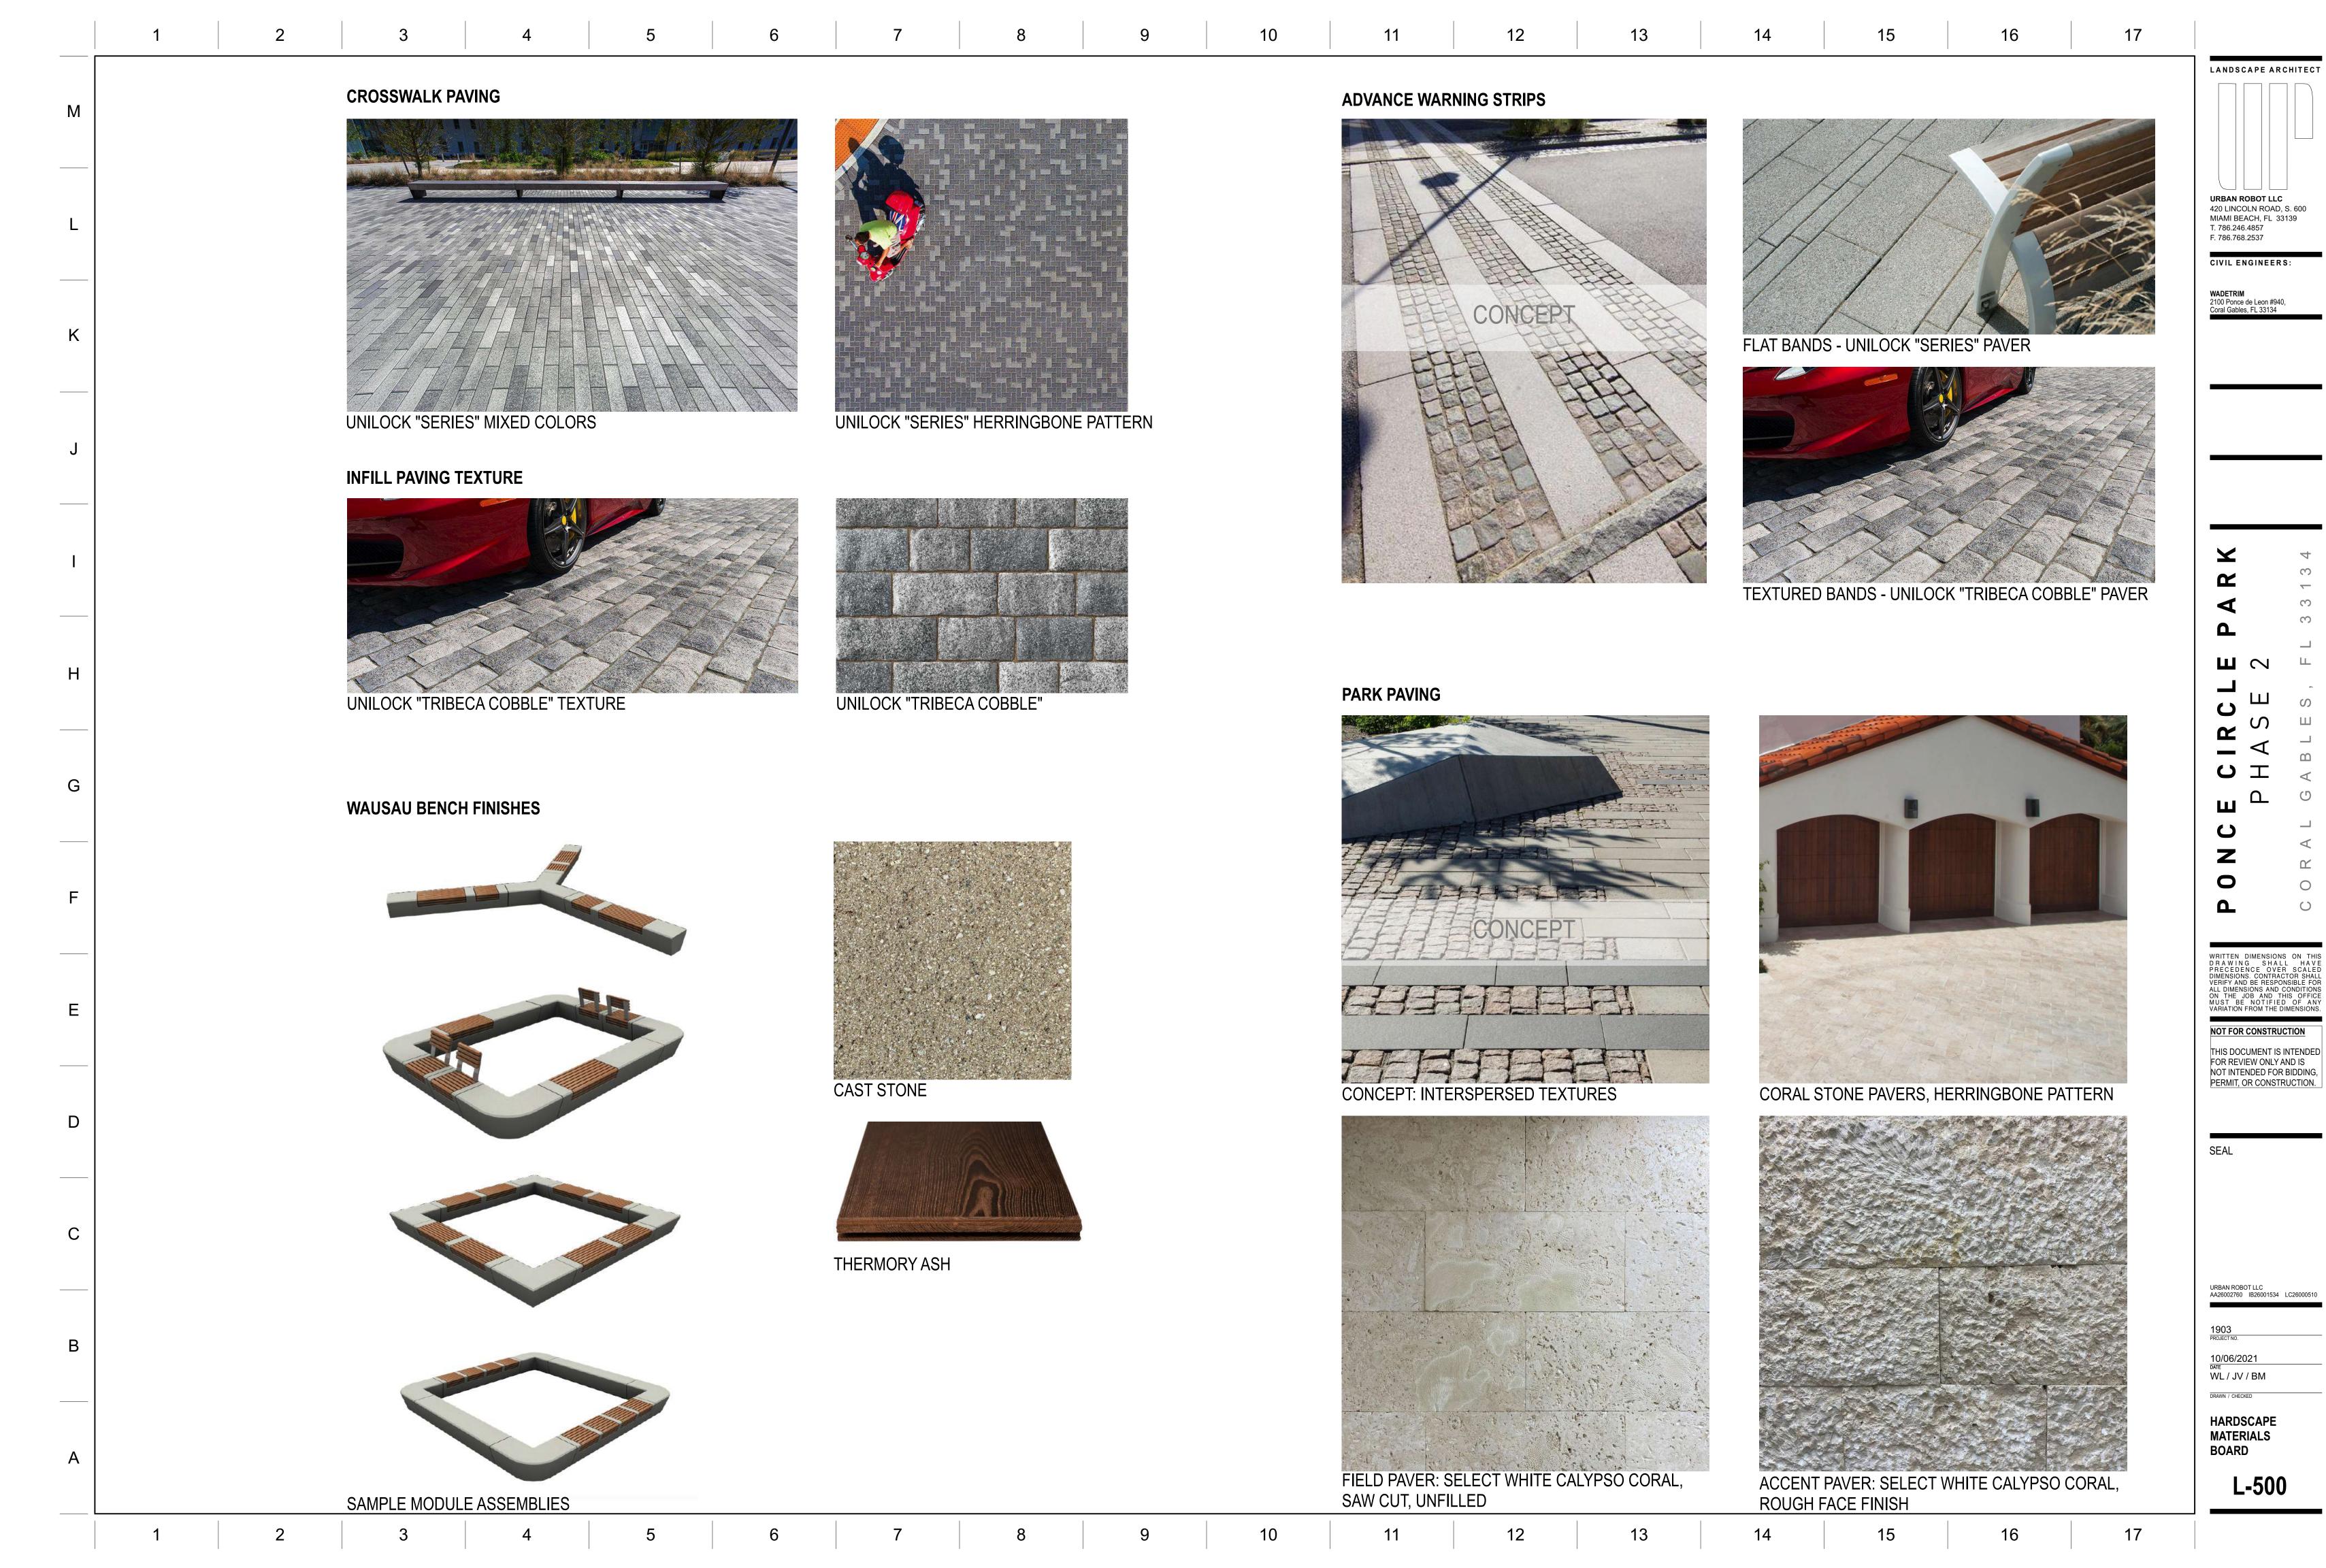
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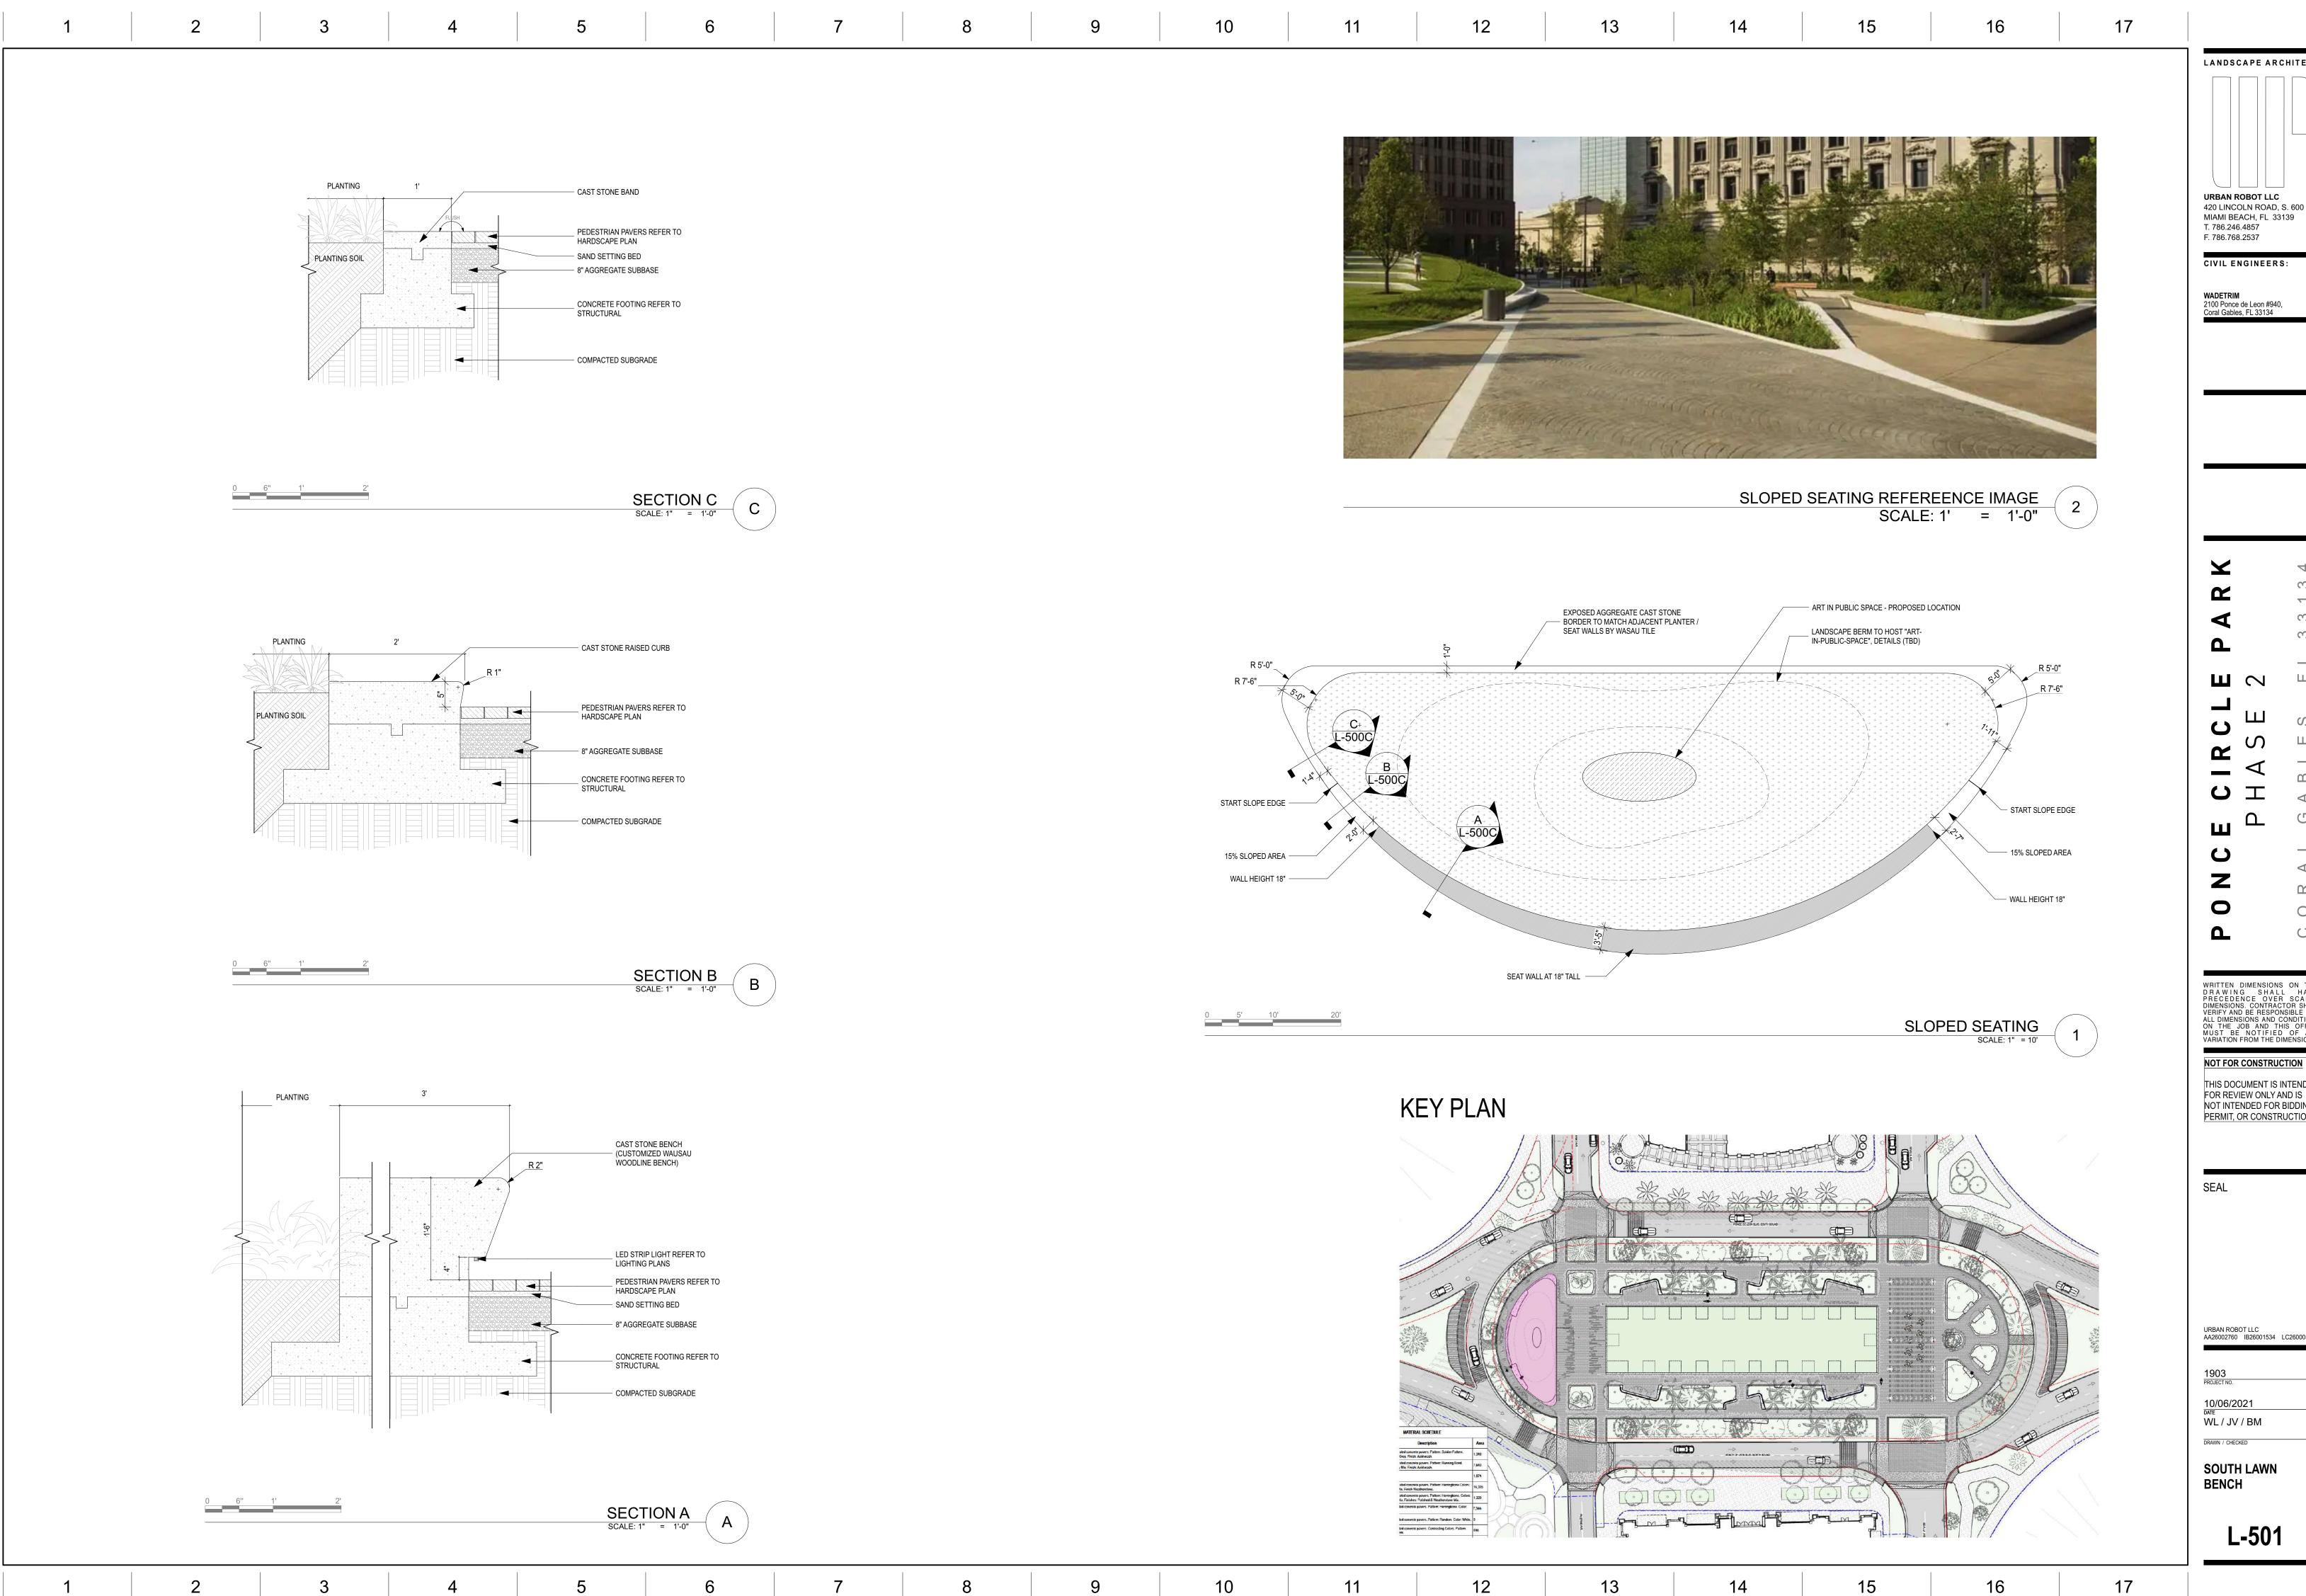
10/06/2021

WL/JV/BM DRAWN / CHECKED

LIGHTING SCHEDULE AND **SPECIFICATIONS**







LANDSCAPE ARCHITECT **URBAN ROBOT LLC**

420 LINCOLN ROAD, S. 600 MIAMI BEACH, FL 33139 T. 786.246.4857 F. 786.768.2537

CIVIL ENGINEERS:

WADETRIM 2100 Ponce de Leon #940, Coral Gables, FL 33134

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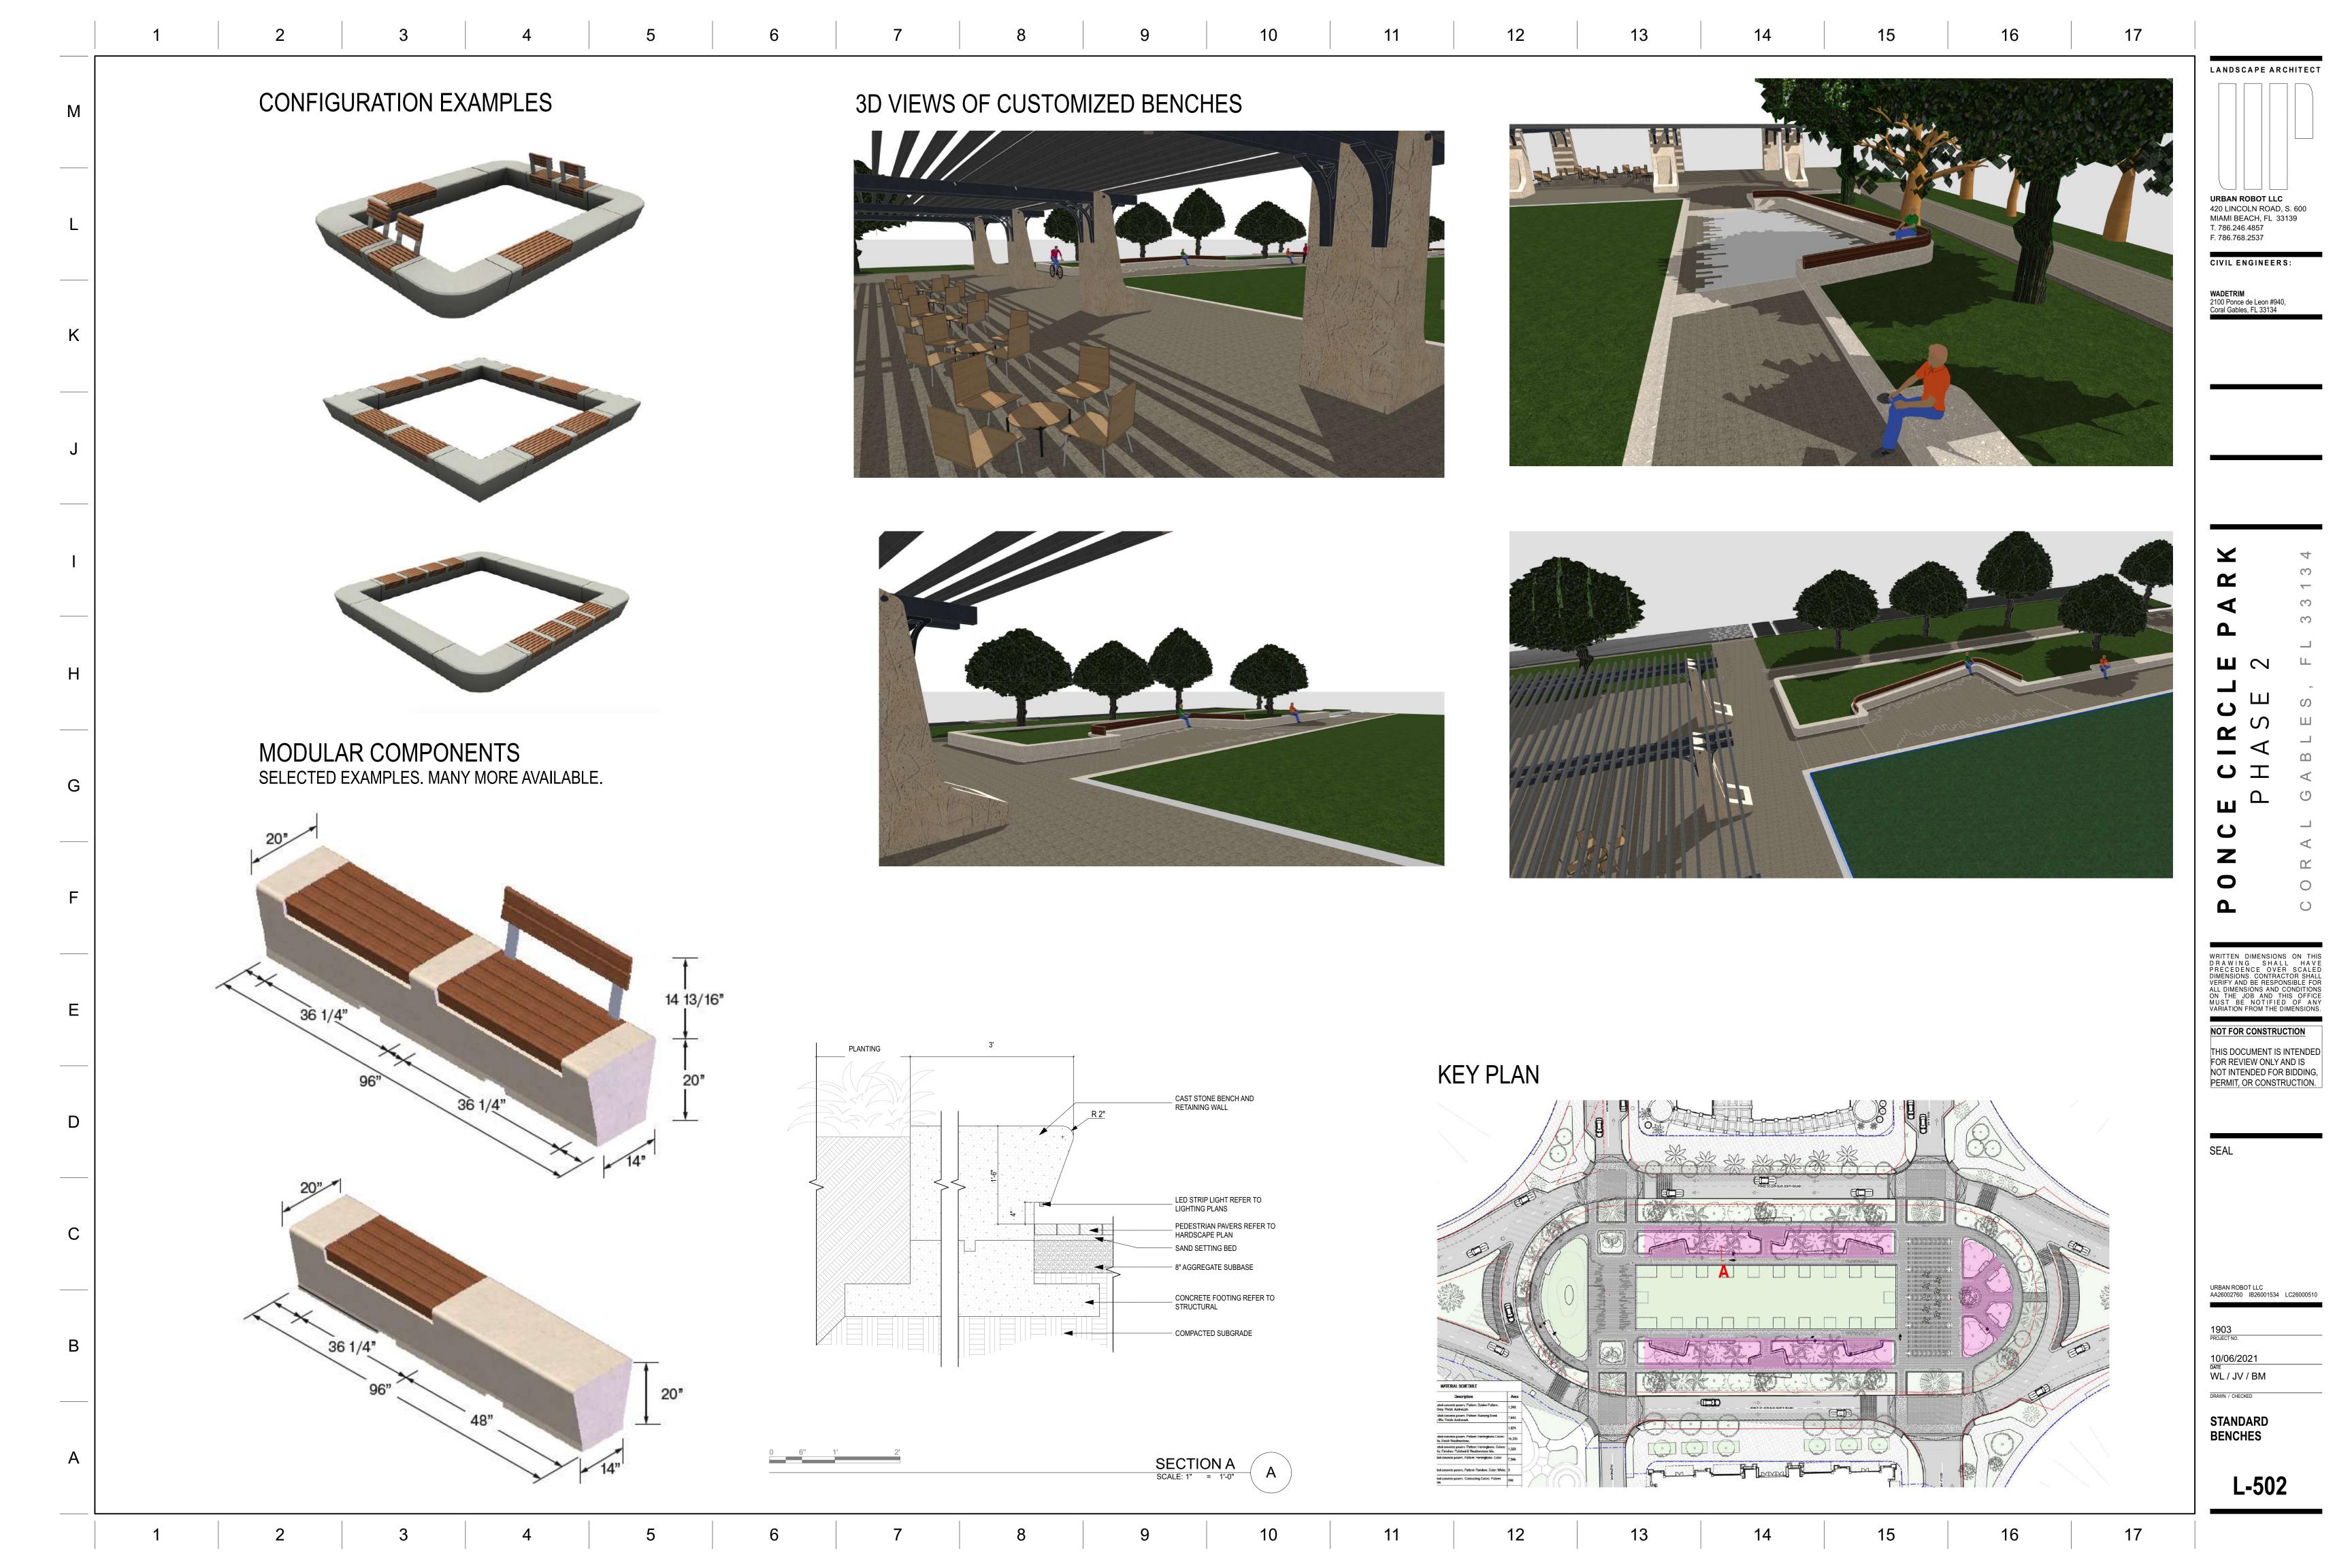
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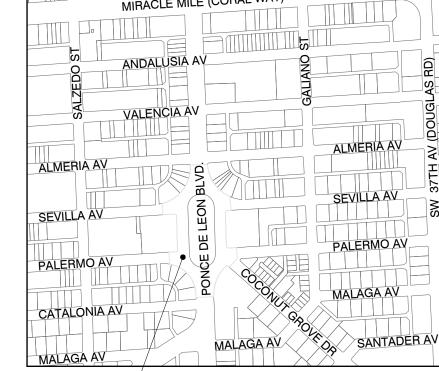
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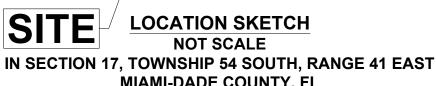
10/06/2021

WL/JV/BM DRAWN / CHECKED

SOUTH LAWN BENCH







- 1. THIS IS NOT A BOUNDARY SURVEY OR RIGHT OF WAY SURVEY. LIMITS OF SURVEY WERE DETERMINED
- 2. THIS SITE LIES IN THE SECTION 17, TOWNSHIP 54 SOUTH, RANGE 41 EAST, MIAMI-DADE COUNTY.
- 4. THE PURPOSE OF THIS RECORD SURVEY IS TO DEPICT ELEVATIONS AND TOPOGRAPHIC IMPROVEMENTS IN THE AREA WITHIN AND AROUND PONCE CIRCLE PARK (TYPICALLY TO THE BACK OF SIDEWALK), AS
- 5. RIGHT OF WAY LINES SHOWN HEREON ARE FOR REFERENCE ONLY AND ARE BASED ON PLATTED INFORMATION, PER THE REFERENCED PLATS. NO TITLE WORK, RIGHT-OF-WAY DEDICATION INFORMATION ZONED RIGHT-OF-WAY INFORMATION, OR RELEVANT DOCUMENTS WERE PROVIDED BY THE CLIENT. BEC
- 6. DIMENSIONS AND DIRECTIONS INDICATED HEREON ARE BASED ON FIELD MEASUREMENTS USING A TOTAL STATION ELECTRONIC DISTANCE MEASUREMENT (EDM) AND LEVELING INSTRUMENT, UNLESS OTHERWISE
- 7. THE ACCURACY OF SURVEY MEASUREMENTS SHOWN HEREON IS BASED ON THE TYPE OF SURVEY AND EXPECTED USE OF THE SURVEY. REDUNDANT MEASUREMENTS AND COMPUTATION RECORDS SUBSTANTIATE THE SURVEY MAP. REDUNDANCY OF MEASUREMENTS WERE OBTAINED BY MULTIPLE OCCUPATIONS OF FOUND AND SET CONTROL POINTS. THESE METHODS HAVE BEEN TESTED BY BEC AND FOUND TO HAVE AN EXPECTED ACCURACY OF \pm 0.07 FEET HORIZONTALLY, \pm 0.03 FEET VERTICALLY ON HARD SURFACES AND \pm 0.1 FEET ON GROUND SURFACES.
- 9. ELEVATIONS SHOWN HEREON ARE REFERENCED TO THE NATIONAL GEODETIC VERTICAL DATUM OF 1929
- ALUMINUM WASHER IN CONCRETE DRIVEWAY OF GAS STATION.
- ADJUSTMENT (FLORIDA EAST STATE PLANE COORDINATES IN US SURVEY FEET) AND WERE OBTAINED USING REAL TIME KINEMATIC (RTK) GLOBAL POSITION EQUIPMENT HAVING SUBCENTIMETER ACCURACY USING A TRIMBLE MODEL R8 UNIT (DUAL FREQUENCY) AND ARE REFERENCED TO THE FOLLOWING
- LONGITUDE 80° 08' 14.16764" WEST, (NAD 83 (2011) EPOCH 2010); PER FLORIDA PERMANENT REFERENCE NETWORK (FPRN) DATASHEET AS PROVIDED BY THE FLORIDA DEPARTMENT OF
- UNDERGROUND IMPROVEMENTS AND/OR UNDERGROUND ENCROACHMENTS, WHERE THEY ARE NOT VISIBLE AT SURFACE GROUND LEVEL, ARE NOT SHOWN INCLUDING BUT NOT LIMITED TO BUILDINGS, STRUCTURAL APPURTENANCES, STORM DRAINAGE SYSTEMS, UTILITIES, TANKS OR RUBBISH FILLS.
- REFERENCE AND ARE NOT SHOWN TO SCALE.
- CONSULT A CERTIFIED ARBORIST FOR VERIFICATION OF TREE SPECIES. 15. EVIDENCE OF CONSTRUCTION OR RECENT EARTH MOVING WORK WAS OBSERVED AT THE TIME OF THE
- RESTRICTIONS WITHIN THE SURVEY LIMITS. NO INFORMATION REGARDING THIS WAS PROVIDED TO THE
- 20. ALL DISTANCES ARE IN FEET AND DECIMALS THEREOF UNLESS OTHERWISE NOTED.
- 22. SEE THE STRUCTURES TABLE ON SHEET 2 OF 2.
- 23. THE CERTIFICATE OF AUTHORIZATION NUMBER OF BISCAYNE ENGINEERING COMPANY IS LB-00129.

I HEREBY CERTIFY THAT THE ATTACHED "SPECIFIC PURPOSE SURVEY" WAS PREPARED UNDER MY RESPONSIBLE CHARGE AND COMPLIES WITH THE STANDARDS OF PRACTICE FOR SURVEYING AND MAPPING AS SET FORTH BY THE STATE OF FLORIDA BOARD OF PROFESSIONAL SURVEYORS AND MAPPERS IN CHAPTER 5J-17, FLORIDA ADMINISTRATIVE CODE, PURSUANT TO CHAPTER 472.027,



THE OFFICIAL RECORD OF THIS SHEET IS THE ELECTRONIC FILE DIGITALLY SIGNED AND SEALED UNDER RULE 5J-17-062, F.A.C. THIS ITEM HAS BEEN DIGITALLY SIGNED . PRINTED COPIES OF THI DOCUMENT ARE NOT CONSIDERED SIGNED AND SEALED AND THE

03-87131

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MIRACLE MILE (CORAL WAY)

MIAMI-DADE COUNTY, FL **SURVEYOR'S NOTES:**

- 3. ADDRESS OF PONCE CIRCLE PARK IS 2810 PONCE DE LEON BLVD, CORAL GABLES, FL 33134 ACCORDING TO THE PROPERTY APPRAISER'S WEBSITE AND IS SHOWN FOR REFERENCE ONLY.
- DETERMINED BY THE CLIENT AND SHOWN HEREON.
- MAKES NO STATEMENT OF OWNERSHIP

- 8. LANDS SHOWN HEREON ARE LOCATED IN FEDERAL FLOOD ZONE "X", PER FIRM MAP NUMBER 12086C0457, SUFFIX L, COMMUNITY NAME: CITY OF CORAL GABLES, COMMUNITY NUMBER: 120639, EVISED: SEPTEMBER 11, 2009, "X" AREAS DETERMINED TO BE OUTSIDE THE 0.2% ANNUAL CHANGE
- ELEVATIONS ARE BASED UPON THE FOLLOWING MIAMI-DADE BENCHMARKS:
- I) P-711 ELEVATION = 13.62 FEET (NGVD-29), LOCATED 30 FEET NORTH OF THE CENTERLINE OF ROMANO AVE, 54 FEET EAST OF THE CENTERLINE OF PONCE DE LEON BLVD., PK NAIL AND ALUMINU II) P-710 ELEVATION = 14.21 FEET (NGVD-29), LOCATED 61 FEET NORTH OF THE CENTERLINE OF SOUTHWETS 40TH STREET, 39 FEET EAST OF THE CENTERLINE OF PONCE DE LEON BLVD., PK NAIL AND
- SITE NAME: MIAMI BEACH; SITE CODE: FLMB; GEODETIC POSITION: LATITUDE 25° 46' 57.83786"NORTH
- 12. UNDERGROUND UTILITIES SHOWN HEREON WERE MARKED BY INFRAMAP CORPORATION ON 6/28/2021 (INFRAMAP PROJECT NUMBER PF21010) AND LOCATED BY BISCAYNE ENGINEERING.
- 13. THE LOCATIONS OF VISIBLE UTILITIES WERE SURVEYED; HOWEVER, SYMBOLS SHOWN HEREON ARE FOR 14. TREES SHOWN HEREON WERE LOCATED AND IDENTIFIED TO THE BEST OF OUR ABILITY; CLIENT SHOULD
- 16. NO BUILDINGS OR SUB-SURFACE FOUNDATIONS HAVE BEEN LOCATED AS PART OF THIS RECORD SURVEY (SURROUNDING BUILDINGS ARE REFERENCED WHERE THEY WERE OBSERVED).
- 17. THIS RECORD SURVEY IS SUBJECT TO ANY FACTS THAT MAY BE DISCLOSED BY A FULL AND ACCURATE 18. THIS RECORD SURVEY DOES NOT MAKE ANY REPRESENTATIONS AS TO ZONING OR DEVELOPMENTS
- 19. ALL NOTED RECORDED REFERENCES ARE FROM THE PUBLIC RECORDS OF MIAMI-DADE COUNTY.
- 21. THERE MAY BE ADDITIONAL RESTRICTIONS AFFECTING THIS PROPERTY FOUND IN THE LAWS OF CORAL
- GABLES, MIAMI-DADE COUNTY, AND THE STATE OF FLORIDA.

SURVEYOR'S CERTIFICATE:

NOT VALID WITHOUT THE ORIGINAL SIGNATURE AND SEAL OF A FLORIDA LICENSED SURVEYOR AND


BISCAYNE ENGINEERING COMPANY, INC. 529 WEST FLAGLER STREET, MIAMI, FL. 33130 (305) 324-7671 STATE OF FLORIDA DEPARTMENT OF AGRICULTURE

SPECIFIC PURPOSE SURVEY DATE: 07-01-2021



Digitally signed by Alberto J Rabionet 21:50:38 -04'00'

SIGNATURE MUST BE VERIFIED ON ANY ELECTRONIC COPIES.

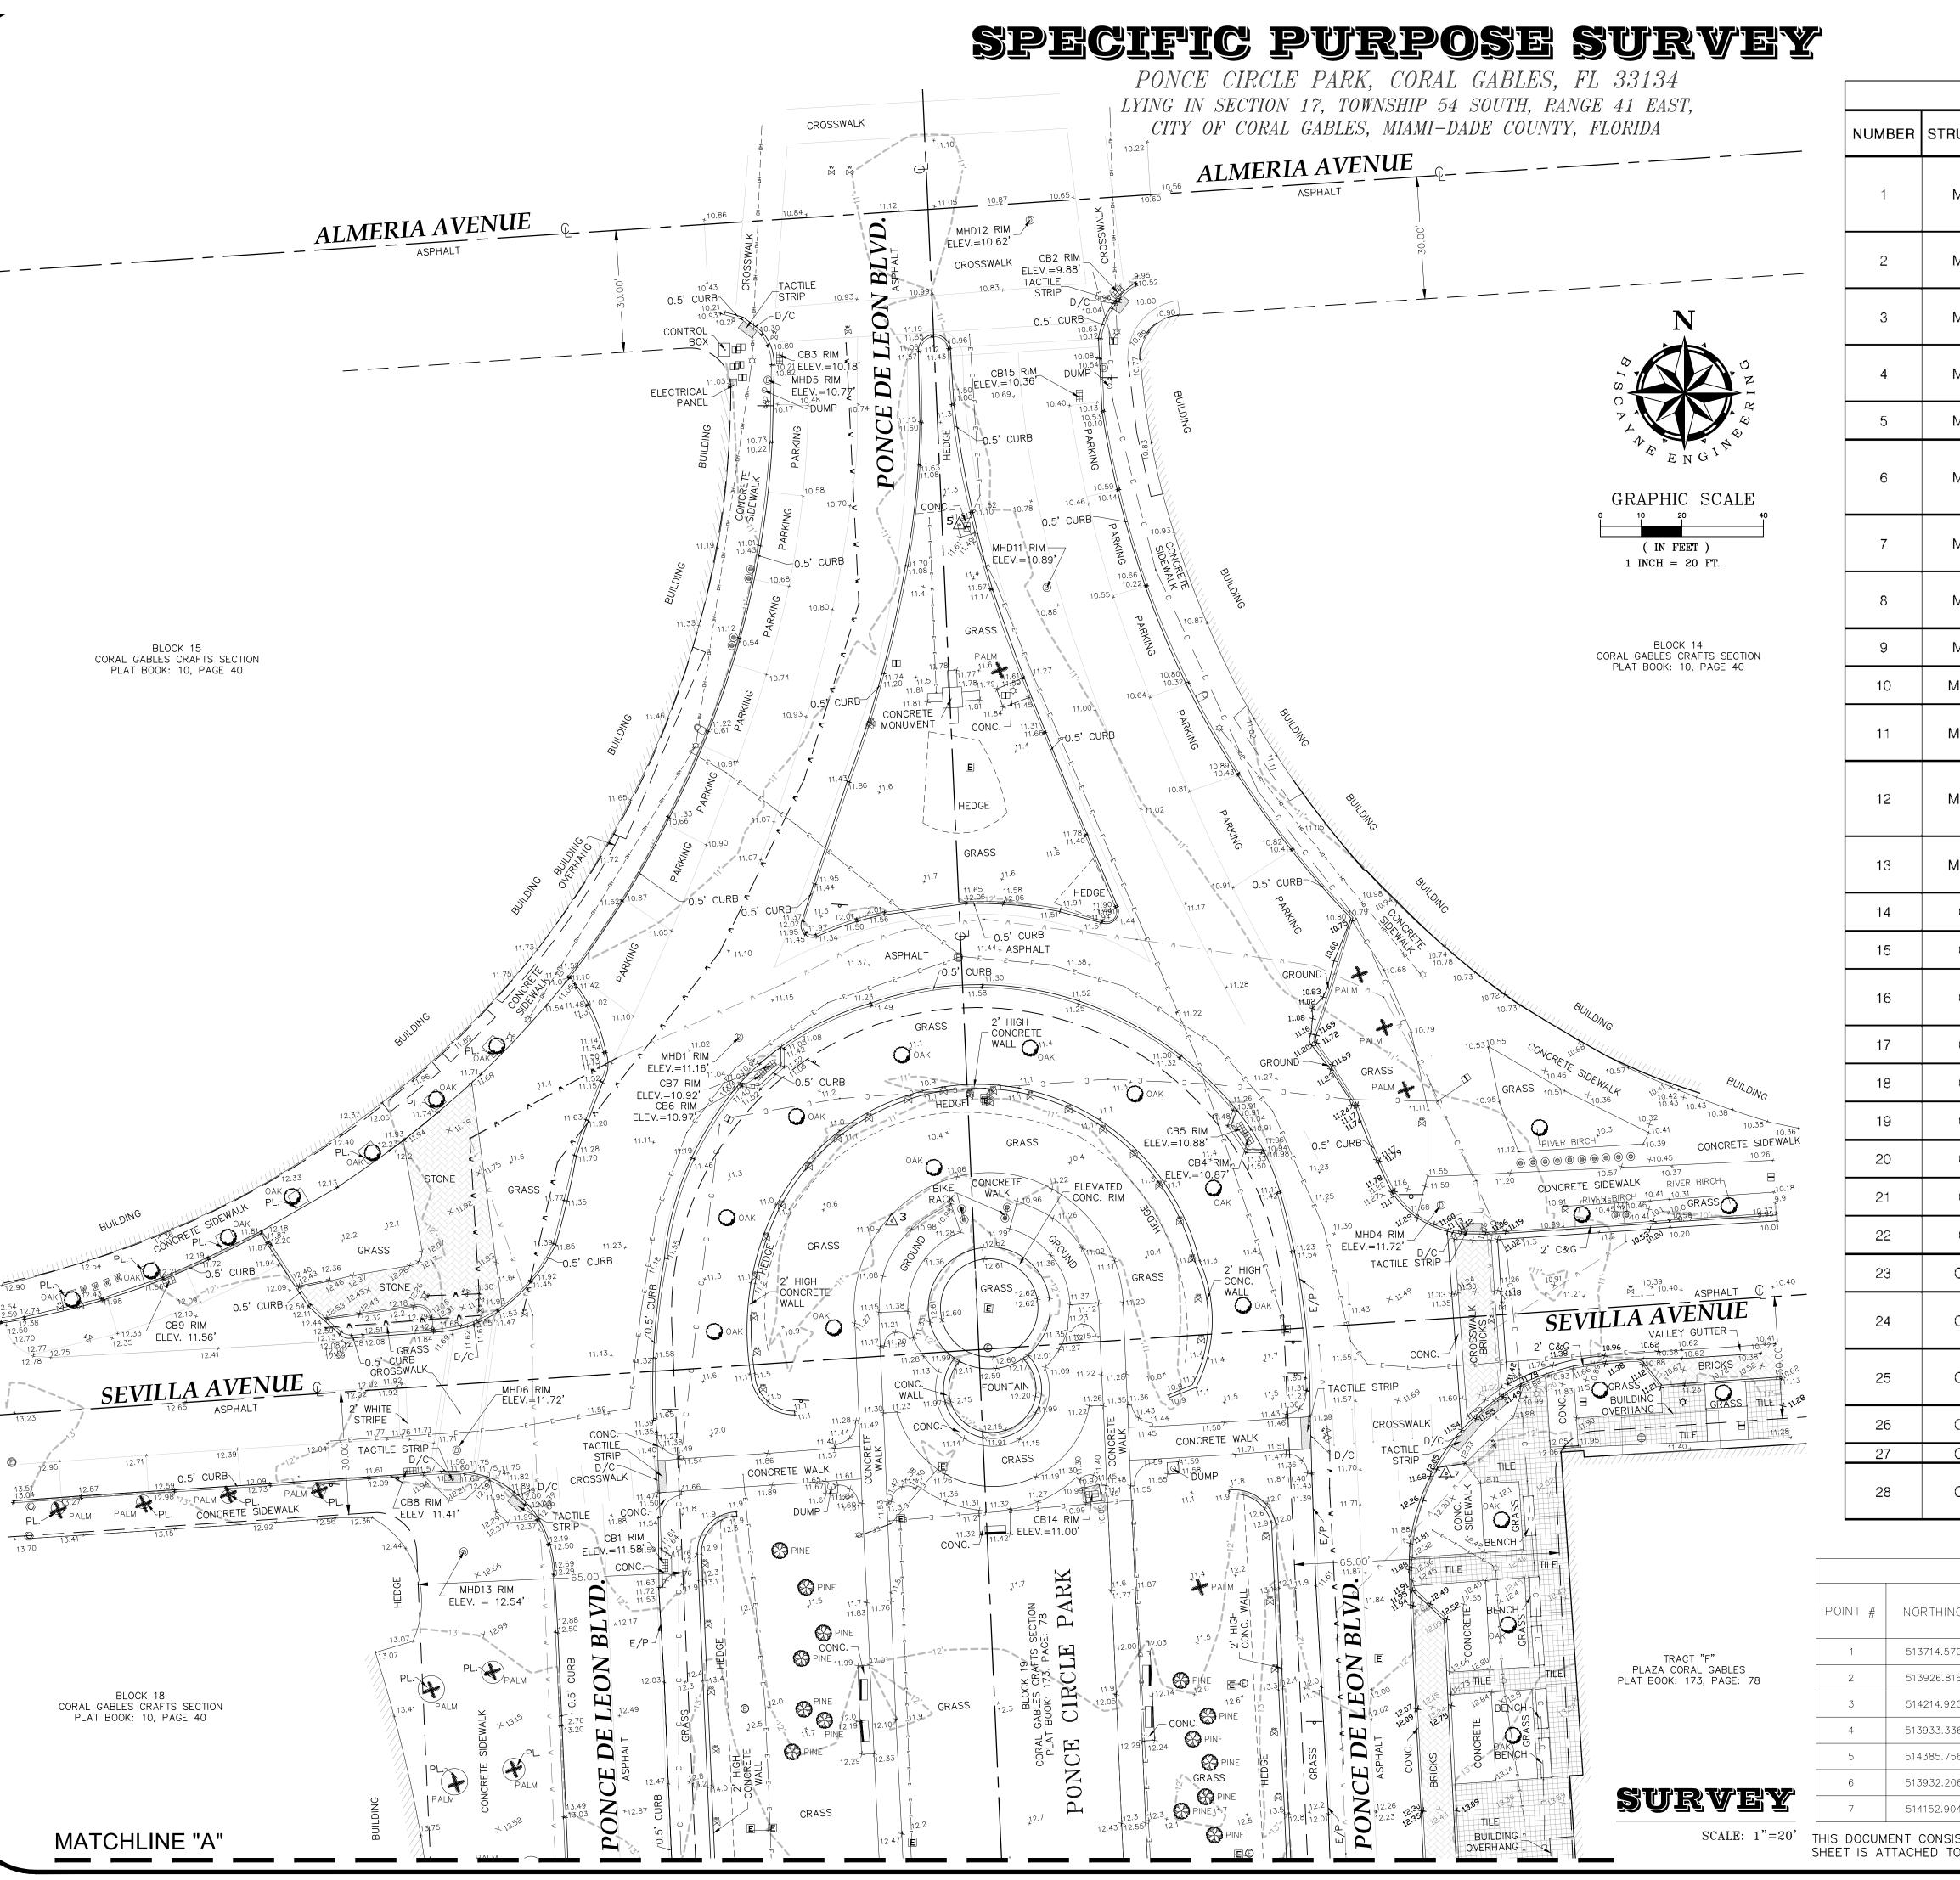

		RIM ELEV	INVERT ELEV	PIPE DIAM	MATERIAL	DIRECTION	
NUMBER	STRUCTURE	(FEET)	(FEET)	(INCH)	WALLETTAL	DITECTION	
		(1 221)	7.55	(111011)		BOTTOM	
1	MHD1	11.16	7.61	12	CONCRETE	NORTHEAST	
I	IVII ID I	11.10	7.58	12	CONCRETE	SOUTH	
			7.61	12	CONCRETE	SOUTHWEST	
			2.30			BOTTOM	
2	MHD2	16.11	2.76	36	TRENCH	NORTH	
	1		2.30	36	TRENCH	SOUTHEAST	
3	MHD3	14.83	2.38	36		BOTTOM SOUTHWEST	
J	IVIIIDS	14.03	2.38	36		NORTHWEST	
			0.27	30		BOTTOM	
4	MHD4	11.72	0.34	36	TRENCH	NORTH	
			0.34	36	TRENCH	SOUTH	
5	MHD5	10.77	5.44			BOTTOM	
5	IVINUS	10.77	6.39			EAST	
			8.04			BOTTOM	
6	MHD6	11.72	8.04	12	CONCRETE	NORTHEAST	
Ü		· · · · · -	8.26	12	CONCRETE	SOUTH	
			8.27	12	PVC	SOUTHWEST	
7	MUD7	15.00	8.40	10	PVC	BOTTOM	
7	MHD7	15.93	10.32 11.98	12 12	CONCRETE	NORTH EAST	
			10.10	12	CONCILIE	BOTTOM	
8	MHD8	15.83	11.83	12	PVC	SOUTHEAST	
U	1711 123	10.00	11.97	12	PVC	WEST	
	14150	15.50	10.06			BOTTOM	
9	MHD9	15.59	11.44	12	CONCRETE	WEST	
10	MHD10	14.36	10.26			BOTTOM	
10	MINDIO	14.30	10.54	12	CONCRETE	NORTH	
			1.94			BOTTOM	
11	MHD11	10.89	1.94	36	TRENCH	NORTH	
			1.94	36	TRENCH	SOUTH	
			-0.48		TDENOU	BOTTOM	
12	MHD12	10.62	0.48	36	TRENCH	NORTH	
			4.19 0.13	24 36	TRENCH TRENCH	EAST SOUTH	
				8.87	30	INCII	BOTTOM
13	MHD13	12.54	8.89	12	CONCRETE	NORTH	
, ,		, =, 0	8.57	12	CONCRETE	EAST	
	OD4	44.50	9.13			воттом	
14	CB1	11.58	9.14	12	CONCRETE	WEST	
15	CB2	9.88	6.25			BOTTOM	
10	Obz	9.00	6.38	15	CONCRETE	NORTHWEST	
				6.36			BOTTOM
16	CB3	10.18	6.40	15	CONCRETE	NORTHEAST	
			6.51	15	CONCRETE	SOUTHWEST	
17	CB4	10.87	6.71	10	CONODETE	BOTTOM	
			6.73	12	CONCRETE	NORTHEAST	
18	CB5	10.88	6.72 6.74	12	CONCRETE	BOTTOM NORTHEAST	
			6.80	14	OUNCELE	BOTTOM	
19	CB6	10.97	7.79	12	CONCRETE	NORTHWEST	
			7.74		CONTRACTOR	BOTTOM	
20	CB7	10.92	6.75	12	CONCRETE	NORTHWEST	
01	CDA	44 84	8.55	12	PVC	EAST	
21	CB8	11.41	8.41	12	PVC	WEST	
22	CB9	11.56	8.18			BOTTOM	
دد		11.00	8.18	12	CONCRETE	SOUTHEAST	
23	CB10	15.46	9.36			BOTTOM	
			11.46	15	CONCRETE	SOUTHWEST	
0.4	0044	450.	9.04	4,	DIACTIC	BOTTOM	
24	CB11	15.34	12.20	14	PLASTIC PLASTIC	NORTH	
			10.73 9.76	14	PLASTIC	SOUTH BOTTOM	
25	CB12	14.26	9.76	12	CONCRETE	SOUTHEAST	
25		14.20	9.81	12	CONCRETE	NORTHWEST	
		. –	7.52	1 -	CONTRIL	BOTTOM	
26	CB13	12.15	7.83	12	CONCRETE	EAST	
27	CB14	11.00	4.67	. —		BOTTOM	
			1.16			воттом	
28	CB15	10.36	6.36	15	PLASTIC	NORTHEAST	
		l	5.91	18	PLASTIC	SOUTH	

PROJECT CONTROLS POINTS

	HORIZONTAL AND VERTICAL CONTROL NETWORK											
POINT #	NORTHING(')	EASTING(')	LATITUDE	LONGITUDE	NGVD-29 ELEVATION (')	DESCRIPTION						
1	513714.5702	900303.7097	N25° 44′ 42.17"	W80° 15′ 29.90″	16.10	FND N&W BEC 0129						
2	513926.8168	900178.3387	N25° 44′ 44.28″	W80° 15′ 31.26″	15.64	FND N&W BEC 0129						
3	514214.9200	900214.7240	N25° 44′ 47.13″	W80° 15′ 30.85″	11.08	FND N&W BEC 0129						
4	513933.3360	900305.6980	N25° 44′ 44.34″	W80° 15' 29.87"	14.84	FND N&W BEC 0129						
5	514385.7564	900231.3627	N25° 44′ 48.82″	W80° 15′ 30.65″	11.66	SET N&W BEC 0129						
6	513932.2060	900363.0700	N25° 44′ 44.32″	W80° 15' 29.24"	14.75	SET N&W BEC 0129						
7	514152.9040	900350.7260	N25° 44′ 46.51″	W80° 15' 29.36"	12.16	SET N&W BEC 0129						

SCALE: 1"=20' THIS DOCUMENT CONSISTS OF TWO (2) SHEETS AND SHALL NOT BE CONSIDERED FULL, VALID, AND COMPLETE UNLESS EACH SHEET IS ATTACHED TO THE OTHERS.

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