
301-341 MADEIRA AVE

301-341 MADEIRA AVE CORAL GABLES, FLORIDA

BEHAR·FONT

PARCHITECTURE • PLANNING • INTERIORS

CORAL GABLES • ATLANTA

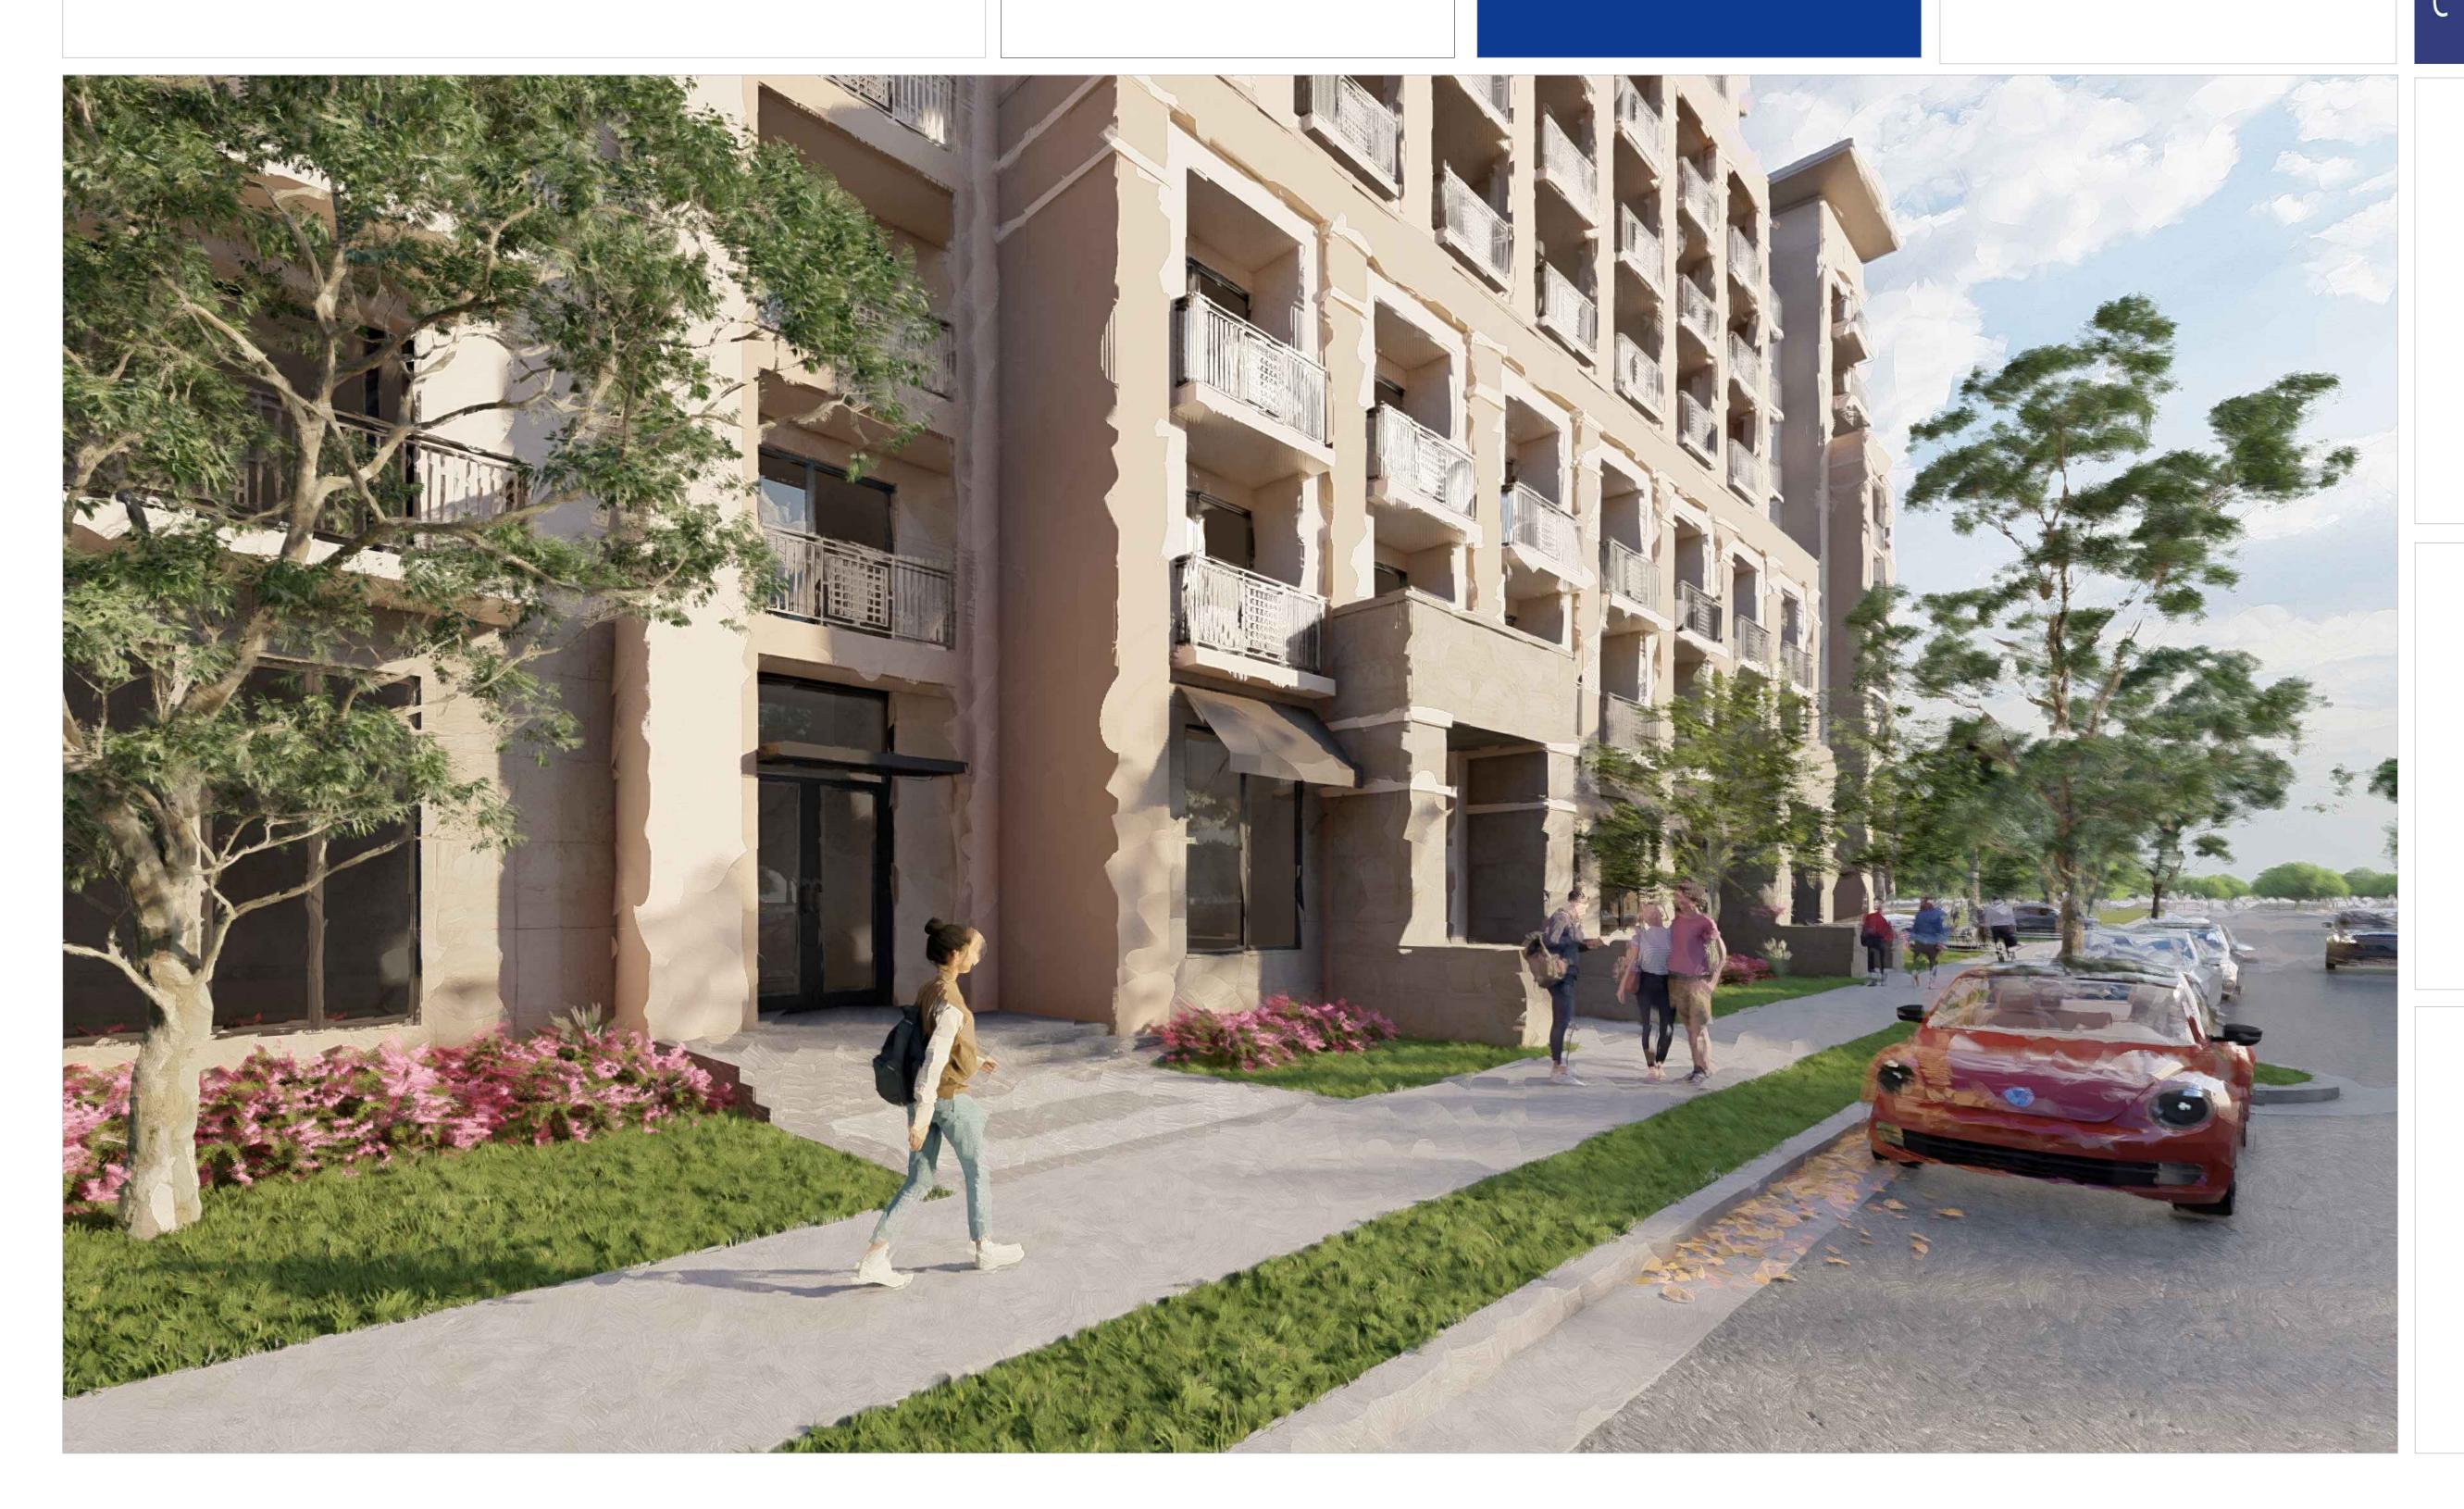



A - 0.0	COVER
A - 0.01	INDEX
CP - 1.0	LOCATION PLAN
CP - 1.01	MIAMI-DADE COUNTY AND CITY OF CORAL GABLES ZONING
CP - 1.1	SITE CONTEXT
	SURVEY
A - 0.1	MASSING CONTEXT 1
A - 0.1.1	MASSING CONTEXT 2
A - 0.1.2	MASSING CONTEXT 3
A - 0.1.3	PERIMETER HEIGHT CONTEXT
A - 0.1.4	APPROVED PROJECTS
A - 0.1.5	MEDITERRANEAN BONUS
A - 0.1.6	MEDITERRANEAN BONUS - TABLE 1
A - 0.1.7	MEDITERRANEAN BONUS - TABLE 1
A - 0.1.8	MEDITERRANEAN BONUS - TABLE 2
A - 0.1.9	MEDITERRANEAN BONUS - TABLE 2
A - 0.1.10	HISTORICAL REFERENCE
A - 0.1	ZONING
A - 0.2	LOT COVERAGE
A - 0.3	F.A.R DIAGRAMS
R - 1.0	RENDERING 1
R - 1.1	RENDERING 2
R - 1.2	RENDERING 3
R - 1.3	RENDERING 4
R - 1.4	RENDERING 5
R - 1.5	RENDERING 6
R - 1.6	RENDERING 7
R - 1.7	RENDERING 8
A - 1.0	SITE PLAN
A - 1.1	GROUND FLOOR PLAN
A - 1.2	2ND FLOOR PLAN
A - 1.3	3RD FLOOR PLAN
A - 1.4	4TH FLOOR PLAN (AMENITIES DECK)
A - 1.5	5TH FLOOR PLAN
A - 1.6	6TH FLOOR PLAN
A - 1.7	7TH FLOOR PLAN
A - 1.8	8TH FLOOR PLAN
A - 1.9	9TH FLOOR PLAN
A - 2.0	SOUTH ELEVATION
A - 2.1	EAST & WEST ELEVATIONS
A - 2.2	NORTH ELEVATION
A - 3.0	MATERIALS BOARD
L - 1	LANDSCAPE PLAN GROUND FLOOR
L - 2	LANDSCAPE PLAN RECREATIONAL FLOOR



ROBERT BEHAR AR No. 14339

301-341 MADEIRA AVE CORAL GABLES, FLORIDA 33134

⚠ REV. 07-26-2021 **A** REV. 01-28-2021 ⚠ REV. 12-15-2020


DATE: 10-22-2021 PROJECT NO: 18-035 DRAWING NAME: SHEET NO: A-0.01

INDEX

\$\hlimin{a}{2} \hlimin{A}{2} \hlimin{

Mendoza Ave Mendoza Ave Consulate of Belize Zamora Ave Minuteman Press 😩 SW 16th Terrace SW 422nd Awa 301 Madeira Avenue Madelia Ave Madeira Ave

ROBERT BEHAR AR No. 14339

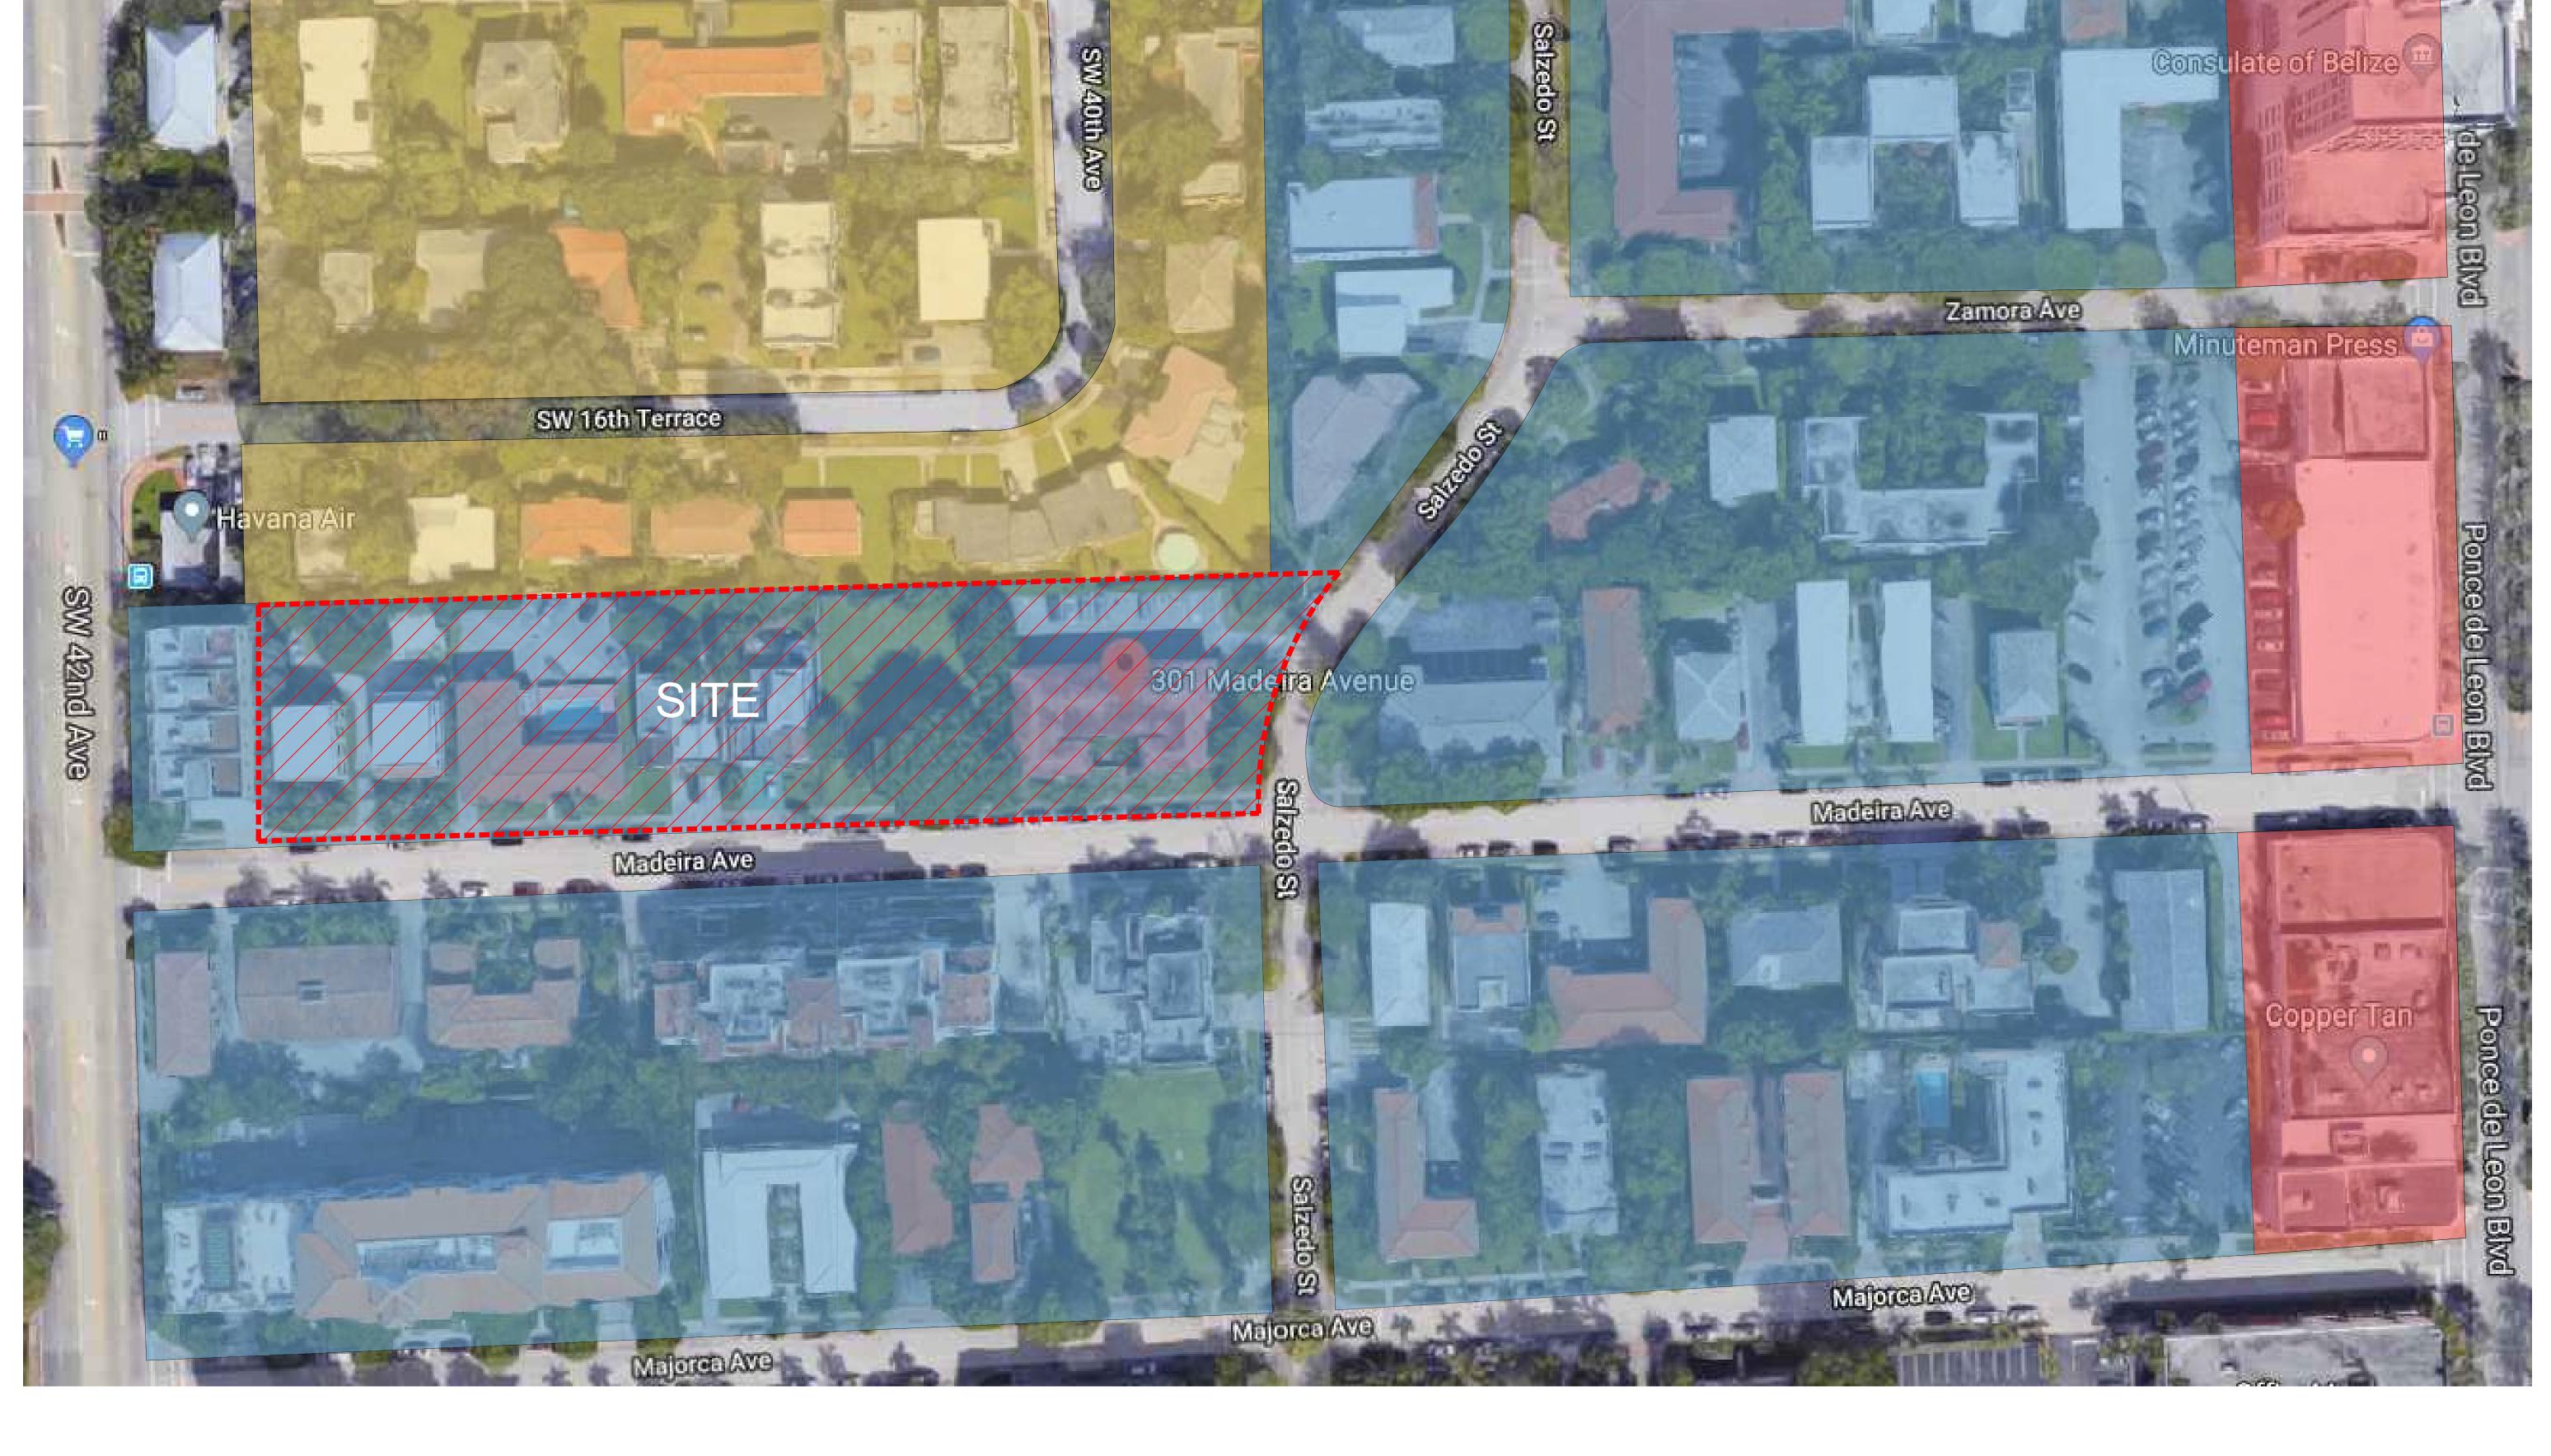

Mendoza/Ave

Mendoza Ave

MIAMI-DADE COUNTY ZONING:

CITY OF CORAL GABLES ZONING:


RU-3 (40' MAX. HEIGHT)




MF2




MX3

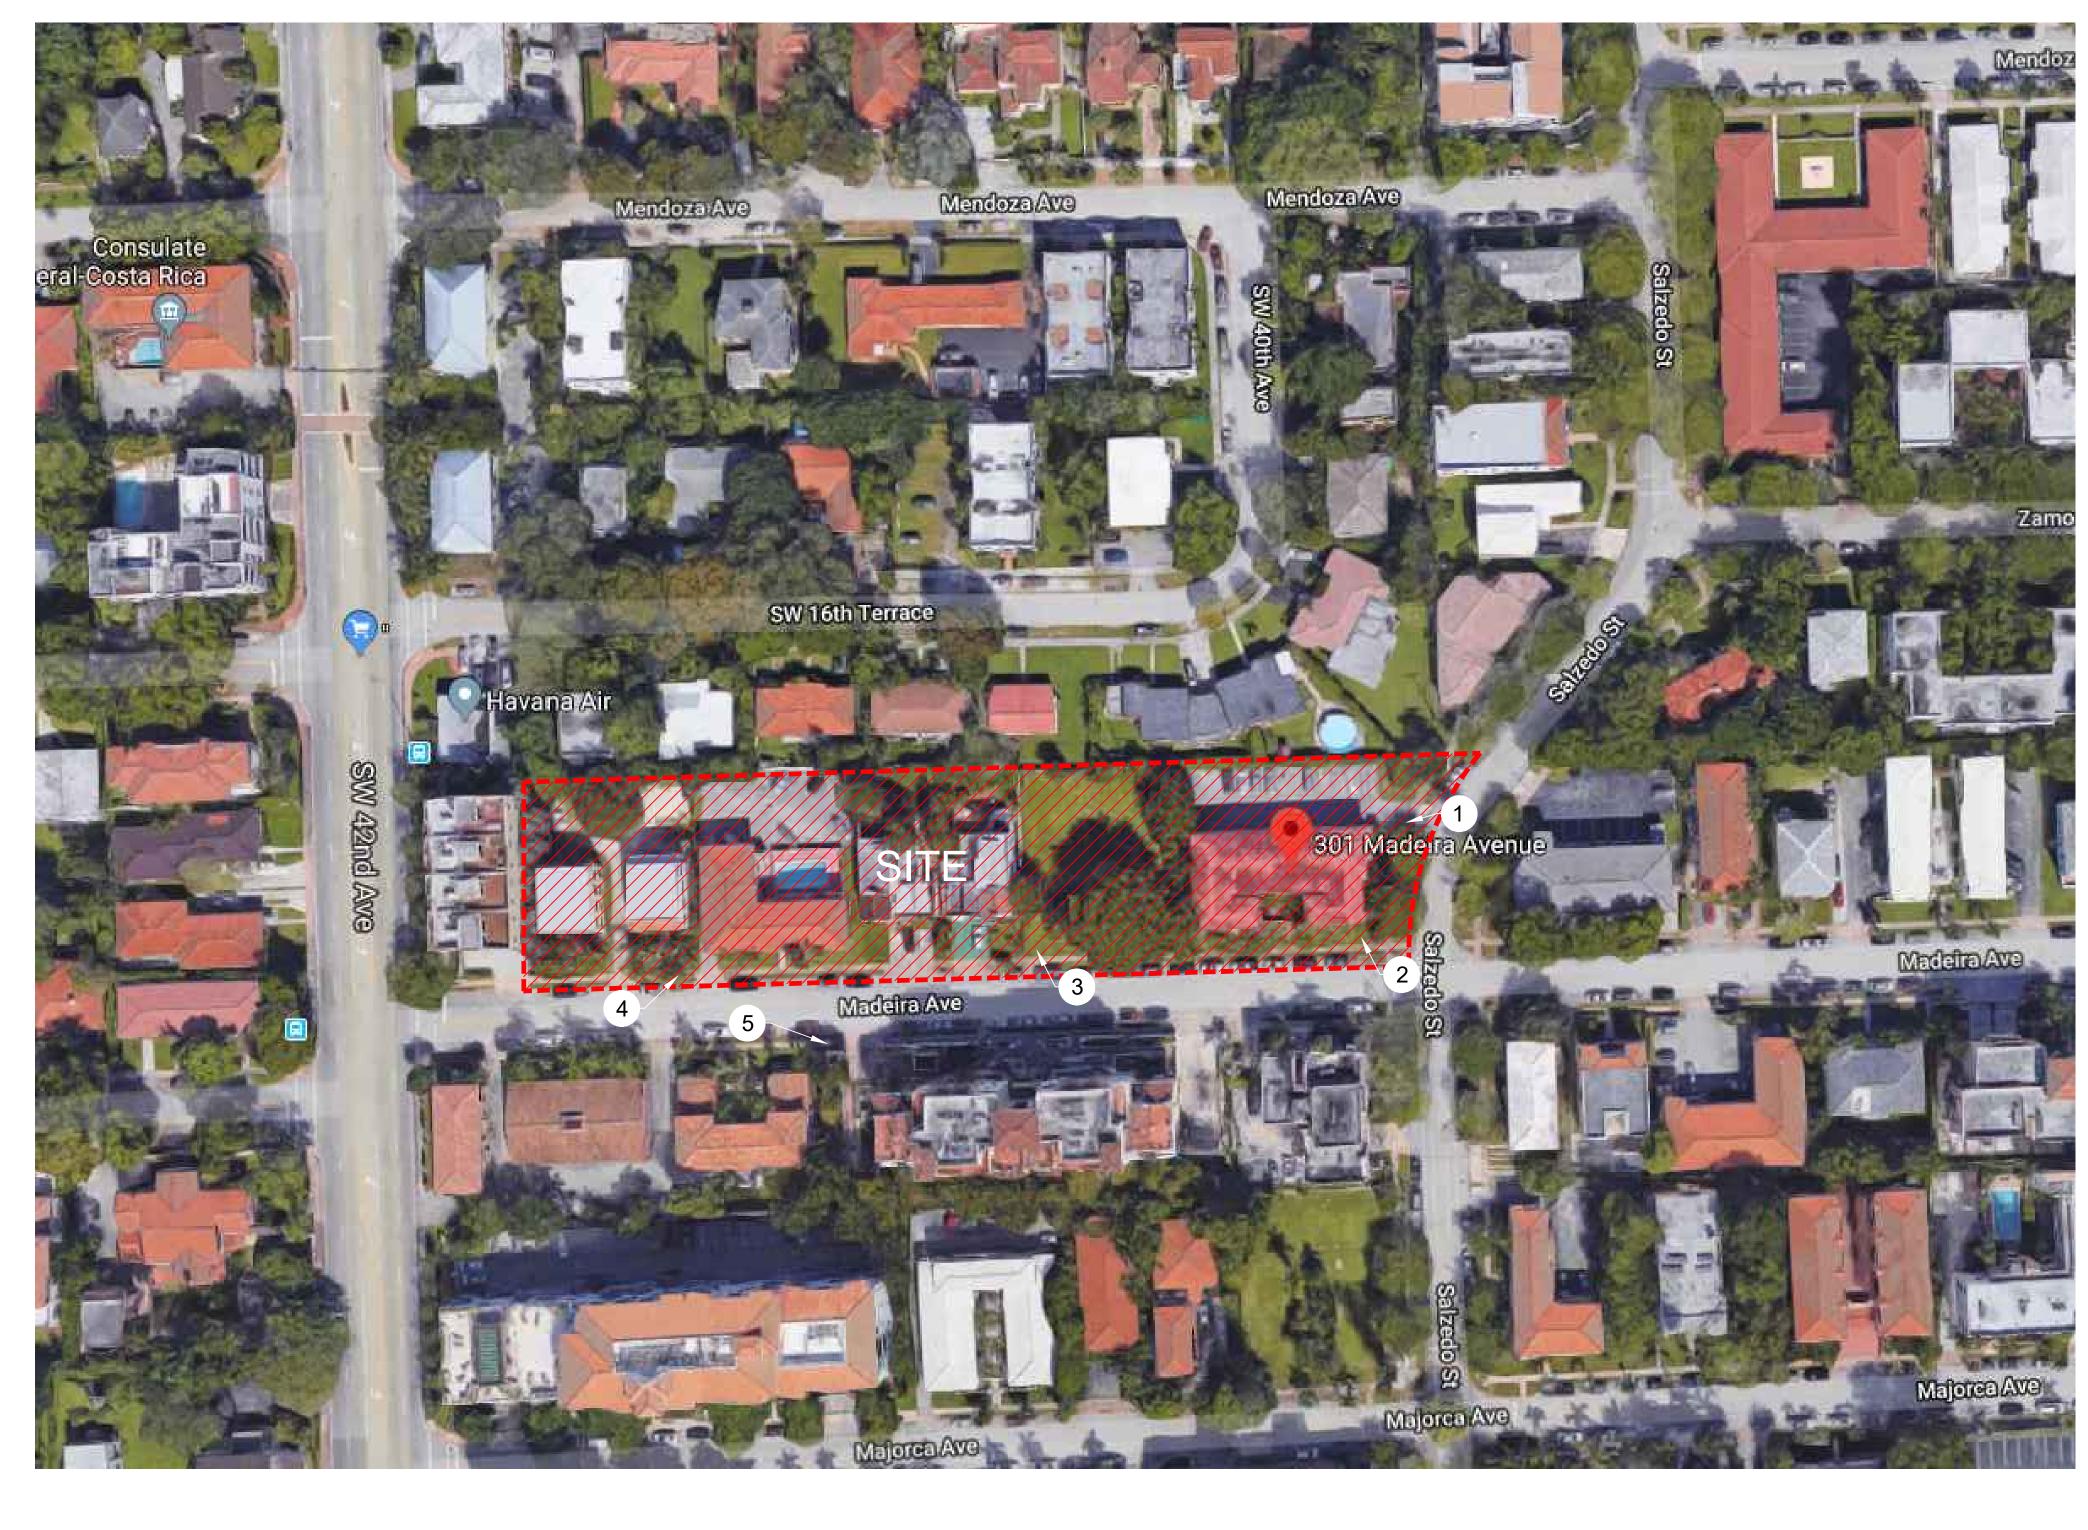

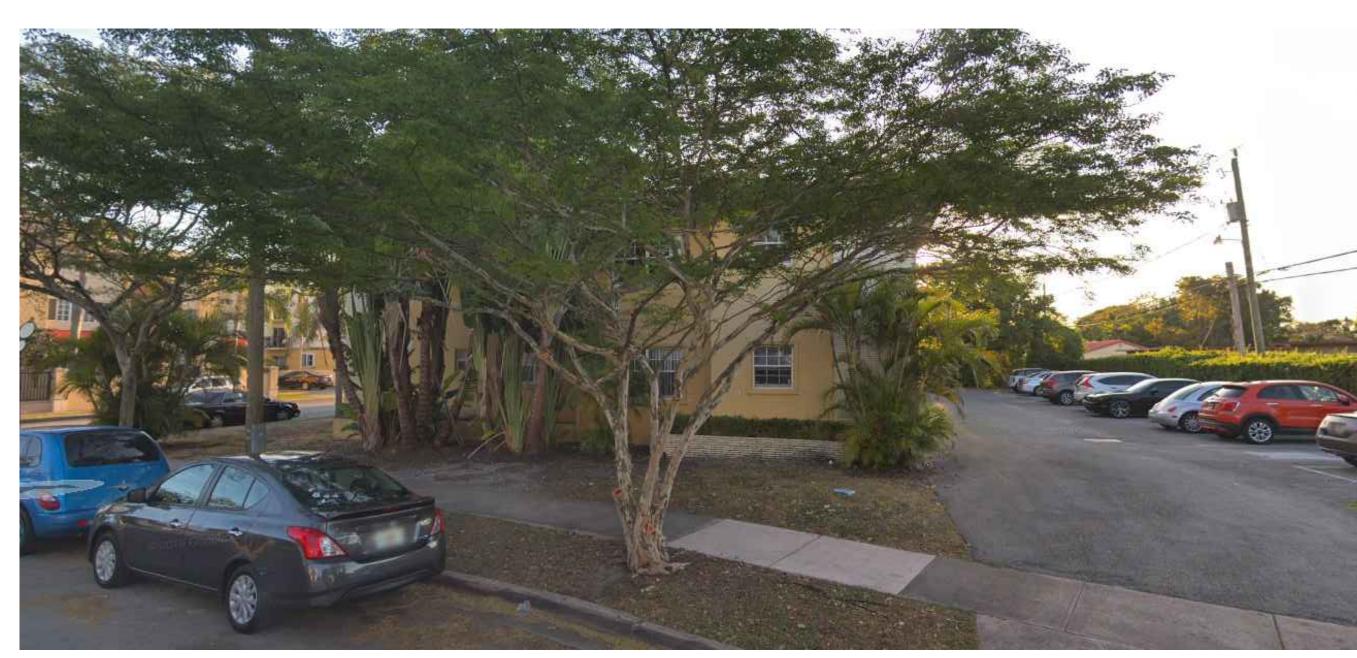

1. 301 MADEIRA AVE.

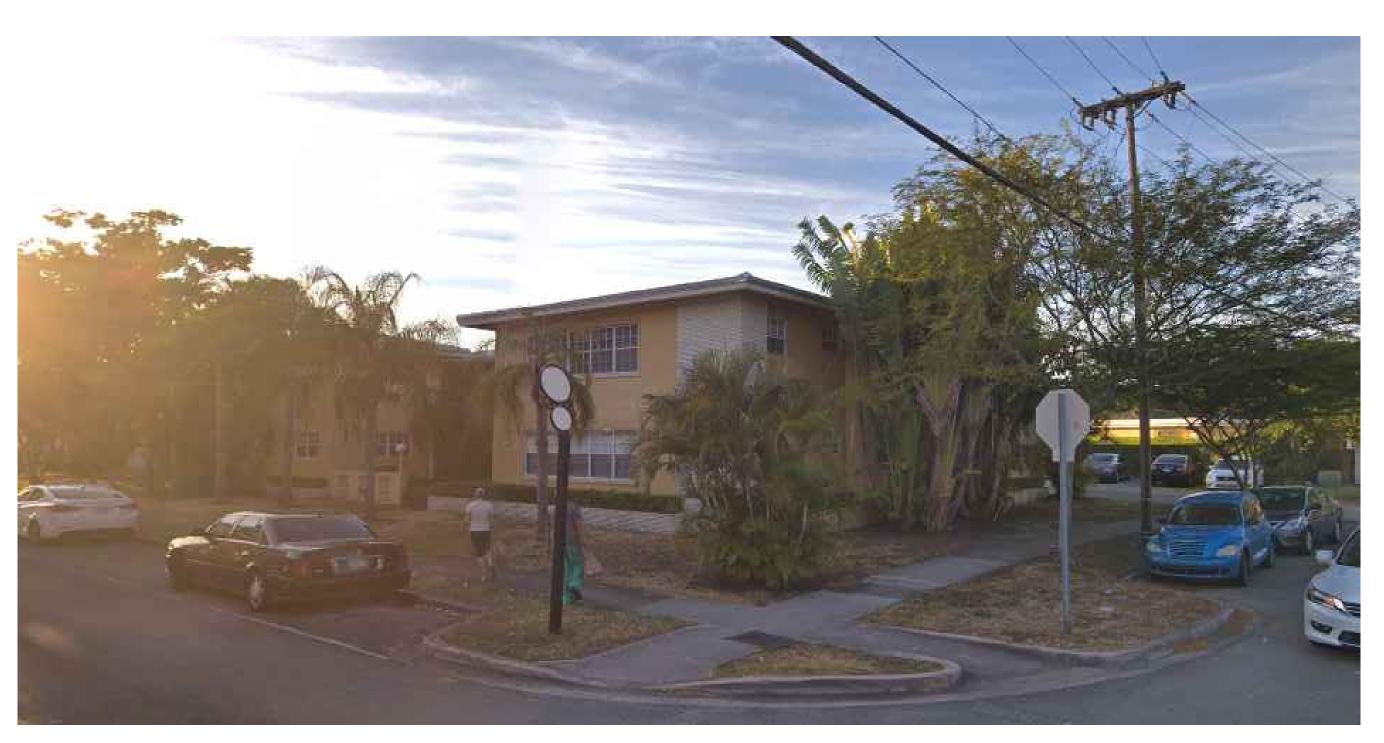

2. 301 MADEIRA AVE.



3. 317-321 MADEIRA AVE.



4. 341-323 MADEIRA AVE.

5. 340-322 MADEIRA AVE.



ROBERT BEHAR AR No. 14339

DATE: 07-26-2021 PROJECT NO: 18-035 DRAWING NAME: SHEET NO:

CP-1.1

= ORNAMENTAL TREE = TEMPORARY SITE BENCHMARK .R.B. = OFFICIAL RECORDS BOOK ADA = AMERICAN DISABILITY ACT (2)2"Ø = INDICATES NUMBER OF PIPE INV. = INVERT ΓΥΡ. = TYPICAL IRR = IRRIGATION EX = EXISTING ST = STORM SAN = SANITARY G = GAS W = WATER COM = EXISTING UNDERGROUND COMMUNCATION LINE = EXISTING UNDERGROUND ELECTRIC LINE O = FIBER OPTIC CATV = CABLE TELEVISION ELEC. = ELECTRIC 0.00 = SPOT ELEVATION ONC. = CONCRETE J.B.S. = CONCRETE BLOCK STUCCO C.L.F. = CHAIN LINK FENCE W.F. = WOOD FENCE M.F. = METAL FENCE B.W.F. = BARBED WIRE FENCE F = FINISH FLOOR FDC = FIRE DEPARTMENT D = DIAMETER OF TREE (TAKEN AT BREAST HEIGHT = HEIGHT OF TREE = SPREAD (CANOPY OF TREE = POLYVINYL CHLORIDE PIPE = HIGH-DENSITY POLYETHYLEI = RECORD = CALCULATED = MEASURE = CORRUGATED META I. = CAST IRON = LICENSE BUSINESS = LENGTH = CENTRAL ANGLE T = TANGENT PCC = POINT OF COMPOUND CURVATURE PRC = POINT OF REVERSE CURVATURE PT = POINT OF TANGENCY PC = POINT OF CURVATURE STA. = STATION OLP = ORNAMENTAL LIGHT POLE WLP = WOODEN LIGHT POLE MLP = METAL LIGHT POLE CLP = CONCRETE LIGHT POLE R/W = RIGHT-OF-WAY P.B. = PLAT BOOK \$ = SECTION LINF = CENTERLINE = MONUMENT LINE = TRAFFIC SIGNAL BOX = TRAFFIC SIGNAL CABINET = BOLLARD = PEDESTRIAN SIGNAL = TRAFFIC HANDHOLI = TRAFFIC MANHOLE = TRAFFIC CAMERA = TRAFFIC MARKER SIGN = TRAFFIC SIGNAL MAST ARN = TRAFFIC SENSOR = CABLE TELEVISION MANHOL = CABLE TELEVISION HANDHO = CABLE TELEVISION VAULT = CABLE TELEVISION BOX = CABLE TELEVISION MARKE = CABLE TELEVISION MARKER = CONCRETE LIGHT POLE = FLOODLIGHT = ELECTRIC BOX = FLECTRIC SWITCH = WOODEN UTILITY POL = CONCRETE UTILITY PO = METAL UTILITY POLE = ELECTRIC TRANSFORMER = GUY ANCHOR = COMMUNICATION BO COMMUNICATION MANHOLE COMMUNICATION VAULT COMMUNICATION HANDHOLE COMMUNICATION MARKER = GARBAGE RECEPTACLE = BASKETBALL HOOP = HANDICAP PARKING SPACE = IRRIGATION VALVE = WATER VALVE = AIR RELEASE VALVE = WATER HANDHOLE = WATER MARKING SIGN = STORM MANHOLE = STORM METER STORM HANDHOLE = CATCH BASIN STORM MARKER FL = STORM MARKER SIGN = TELEPHONE MANHOLI = TELEPHONE BOX = TELEPHONE BOX = TELEPHONE MARKER SIGN = NEWSPAPER DISPENSER = MAILBOX = BORING HOLE = SANITARY MANHOLE = SANITARY METER = SANITARY TANK = SANITARY LIFT STATION SANITARY VAULT = SANITARY MARKER FLA = GREASE TRAP MANHOLE = PARKING METER = FIBER OPTIC MANHOLE = FIBER OPTIC HANDHOL = FIBER OPTIC MARKER FLA = FIBER OPTIC MARKER SIGN = MONITORING WELL = UNKNOWN UTILITY BOX = UNKNOWN UTILITY MATER = UNKNOWN UTILITY MANHOLE = UNKNOWN UTILITY MANHOLE = UNKNOWN UTILITY TANK = UNKNOWN UTILITY VALVE = UNKNOWN UTILITY VALVE = UNKNOWN UTILITY WALVE = UNKNOWN UTILITY MARKER FLAG = UNKNOWN UTILITY MARKER = RAILROAD SIGNAL = RAILROAD SIGN = RAILROAD BOX = RAILROAD VAULT = RAILROAD HANDHOLE = FLAGPOLE = PIPELINE BOX = PIPELINE HANDHOLE = PIPELINE METER = PIPELINE MANHOLE = PIPELINE VALVE = PIPELINE VAULT

= PIPELINE MARKER FLAG


ASPHALT

PAVER

= PIPELINE MARKER SIGN

CONCRETE

MAP OF BOUNDARY SURVEY

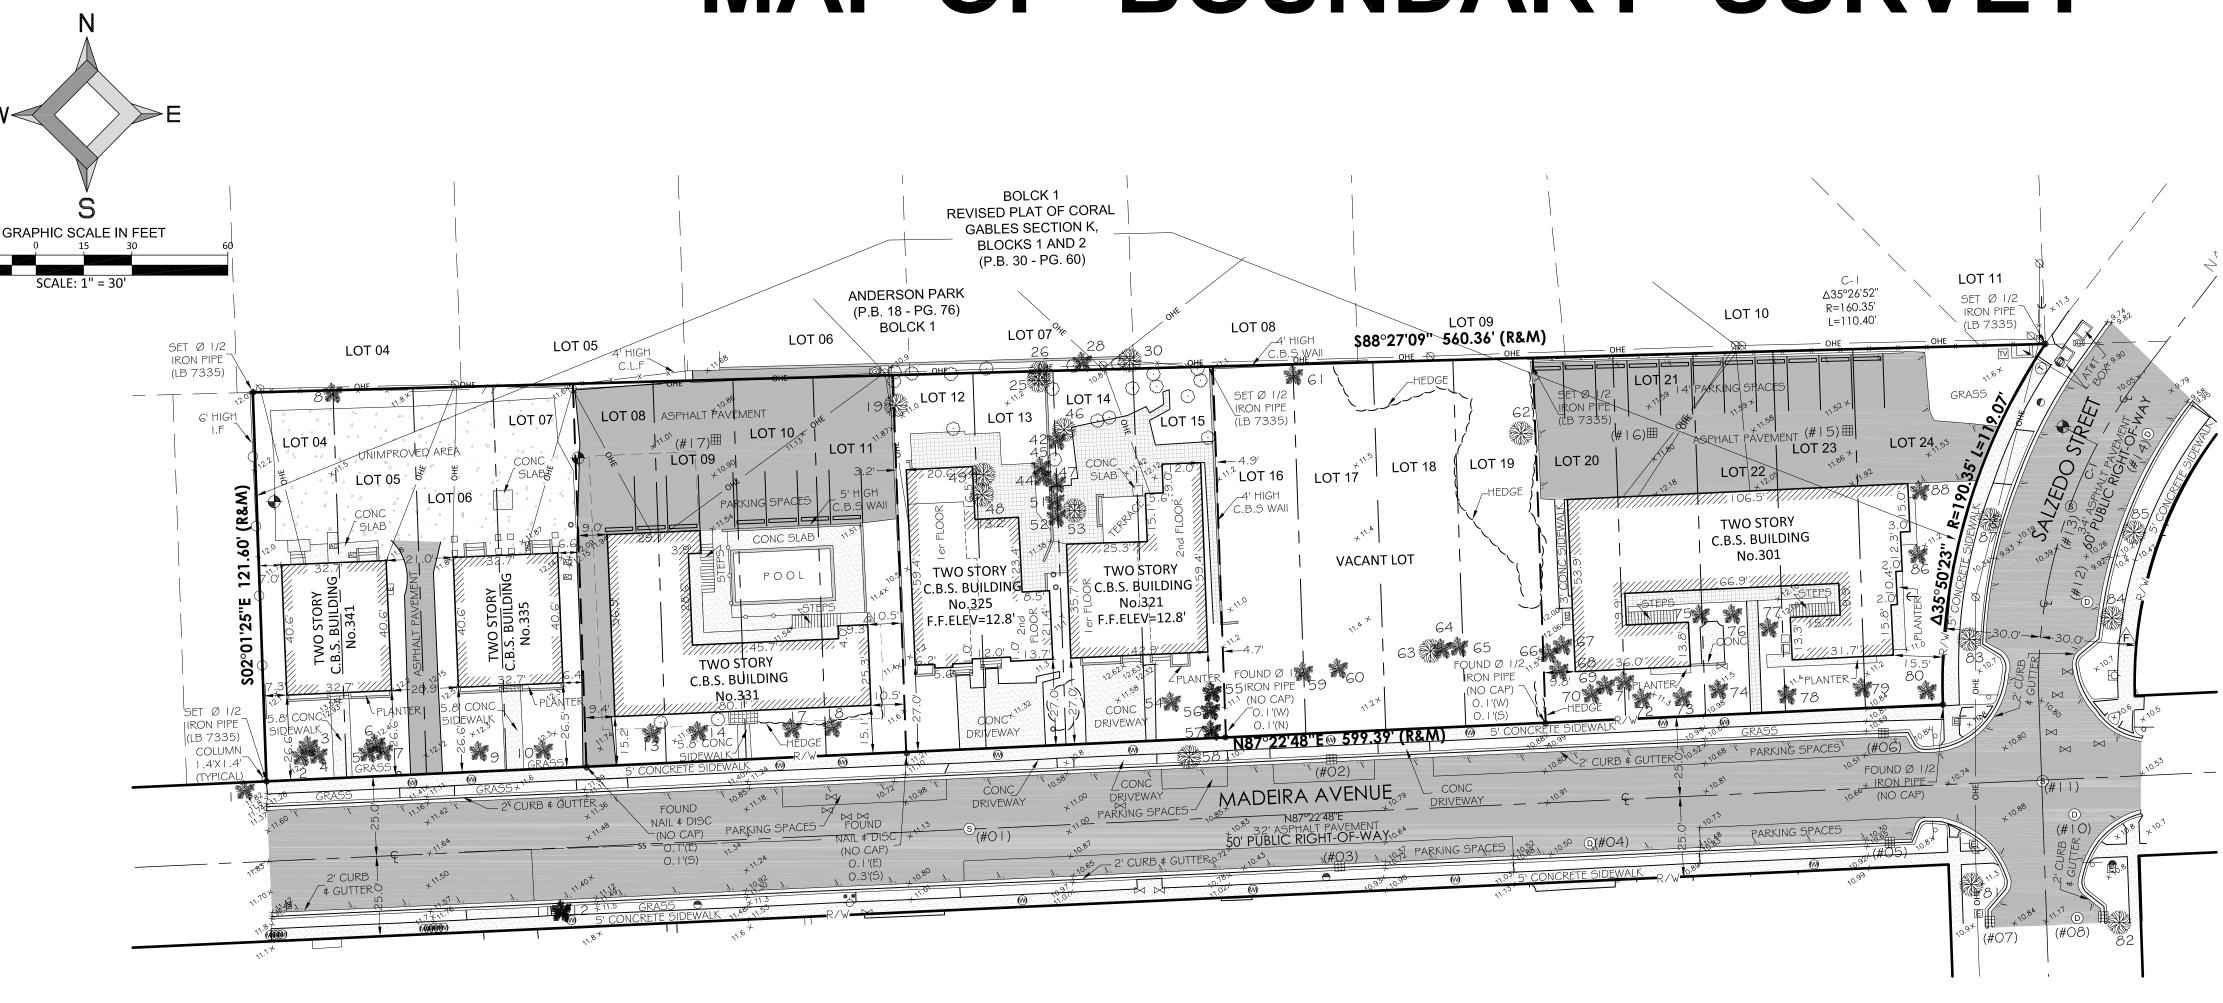

#OF STRUCTUR	I .	NORTH INVERT	Ø & MATERIAL	EAST INVERT	Ø & MATERIAL	WEST INVERT	Ø & MATERIAL	SOUTH INVERT	Ø & MATERIAL	SOUTHEAST INVERT	Ø & MATERIAL	NORTHEAST INVERT	Ø & MATERIAL	TRENCH TOP OF PIPE	воттом	COMMENTS
#01	11.05			6.80	8"Ø CLAY PIPE	6.84	8"Ø CLAY PIPE									
#02	10.18							4.82	12"Ø RCP PIPE						3.53	
#03	10.22	5.97	12"Ø RCP PIPE												4.80	
#04	10.73													TRENCH E-W=2.35	2.35	
#05	9.94															No Access
#06	10.12							7.27	12"Ø IRON PIPE						7.02	
#07	10.29			6.92	12"Ø RCP PIPE										5.78	
#08	10.84			6.71	12"Ø RCP PIPE	5.75	12"Ø RCP PIPE							TRENCH N-S=3.98 12"Ø RCP PIPE		
#09	10.28					6.70	12"Ø RCP PIPE								5.78	
#10	10.91	7.24	12"Ø RCP PIPE	4.55	12"Ø RCP PIPE	5.26	12"Ø RCP PIPE	4.08	18"Ø RCP PIPE	6.61	10"Ø RCP PIPE				4.08	
#11	10.93	1.33	12"Ø CLAY PIPE	2.01	8"Ø DIP PIPE	1.74	8"Ø CLAY PIPE			4.08	16"Ø CLAY PIPE					
#12	10.27													TRENCH N-S=2.28	2.28	
#13	10.17							1.59	12"Ø CLAY PIPE			1.65	12''Ø CLAY PIPE			
#14	9.86													TRENCH SW-NE=2.43	2.43	
#15	10.27					Baffled									5.98	
#16	10.17			Baffled											5.95	
#17	10.30			8.6	4"Ø CONC PIPE										8.50	

SURVEYOR'S NOTES:

DATE OF FIELD SURVEY:

The date of completion of the original field Survey was on April 16, 2018.

LEGAL DESCRIPTION:

Lots 4 thru 24 of Block 1 of "REVISED PLAT OF CORAL GABLES SECTION K", according to the Plat thereof as recorded in Plat Book 30 at Page 60 of the Public Records of Miami-Dade County, Florida.

Containing 62,474 sq. ft. and/or 1.434 acres, more or less, by calculations.

ACCURACY:

The accuracy obtained by field measurement methods and office calculations of closed geometric figures meets and exceeds the Minimum Technical Standards requirement for Suburban Area (Linear: 1 foot in 7,500 feet) as defined in Rule 5J-17.051, Florida Administrative Code.

Elevations of well identified features as depicted on the Survey Map were measured to an estimated vertical position accuracy of 1/100 of a foot on hard surfaces and 1/10 of a foot on ground surfaces.

Well identified features as depicted on the Survey Map were measured to an estimated horizontal position accuracy of 1/10 of a foot.

This Map of Survey is intended to be displayed at a scale of One inch equals Thirty feet or smaller.

PERTINENT INFORMATION USED FOR SURVEY:

North arrow direction is based on an assumed Meridian.

Bearings as shown hereon are based upon the Centerline of Madeira Avenue with an assumed bearing of N87°22'48"E, said line to be considered a well established and monumented line.

This project area appears to be located in Flood Zone "X" and "AH", with a Base Flood Elevation being N/A and 11.0, as per Federal Emergency Management Agency (FEMA) Community-Panel Number 120639 City of Coral Gables), Map No. 0294, Suffix L, Map Revised Date: September 11, 2009.

PERTINENT INFORMATION USED FOR SURVEY (CONTINUED):

For Horizontal Control:

Bearings and Coordinates are relative to the State Plane Coordinate System, Florida East Zone (0901), North American Datum (N.A.D.) of 1983, adjustment of 2011 (NAD 83 / 2011)Epoch 2010.0000; .

All measurements are in U.S. Survey feet.

Global Positioning System (G.P.S.). measurements were conducted in the field to acquire said coordinate values, which are based on the following Horizontal Control Stations:

Name: FLMB Latitude: 25° 46′ 57.83764″ N Longitude: 80° 8′ 14.16768″ W State Plane Coordinates: Northing: 527,654.41 US Feet Easting: 940,056.84 US Feet

Name: FLD6 Latitude: 25° 46′ 49.67350′′ N Longitude: 80° 22′ 35.34867″ W Ellipsoid Height (Meters): -15.104 State Plane Coordinates Northing: 526,386.046 Easting: 861,341.738

 \emptyset = DENOTES DIAMETER

For Vertical Control:

All elevations shown hereon are based on the National Geodetic Vertical Datum of 1929 (N.G.V.D. '29), and a Benchmark supplied by the Public Works Department of The City of Coral Gables, Florida.

Elevation: + 10.48 (N.G.V.D. '29) Located NE COR SALZEDO ST ZAMORA AVE=PKBW COR BSW,

Plat of "CORAL GABLES SECTION K" according to the Plat thereof as recorded in Plat Book 8 at Page 33 of the Public Records of Miami-Dade County, Florida.

Plat of "REVISED PLAT OF CORAL GABLES DOUGLAS SECTION" according to the Plat thereof as recorded in Plat Book 25 at Page 69 of the Public Records of Miami-Dade County, Florida.

PERTINENT INFORMATION USED FOR SURVEY:CONTINUED

Plat of "REVISED PLAT OF CORAL GABLES SECTION K, BLOCK 1 AND 2" according to the Plat thereof as recorded in Plat Book 30 at Page 60 of the Public Records of Miami-Dade County, Florida.

Plat of "ANDERSON PARK" according to the Plat thereof as recorded in Plat Book 18 at Page 76 of the Public Records of Miami-Dade County, Florida.

Since no other information were furnished other than that is cited under pertinent information, the Client is hereby advised that there may be legal restrictions on the Subject Property that are not shown on the Survey Map that may be found in the Public Records of Miami-Dade County.

The Surveyor makes no representation as to ownership or possession of the Subject Property by any

entity or individual that may appear on the Public Records of this County.

No excavation or determination was made as to how the Subject Property is served by utilities.

No improvements were located, other than those shown. No underground foundations, improvements and/or utilities were located or shown hereon.

The purpose of this survey is for design.


CLIENT INFORMATION:

This Boundary Survey was prepared at the insistence of and certified to:

T.A. BUILDERS

SECTION 8 - TOWNSHIP 54 SOUTH - RANGE 41 EAST

LYING AND BEING IN CORAL GABLES, FLORIDA

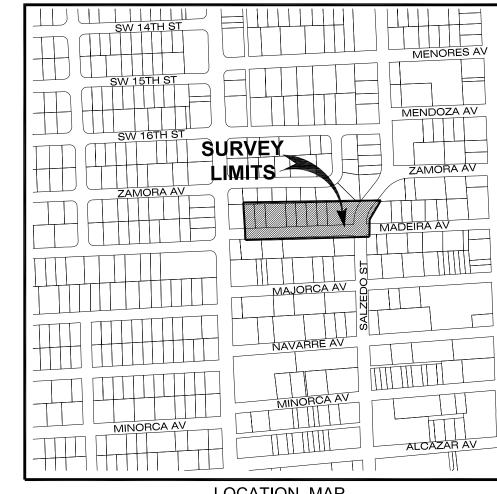

LOCATION MAP

NI-	TRE		DDII	UEIGUT	CDDEA
No.	BOTANICAL NAME	COMMON NAME		HEIGHT	- 415002152
1	UNKNOWN	TREE	8''	30'	15'
2	UNKNOWN	TREE	8''	20'	15'
3	UNKNOWN	TREE	8"	35'	15'
4	UNKNOWN	TREE	8''	30'	15'
5	UNKNOWN	TREE	8''	25'	10'
6	UNKNOWN	TREE	8"	25'	10'
7	UNKNOWN	TREE	8"	15'	6'
8	UNKNOWN	TREE	3"	30'	6'
9	COCOS NUCIFERA	COCONUT	12"	30'	15'
10	COCOS NUCIFERA	COCONUT	12"	30'	15'
13	AILANTHUS ALTISSIMA	TREE QUEEN	10"	25'	15'
14	AILANTHUS ALTISSIMA	TREE QUEEN	10"	15'	15'
17	AILANTHUS ALTISSIMA	TREE QUEEN	10"	20'	10'
18	AILANTHUS ALTISSIMA	TREE QUEEN	8"	18'	25'
			_	2.000000	0.00000000
19	PRUNUS DULCIS	ALMOND	30"	50'	50'
25	FICUS BENJAMINA	LAUUREL DE LA INDIA	6''	10'	10'
26	UNKNOWN	TREE	10"	20'	20'
27	CONOCARPUS ERECTUS	SILVER BUTTONWOOD	9"	12'	12'
28	ARECA CATECHU	ARECA CLUSTER	10"	20'	15'
30	UNKNOWN	TREE	12"	25'	15'
42	ARECA CATECHU	ARECA CLUSTER		10'	8'
44	ARECA CATECHU	ARECA CLUSTER		20'	15'
45	ARECA CATECHU	ARECA CLUSTER		20'	15'
46	SCHEFFLERA ACTINOPHYLLA	UMBRELLA	8"	20'	10'
47	ARECA CATECHU	ARECA CLUSTER	0	10'	8'
		7.000.000.000.000.000.000.000.000	4.411		
48	UNKNOWN	TREE	14"	40'	30'
49	UNKNOWN	TREE	14"	20'	20'
51	ARECA CATECHU	ARECA		15'	10'
52	ARECA CATECHU	ARECA		15'	10'
53	CALLISTEMON	BUTTER BRUSH	10"	18'	12'
54	ARECACEAE	PALM REVELINE	4"	7'	4'
55	ARECA CATECHU	ARECA TREE	4"	25'	7'
56	ARECA CATECHU	ARECA TREE	3"	25'	6'
57	ARECA CATECHU	ARECA TREE	3"	15'	4'
58	CALLISTEMON	BUTTER BRUSH		15'	15'
59	COCOS NUCIFERA	COCO PALM	18"	25'	20'
60	COCOS NUCIFERA	COCO PALM	8"	25'	20'
61	ARECA CATECHU	ARECA CLUSTER		15'	10'
62	FICUS BENJAMINA	ALMOND FICUS	48"	50'	50'
63	PRUNUS DULCIS	ALMOND TREE	26"	40'	60'
64	ARECA CATECHU	ARECA CLUSTER		10'	6'
65	ARECA CATECHU	ARECA CLUSTER	350000	10'	6'
66	AILANTHUS ALTISSIMA	TREE QUEEN	12"	30'	10'
67	AILANTHUS ALTISSIMA	TREE QUEEN	10"	25'	10'
68	AILANTHUS ALTISSIMA	TREE QUEEN	12"	30'	10'
69	ARECA CATECHU	ARECA CLUSTER		15'	20'
70	AILANTHUS ALTISSIMA	TREE QUEEN	8"	20'	15'
71	ARECA CATECHU	ARECA CLUSTER		15'	10'
72	AILANTHUS ALTISSIMA	TREE QUEEN	10"	20'	15'
73	AILANTHUS ALTISSIMA	TREE QUEEN	12"	25'	8'
74	AILANTHUS ALTISSIMA	TREE QUEEN	10"	25'	15'
	ARECA CATECHU	ARECA CLUSTER	10	15'	10'
75	ANECA CATECITO	ARECA CEOSTER		10'	10'
75 76	ADECA CATECULI	ADECA CLUSTED			10
76	ARECA CATECHU	ARECA CLUSTER		1000000	1000000
76 77	ARECA CATECHU	ARECA CLUSTER	Ol:	20'	15'
76 77 78	ARECA CATECHU AILANTHUS ALTISSIMA	ARECA CLUSTER TREE QUEEN	9"	20' 20'	15' 16'
76 77 78 79	ARECA CATECHU AILANTHUS ALTISSIMA AILANTHUS ALTISSIMA	ARECA CLUSTER TREE QUEEN TREE QUEEN	9" 9"	20' 20' 20'	15' 16' 10'
76 77 78	ARECA CATECHU AILANTHUS ALTISSIMA	ARECA CLUSTER TREE QUEEN	9"	20' 20'	15' 16'
76 77 78 79	ARECA CATECHU AILANTHUS ALTISSIMA AILANTHUS ALTISSIMA	ARECA CLUSTER TREE QUEEN TREE QUEEN	-	20' 20' 20'	15' 16' 10'
76 77 78 79 80	ARECA CATECHU AILANTHUS ALTISSIMA AILANTHUS ALTISSIMA ARECA CATECHU	ARECA CLUSTER TREE QUEEN TREE QUEEN ARECA CLUSTER	9"	20' 20' 20' 10'	15' 16' 10' 10'
76 77 78 79 80 81	ARECA CATECHU AILANTHUS ALTISSIMA AILANTHUS ALTISSIMA ARECA CATECHU RAVENALA MADAGASCARIENSIS	ARECA CLUSTER TREE QUEEN TREE QUEEN ARECA CLUSTER TRAVELLER'S TREE	9"	20' 20' 20' 10' 30'	15' 16' 10' 10' 30'
76 77 78 79 80 81 82	ARECA CATECHU AILANTHUS ALTISSIMA AILANTHUS ALTISSIMA ARECA CATECHU RAVENALA MADAGASCARIENSIS RAVENALA MADAGASCARIENSIS	ARECA CLUSTER TREE QUEEN TREE QUEEN ARECA CLUSTER TRAVELLER'S TREE TRAVELLER'S TREE	9" 12" 8"	20' 20' 20' 10' 30' 35'	15' 16' 10' 10' 30' 20'
76 77 78 79 80 81 82 83	ARECA CATECHU AILANTHUS ALTISSIMA AILANTHUS ALTISSIMA ARECA CATECHU RAVENALA MADAGASCARIENSIS RAVENALA MADAGASCARIENSIS RAVENALA MADAGASCARIENSIS	ARECA CLUSTER TREE QUEEN TREE QUEEN ARECA CLUSTER TRAVELLER'S TREE TRAVELLER'S TREE TRAVELLER'S TREE	9" 12" 8" 8"	20' 20' 20' 10' 30' 35' 20'	15' 16' 10' 10' 30' 20' 20'
76 77 78 79 80 81 82 83 84 85	ARECA CATECHU AILANTHUS ALTISSIMA AILANTHUS ALTISSIMA ARECA CATECHU RAVENALA MADAGASCARIENSIS RAVENALA MADAGASCARIENSIS RAVENALA MADAGASCARIENSIS RAVENALA MADAGASCARIENSIS RAVENALA MADAGASCARIENSIS RAVENALA MADAGASCARIENSIS	ARECA CLUSTER TREE QUEEN TREE QUEEN ARECA CLUSTER TRAVELLER'S TREE TRAVELLER'S TREE TRAVELLER'S TREE TRAVELLER'S TREE TRAVELLER'S TREE TRAVELLER'S TREE	9" 12" 8" 8" 7"	20' 20' 20' 10' 30' 35' 20' 20' 20'	15' 16' 10' 10' 30' 20' 20' 25'
76 77 78 79 80 81 82 83 84	ARECA CATECHU AILANTHUS ALTISSIMA AILANTHUS ALTISSIMA ARECA CATECHU RAVENALA MADAGASCARIENSIS RAVENALA MADAGASCARIENSIS RAVENALA MADAGASCARIENSIS RAVENALA MADAGASCARIENSIS	ARECA CLUSTER TREE QUEEN TREE QUEEN ARECA CLUSTER TRAVELLER'S TREE TRAVELLER'S TREE TRAVELLER'S TREE TRAVELLER'S TREE	9" 12" 8" 8" 7"	20' 20' 20' 10' 30' 35' 20'	15' 16' 10' 10' 30' 20' 20' 20'

SURVEYOR'S CERTIFICATE:


I hereby certify: That this "Boundary Survey" and the Survey Map resulting therefrom was performed under my direction and is true and correct to the best of my knowledge and belief and further, that said "Boundary Survey" meets the intent of the applicable provisions of the Standards of Practice for Land Surveying in the State of Florida, pursuant to Rule 5J-17.051 through 5J-17.052 of the Florida Administrative Code and its implementing law, Chapter 472.027 of the Florida Statutes.

LONGITUDE SURVEYORS LLC., a Florida Limited Liability Company

Florida Certificate of Authorization Number LB7335

Eduardo M. Suarez, PSM Registered Surveyor and Mapper LS6313 State of Florida

NOTICE: Not valid without the signature and original raised seal of a Florida Licensed Surveyor and Mapper. Additions or deletions to Survey Maps by other than the signing party are prohibited without the written consent of the signing party.

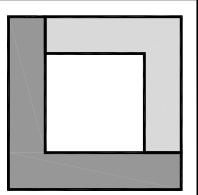

LONGITUDE **SURVEYORS**

7715 NW 48th STREET **SUITE 310** DORAL, FLORIDA

33166 PH: (305) 463-0912 FAX: (305) 513-5680 FLORIDA CERTIFICATE OF AUTHORIZATION LB 7335

WWW.LONGITUDESURVEYORS.COM

RECORD OF REVISION	Description				
	Date:				
	No.:				

AS SHOWN Checked By: Managed By:

Drawing Date: April 20, 2018

Sheet 1 of 1

ORAL GABLES • ATLANTA

SEAL:

ROBERT BEHAR AR No. 14339

A REV.10-22-2021 ⚠ REV. 07-26-2021

301-341 MADEIRA AVE

CORAL GABLES • ATLANTA

SEAL:

ROBERT BEHAR AR No. 14339

DATE: 10-22-2021

PROJECT NO: 18-035

DRAWING NAME:


SHEET NO:

A-0.1.1

MASSING CONTEXT - SOUTH WEST VIEW

SCALE: N.T.S.

ROBERT BEHAR AR No. 14339

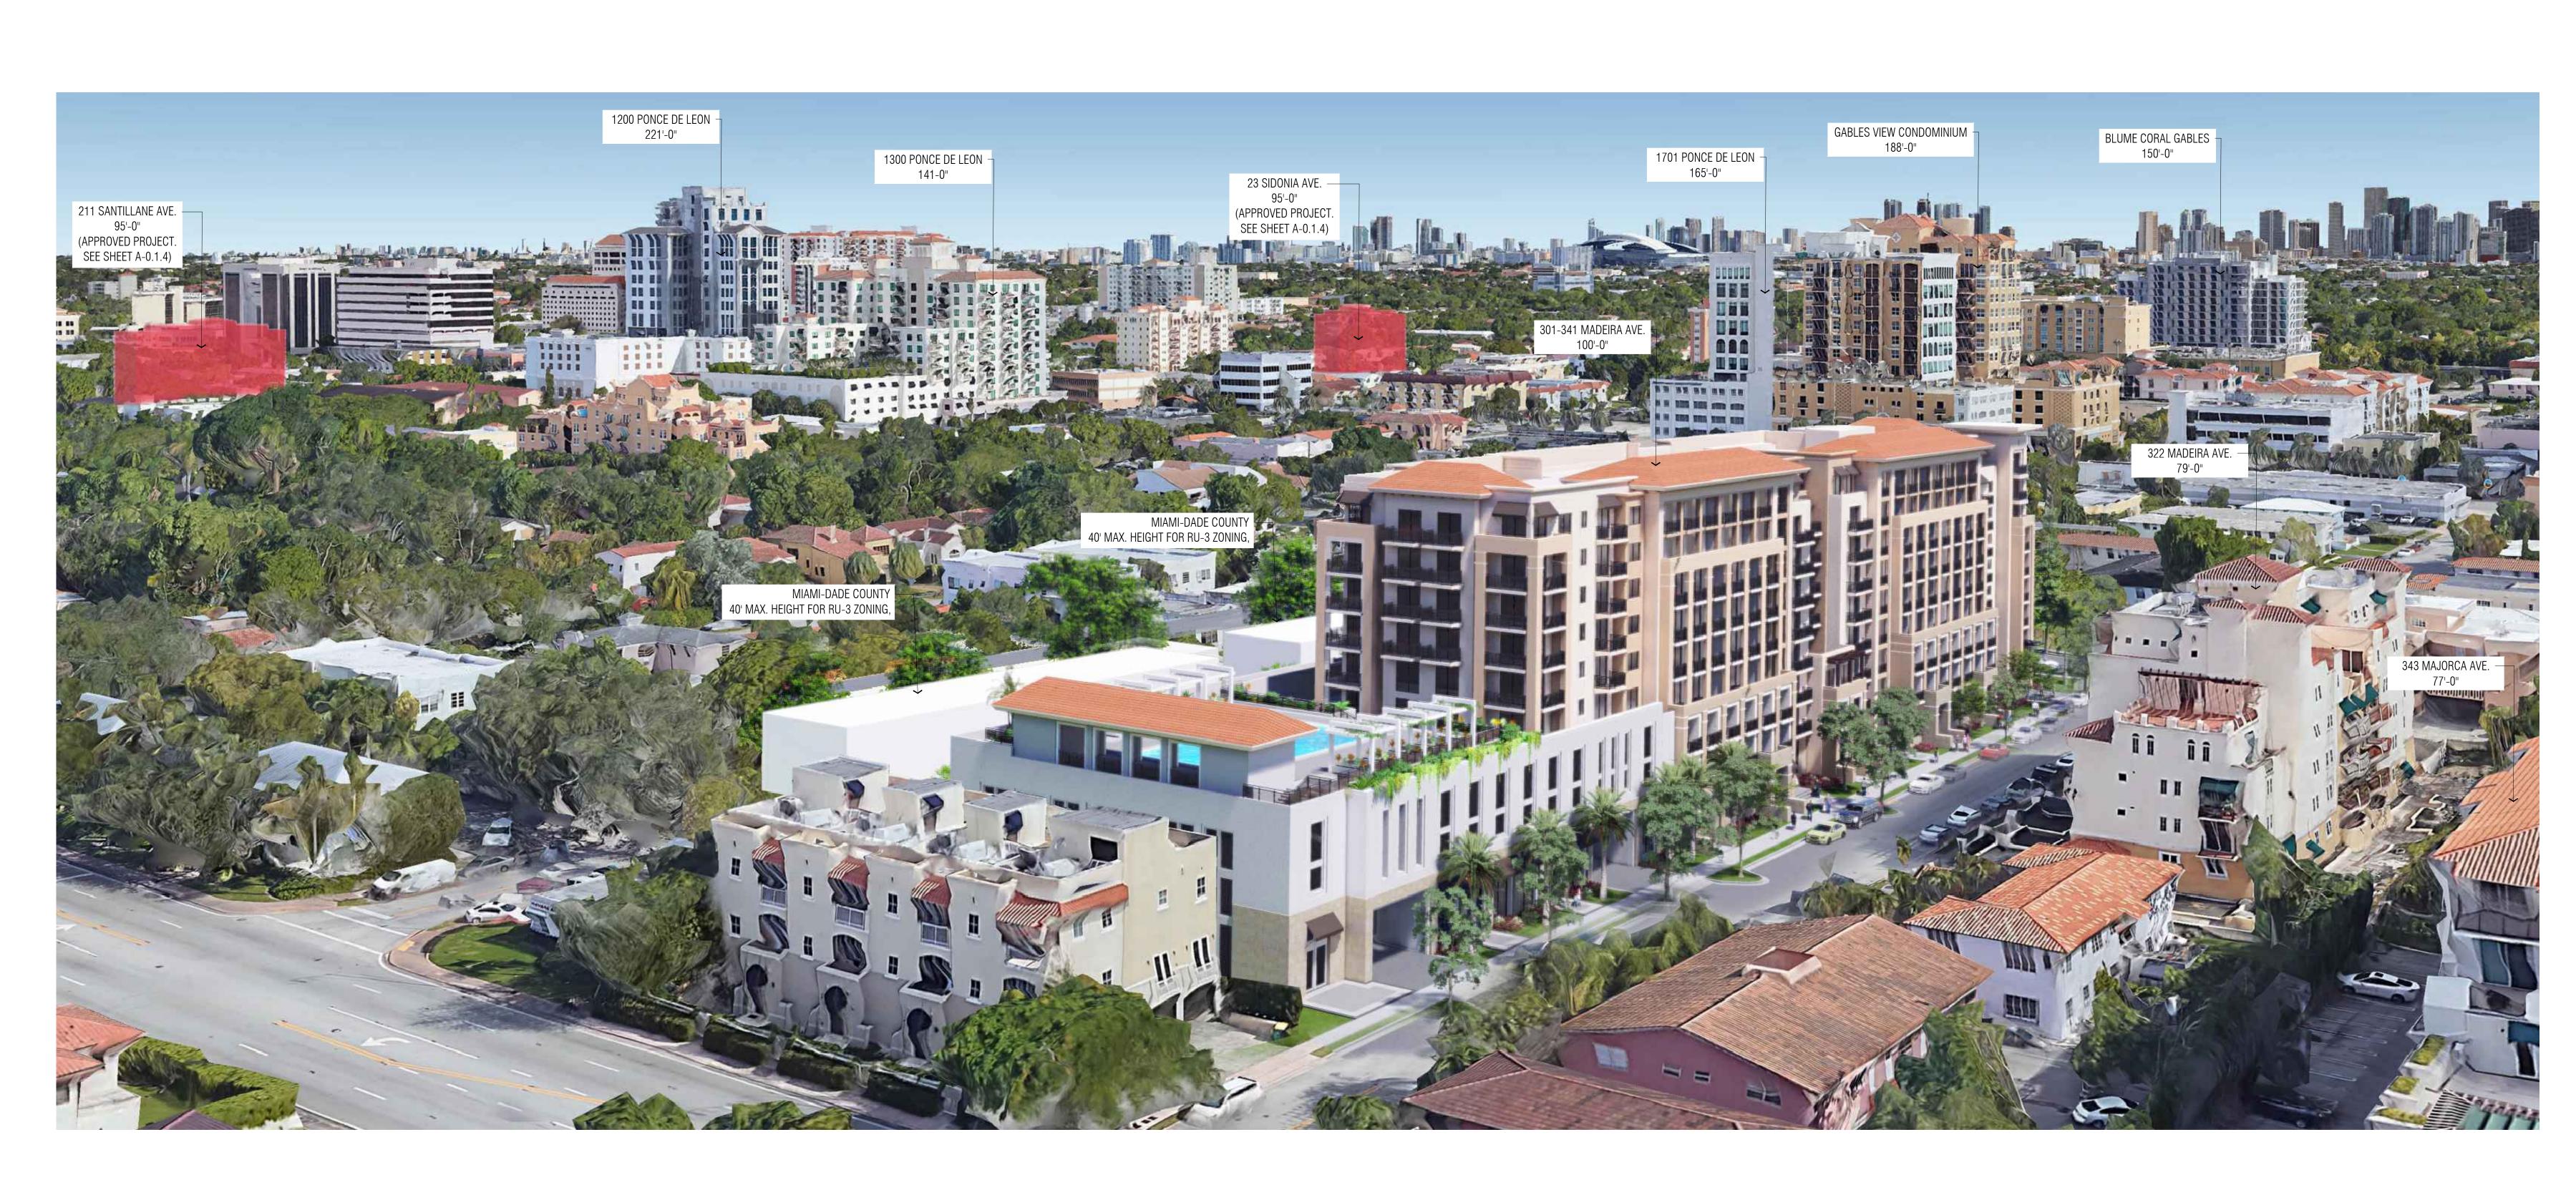

IADEIRA DEIRA AVE FLORIDA 33134

⚠ REV.10-22-2021 ⚠ REV.07-26-2021

MASSING CONTEXT - NORTH EAST VIEW

SCALE: N.T.S.


BEHAR - FONT

PART NERS, P.A.

ARCHITECTURE - PLANNING - INTERIORS

SEAL:

ROBERT BEHAR AR No. 14339

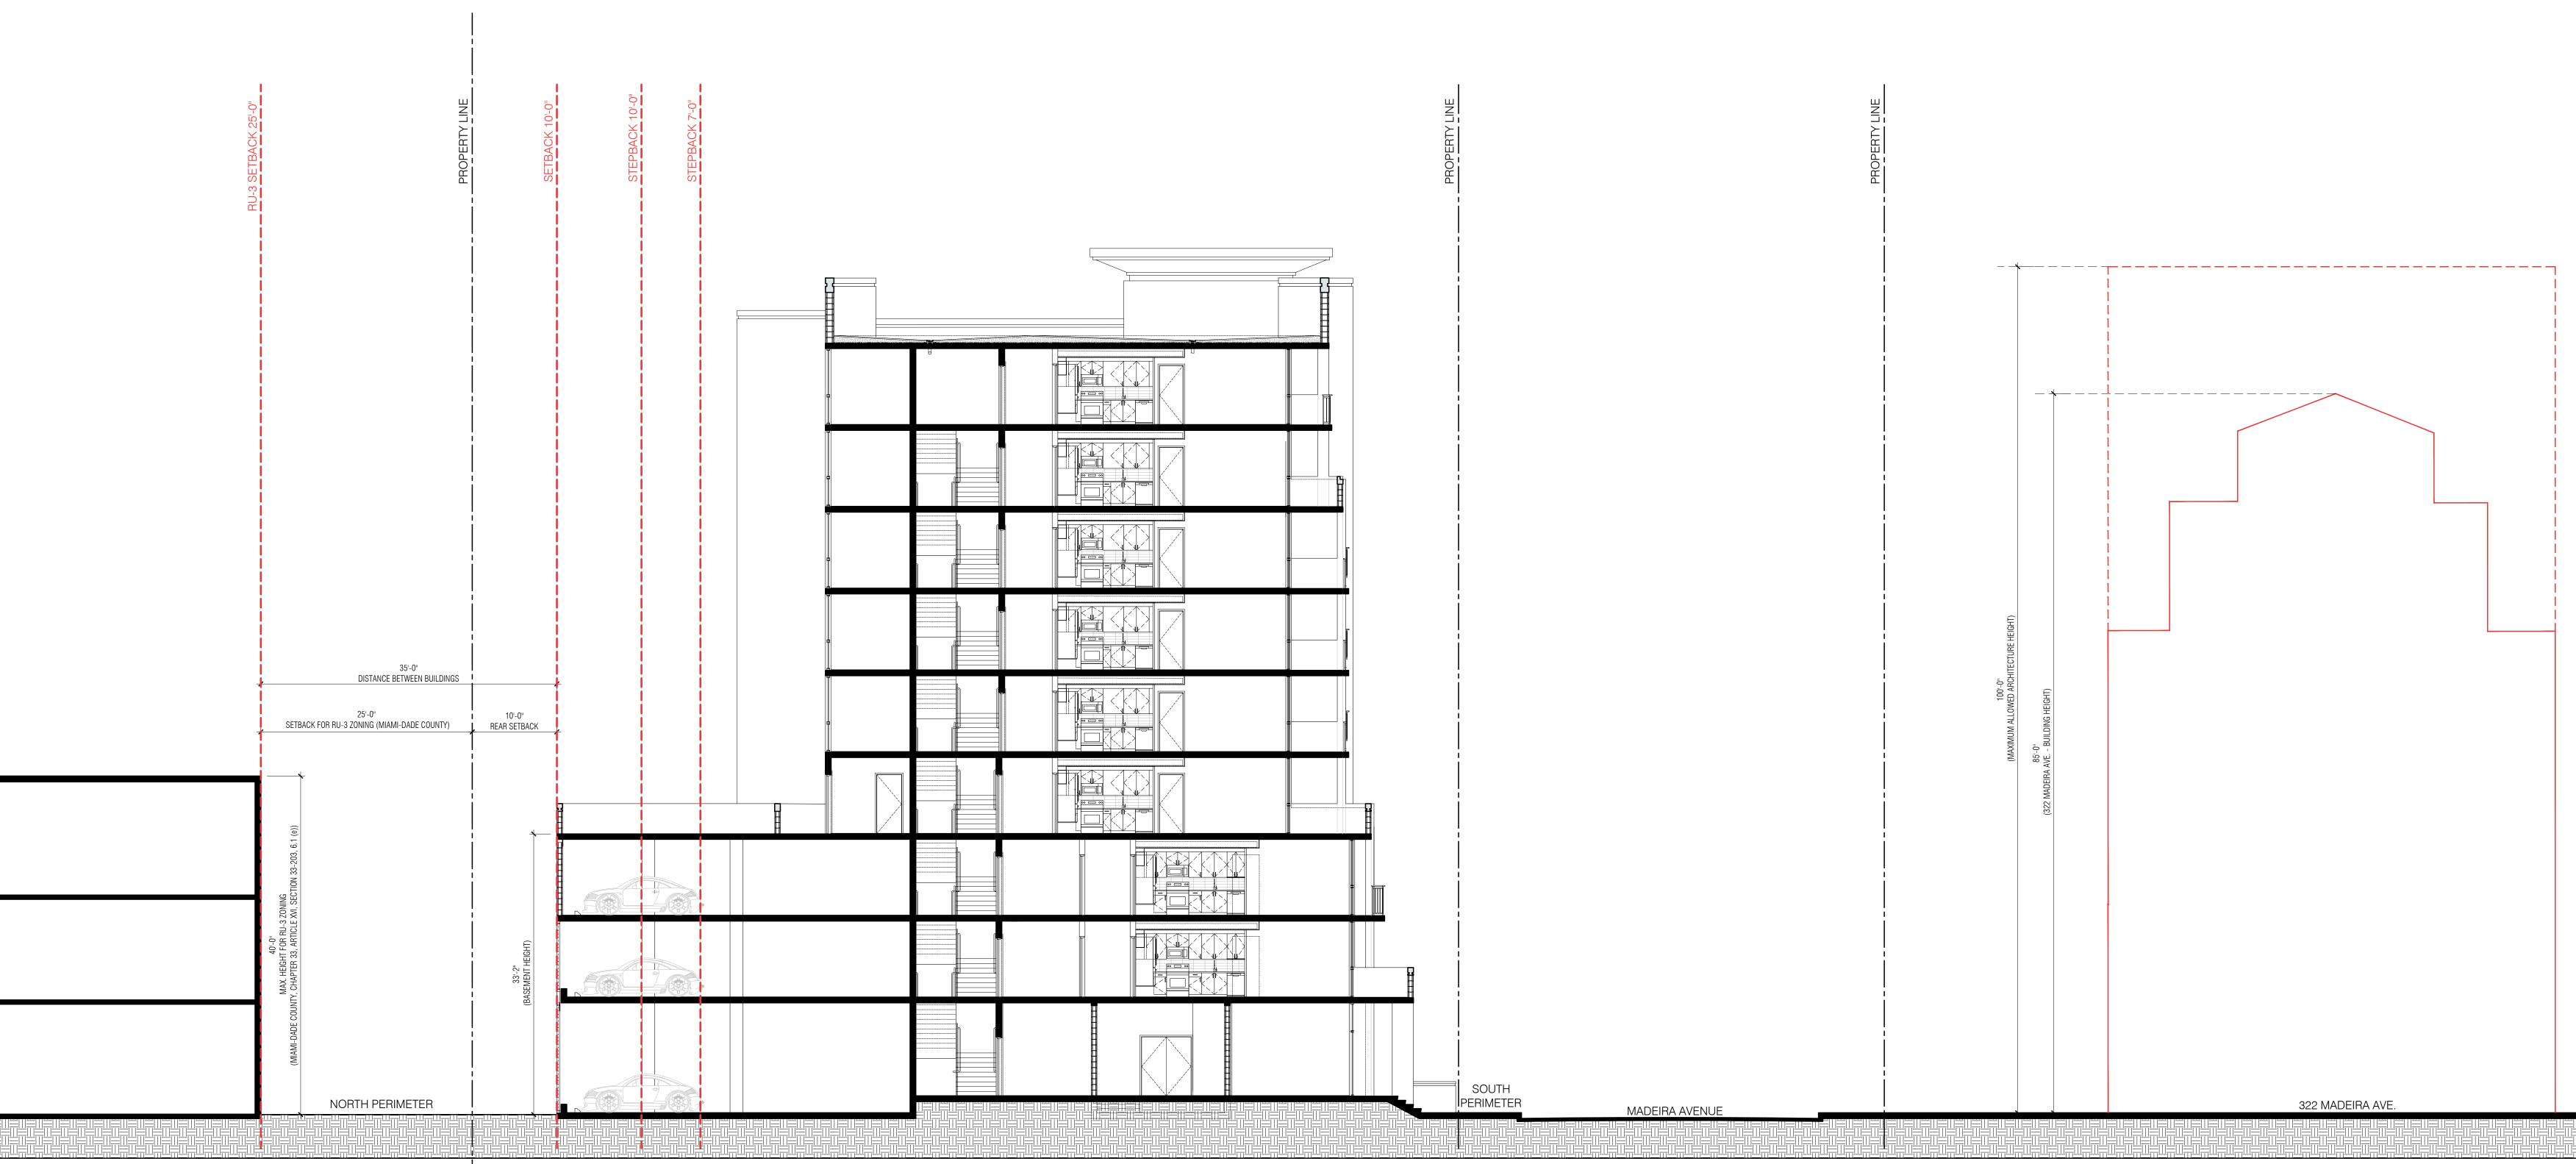

MIAMI-DADE COUNTY

40' MAX. HEIGHT FOR RU-3 ZONING,
AS PER MIAMI-DADE COUNTY, CHAPTER 33,
ARTICLE XVI, SECTION 33-203, 6.1 (e)

CITY OF CORAL GABLES ---

⚠ REV. 07-26-2021

301-341 MADEIRA AVE CORAL GABLES, FLORIDA 33134

PERIMETER HEIGHT CONTEXT

SCALE: 3/16" = 1'-0'

DATE: 10-22-2021

PROJECT NO: 18-035

DRAWING NAME:

SHEET NO:

A-0.1.3


⚠ REV. 10-22-2021

A REV. 01-28-2021

⚠ REV. 12-15-2020

DATE: 10-22-2021 PROJECT NO: 18-035 DRAWING NAME: SHEET NO:

A-0.1.5

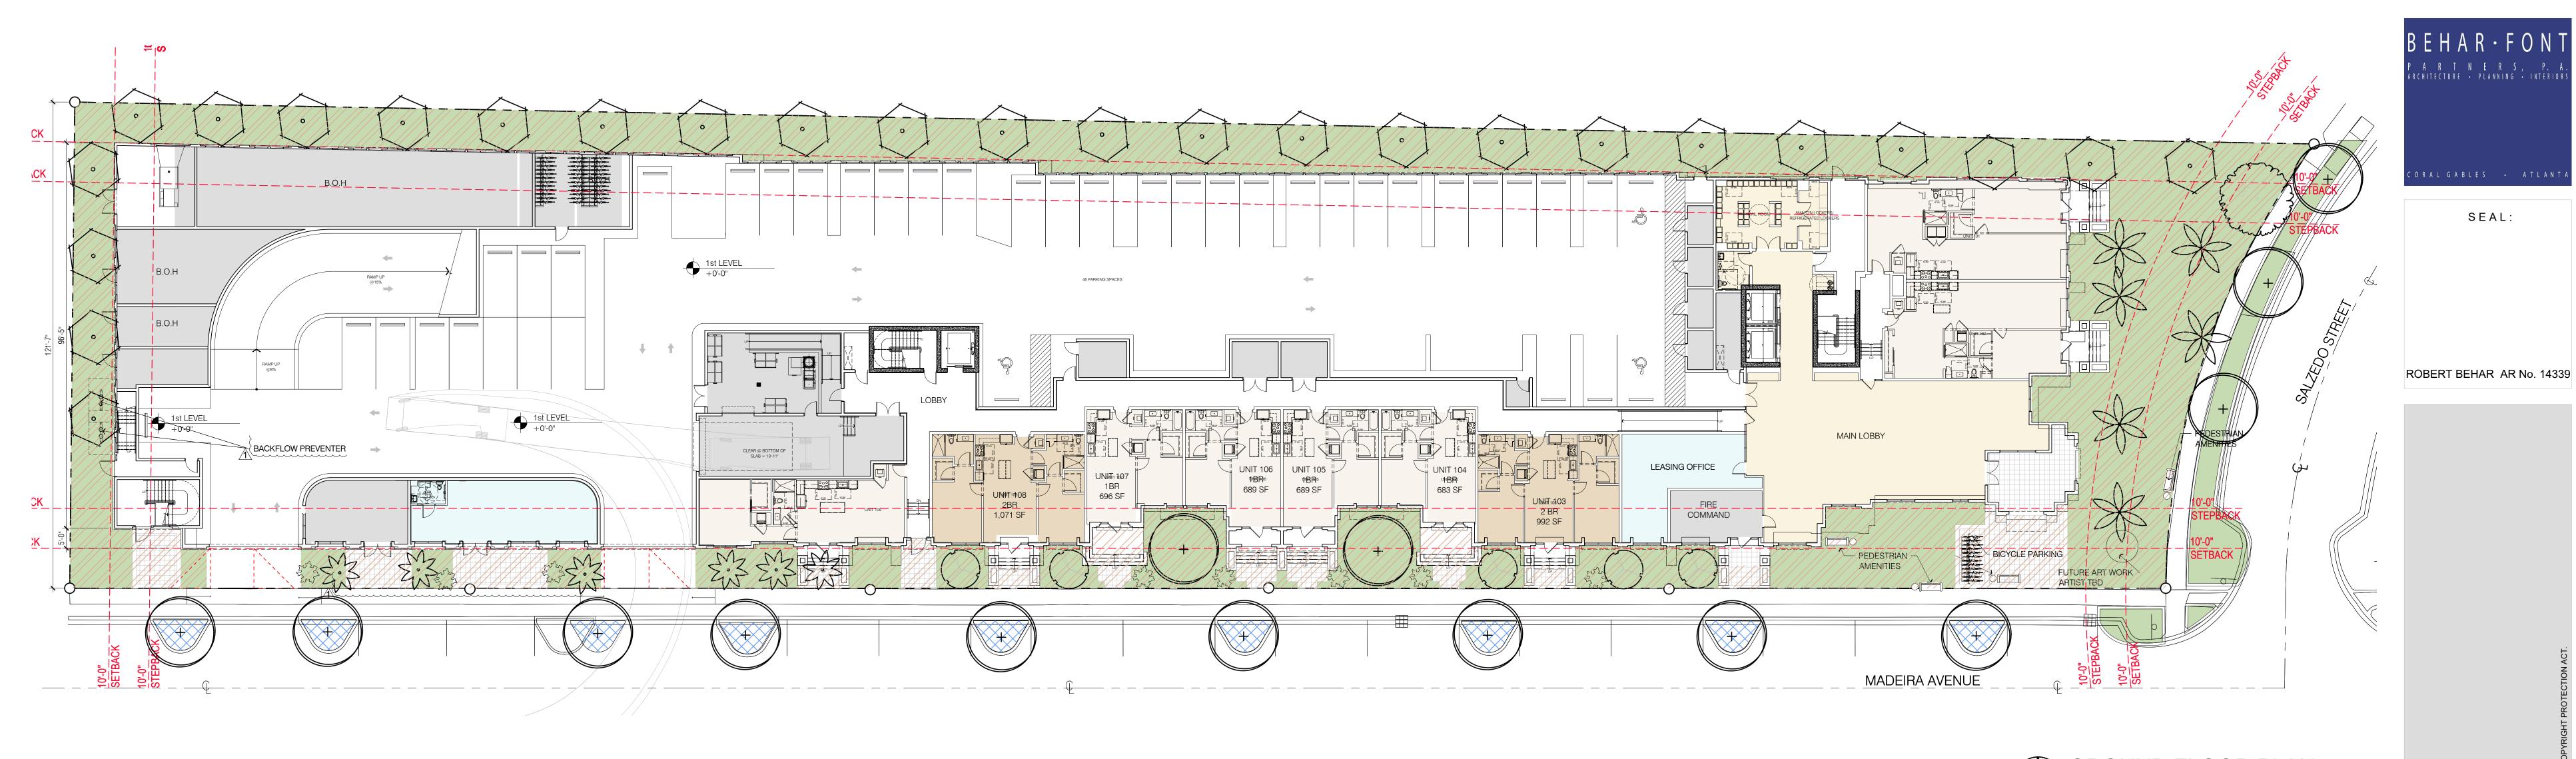

GROUND FLOC	OR PLAN
<u>^6</u> / <u>5</u>	SCALE: 1/16"

(REC	QUIRED STANDARDS) TABLE	1 (ALL REQ	UIRED)
REF	TYPE	PROVIDED	COMMENTS
1	ARCHITECTURAL ELEMENTS ON BUILDING FACADES	YES	SEE SHEET A-0.1.1 MEDITERRANEAN BONUS
2	ARCHITECTURAL RELIEF ELEMENTS AT STREET LEVEL	YES	SEE SHEET A-0.1.1 MEDITERRANEAN BONUS
3	ARCHITECTURAL ELEMENTS ON THE TOP OF BLDG.	YES	SEE SHEET A-0.1.1 MEDITERRANEAN BONUS
4	BICYCLE STORAGE	YES	SEE SHEET A-0.1.1 MEDITERRANEAN BONUS
5	BUILDING FACADES	YES	SEE SHEET A-0.1.1 MEDITERRANEAN BONUS
6	BUILDING LOT COVERAGE	YES	SEE SHEET A-0.1.1 MEDITERRANEAN BONUS
7	DRIVE THRU FACILITIES	N/A	SEE SHEET A-0.1.1 MEDITERRANEAN BONUS
8	LANDSCAPE / OPEN SPACE AREA	YES	SEE SHEET A-0.1.1 MEDITERRANEAN BONUS
0	STREET LIGHTING	N/A	SEE SHEET A-0.1.2 MEDITERRANEAN BONUS
10	PARKING GARAGES	YES	SEE SHEET A-0.1.2 MEDITERRANEAN BONUS
11	PORTE-COCHERES	N/A	SEE SHEET A-0.1.2 MEDITERRANEAN BONUS
12	SIDEWALK / PEDESTRIAN ACCESS	YES	SEE SHEET A-0.1.2 MEDITERRANEAN BONUS
13	STRUCTURAL SOIL	YES	SEE SHEET A-0.1.2 MEDITERRANEAN BONUS
14	WINDOWS ON MEDITERRANEAN BUILDINGS	YES	SEE SHEET A-0.1.2 MEDITERRANEAN BONUS

	THIS SHEET DEFICTS.
1-	CONTINUOUS SIDEWALKS AT MADEIRA AVE.
3-	PEDESTRIAN ENTRIES FROM MADEIRA AVE.

/ I L	EDITERRANEA		LE DESIGN 3 A	
ARC	CHITECTURAL AND PUBLIC	REALM STAI	NDARDS) TABLE 2 (SIX OF TWELVE REQUIRED)	
REF	TYPE	PROVIDED	COMMENTS	
1	ARCADES AND OR / LOGGIAS	YES	SEE SHEET A-0.1.3 MEDITERRANEAN BONUS	
2	BUILDING ROOF LINES	YES	SEE SHEET A-0.1.3 MEDITERRANEAN BONUS	
3	BUILDING STEPBACK	YES	SEE SHEET A-0.1.3 MEDITERRANEAN BONUS	
4	BUILDING TOWERS	YES	SEE SHEET A-0.1.3 MEDITERRANEAN BONUS	
5	DRIVEWAYS	N/A	SEE SHEET A-0.1.3 MEDITERRANEAN BONUS	
6	LIGHTING OF LANDSCAPING	YES	SEE SHEET A-0.1.3 MEDITERRANEAN BONUS	
7	MATERIALS ON EXTERIOR BUILDING FACADES	YES	SEE SHEET A-0.1.3 MEDITERRANEAN BONUS	
8	OVERHEAD DOORS	YES	SEE SHEET A-0.1.3 MEDITERRANEAN BONUS	
9	KEYSTONE PAVER TREATMENT	YES	SEE SHEET A-0.1.3 MEDITERRANEAN BONUS	
10	PEDESTRIAN AMENITIES	YES	SEE SHEET A-0.1.4 MEDITERRANEAN BONUS	
11	PEDESTRIAN PASS-THROUGHS / PASEOS	N/A	SEE SHEET A-0.1.4 MEDITERRANEAN BONUS	
12	UNDERGROUND PARKING	N/A	SEE SHEET A-0.1.4 MEDITERRANEAN BONUS	

V STY	LE DESIGN &		DITERRAN		PROVIDED	COMMENTS
REALM STA	NDARDS) TABLE 2 (SIX OF TWELVE REQUIRED)	SIY	LE DESIG	N		
PROVIDED	COMMENTS	(OTHI	ER DEVELOPMEN	NT OPTIONS) TABLE 3		
YES	SEE SHEET A-0.1.3 MEDITERRANEAN BONUS	REF	TYPE			
YES	SEE SHEET A-0.1.3 MEDITERRANEAN BONUS	1 2	BUILDING SET		N/A N/A	
YES	SEE SHEET A-0.1.3 MEDITERRANEAN BONUS	3	PARKING EXCE		N/A	
YES	SEE SHEET A-0.1.3 MEDITERRANEAN BONUS	4	MULTY-FAMILY	/ DENSITY	N/A	
N/A	SEE SHEET A-0.1.3 MEDITERRANEAN BONUS	L	EGEND			
YES	SEE SHEET A-0.1.3 MEDITERRANEAN BONUS			TOTAL NET LOT AREA	A 1 6	62,474 SQ.FT.
YES	SEE SHEET A-0.1.3 MEDITERRANEAN BONUS			GROUND FLOOR LANDSCAPE OPEN S	····- / 5 \ / 2 \\	,492 SQ.FT.
YES	SEE SHEET A-0.1.3 MEDITERRANEAN BONUS			(WITHIN PROPERTY L	INE)	
YES	SEE SHEET A-0.1.3 MEDITERRANEAN BONUS			GROUND FLOOR LANDSCAPE OPEN S (WITHIN THE PUBLIC	<u>/5</u> \ <u>/2</u> \	1,534 SQ.FT.
YES	SEE SHEET A-0.1.4 MEDITERRANEAN BONUS			RIGHT-OF-WAY SECT	11011 5604)	
N/A	SEE SHEET A-0.1.4 MEDITERRANEAN BONUS		LANDS	SCAPE		
N/A	SEE SHEET A-0.1.4 MEDITERRANEAN BONUS		TOTAL NET	T LOT AREA = 62,474 S	S.F. (100%)	
			TOTAL LAN	NDSCAPE OPEN SPACE	E AREA:\\15,942 S	S.F. (25.5%)
			•	1UM GROUND-LEVEL L IAL PROPERTIES (SECT		
			FOOT PRIN	NT BUILDING	46,532 S.F.	

Provided: 25.5% = 15,942 SQ.FT.

B E H A R · F O N

RAL GABLES • ATLANT

SEAL:

ROBERT BEHAR AR No. 14339

301-341

DATE: 10-22-2021

DRAWING NAME

SHEET NO:

PROJECT NO: 18-035

A-0.1.6


ΓAΒL	_E 1				
9.	>	>	*	Lighting, street.	Street lighting shall be provided and located on all streets/rights-of- way. The type of fixture shall be the approved City of Coral Gables light fixture and location/spacing, etc. shall be the subject to review and approval by the Department of Public Works.
REQ	UIREI	MENT	S SAT	TISFIED	Lighting will be provided as required by the City of Coral Gables.
10.	~	√	~	Parking garages.	Ground floor parking as a part of a multi-use building shall not front on a primary street. ADA parking is permitted on the ground floor. Ground floor parking is permitted on secondary/side streets and shall be fully enclosed within the structure and/or shall be surrounded by retail uses and/or residential units. Ground floor parking is permitted on alley frontages.
					Parking facilities shall strive to accommodate pedestrian access to all adjacent street(s) and alleys.
•			S SAT of pai	TISFIED rking)	Ground Floor parking does not front a primary street. The garage entrance is located on secondary street (Madeira Avenue) and is fully concealed within the structure. Units and amenities surround the parking at the ground level facing the primary frontage (Salzedo Street).
11.	~	V	~	Porte- cocheres.	Porte-cocheres are prohibited access to/from Ponce de Leon Boulevard from S.W. 8th Street to Bird Road, Miracle Mile from Douglas Avenue to LeJeune Road, and Alhambra Circle from Douglas Avenue to LeJeune Road.
REQ	UIREI	MENT	S SAT	ISFIED	There are no porte-cocheres.
12.		~	•	Sidewalks/ pedestrian access.	All buildings, except accessory buildings, shall have their main pedestrian entrances oriented towards adjoining streets. Pedestrian pathways and/or sidewalks shall be provided from all pedestrian access points and shall connect to one another to form a continuous pedestrian network from buildings, parking facilities, parking garages entrances, etc. Wherever possible pathways shall be separated from vehicular traffic.
REQ	UIRE	MENT	S SAT	ISFIED	The building has its main pedestrian entrances oriented towards the corner of Madeira Avenue and Salzedo Street with a continuous pedestrian network connecting both building frontages.
13.	¥	4	Y	Soil, structural.	Structural soil shall be utilized within all rights-of-way for all street level planting areas with root barriers approved by the Public Service Department.
REQ	UIRE	MENT	S SAT	ISFIED	The project will comply with this requirement.
14.	1	V	· /	Windows on Mediterranean buildings.	Mediterranean buildings shall provide a minimum window casing depth of four (4) inches as measured from the face of the building.





301-341 MADEIRA AVE CORAL GABLES, FLORIDA 33134

SEAL:

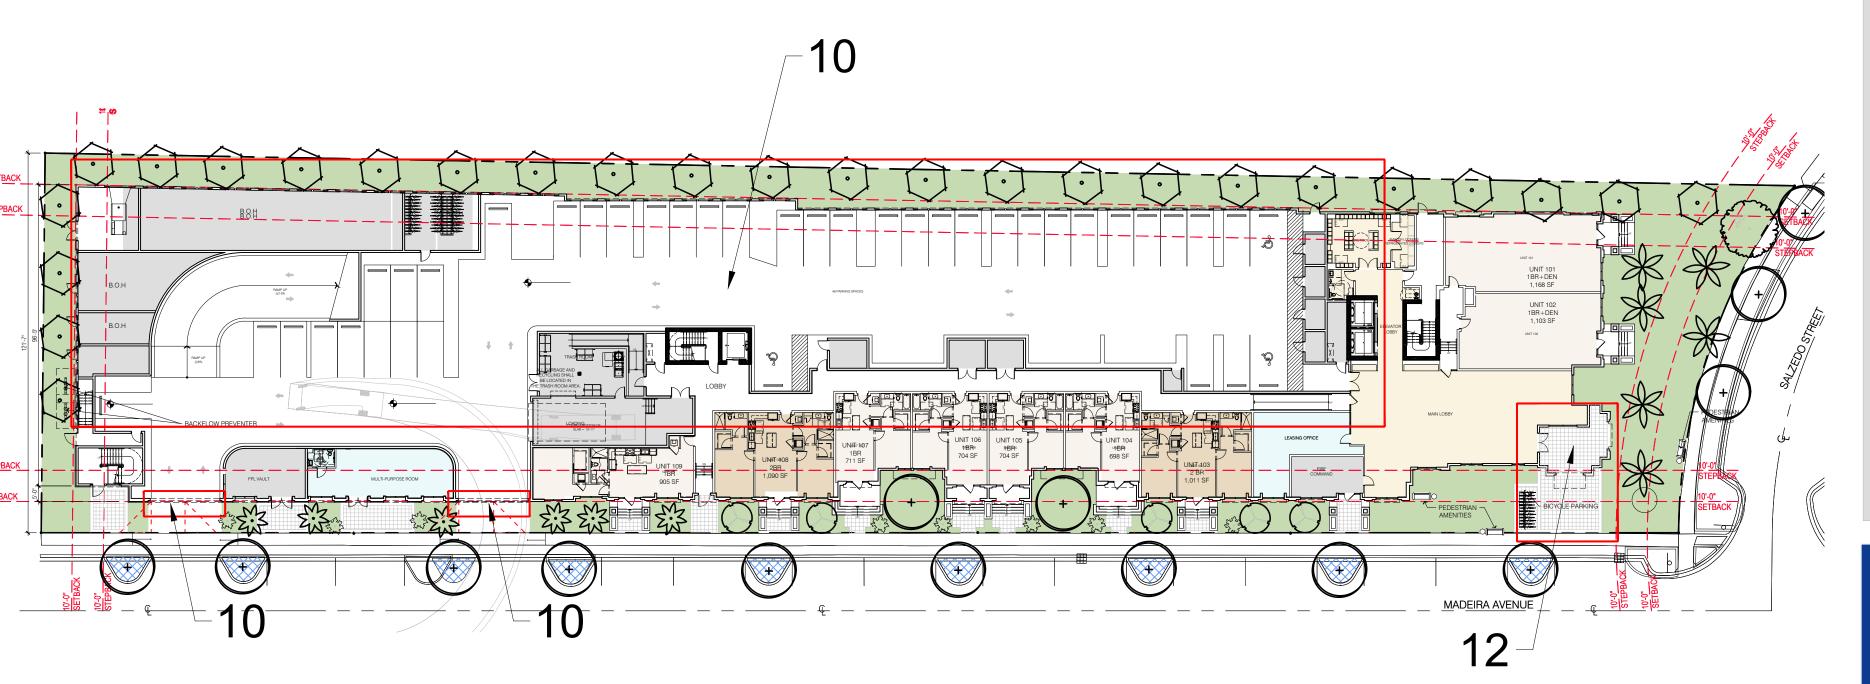

® REV. 10-22-2021 ∕5 REV. 07-26-2021

DATE: 10-22-2021 PROJECT NO: 18-035 DRAWING NAME: SHEET NO: A-0.1.7

MEDITERRANEAN BONUS

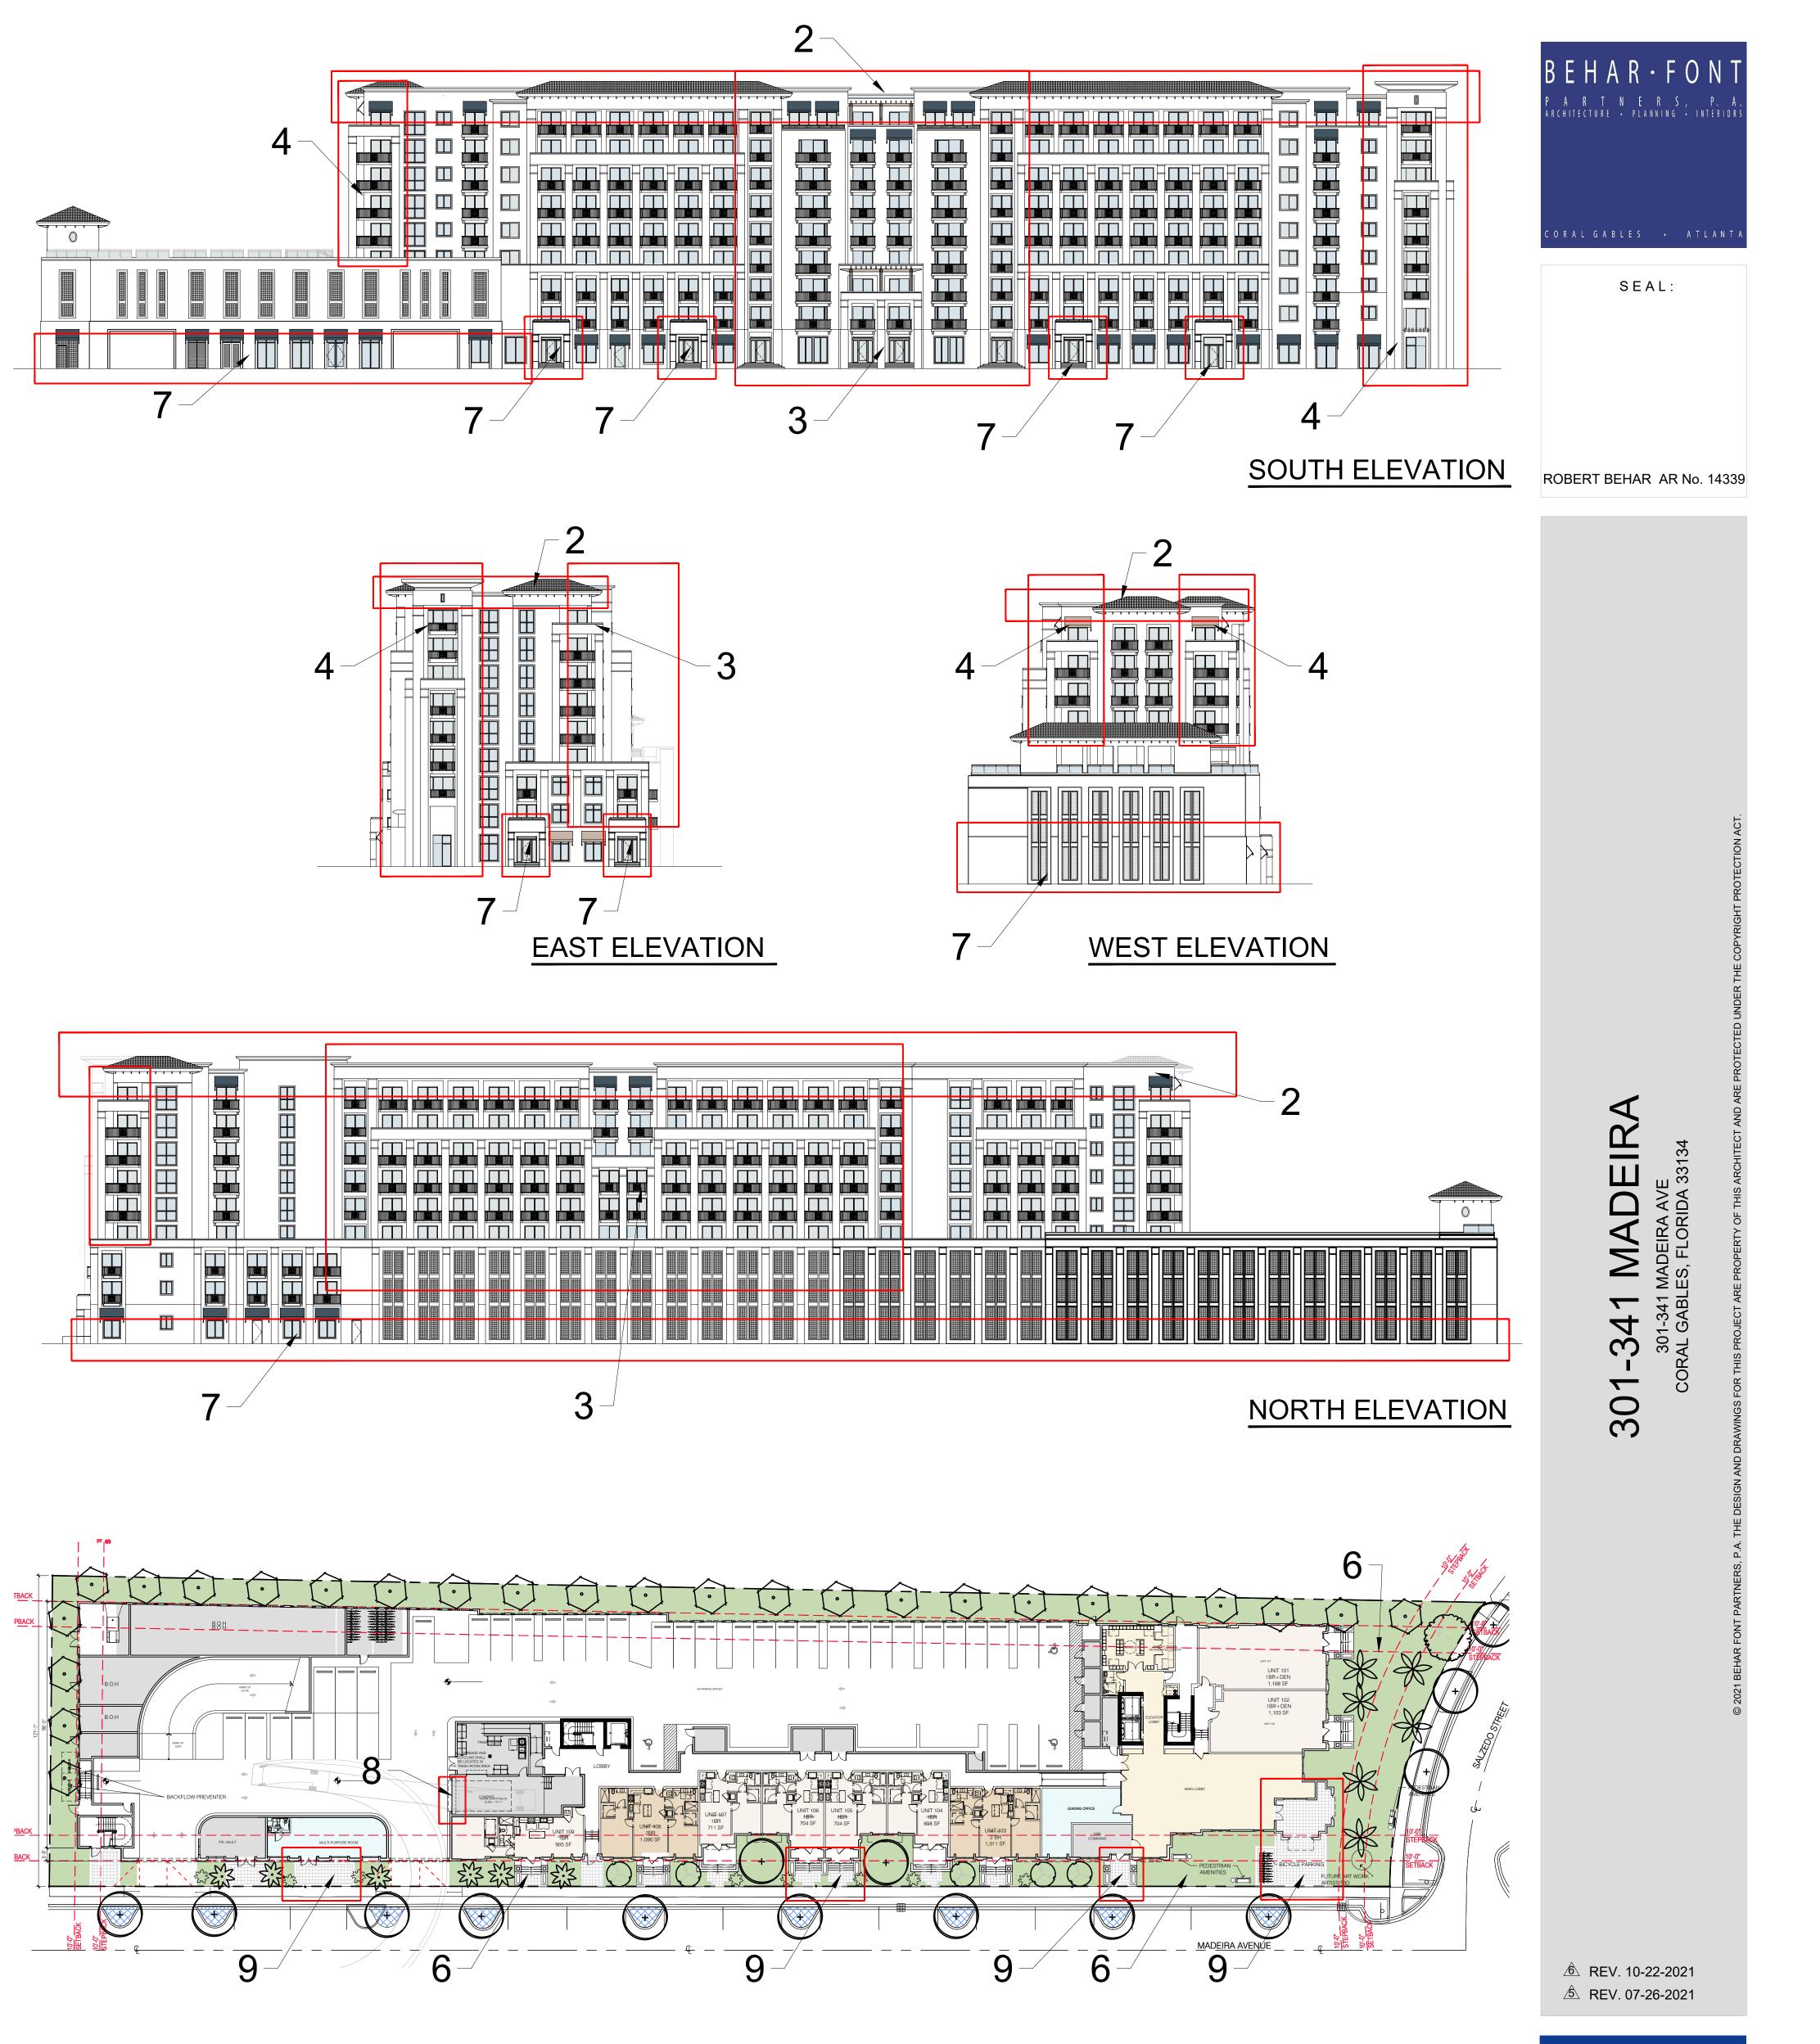


TABLE	1.20		100	Pedestrian	Dedectries emenities on both private preparty and/or public
10.	9 * 0	i i Meriti.		amenities.	Pedestrian amenities on both private property and/or public open spaces including a minimum of four (4) of the following: a. Benches. b. Expanded sidewalk widths beyond the property line. c. Freestanding information kiosk (no advertising shall be permitted). d. Planter boxes. e. Refuse containers.
REQUI	IREM	ENTS	SSAT	ISFIED	f. Public art. g. Water features, fountains and other similar water features. Ground and/or wall mounted. Above amenities shall be consistent in design and form with the City of Coral Gables Master Streetscape Plan. Pedestrian amenities to be included: benches, expanded sidewalks at Madeira Avenue, refuse containers, and planter boxes. All of the above amenities will be consistent with the City of Coral Gables masterstreetscape plan.
11.			~	Pedestrian pass- throughs/ paseos on properties contiguous to alleys and/or streets.	Pedestrian pass-throughs provided for each two hundred and fifty (250) linear feet or fraction thereof of building frontage provided on properties contiguous to alleys and/or streets or other publicly owned properties. Buildings less than two hundred and fifty (250) feet in size shall provide a minimum of one (1) pass through. The pass-throughs shall be subject to the following: a. Minimum of ten (10) feet in width. b. Include pedestrian amenities as defined herein. In lieu of providing one (1) pass-through of ten (10) feet in width every two hundred and fifty (250) feet of building frontage, two (2) pass-throughs can be combined to provide one (1) twenty (20) foot wide pass-through.
N/A					Northern side of the site is Miami Dade County and abuts another property. A pedestrian pass-through is not appropriate for this site.
12.	✓	~	√	Underground parking.	The use of underground (below grade level) parking, equal in floor area of a minimum of seventy-five (75%) percent of the total surface lot area. Underground parking shall be located entirely below the established grade as measured from the top of the supporting structure and includes all areas utilized for the storage of vehicles and associated a circulation features.
N/A					











WEST ELEVATION

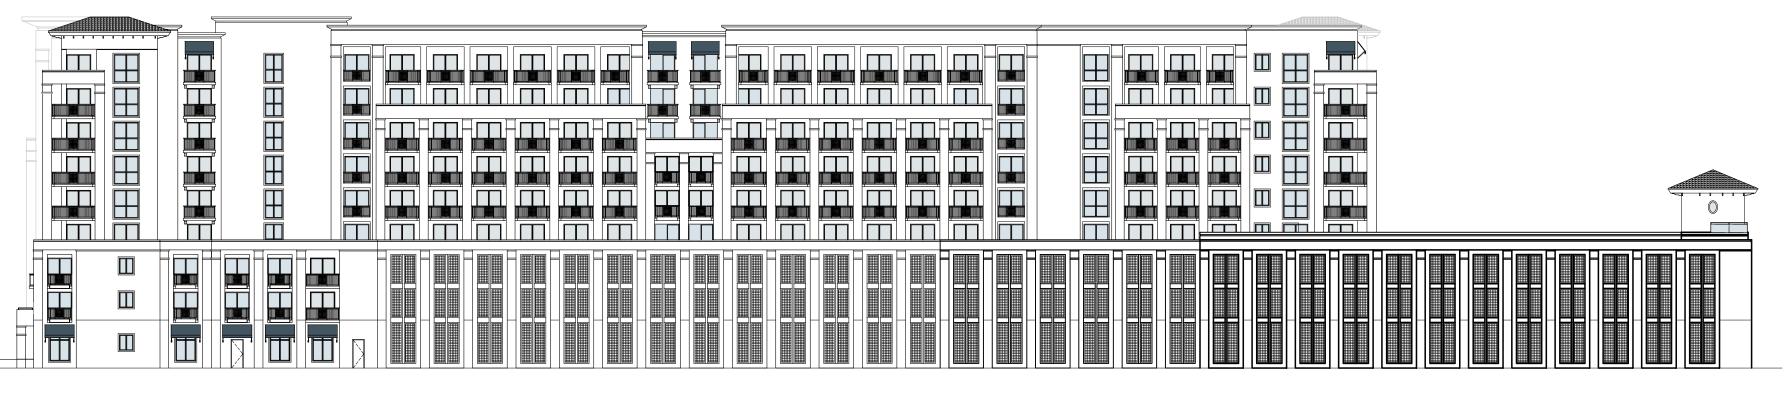

NORTH ELEVATION

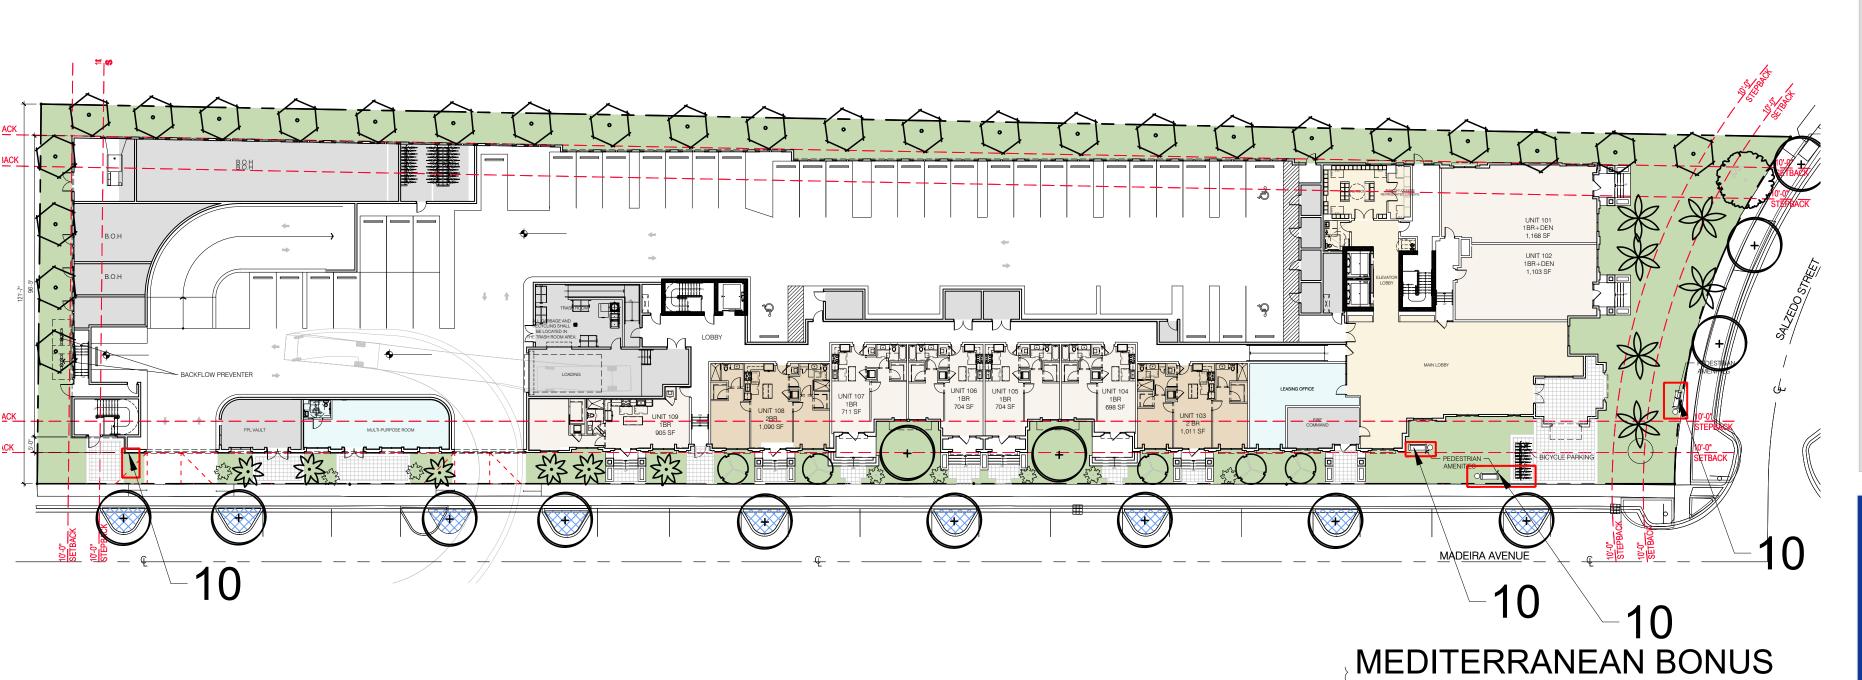

® REV. 10-22-2021 ⓑ REV. 07-26-2021

301-341 MADEIRA AVE CORAL GABLES, FLORIDA 33134

HISTORICAL REFERENCE


This project takes its influence from surrounding buildings within the city of Coral Gables.

There are several architectural features that characterize this project as Mediterranean/Transitional Architecture. The proposed design makes reference to the proportion and architectural elements of Coral Gables landmarks such as the Biltmore Hotel, the Colonnade Building, and San Sebastian Apartments.

The project consists of symmetrical primary façade (South Elevation) that sits on a base composed of two orders of arcades. All façade corners are addressed by tower elements reminiscent to the corner design present on the Colonnade Building. The dynamic mass of the building is emphasized by vertical breaks that follow the scale of the Biltmore Hotel.


In addition, a roof loggia used on the West Elevation, and the proportions of the arcade are elements derived from San Sebastian Apartments. The implementation of balconies, awnings, trellises and the vertical composition elements are also incorporated as part of the overall design composition. The roof line design also incorporates vertical and horizontal changes in height and style, including mansard roof with clay barrel tile seen in different Mediterranean style building like the Biltmore Hotel.


The overall design and façade composition for 301-341 Madeira have been faithful to its Mediterranean / Transitional Architectural style inspired by some of the most important and representative landmarks found in the city of Coral Gables.

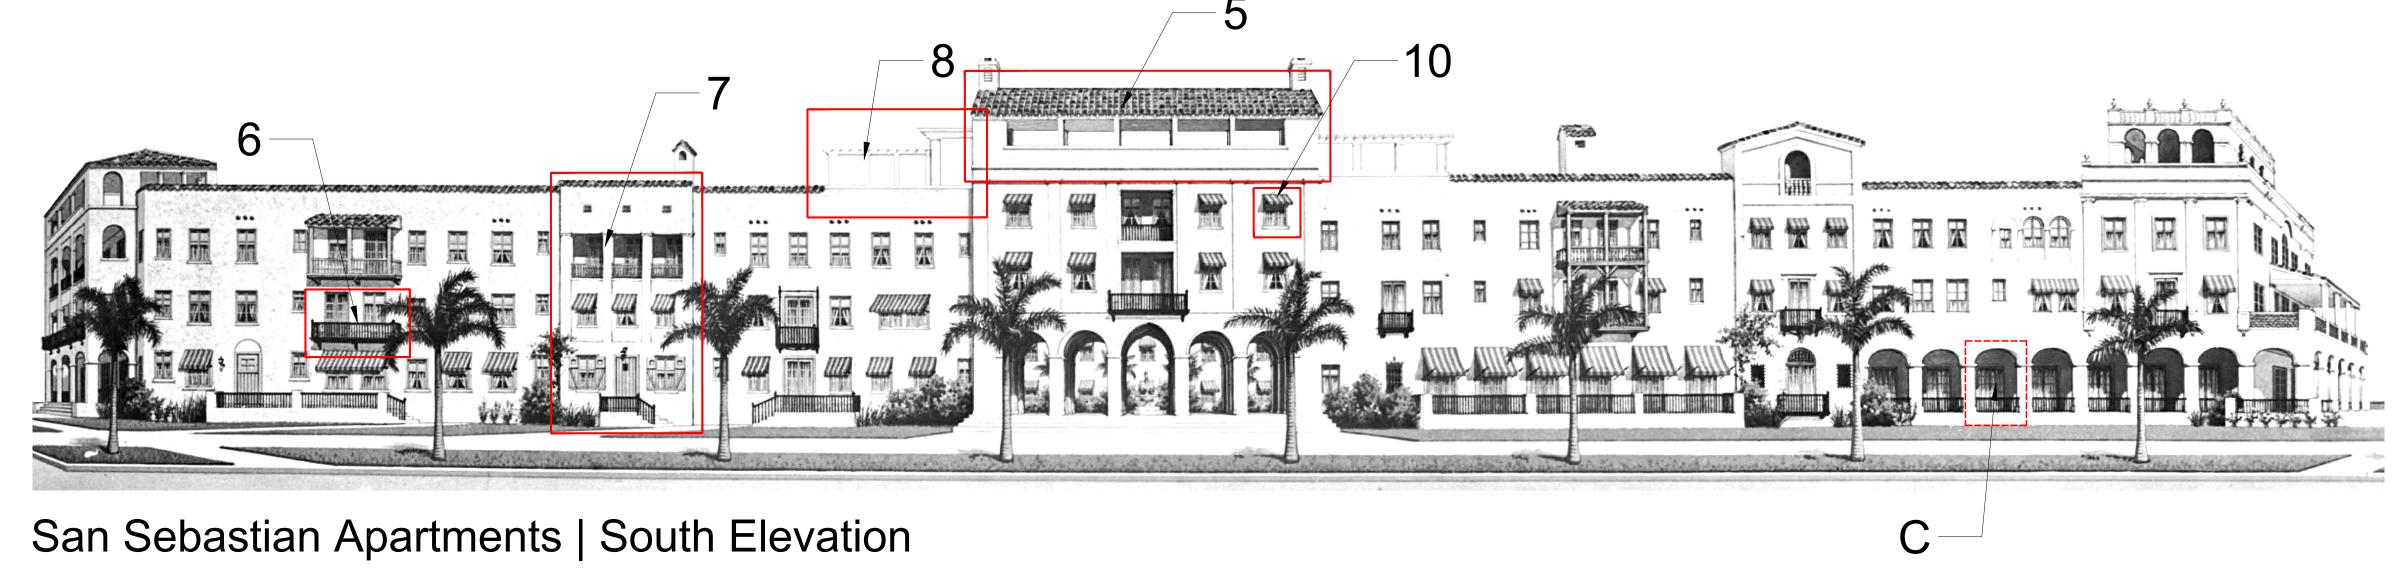





6

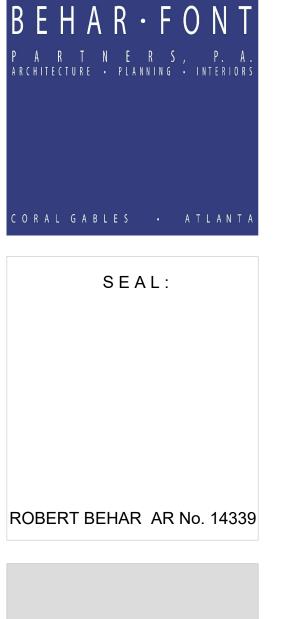

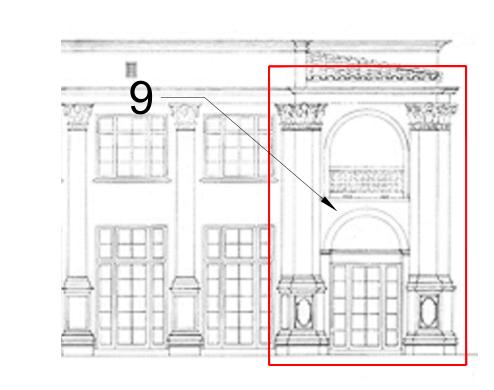

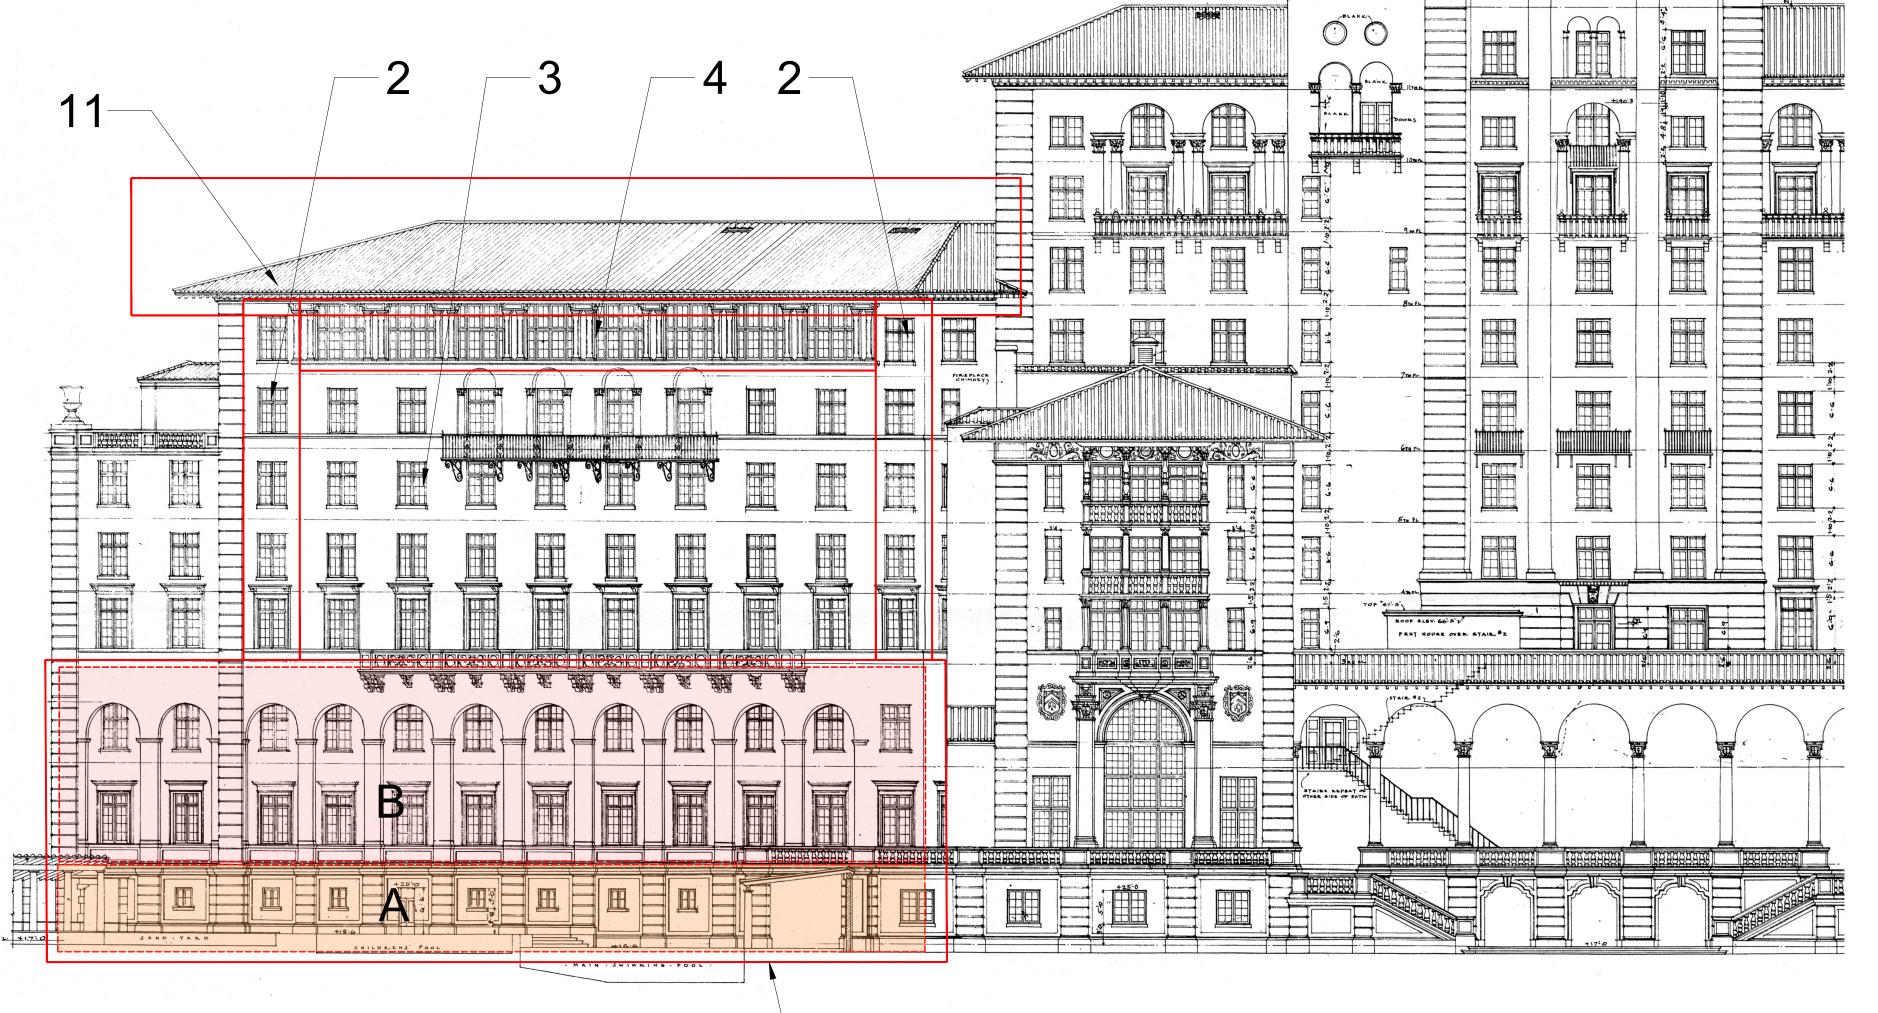

10

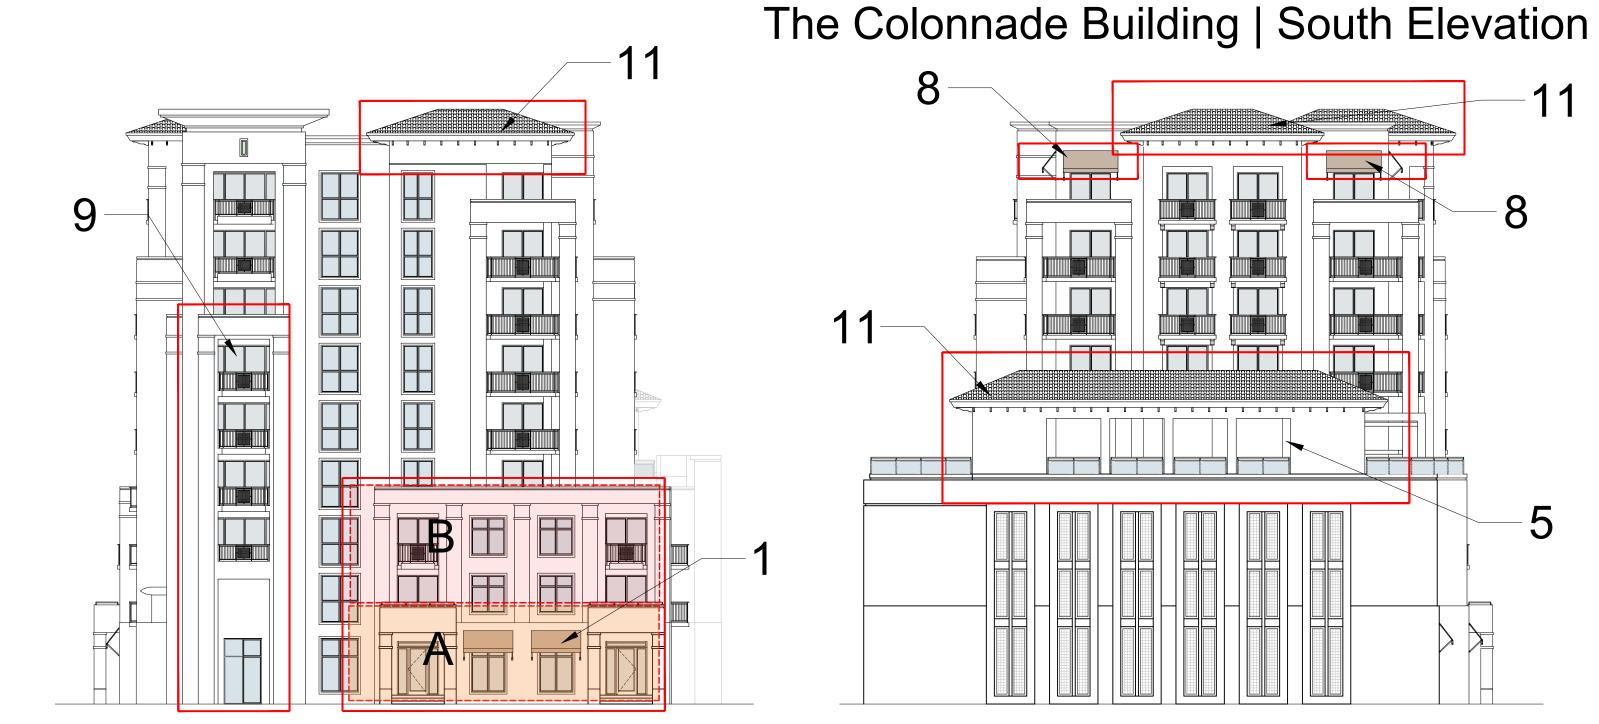


Proposed Design | East Elevation

Proposed Design | West Elevation

Biltmore Hotel | South Elevation



REV. 10-22-2021 ⚠ REV.07-26-2021

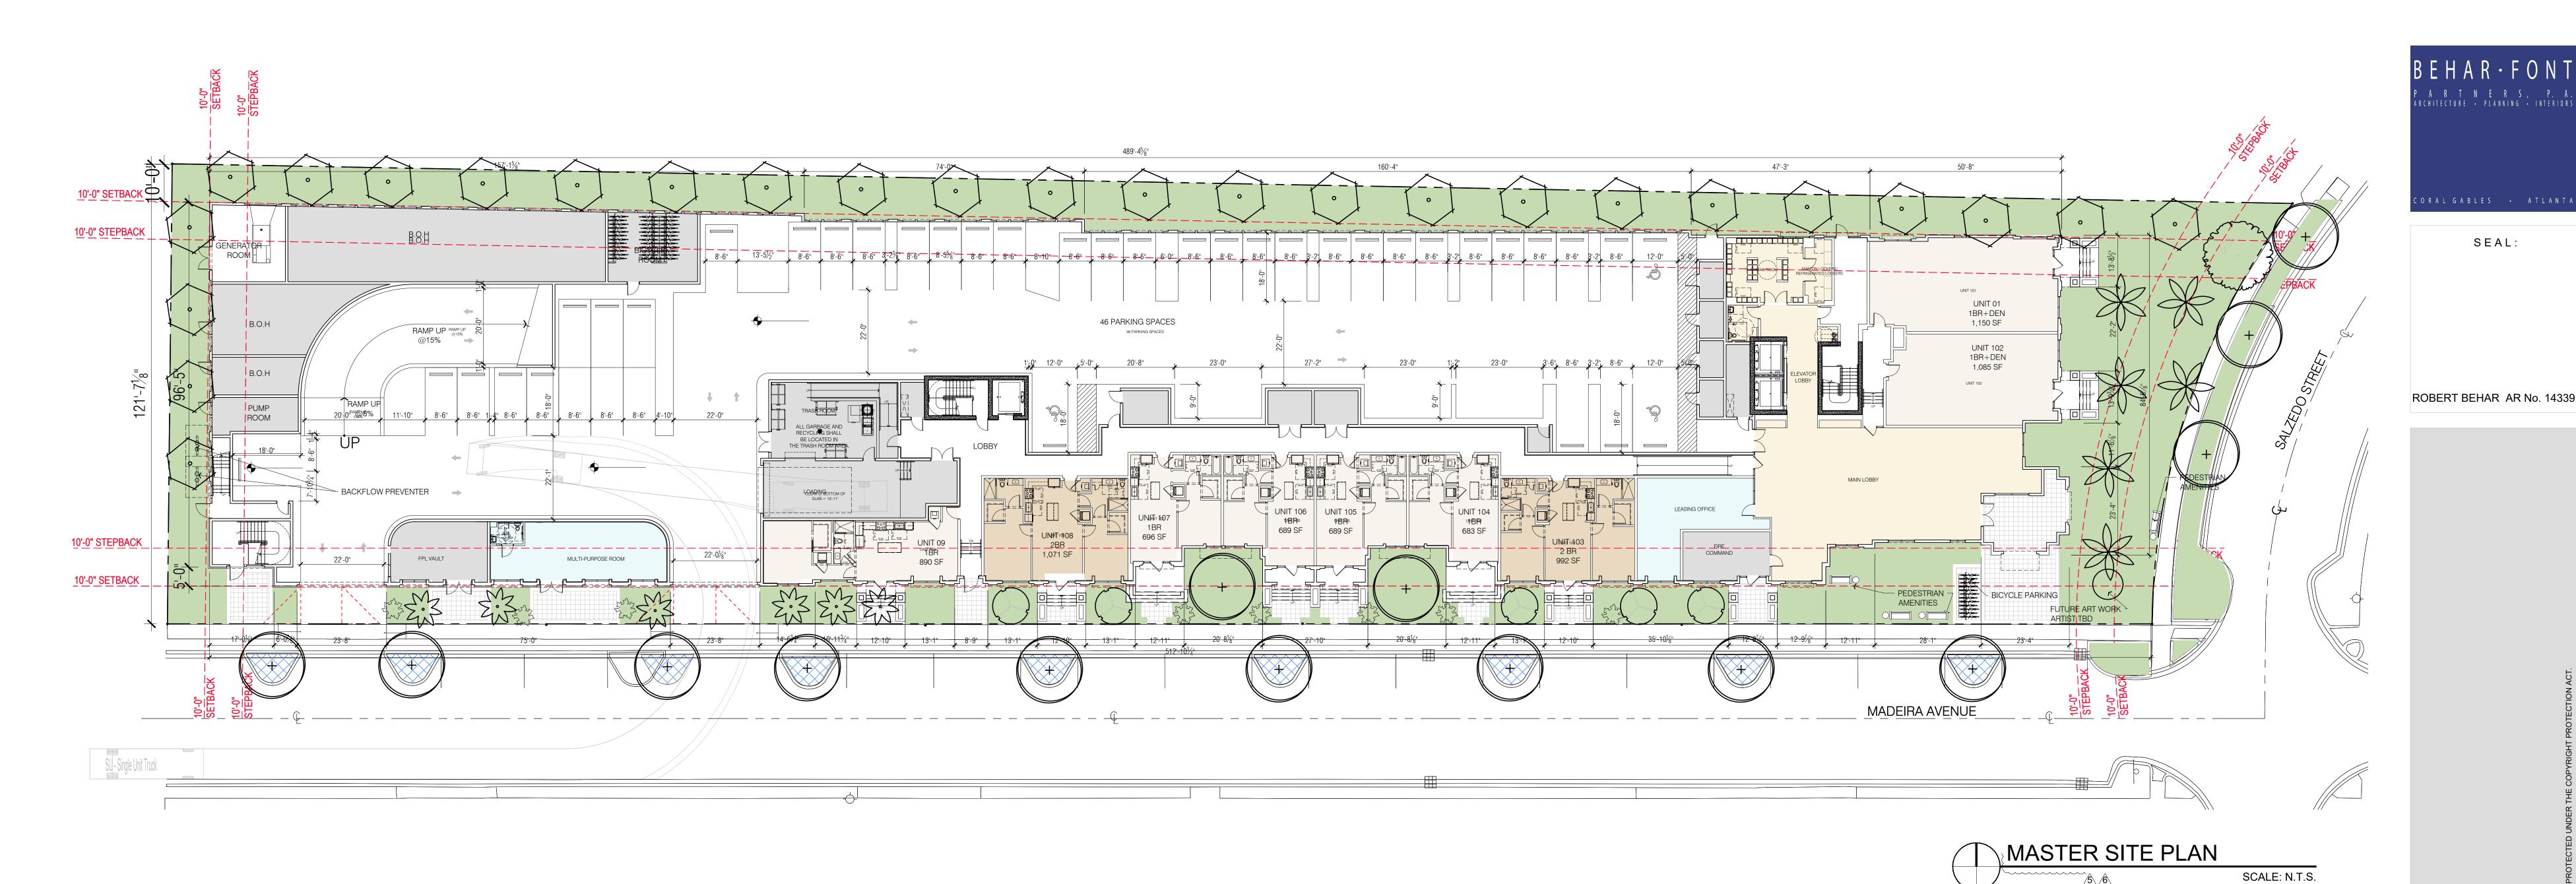

ZONING INFORMATION

301-341 MADEIRA AVENUE. CORAL GABLES,FL 33134

RECORDS OF MIAMI DADE COUNTY, FLORIDA. (SEE SURVEY)

MULTI-FAMILY 2 (MF2) AND RESIDENTIAL INFILL OVERLAY (RIR)

LOTS 4 THRU 24 OF BLOCK 1 OF "REVISED PLAT OF CORAL GABLES SECTION K" ACCORDING

ZONE "X"

FLOORS

ALLOWED

100 Units per Acre

1.43 Acres X 100 (143 Units)

9.00

REQUIRED

AS PER RIR

10'-0" MINIMUM

10'-0" MINIMUM

10'-0" MINIMUM

10'-0" MINIMUM

PROVIDED

10%

REQUIRED

25% OF 62,474 SF (

GROUND LEVEL

5% @ ELEVATED DECK = 3,123.7 SF

683-890 SF

665-724 SF

665-724 SF

650 -731 SF

650 -731 SF

650 -731 SF

1 BEDROOM

UNITS SQ. FT.

47%

=15,618.5 SF

1.43 Acres

TOTAL (SF)

156,183

PROVIDED

9

PROVIDED

AS PER PAD 25'-6" UP TO 45'-0"

34'-9" ABOVE 45'-0" 10'-0" up to 45'-0"

19'-4" ABOVE 45'-0" 10'-0" UP TO 45'-0"

106'-10" ABOVE 45'-0" 10'-0" UP TO 45'-0"

23'-3" ABOVE 45'-0"

15,618.5 SF

3,945 SF (6.31%)

1,085-1,150 SF

1,083-1,150 SF

1,083-1,150 SF

964 SF

964 SF

1 BEDROOM + DEN

UNITS SQ. FT.

21,421 SF = 34.3%

2 BEDROOMS

38%

141

UNITS SQ. FT.

1,071 SF

905-1,081 SF

905-1,081 SF

1,037-1,269 SF

1,037-1,269 SF

1,037-1,269 SF

141

TO THE PLAT THEREOF AS RESEARCHED IN PLAT BOOK 30 AT PAGE 60 OF THE PUBLIC

301-341 MADEIRA AVENUE

PAD W/ RIR SITE PLAN APPROVAL

AREA (SF)

20,076

19,895

62,474 SQ.FT.

PROJECT NAME:

PROPERTY ADDRESS:

LEGAL DESCRIPTION:

PROPOSED ZONING APPROVALS:

FEDERAL FLOOD HAZARD:

EXISTING ZONING:

NET LOT AREA:

FLOOR AREA

GROUND FLOOR 2ND LEVEL 3RD LEVEL 4TH REC LEVEL

5TH-8TH LEVELS

LIVE / WORK UNITS

OPEN SPACE

UNIT MIX

2ND LEVEL

3RD LEVEL

9TH LEVEL

4TH REC LEVEL

TYP LEVEL (5TH-8TH)

BUILDING SETBACKS

(As per 4-201.E.13 City of Coral Gables Zoning Code)

(As per 3-502.C.10 City of Coral Gables Zoning Code)

WEST INTERIOR SIDE (ADJACENT PROPERTY)

NORTH REAR SIDE (ADJACENT PROPERTY)

GROUND FLOOR (LIVE WORK UNITS)

TOTAL

EAST FRONT (SALZEDO STREET)

SOUTH SIDE STREET (MADEIRA AVE)

REQUIRED PROVIDED RESIDENTIAL PARKING *EFF.* & 1BR UNITS @ 1.00 2BR UNITS @ 1.75 2BR UNITS: 54 96.00 15.75 3BR UNITS @ 2.25 3BR UNITS:7 16.00 LIVE/WORK UNITS 9 UNITS: 1/UNIT + 1/350SF OF WORK SPACE 18.00 18.00 COMMERCIAL PARKING

HANDICAPPED PARKING	REQUIRED	PROVIDED
HANDICAP PARKING		
201-300 SPACES = 7 HC SPACES REQUIRED	7	7
NUMBER OF HANDICAP SPACES REQUIRED TO BE VAN ACCESSIBLE		
(1 PER 6 REQ. HC SPACES) = 1.16 REQUIRED	2	2

REQUIRED		PROVIDED	
2% X 212=	5	5	
3% X 212=	7	7	
15% X 212=	32	32	
	2% X 212= 3% X 212=	2% X 212= 5 3% X 212= 7	$2\% \times 212 = 5$ 5 5 3% $\times 212 = 7$ 7

1 SPACE @ 300 SF

TOTAL PARKING:

BICYCLE PARKING	REQUIRED	PROVIDED
Minimum of 1 bicycle storage spaces for every 4 dwelling units	36	40

TOTAL PARKING SPACES PROVIDED PER FLOOR	# SPACES PROVIDED				
TOTAL FARRING STACES FROVIDED FER I LOOR	TOTAL:	HANDICAP:	ELECTRIC VEHICLE	E-READY	E-INFRASTRUCTURE READY
GROUND FLOOR	46	(3HC SPACES)	0	0	0
PARKING LEVEL 2	75	(2 HC SPACES)	0	0	0
PARKING LEVEL 3	92	(2 HC SPACES)	5	7	32
TOTAL		7	5	7	32
				21	3 SPACES

2.11

212

3.00

213

NOTES:

LIVE/WORK

UNITS

3 BEDROOMS

UNITS SQ. FT.

1,622 SF

1,622 SF

LEASSING OFFICE (635 SF)

FLORIDA GREEN BUILDING COUNCIL EQUIVALENT TO LEED SILVER CERTIFICATION WILL BE PROVIDED.

}	ZONING
<u>^6</u> <u>/5</u> <u>/4</u> / <u>3</u> / <u>2</u> / <u>1</u>	

301-341 MADEIRA AVE


® REV. 10-22-2021

® REV. 07-26-2021

A REV. 04-26-2021

⚠ REV. 03-16-2021

② REV. 01-28-2021 ① REV. 12-15-2020

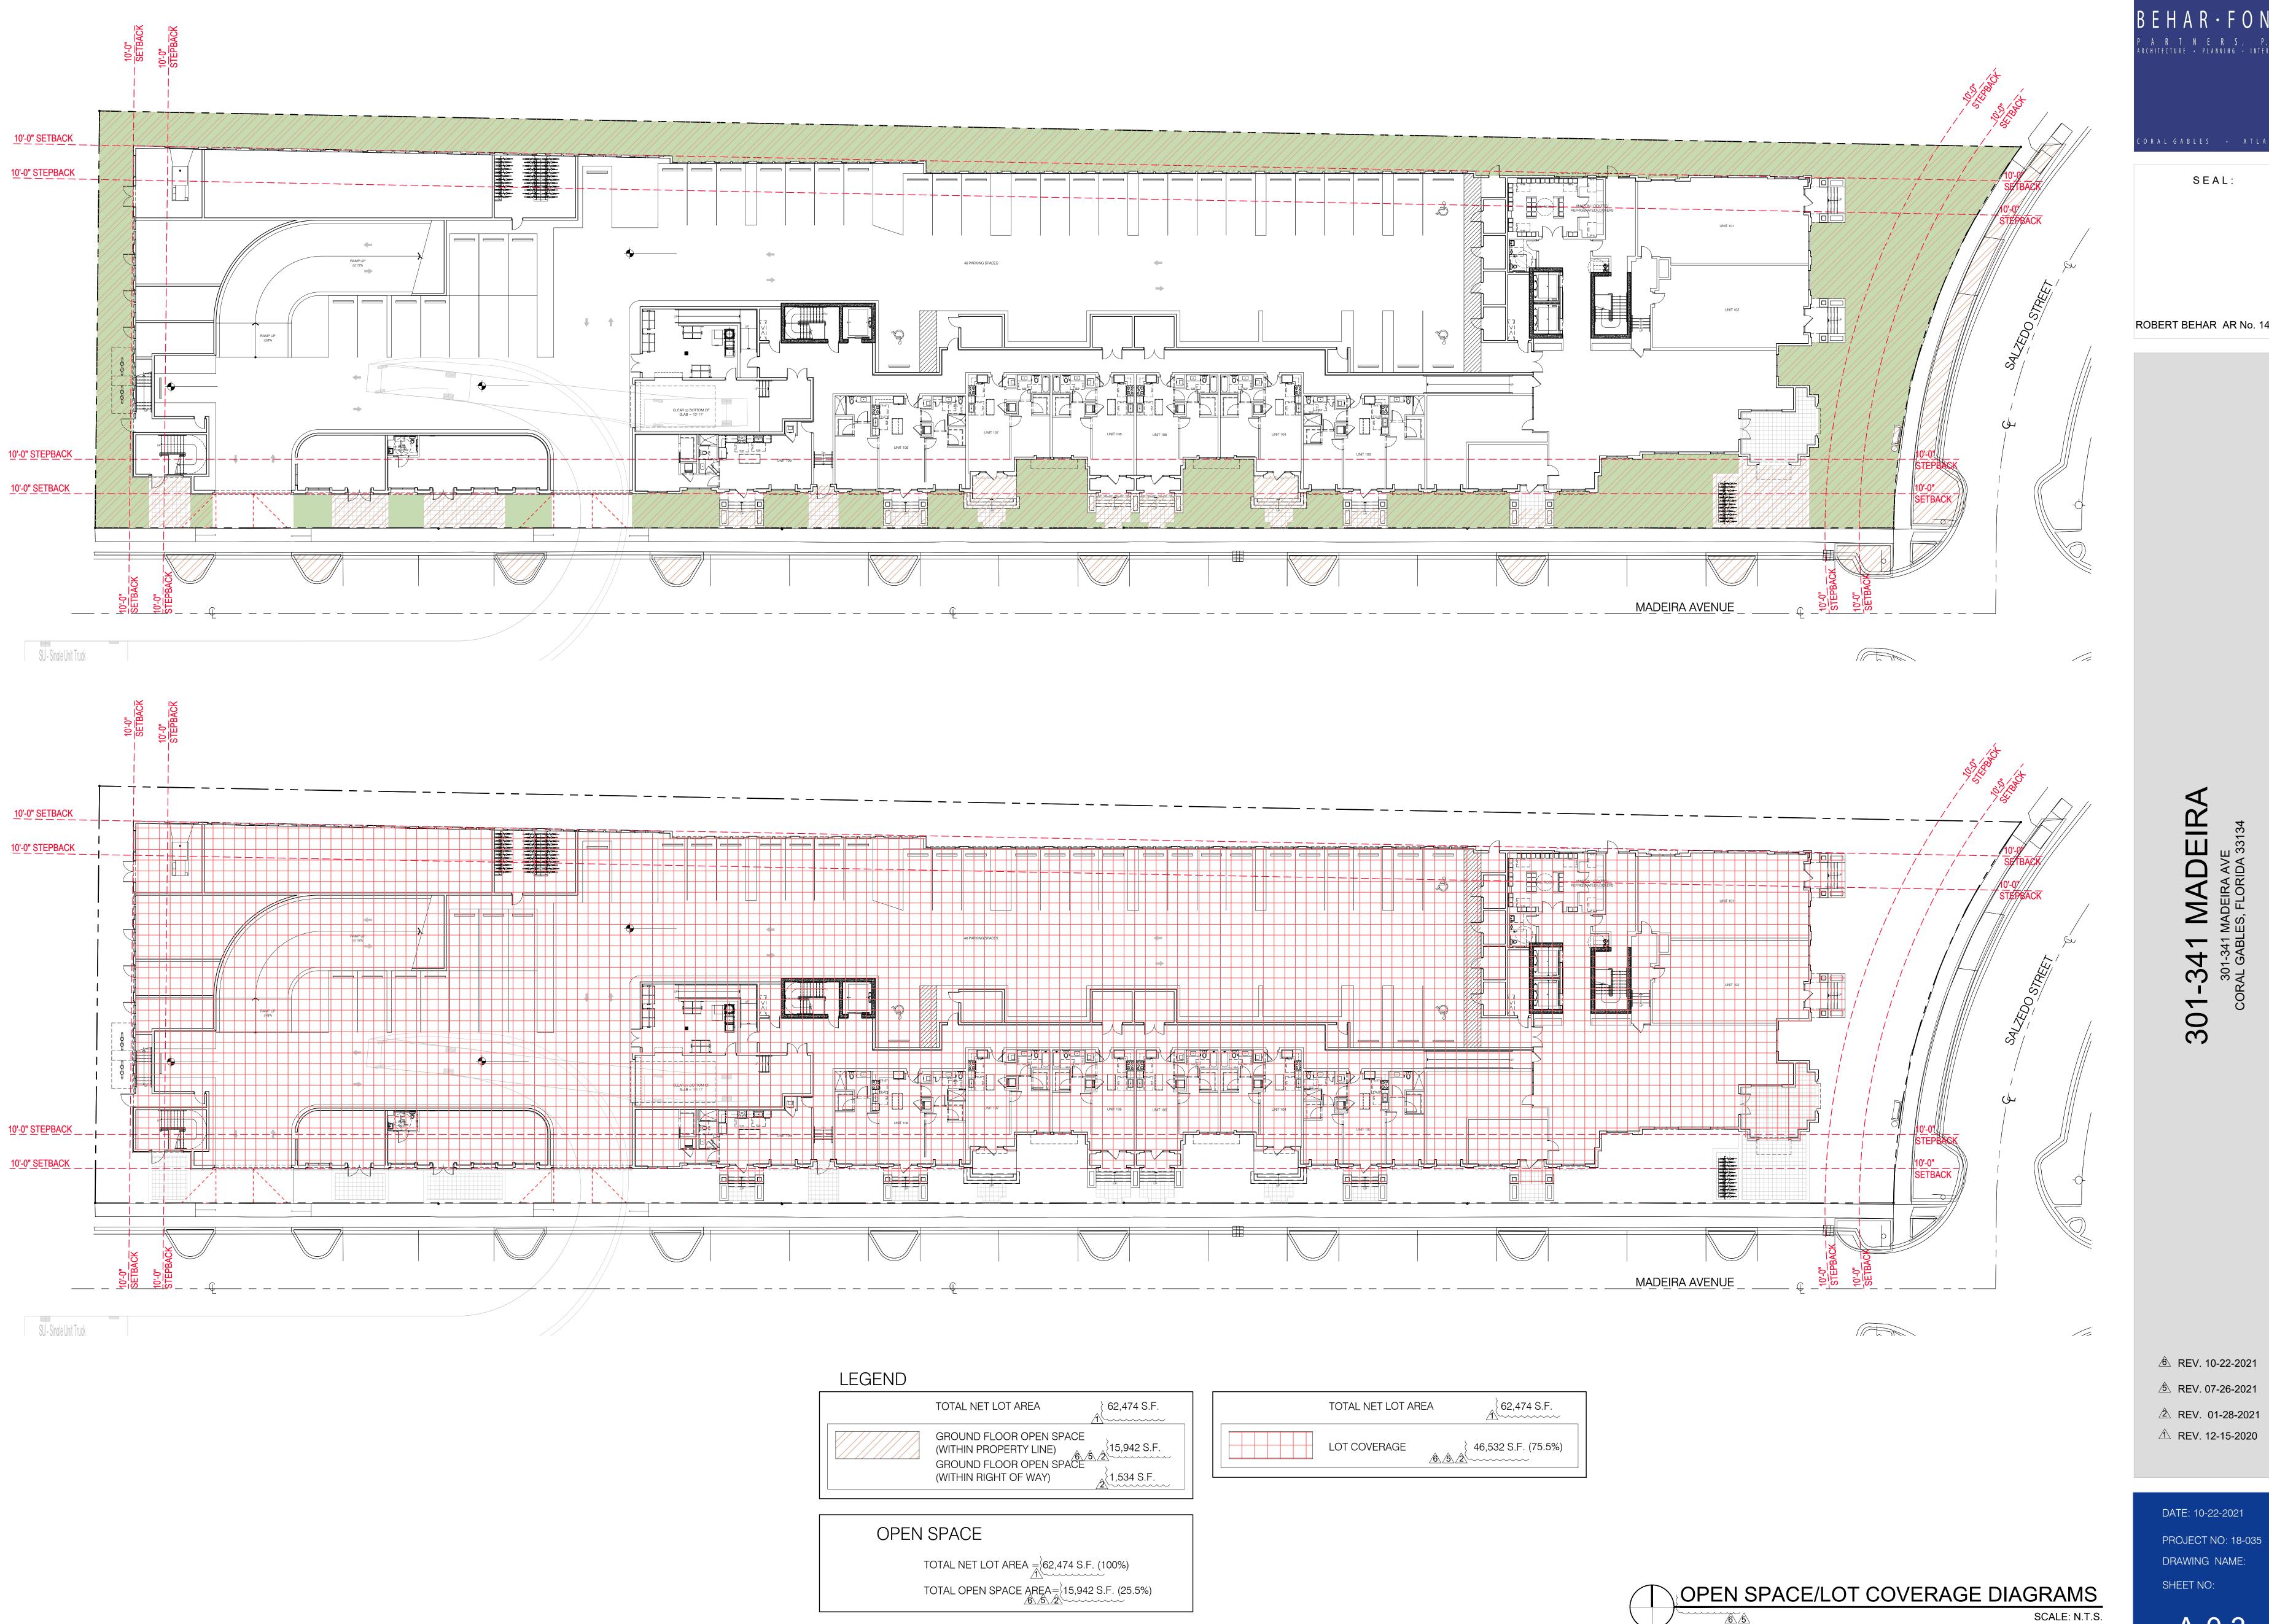


CORAL GABLES • ATLANTA

ROBERT BEHAR AR No. 14339

DATE: 10-22-2021 PROJECT NO: 18-035 DRAWING NAME:

A-0.3

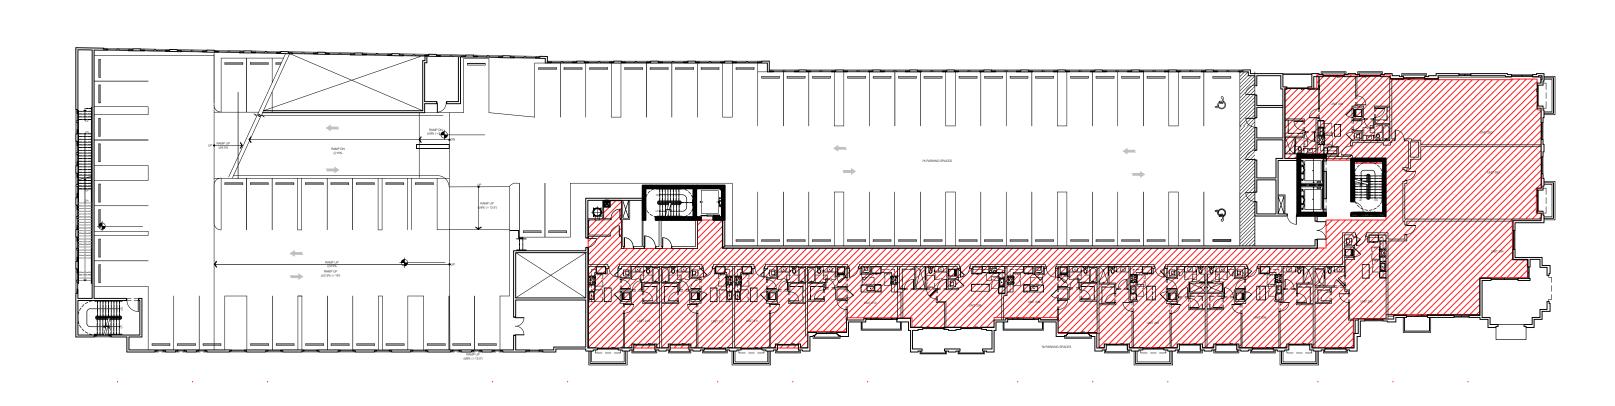

ORAL GABLES • ATLANT

SEAL:

2ND LEVEL

ROBERT BEHAR AR No. 14339


MADEIRA

301-341


3RD LEVEL

GROUND LEVEL

4TH LEVEL

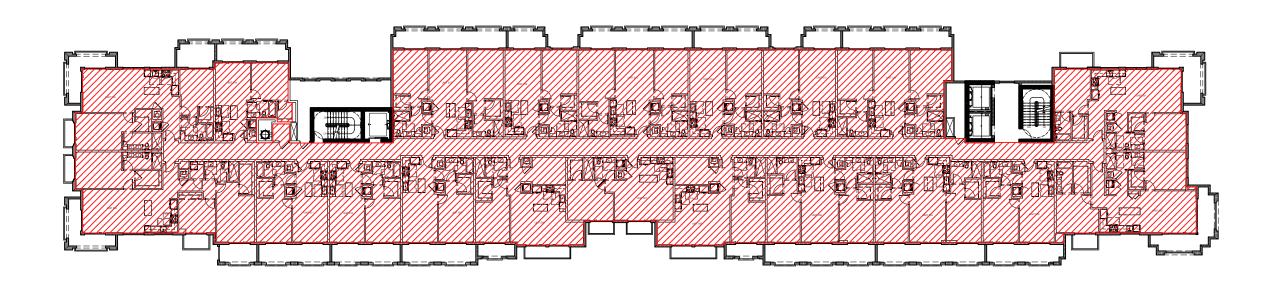

5TH TO 8TH LEVELS

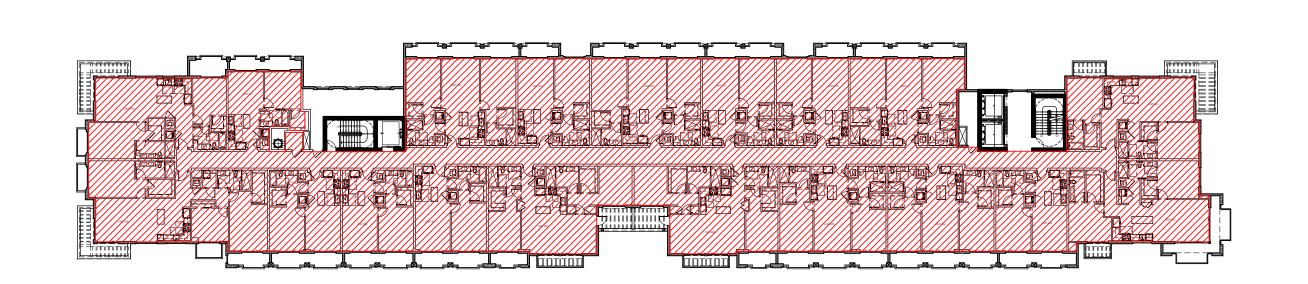

9TH LEVEL

⚠ REV. 10-22-2021 ⚠ REV. 07-26-2021

⚠ REV. 03-16-2021 Æ REV. 01-28-2021

⚠ REV. 12-15-2020

FAR DIAGRAMS

DATE: 10-22-2021 SCALE: 1/32" = 1'-0" PROJECT NO: 18-035 DRAWING NAME: SHEET NO: A-0.4

F.A.R.	PROVIDED
GROUND LEVEL	10,389 S.F.
2ND LEVEL	12,746 S.F.
3RD LEVEL	12,952 S.F.
4TH (REC) LEVEL	19,897 S.F.
5TH LEVEL	20,076 S.F.
6TH LEVEL	20,076 S.F.
7TH LEVEL	20,076 S.F.
8TH LEVEL	20,076 S.F.
9TH LEVEL	19,895 S.F.
TOTAL F.A.R.	156,183 S.F.

LOT SIZE.: 62,474 SF F.A.R. RATIO: 2.5 MAX. F.A.R.: 62,474 SF. x 2.5 = 156,185 SF.

⚠ REV. 01-28-2021

∠ REV. 01-28-20

DATE: 10-22-2021

R-1.0

RENDERING

DRAWING NAME:

SHEET NO:




A REV. 01-28-2021

DATE: 10-22-2021 RENDERING

& & 2 PROJECT NO: 18-035 DRAWING NAME: SHEET NO: R-1.1



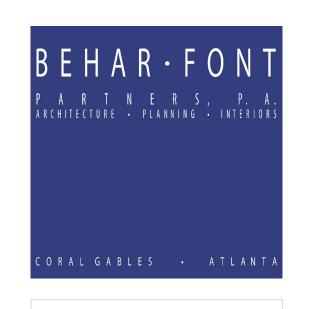

ROBERT BEHAR AR No. 14339

33134

301-341 MADEIRA AVE

® REV. 10-22-2021

® REV. 07-26-2021

A REV. 01-28-2021

DATE: 10-22-2021

PROJECT NO: 18-035

DRAWING NAME:

SHEET NO:

R-1.2



Æ REV. 01-28-2021

DATE: 10-22-2021

PROJECT NO: 18-035

DRAWING NAME:

SHEET NO:

R-1.3





ROBERT BEHAR AR No. 14339

34

301-341 MADEIRA AVE CORAL GABLES, FLORIDA 33134

Æ REV. 01-28-2021



Æ REV. 01-28-2021

DATE: 10-22-2021

PROJECT NO: 18-035

DRAWING NAME:

SHEET NO:

R-1.5



⚠ REV. 07-26-2021

A REV. 01-28-2021

DATE: 10-22-2021

PROJECT NO: 18-035

DRAWING NAME:

SHEET NO:

R-1.6



A REV. 01-28-2021

DATE: 10-22-2021

PROJECT NO: 18-035

DRAWING NAME:

SHEET NO:

R-1.7




ROBERT BEHAR AR No. 14339

SEAL:

-341 MADEIRA 301-341 MADEIRA AVE RAL GABLES, FLORIDA 33134

⚠ REV. 10-22-2021



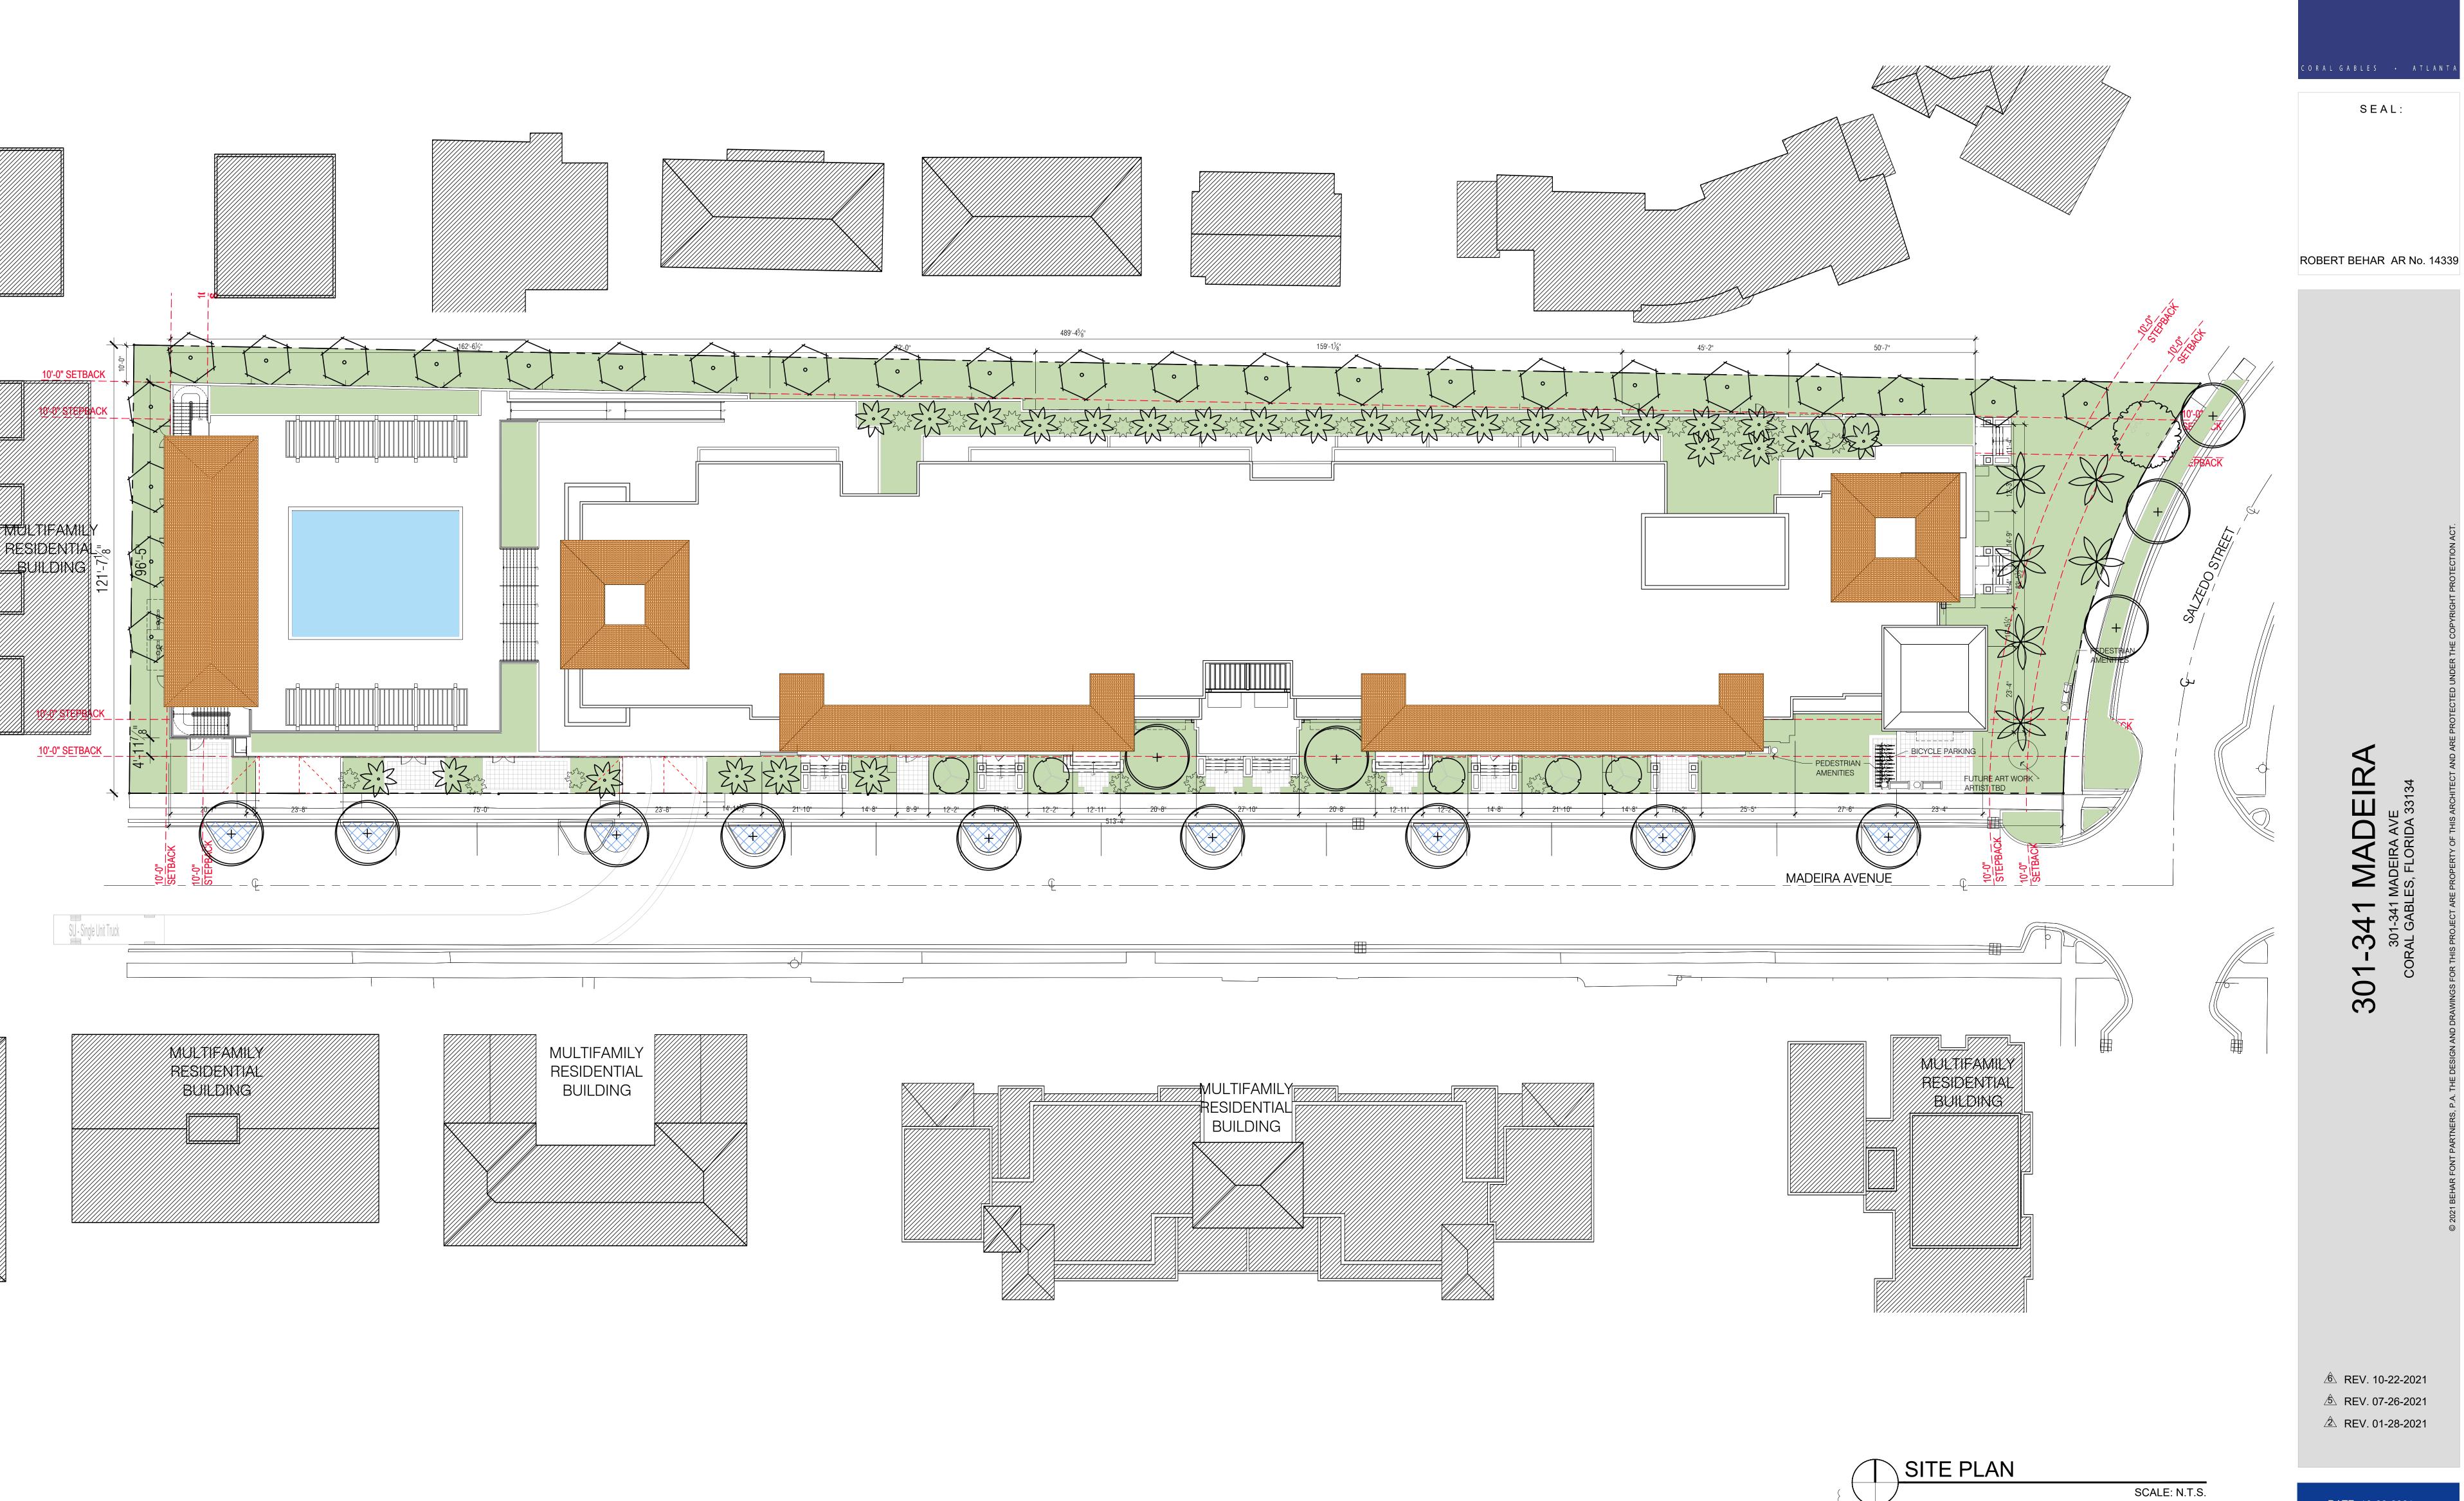

BEHAR·FON

⚠ REV. 10-22-2021


® REV. 10-22-2021

③ REV. 03-16-2021 ② REV. 01-28-2021

⚠ REV. 12-15-2020


SCALE: 1/16" = 1'-0"

GROUND FLOOR PLAN

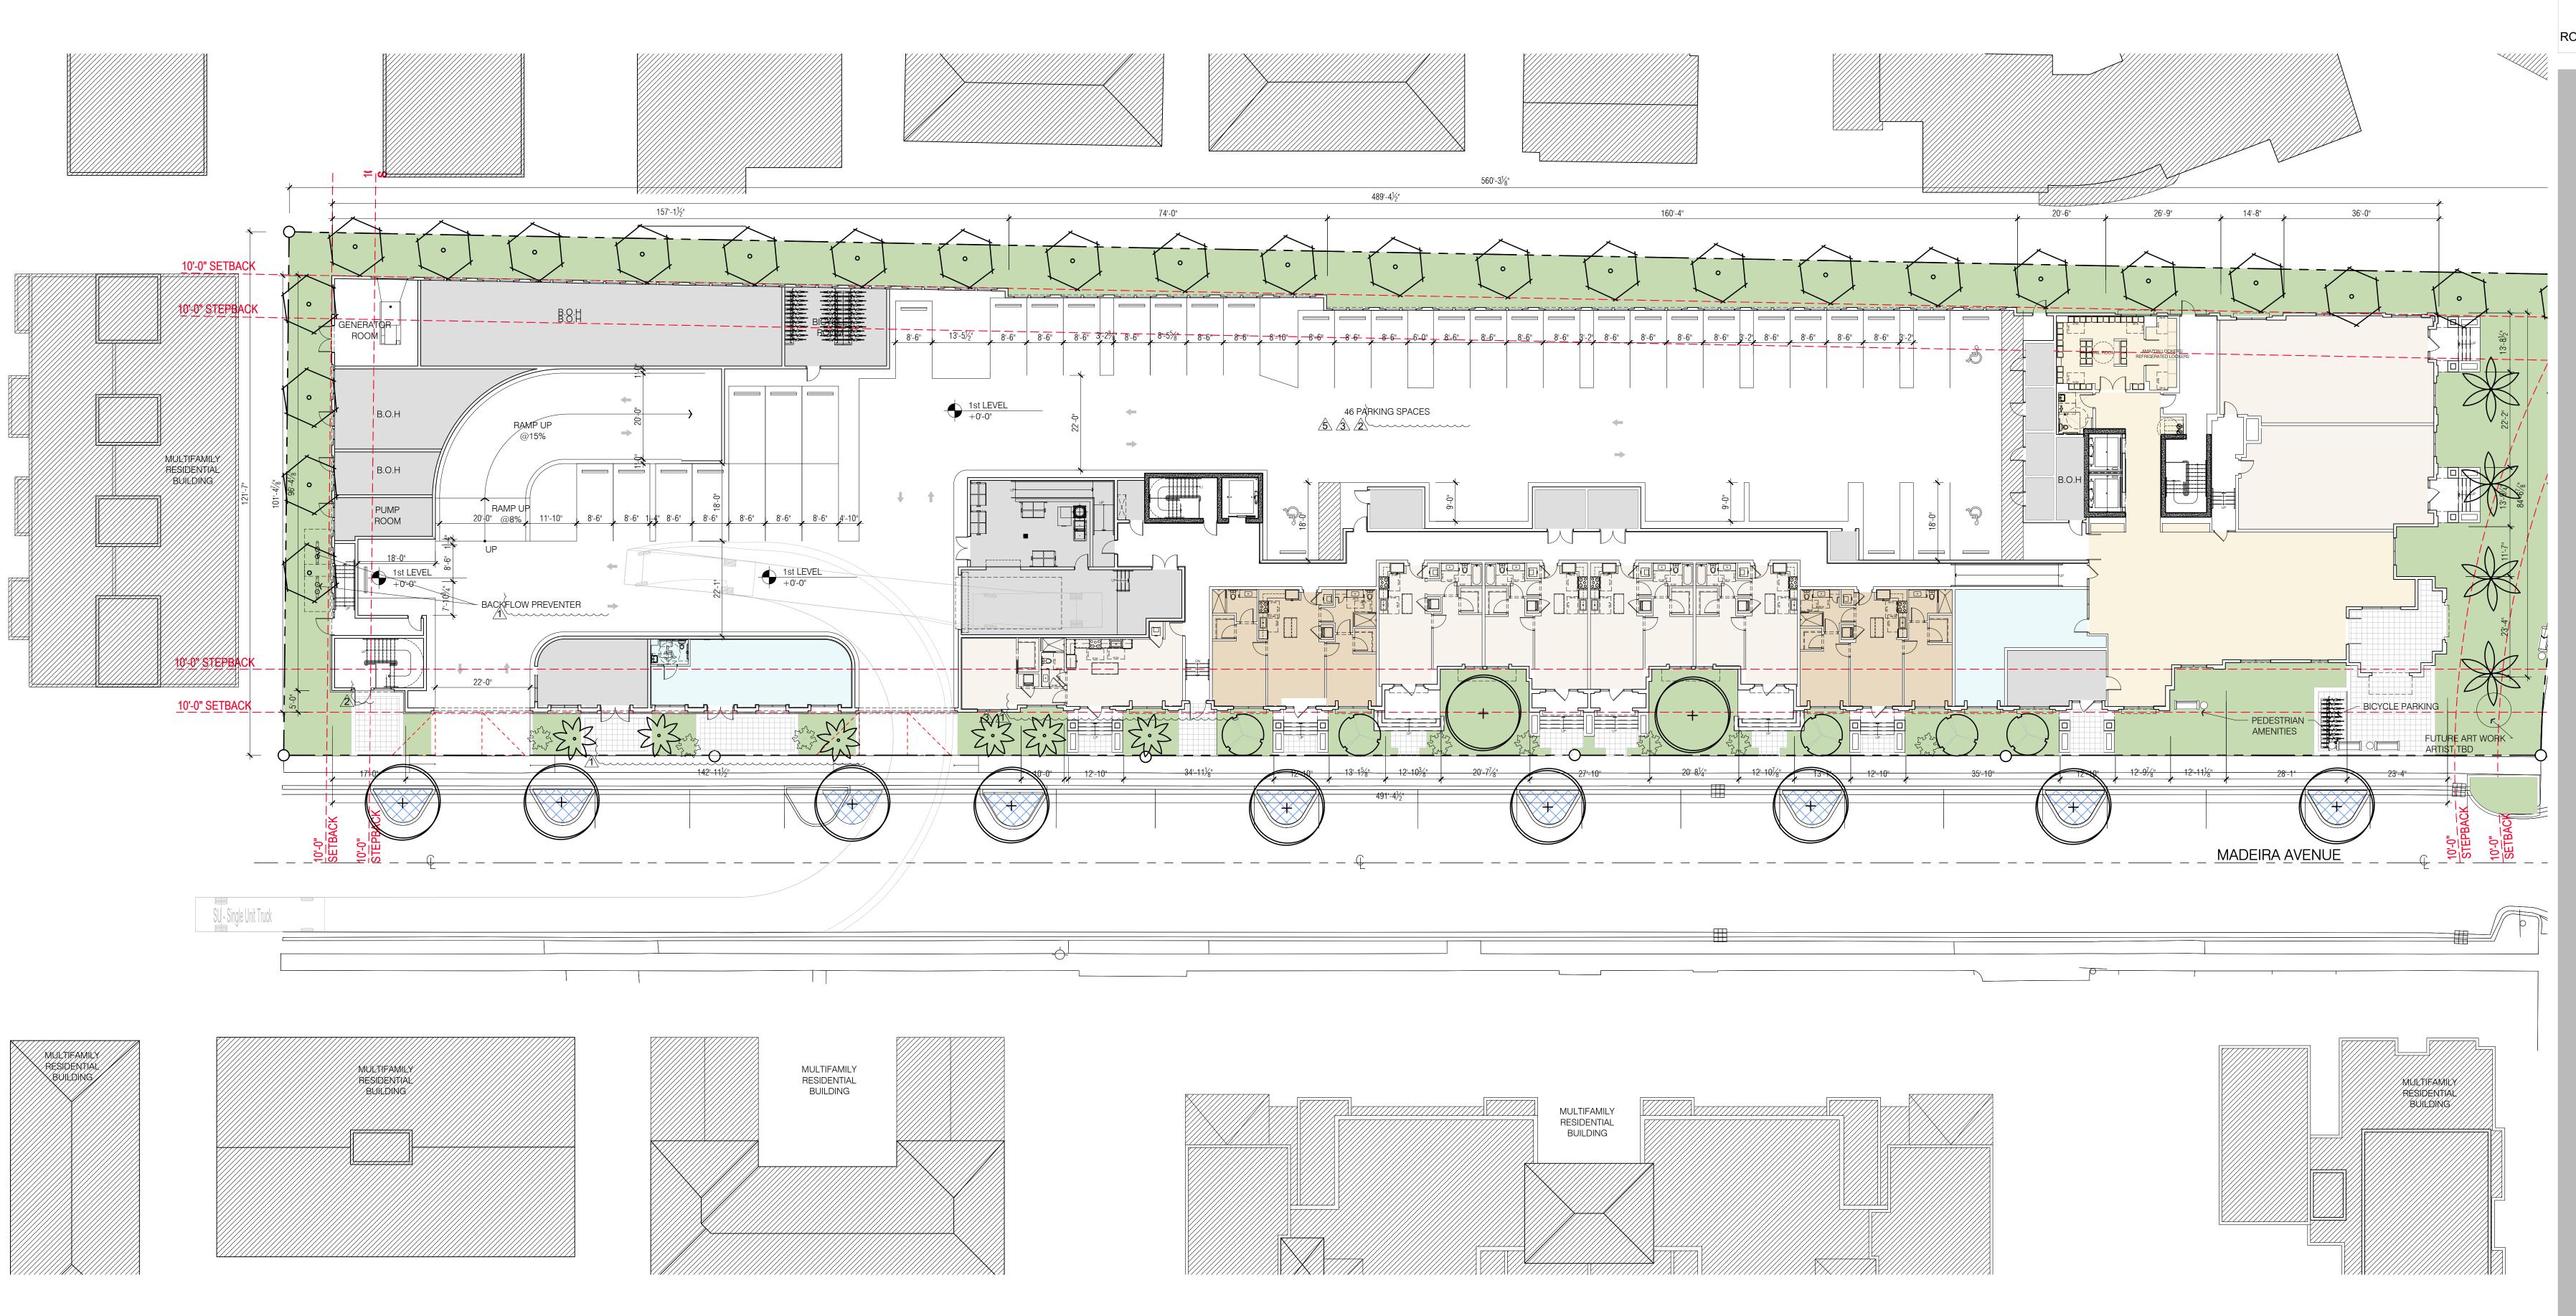



ROBERT BEHAR AR No. 14339

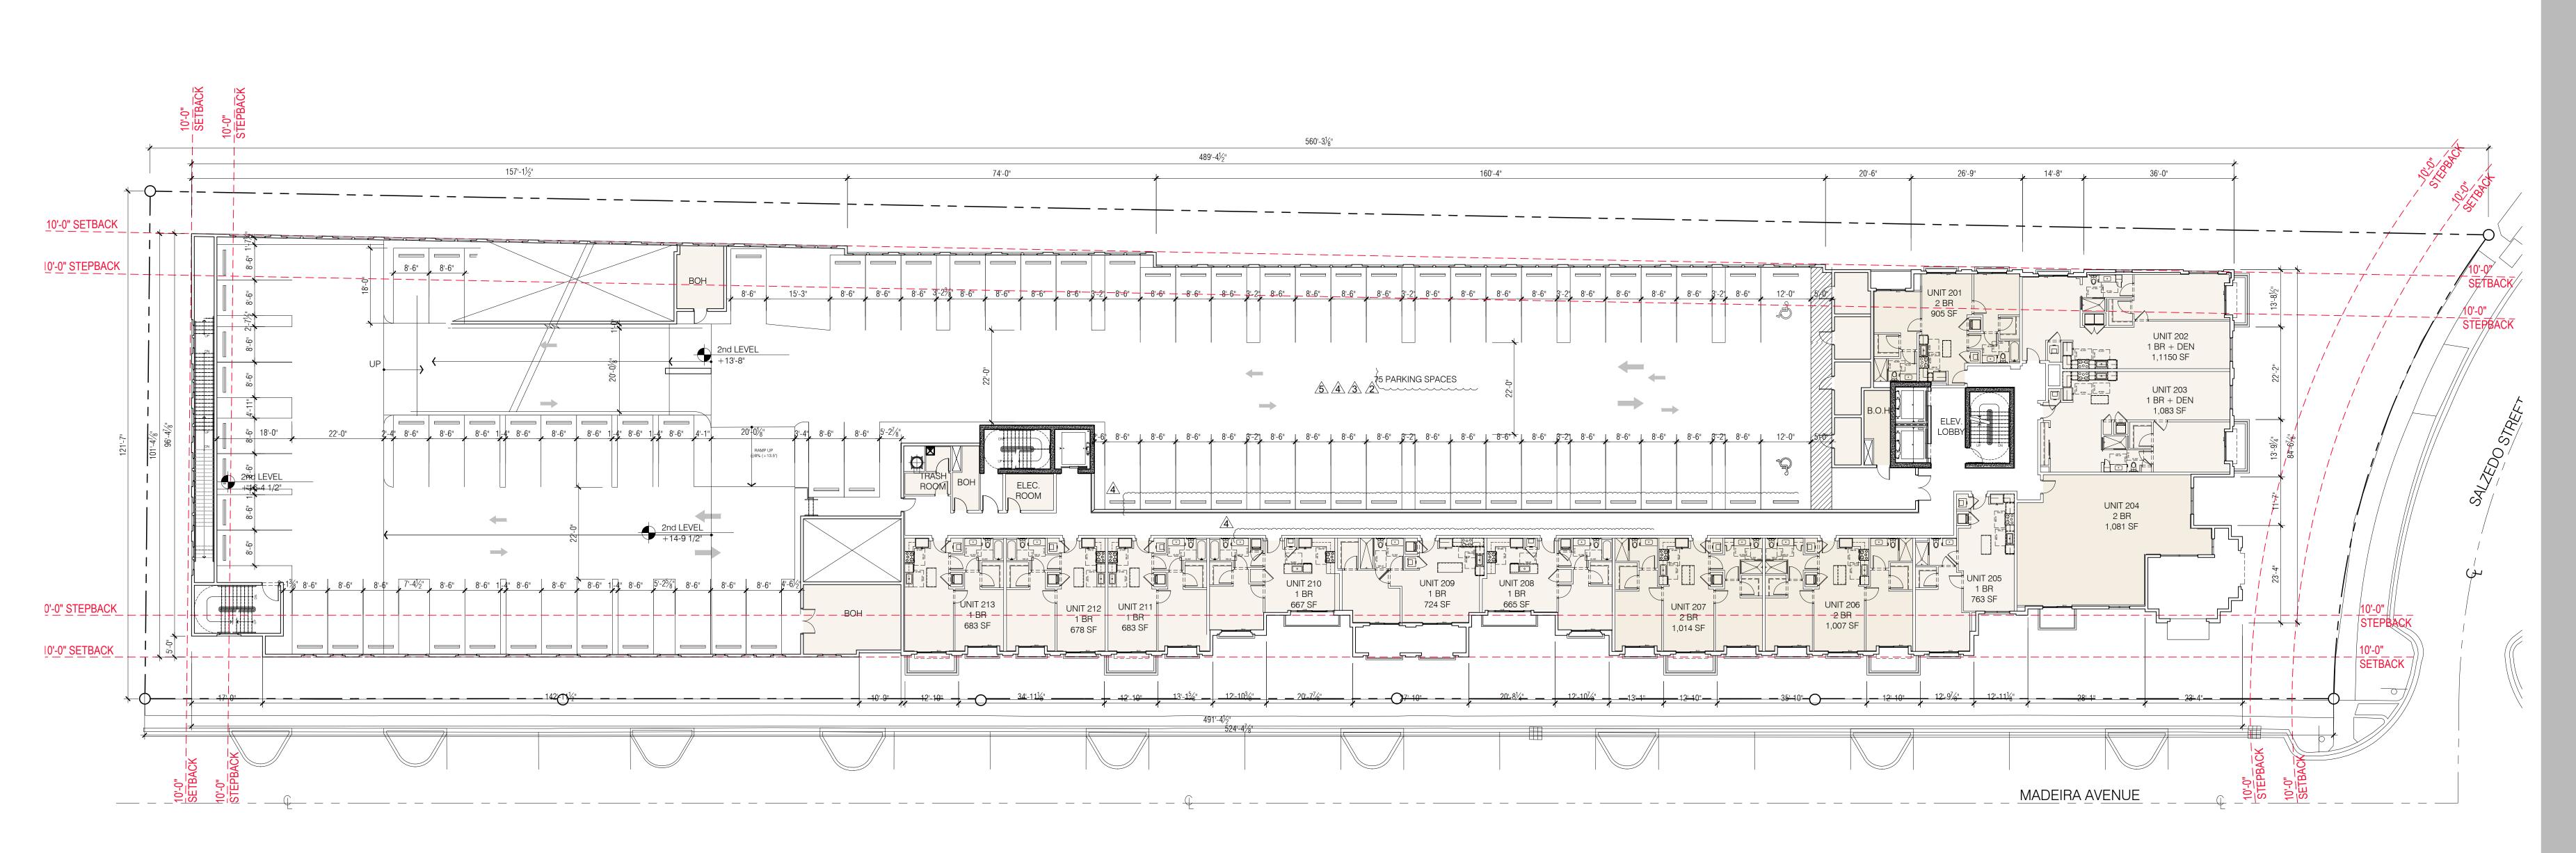

301-341 MADEIRA,

- ® REV. 10-22-2021

 ® REV. 07-26-2021
- A REV. 07-26-2021
- ③ REV. 03-16-2021

2ND FLOOR PLAN

SCALE: 1/16" = 1'-0"

Æ REV. 01-28-2021

Æ REV. 07-26-2021


⚠ REV. 04-26-2021

③ REV. 04-26-2021

A REV. 01-28-2021

3RD FLOOR PLAN

SCALE: 1/16" = 1'-0"

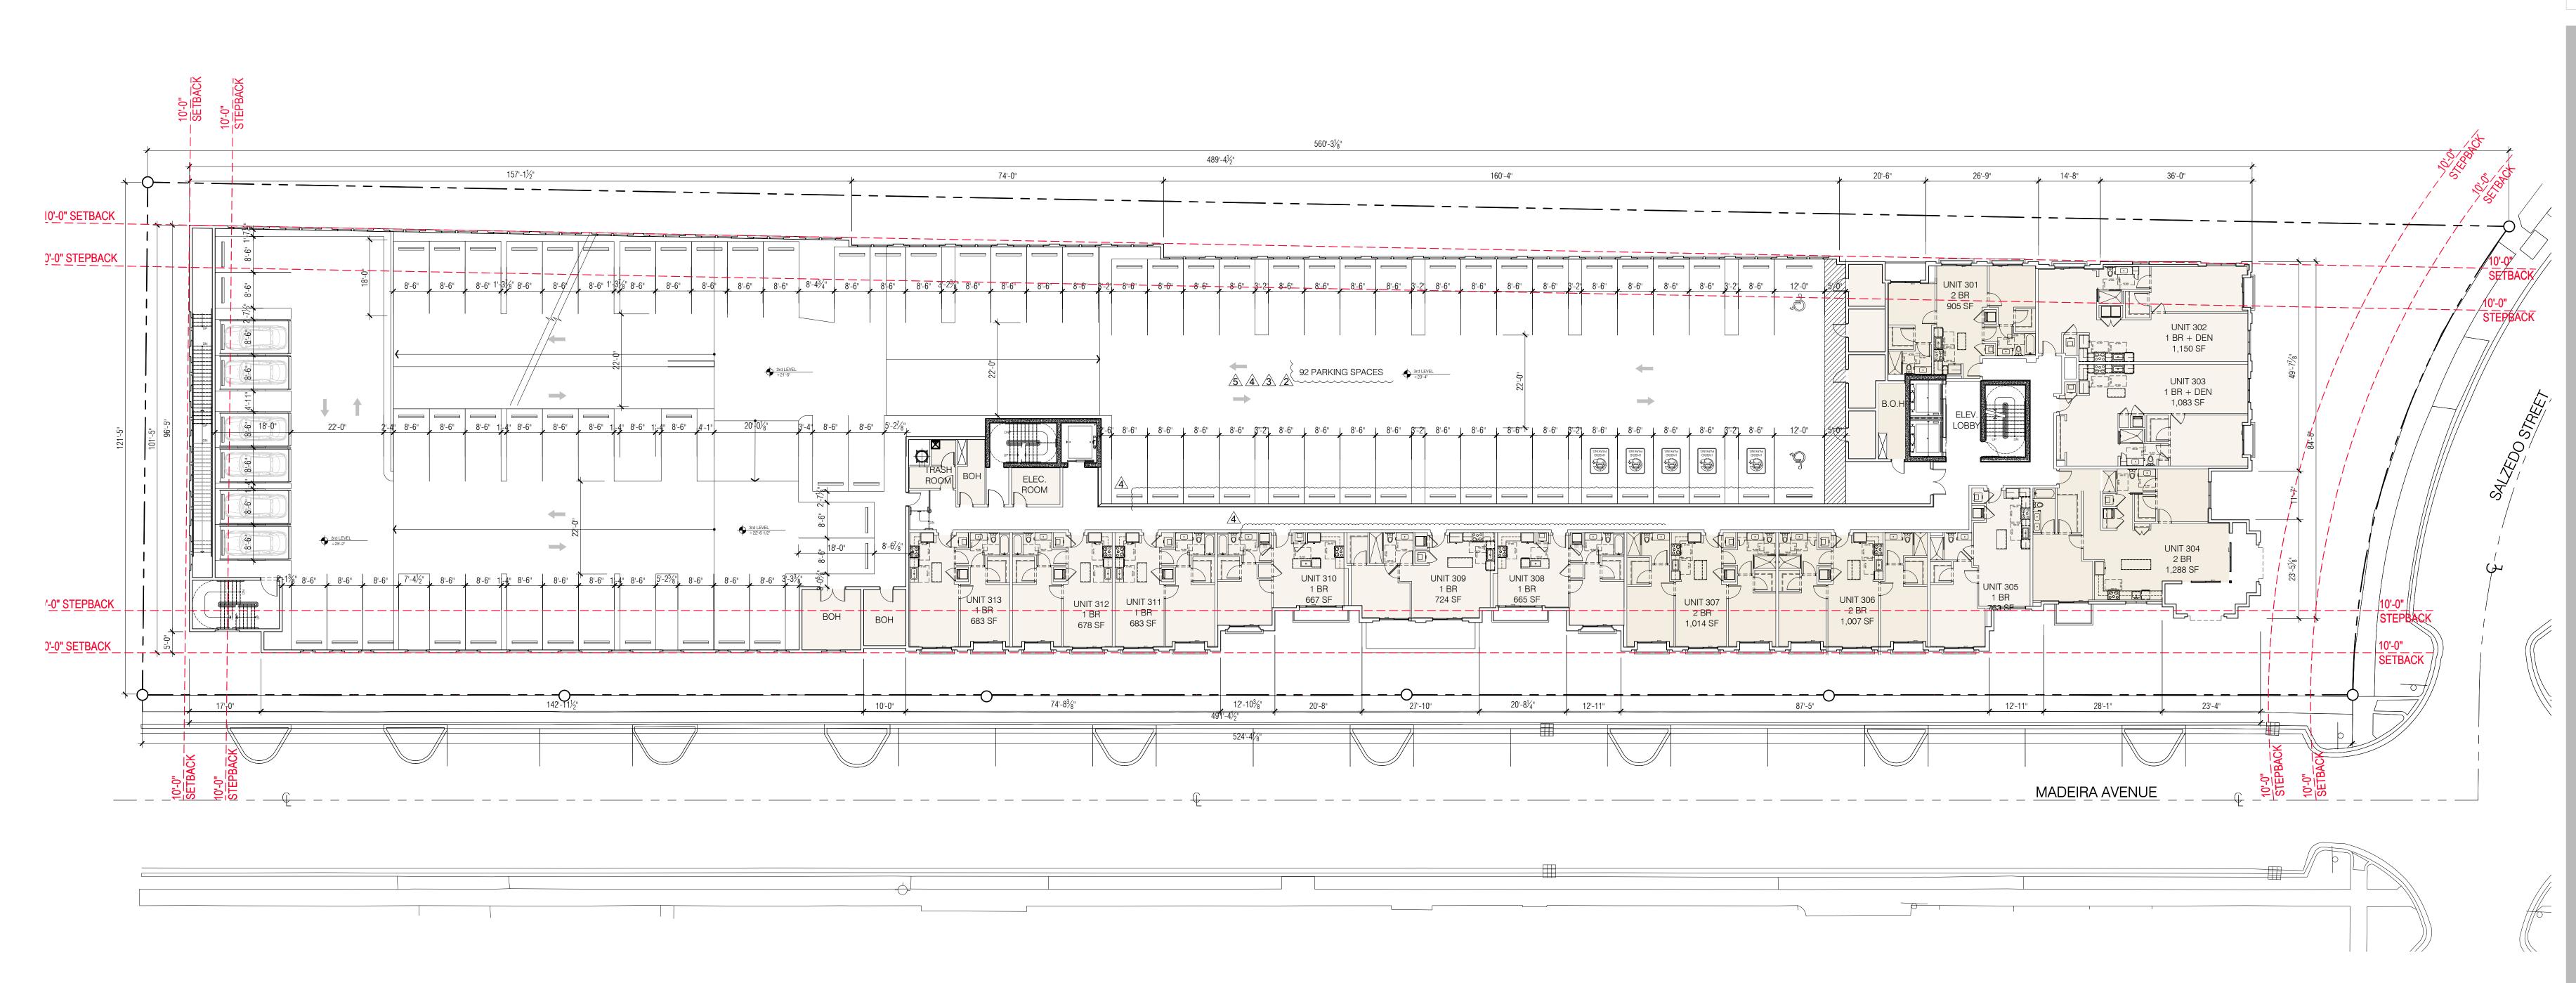



ROBERT BEHAR AR No. 14339

301-341 MADEIRA AVE CORAL GABLES, FLORIDA 3313

- ® REV. 10-22-2021


 ® REV. 07-26-2021
- A REV. 07-26-2021

4TH FLOOR PLAN (AMENITIES DECK)
SCALE: 1/16" = 1'-0"

- ⚠ REV. 03-16-2021
- **A** REV. 01-28-2021



ROBERT BEHAR AR No. 14339

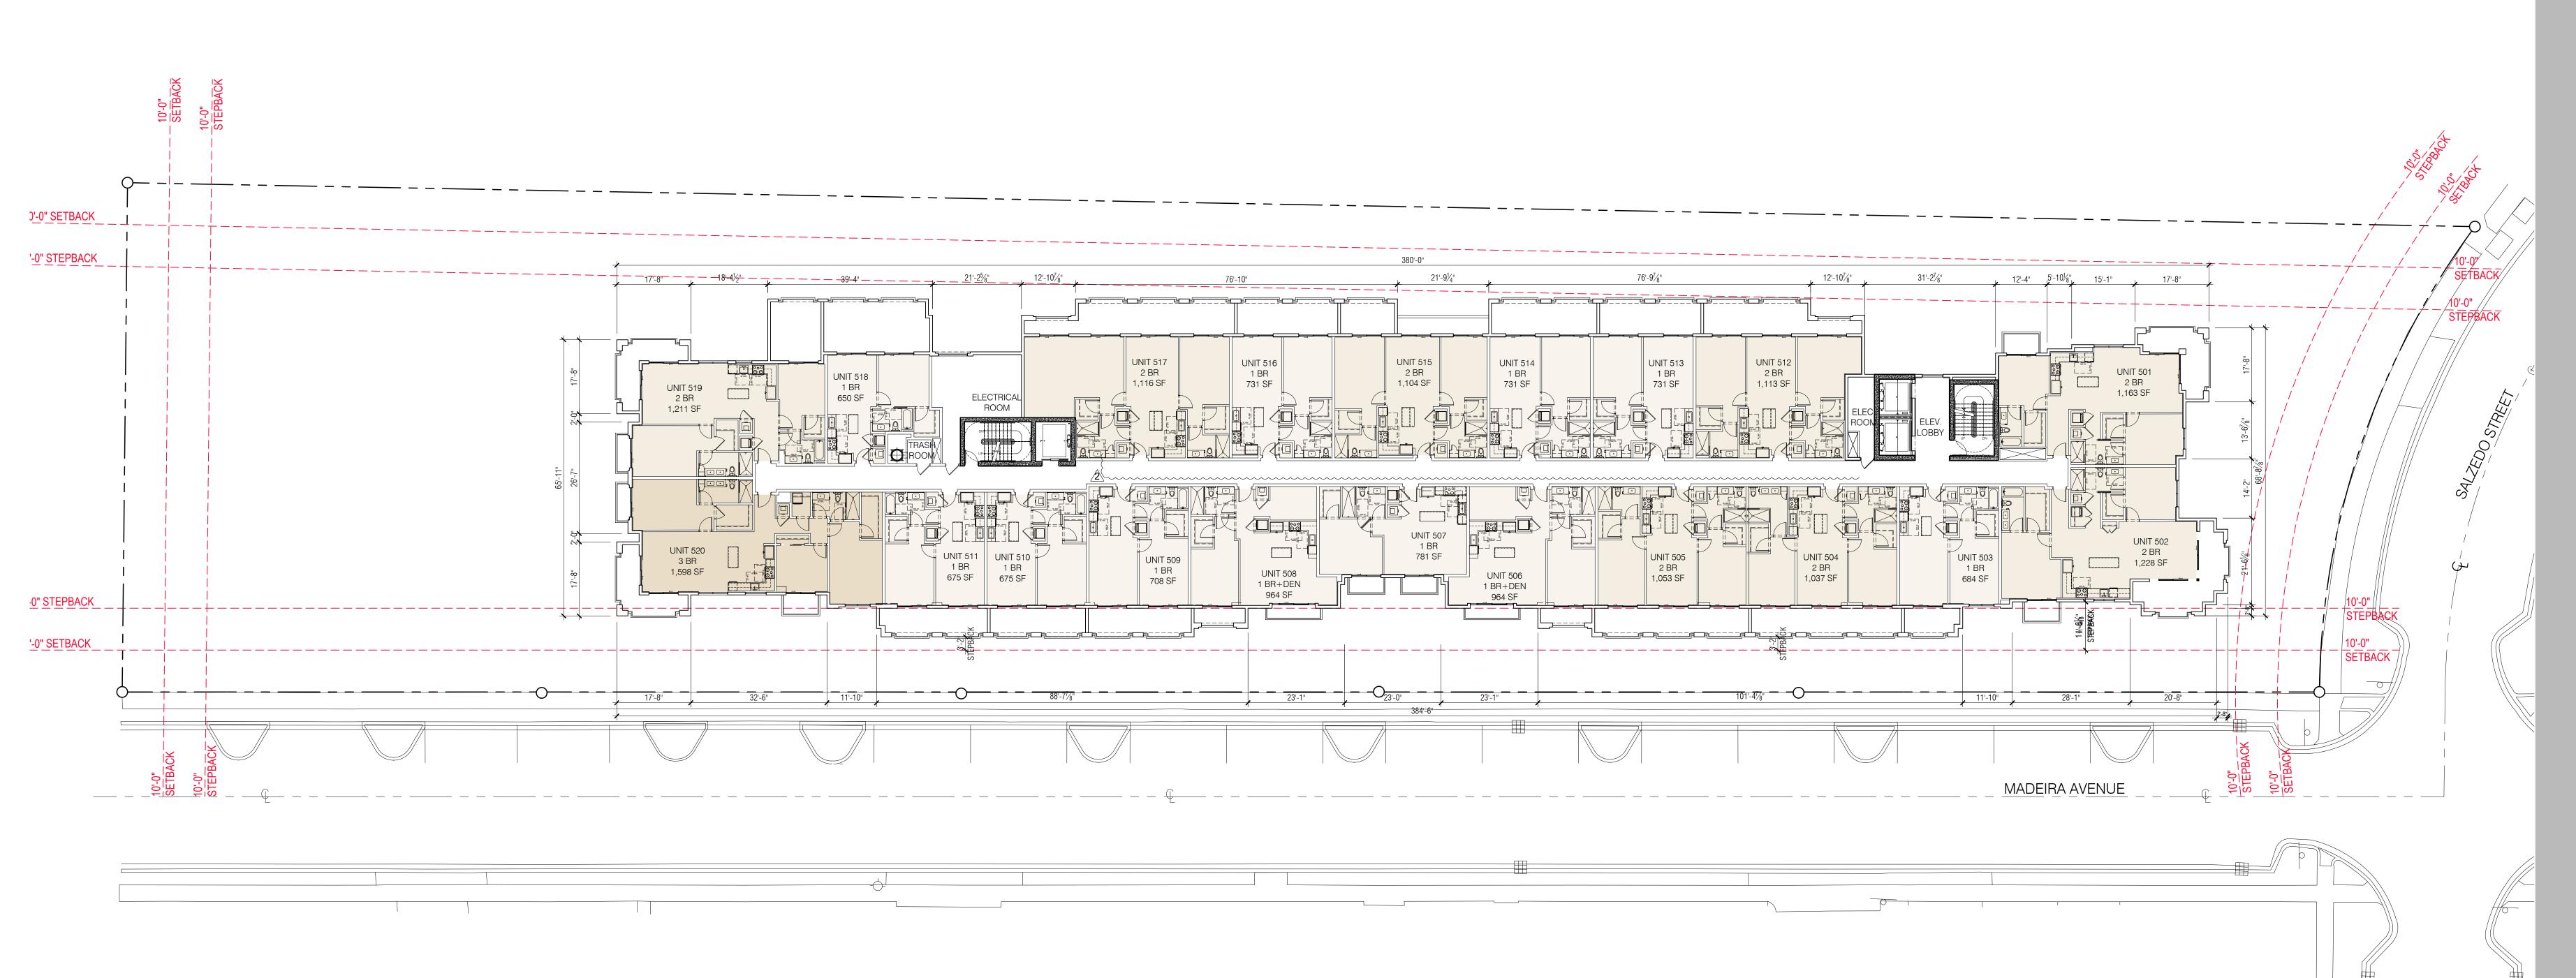

307

® REV. 10-22-2021

® REV. 07-26-2021


A REV. 01-28-2021

5TH FLOOR PLAN



3 L

ROBERT BEHAR AR No. 14339

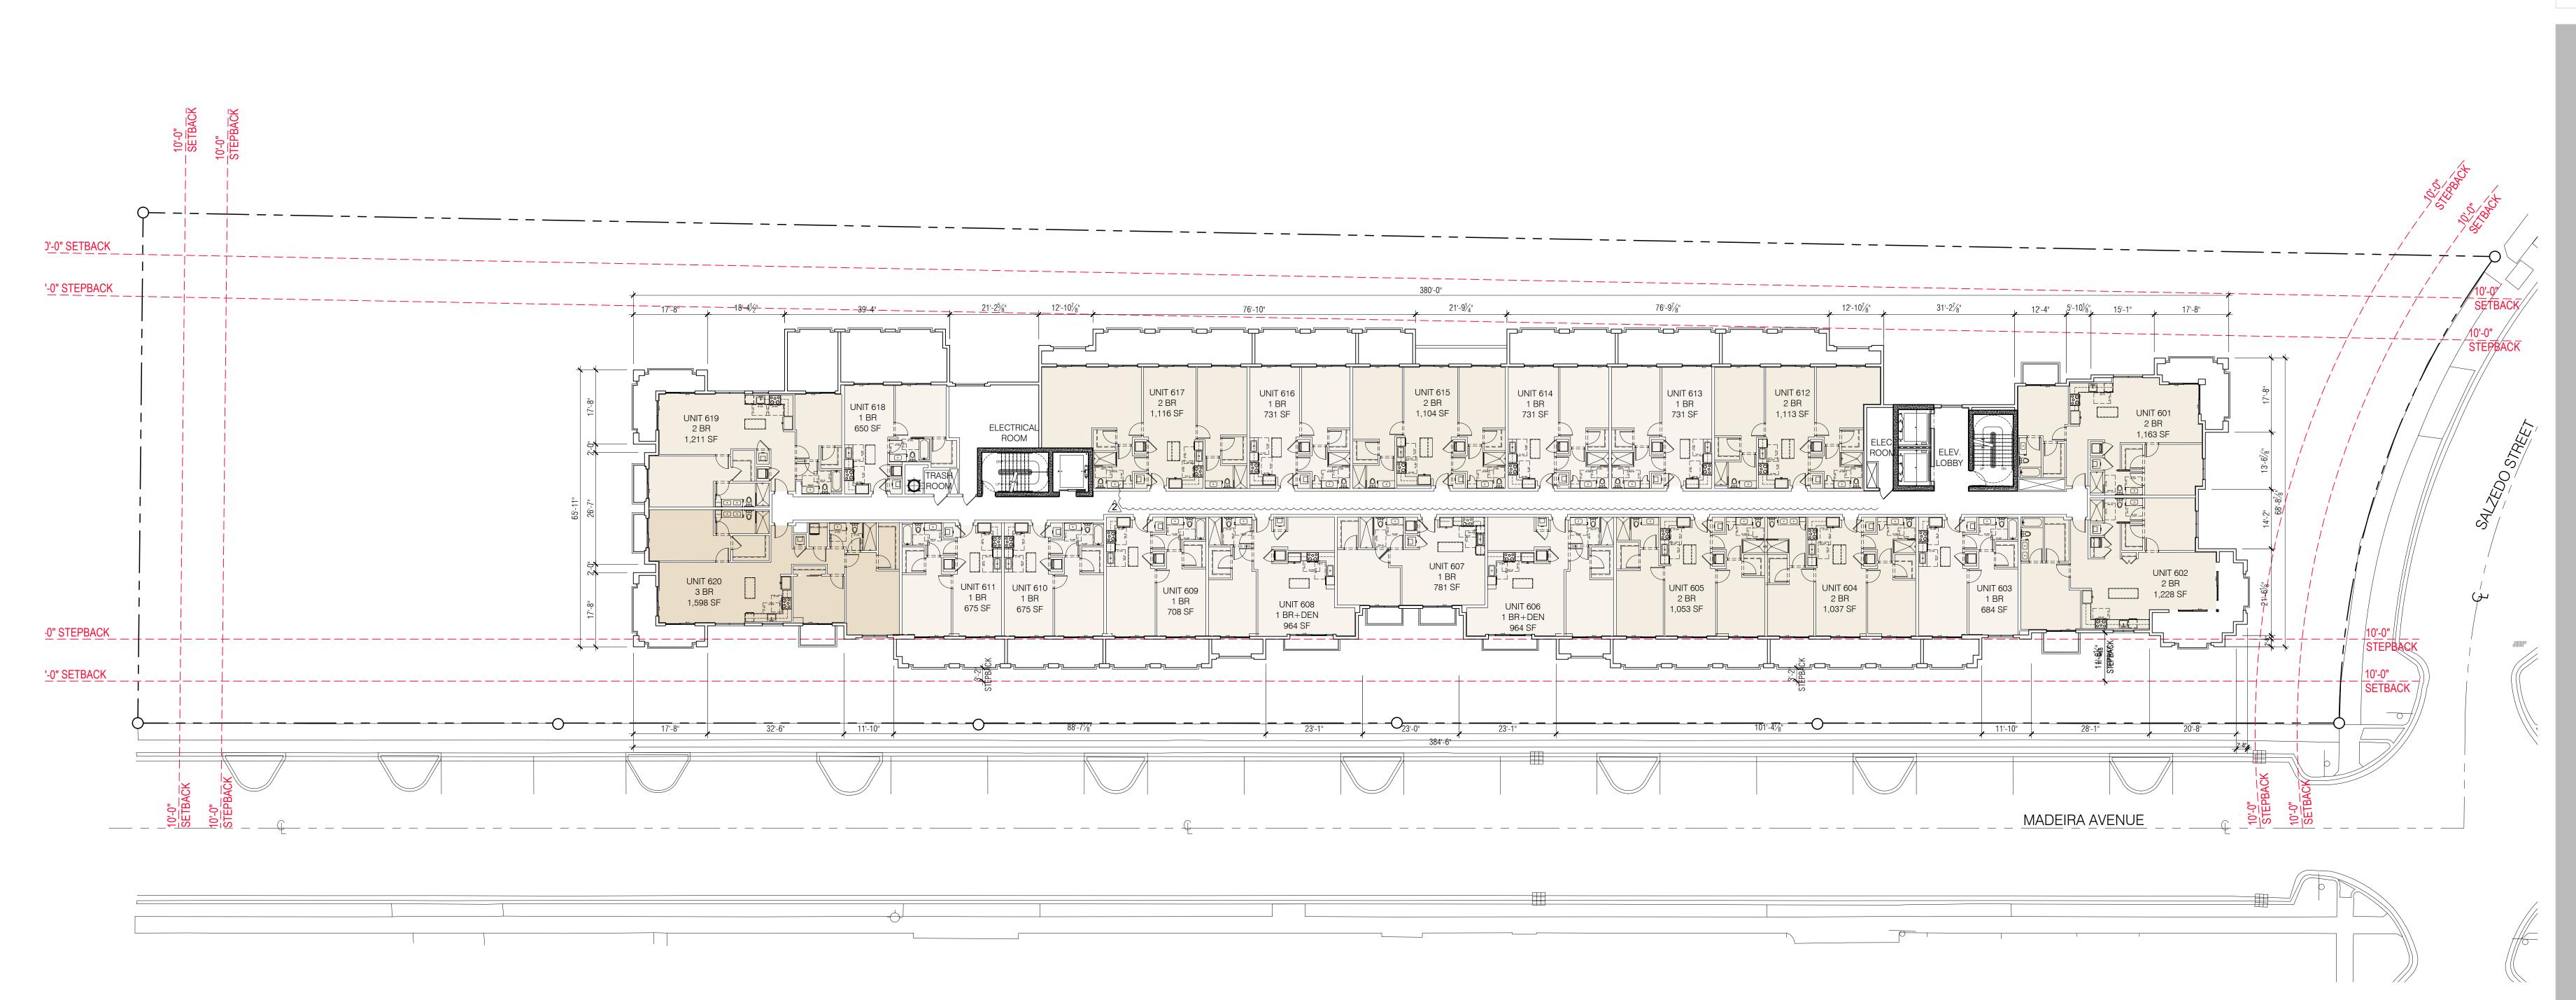

301-341 MADEIRA AVE CORAL GABLES, FLORIDA 33134

DATE: 10-22-2021

PROJECT NO: 18-035

DRAWING NAME:

SHEET NO:


A-1.6

6TH FLOOR PLAN

SCALE: 1/16" = 1'-0"



ROBERT BEHAR AR No. 14339

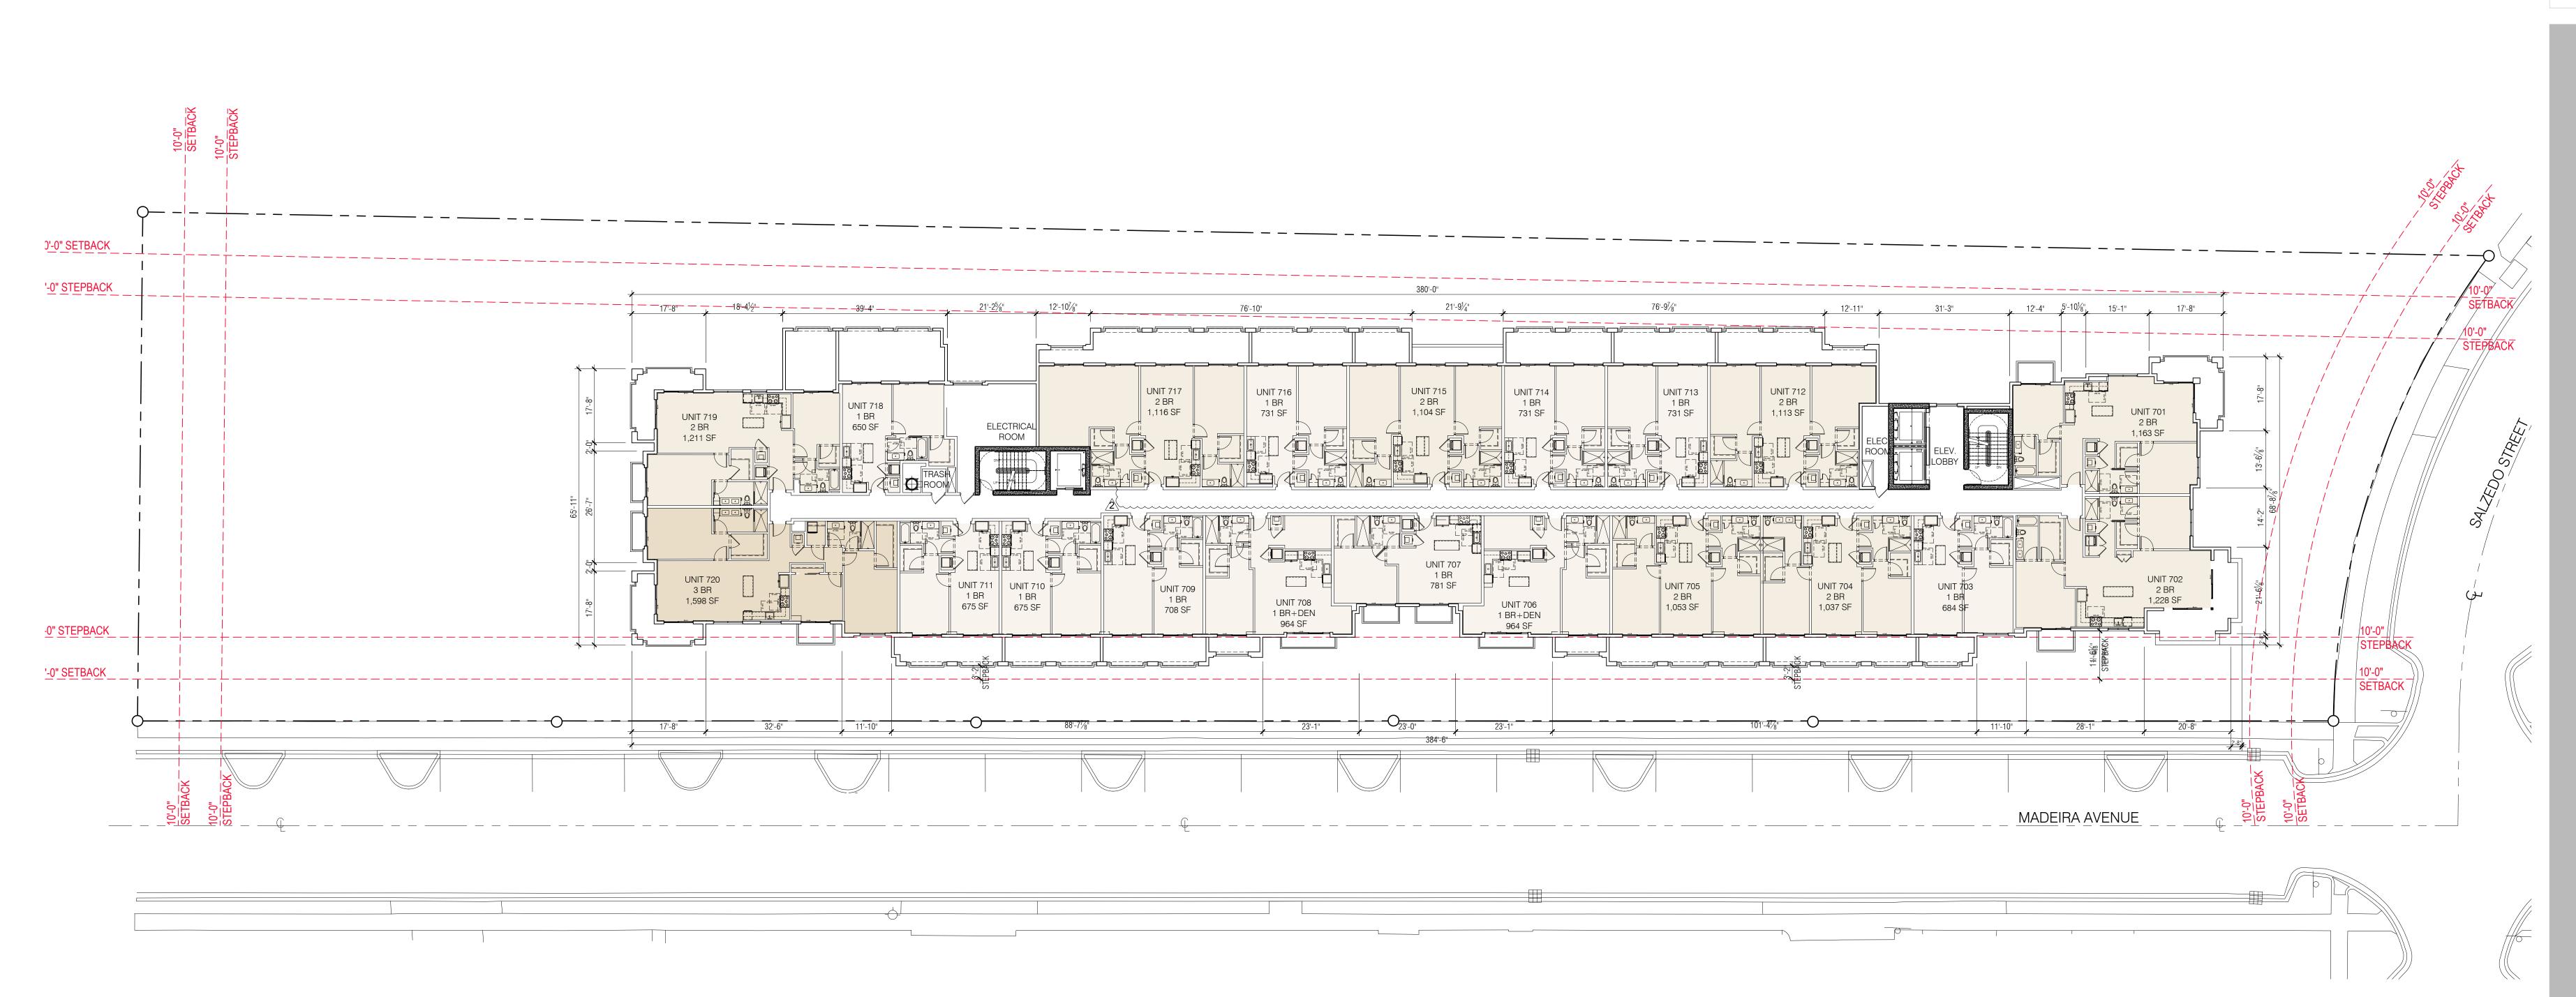


301-341 MADEIRA AVE CORAL GABLES, FLORIDA 3313.

® REV. 10-22-2021
® REV. 07-26-2021

7TH FLOOR PLAN



ROBERT BEHAR AR No. 14339

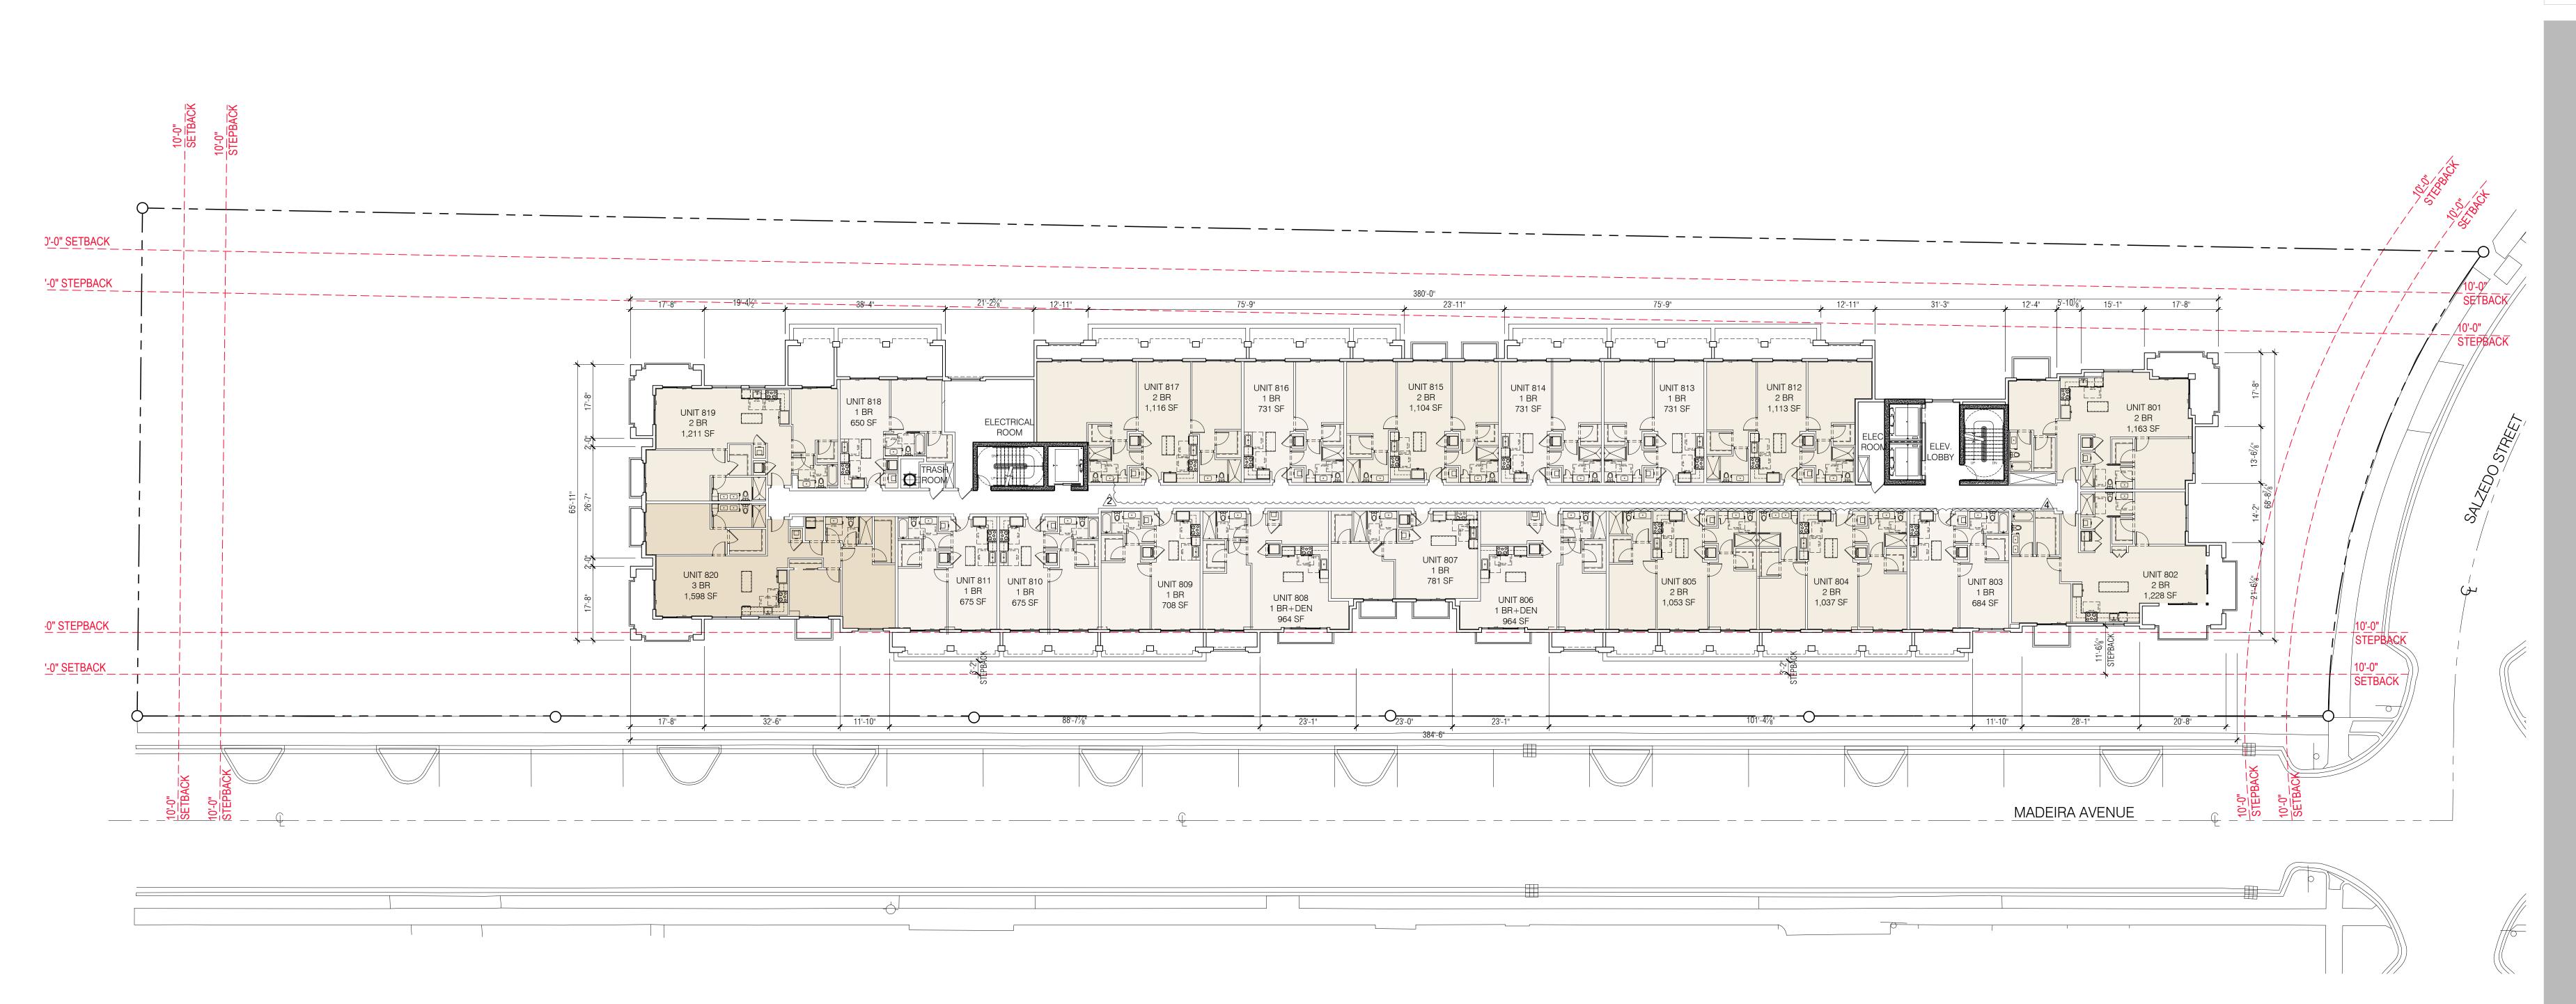

301-341 MADEIRA AVE

⚠ REV. 10-22-2021
⚠ REV. 07-26-2021


A REV. 04-26-2021

REV. 01-28-2021

8TH FLOOR PLAN

ZA REV. 01-28-2021

ROBERT BEHAR AR No. 14339

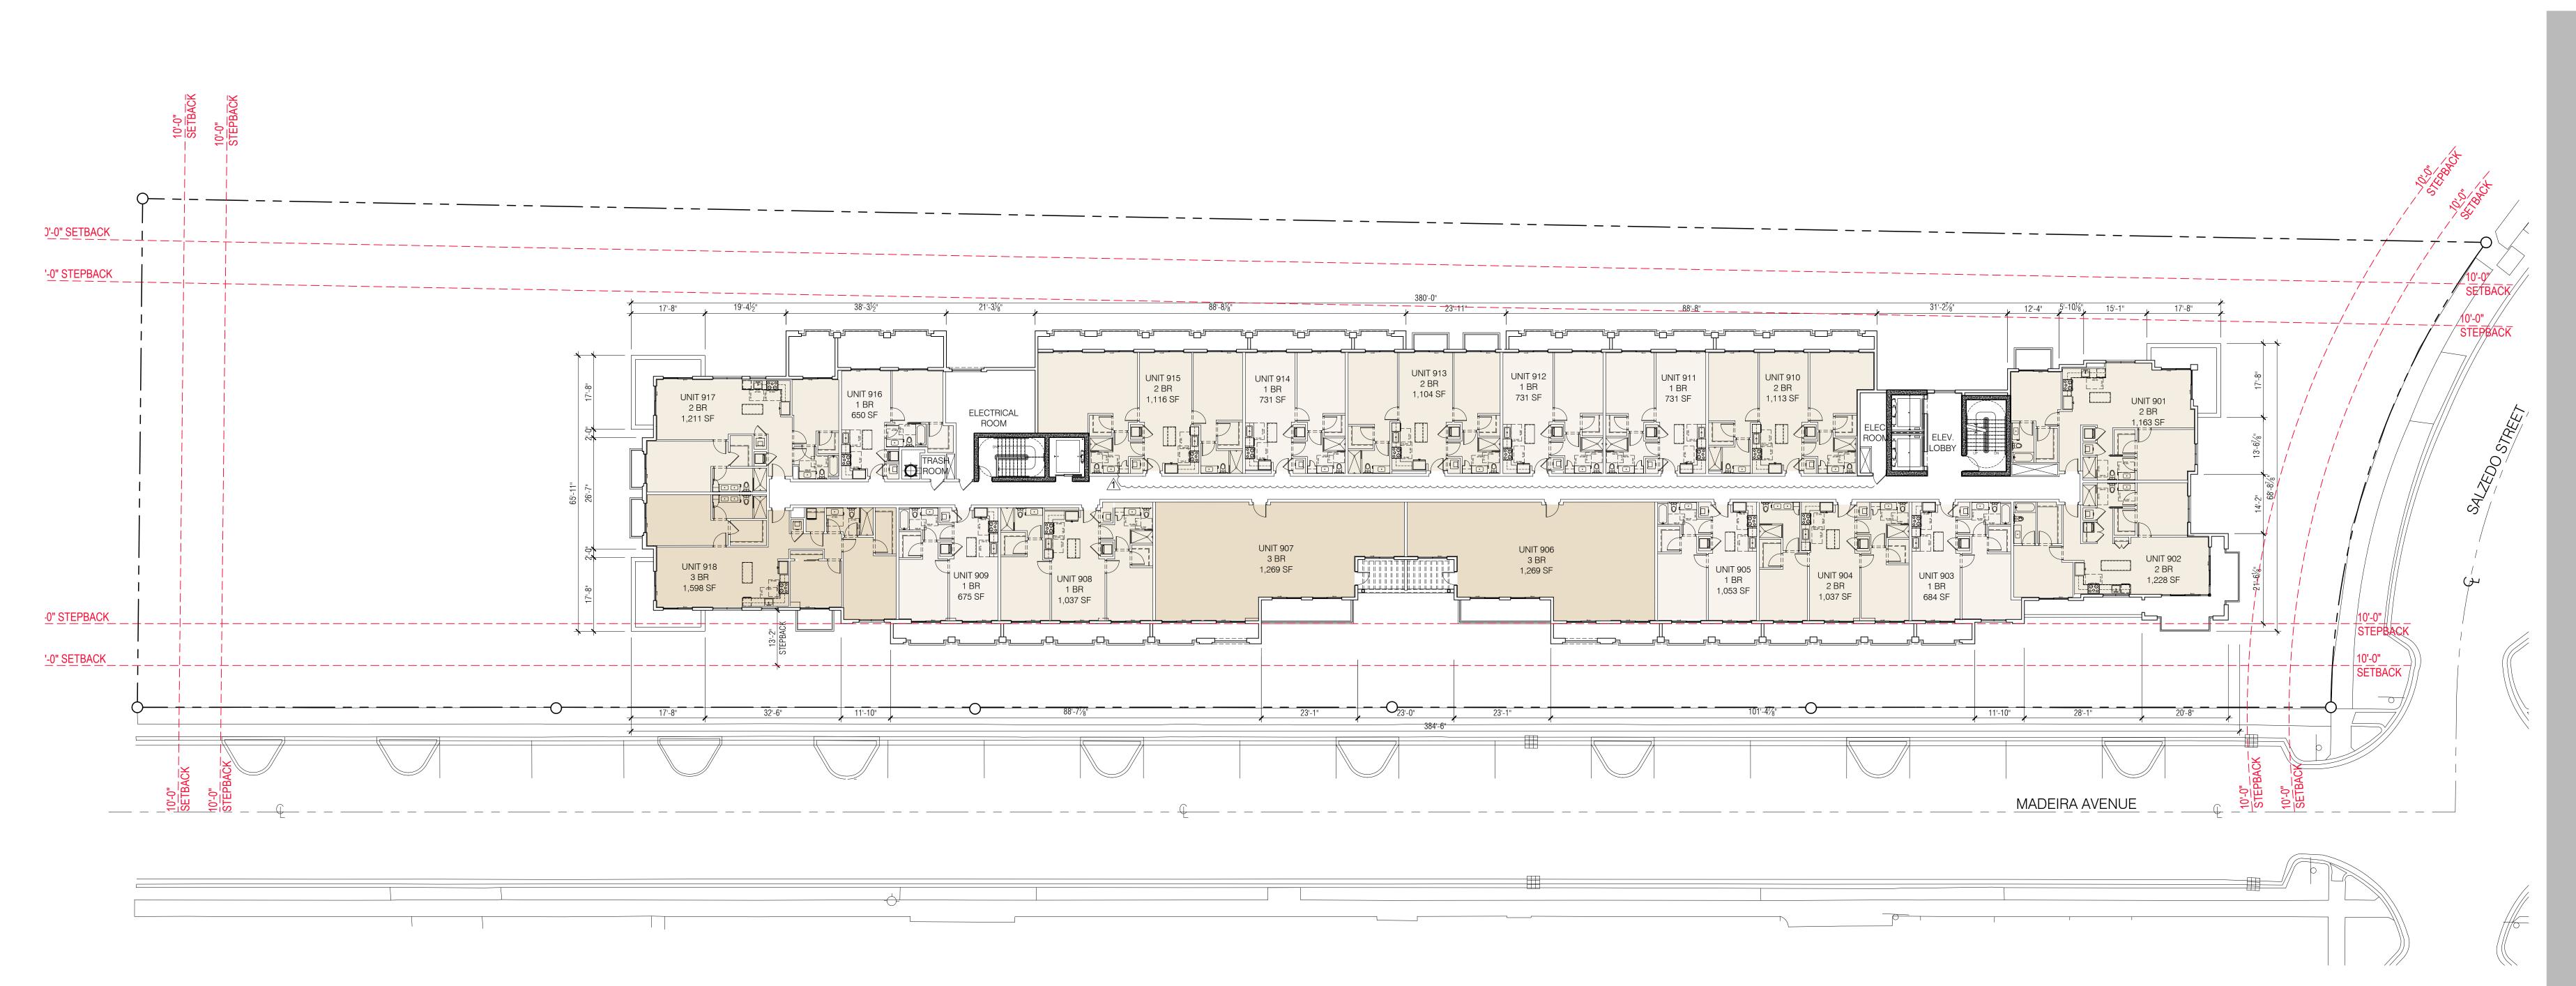

301-341 MADEIRA,

♠ REV. 10-22-2021
 ♠ REV. 07-26-2021
 ♠ REV. 12-15-2020

DATE: 10-22-2021

PROJECT NO: 18-035

DRAWING NAME:

SHEET NO:

A-1.9

9TH FLOOR PLAN

SCALE: 1/16" = 1'-0"



ROBERT BEHAR AR No. 14339



® REV. 10-22-2021

A REV. 04-26-2021

A REV. 01-28-2021

⚠ REV. 12-15-2020

SOUTH ELEVATION

SCALE: 1/16" = 1'-0"

EAST ELEVATION

SCALE: 1/16

WEST ELEVATION

SCALE: 1/16" =

SCALE: 1/16" = 1'-0"

B E H A R · F O N ⁻ PARTNERS, P. ARCHITECTURE • PLANNING • INTERIO ORAL GABLES • ATLANTA

SEAL:

ROBERT BEHAR AR No. 14339

301-341 MADEIRA AVE CORAL GABLES, FLORIDA 33134

♠ REV. 10-22-2021

♠ REV. 07-26-2021 A REV. 04-26-2021

A REV. 01-28-2021

⚠ REV. 12-15-2020



ROBERT BEHAR AR No. 14339



301-341 MADEIRA AVE CORAL GABLES, FLORIDA 33134

® REV. 10-22-2021

® REV. 07-26-2021

Æ REV. 07-26-2021

Æ REV. 04-26-2021

2 REV. 01-28-2021

⚠ REV. 12-15-2020

NORTH ELEVATION

SCALE: 1/16" = 1'-0"

4 NATURAL STONE VENEER

(1) ALUMINUM -

STOREFRONT

(3) PRECAST

CONCRETE

BRACKET

4 NATURAL STONE VENEER

(1) ALUMINUM

STOREFRONT

5 PRIMED &

PAINTED 3/4" SMOOTH STUCCO

8 ALUMINUM

VENTILATION

SCREEN

5 ALUMINUM

CANOPY

4 NATURAL STONE VENEER

MATERIALS BOARD

BEHAR • FONT

PART NERS, P.A.

ARCHITECTURE • PLANNING • INTERIORS

SEAL:

ROBERT BEHAR AR No. 14339

ROBERT BEHAR AR NO

301-341 MADEIRA AVE

DATE: 10-22-2021

PROJECT NO: 18-035

DRAWING NAME:

SHEET NO:

A-3.0

SCALE: N.T.S.

ANDREW M. WITKIN LIC. # LA0000889

301-341

DATE: 11-20-2019

PROJECT NO: 2019-005

DRAWING NAME: LANDSCAPE PLAN SHEET NO:

MADEIRA AVENUE

LANDSCAPE PLAN - GROUND FLOOR

Scale: 1"=20'-0"



LANDSCAPE LEGEND Information Required to I	•		
Zoning District: MF2	Net Lot Area 1.4	434_ acres_62,474	_ S.
OPEN SPACE	REQUIRED/ ALLOWED	PROVIDED	
A. Square Feet of open space required by Article 5, Development Standard Net lot area = $62,474$ s.f. x 25 % = $15,619$ s.f.	dards: 15,619	15,995	
TREES A. No. of Trees required: 28 x 1.434 = 40	40	40	
B. % Palms Allowed: No. Trees required x 25% =	10	10	
C. % Natives required: No. Trees required x 30% =	12	29	
STREET TREES (maximum average spacing of 35' o.c.):			
A. <u>524</u> linear feet along Maderia Avenue =	15	15	
B. <u>117</u> linear feet along Salzedo Street =	3	3	
G. Total Trees Required	58	58	
SHRUBS			
A. No. shrubs required: 224 x 1.434 = 321	321	1,760	
B. Natives requirement 30%	96	1,430	

MITIGATION REQUIRED			
TOTAL CANOPY REMOVED:	TOTAL CANOPY REPLACEMENT PROVIDED:		
15,373 sf	18 - Large Tree (500 sf each) = 9,000 sf 30 - Medium Tree Species (300 sf each) = 9,000 sf 8 - Large Palm Species (300 sf each) = 2,400 sf 34 - Small Palm Species (100 sf each) = 3,400 sf		
	Total Canopy Replacement Provided = <u>23,800 sf</u>		

LANDSCAPE LIST


		TREES				
SYMBOL	SYMBOL QUAN. PROPOSED MATERIAL DESCRIPTION					
	11	Caesalpinia granadillo [STI	REET TREE] 16' HT. X 6' SPR. 3.5" CAL.			
\downarrow	11	BRIDALVEIL TREE	F.G.			
	23	*Coccoloba diversiflora	12' HT. X 6' SPR. 2" CAL.			
		PIGEON PLUM	F.G.			
\sqrt{\sq}\}}\sqrt{\sq}}}}}}\sqrt{\sqrt{\sqrt{\sqrt{\sqrt{\sqrt{\sqrt{\sqrt{\sqrt{\sqrt{\sq}}}}}}}\sqrt{\sqrt{\sqrt{\sqrt{\sqrt{\sqrt{\sq}}}}}}}\sqrt{\sqrt{\sqrt{\sq}}}}}}\sqrt{\sqrt{\sqrt{\sqrt{\sq}}}}}}}\sqrt{\sqrt{\sq}}}}}}\signtique \sqrt{\sqrt{\sqrt{\sq}}}}}}\signtinitexentine{\sqrt{\sq}}}}}\signtique \sqrt{\sq}}}}\signtique \sqrt{\sqrt{\sq}	4	*Coccoloba diversiflora [STI	REET TREE] 16' HT. X 6' SPR. 3.5" CAL.			
	7	PIGEON PLUM	F.G.			
	7	Lagerstroemia indica 'Muskogee'	12' HT. X 6' SPR. 2" CAL.			
	'	MUSKOGEE CREPE MYRTLE	F.G.			
M		Phoenix dactylifera 'Medjool'	10' C.T.			
	2	MEDJOOL DATE PALM	F.G.			
- Service Serv			REET TREE] 16' HT. X 6' SPR. 3.5" CAL.			
&	3	LIVE OAK	F.G.			
		*Roystonea elata	12' G.W., 28' O.A. HT. MIN.			
\gg	6	ROYAL PALM	F.G., MATCHED HTS.			
M_		Veitchia montgomeryana 'single'	16' O.A. HT. MIN.			
2:3	33	SINGLE MONTGOMERY PALM	F.G.			
			16' O.A. HT. MIN.			
	1	Veitchia montgomeryana 'quad' QUADRUPLE MONTGOMERY PALM	F.G.			
- ASV			L			
		SHRUBS AND GROUNDO	OVERS			
SYMBOL	QUAN.	PROPOSED MATERIAL	DESCRIPTION			
AB	11	Aechmea blanchettiana	36" HT. X 24" SPR.			
ΛD		BRIGHT YELLOW BROMELIAD	10" POT			
AO	24	Alcantarea odorata	3' O.A. HT.			
AO	21	BROMELIAD SP.	9" POT			
0 E	440	*Conocarpus erectus	24" HT. X 24" SPR. / 24" O.C.			
CE	413	GREEN BUTTONWOOD	3 GAL.			
00	000	*Clusia guttifera	36" HT. X 24" SPR. / 24" O.C.			
CG	229	SMALL LEAF CLUSIA	7 GAL.			
01	700	*Chrysobalanus icaco 'Red Tip'	18" HT. X 18" SPR. / 18" O.C.			
CI	788	RED TIP COCOPLUM	3 GAL.			
	4.074	Ficus microcarpa 'Green Island'	15" HT. X 15" SPR. / 15" O.C.			
FM	1,271	GREEN ISLAND FICUS	3 GAL.			
10		Ipomoea 'Margarite'	15" O.C.			
IC	105	CHARTREUSE SWEET POTATO	1 GAL. FULL			
		Juniperus chinensis 'Parsonii'	15" HT. X 15" SPR. / 15" O.C.			
JC	744	PARSON'S JUNIPER	3 GAL.			
		Philodendron 'Burle Marx'	24" HT. X 24" SPR. / 36" O.C.			
PB	80	BURLE MARX PHILODENDRON	3 GAL.			
		Pennisetum setaceum 'Alba'	18" HT. X 18" SPR. / 24" O.C.			
PS	218	WHITE FOUNTAIN GRASS				
			3 GAL.			
LAWN	As	Stenotaphrum secundatum 'Floratam'	SOLID EVEN SOD			
	Required	ST. AUGUSTINE GRASS				

^{*} DENOTES NATIVE SPECIES


ANDREW M. WITKIN LIC. # LA0000889

301-341



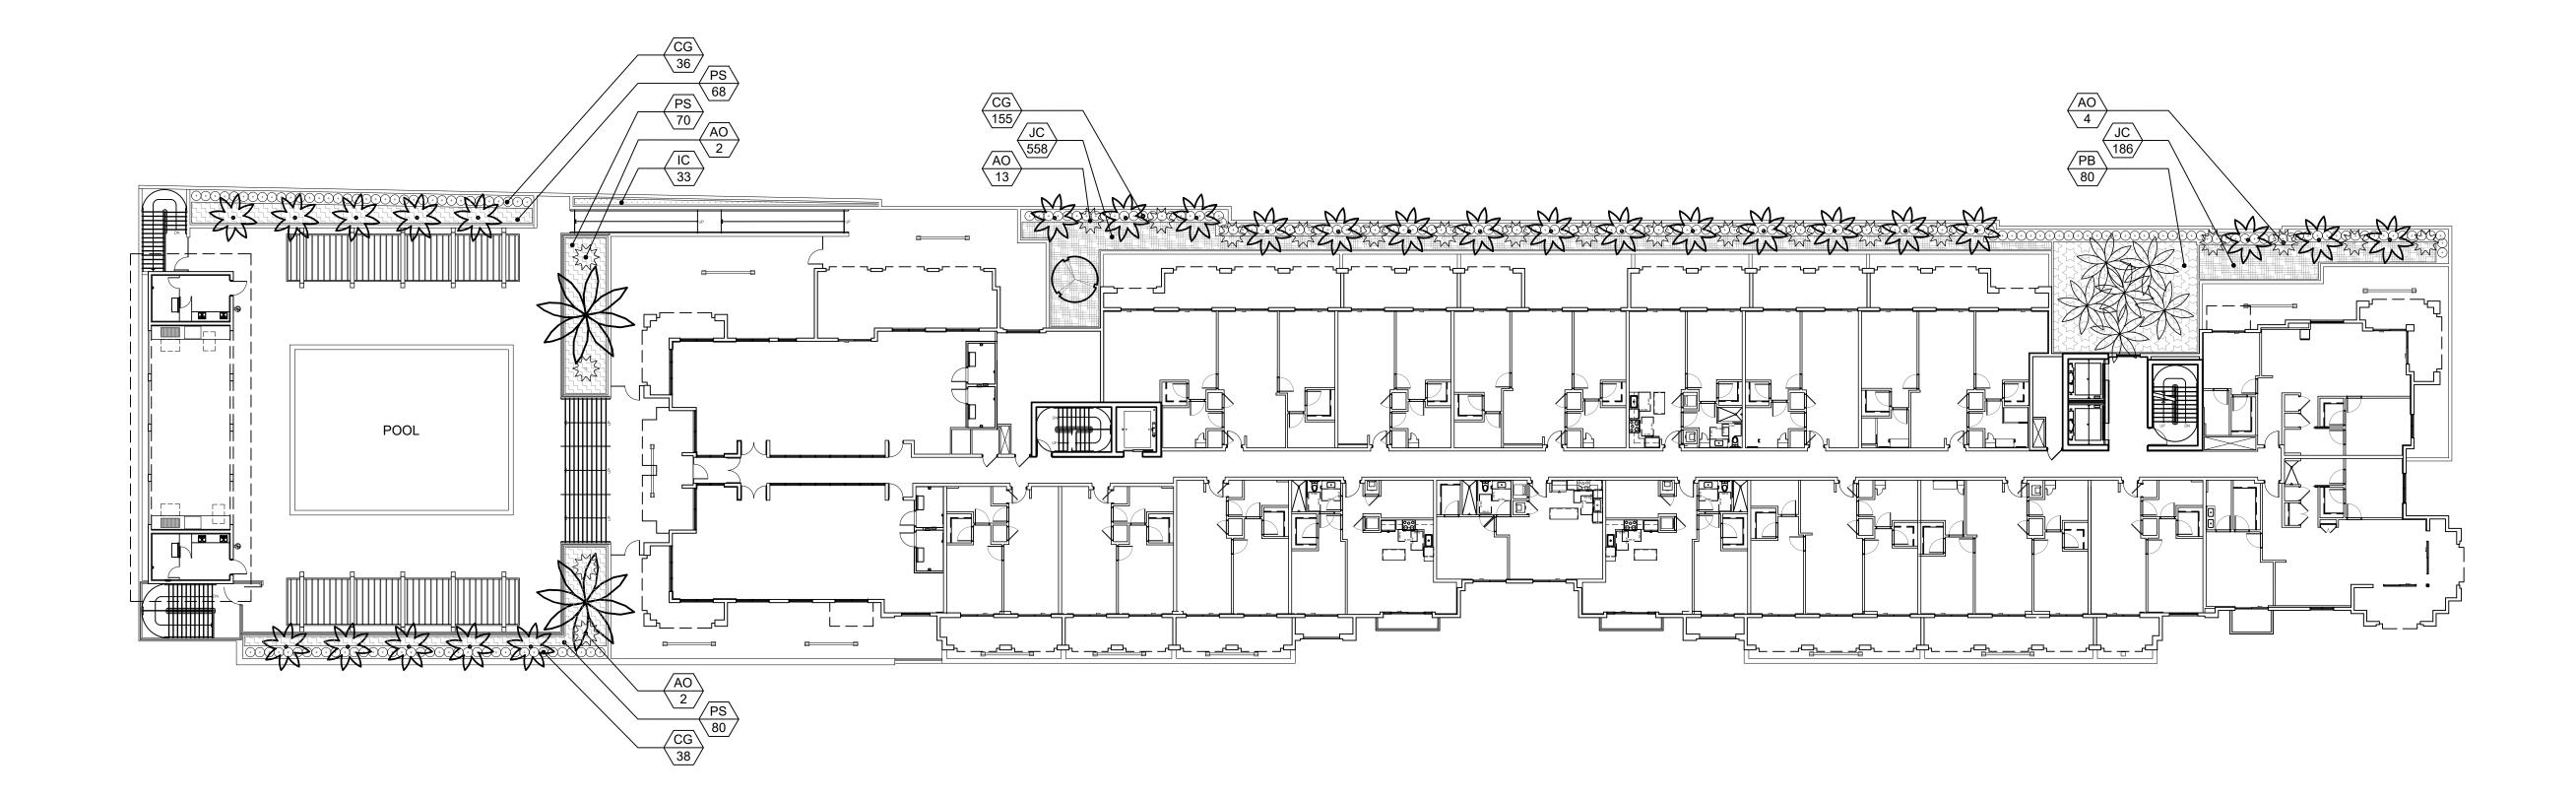

LANDSCAPE PLAN - RECREATION LEVEL

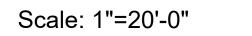



LANDSCAPE LIST

		TREES		
SYMBOL	QUAN.	PROPOSED MATERIAL		DESCRIPTION
		Caesalpinia granadillo	[STREET TREE]	16' HT. X 6' SPR. 3.5" CAL.
+	11	BRIDALVEIL TREE	[OTTLET TITLE]	F.G.
	00	*Coccoloba diversiflora		12' HT. X 6' SPR. 2" CAL.
	23	PIGEON PLUM		F.G.
<u>*</u>	1	*Coccoloba diversiflora	[STREET TREE]	16' HT. X 6' SPR. 3.5" CAL.
₹}	4	PIGEON PLUM	[0]	F.G.
	7	Lagerstroemia indica 'Muskogee'		12' HT. X 6' SPR. 2" CAL.
	7	MUSKOGEE CREPE MYRTLE		F.G.
M		Phoenix dactylifera 'Medjool'		10' C.T.
	2	MEDJOOL DATE PALM		F.G.
beg and	2	*Quercus virginiana	[STREET TREE]	16' HT. X 6' SPR. 3.5" CAL.
E Comment	3	LIVE OAK		F.G.
	6	*Roystonea elata		12' G.W., 28' O.A. HT. MIN.
	6	ROYAL PALM		F.G., MATCHED HTS.
M	33	Veitchia montgomeryana 'single'		16' O.A. HT. MIN.
ZW		SINGLE MONTGOMERY PALM		F.G.
	1	Veitchia montgomeryana 'quad'		16' O.A. HT. MIN.
	l	QUADRUPLE MONTGOMERY PALM		F.G.
		SHRUBS AND GROUN	IDCOVERS	
SYMBOL	QUAN.	PROPOSED MATERIAL		DESCRIPTION
AB	11	Aechmea blanchettiana		36" HT. X 24" SPR.
ΛD	11	BRIGHT YELLOW BROMELIAD		10" POT
AO	21	Alcantarea odorata		3' O.A. HT.
7.0	Z 1	BROMELIAD SP.		9" POT
CE	413	*Conocarpus erectus		24" HT. X 24" SPR. / 24" O.C.
CL	413	GREEN BUTTONWOOD		3 GAL.
CG	229	*Clusia guttifera		36" HT. X 24" SPR. / 24" O.C.
	223	SMALL LEAF CLUSIA		7 GAL.
CI	788	*Chrysobalanus icaco 'Red Tip'		18" HT. X 18" SPR. / 18" O.C.
	' 00	RED TIP COCOPLUM		3 GAL.
FM	1,271	Ficus microcarpa 'Green Island'		15" HT. X 15" SPR. / 15" O.C.
	.,	GREEN ISLAND FICUS		3 GAL.
IC	105	Ipomoea 'Margarite'		15" O.C.
	.00	CHARTREUSE SWEET POTATO		1 GAL. FULL
JC	744	Juniperus chinensis 'Parsonii'		15" HT. X 15" SPR. / 15" O.C.
- -		PARSON'S JUNIPER		3 GAL.
РВ	80	Philodendron 'Burle Marx'		24" HT. X 24" SPR. / 36" O.C.
		BURLE MARX PHILODENDRON		3 GAL.
PS	218	Pennisetum setaceum 'Alba'		18" HT. X 18" SPR. / 24" O.C.
	•	WHITE FOUNTAIN GRASS		3 GAL.
AWN	As	Stenotaphrum secundatum 'Floratam'		SOLID EVEN SOD
	Required	ST. AUGUSTINE GRASS		


^{*} DENOTES NATIVE SPECIES




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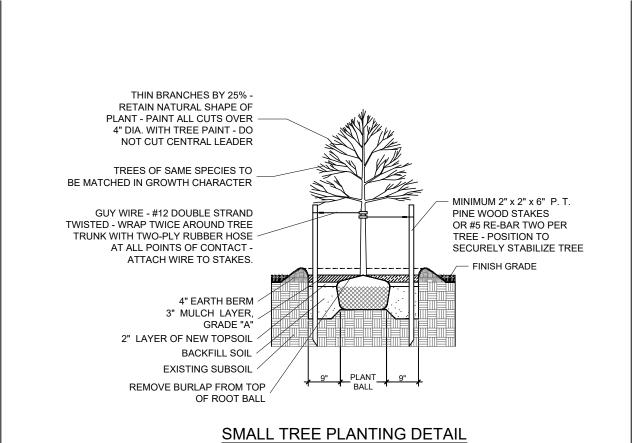
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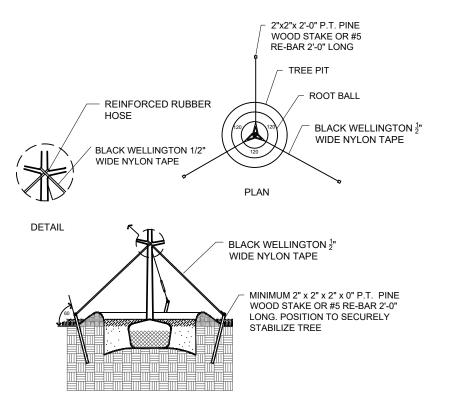
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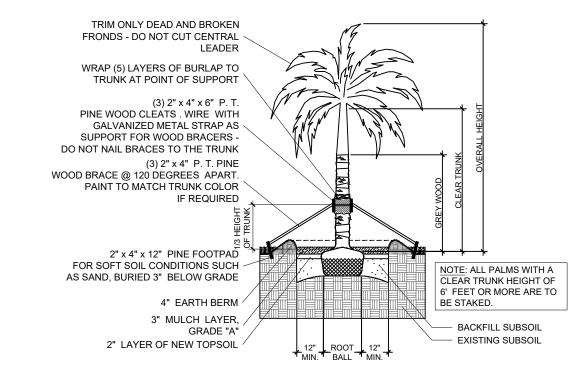
LARGE TREE PLANTING DETAIL






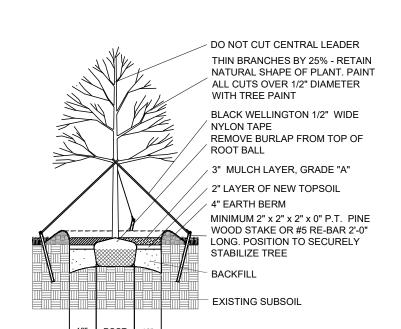


TYPICAL TREE GUYING DETAIL

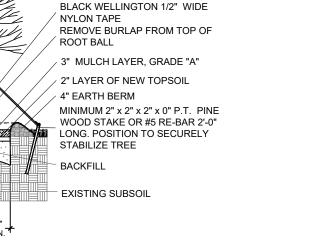


STRAIGHT TRUNK PALM PLANTING DETAIL

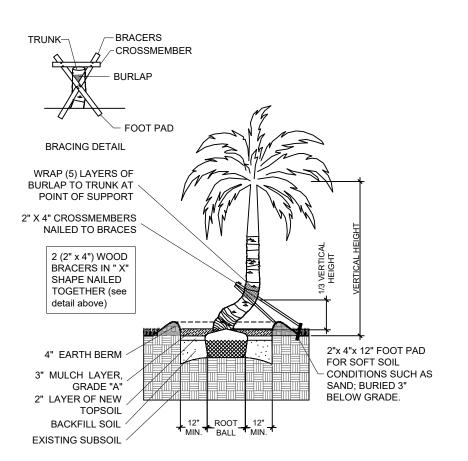




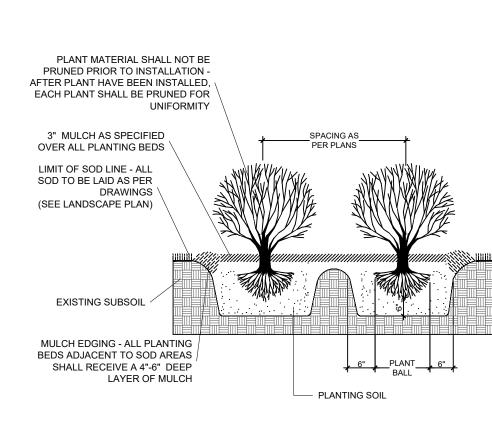



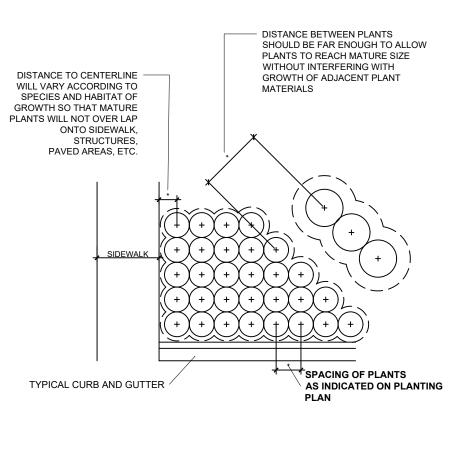

TYPICAL CONTAINER SPACING DETAIL

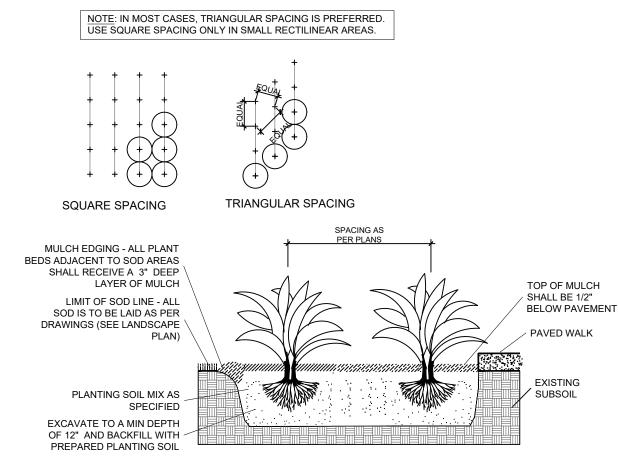

TYPICAL GROUNDCOVER PLANTING DETAIL

PLANTING NOTES:

-All plant material is to be Florida Number 1 or better pursuant to the Florida Department of Agriculture's Grades and Standards for Nursery Plants.

-All plants are to be top dressed with a minimum 3" layer of Melaleuca mulch, Eucalyptus mulch or equal.

-Planting plans shall take precedence over plant list in case of discrepancies.

-No changes are to be made without the prior consent of the Landscape Architect and Owner. Additions and or deletions to the plant material must be approved by the project engineer.

-Landscape Contractor is responsible for providing their own square footage takeoffs and field verification for 100% sod coverage for all areas specified.

- All landscape areas are to be provided with automatic sprinkler system which provide 100% coverage, and 50%
- All trees in lawn areas are to receive a 24" diameter mulched saucer at the base of the trunk.
- Trees are to be planted within parking islands after soil is brought up to grade. Deeply set root balls are not acceptable.
- Planting soil for topsoil and backfill shall be 50/50 mix, nematode free. Planting soil for annual beds to be comprised of 50% Canadian peat moss, 25% salt free coarse sand and 25% Aerolite.
- Tree and shrub pits will be supplemented with "Agriform Pells", 21 gram size with a 20-10-5 analysis, or substitute application accepted by Landscape Architect. Deliver in manufacturer's standard containers showing weight, analysis and name of manufacturer.

SOD NOTES:

-Sod is to be grade "A" weed free.

-All areas marked "LAWN" shall be solid sodded with St. Augustine 'Floratam' solid sod. See limit on plan. All areas marked 'Bahia Grass' shall be solid sodded with Paspalum.

-Provide a 2" deep blanket of planting soil as described in planting notes this sheet. Prior to planting, remove stones, sticks, etc. from the sub soil surface. Excavate existing non-conforming soil as required so that the finish grade of sod is flush with adjacent pavement or top of curb as well as adjacent sod in the case of sod patching.

-Place sod on moistened soil, with edges tightly butted, in staggered rows at right angles to slopes.

-Keep edge of sod bed a minimum of 18" away from groundcover beds and 24" away from edge of shrub beds and 36" away from trees, measured from center of plant.

-Sod Shall be watered immediatley after installation to uniformily wet the soil to at least 2" below the bottom of the sod

-Excavate and remove excess soil so top of sod is flush with top of curb or adjacent pavement or adjacent existing


GENERAL NOTES:

-The Landscape Contractor is to locate and verify all underground and overhead utilities prior to beginning work. Contact proper utility companies and / or General Contractor prior to digging for field verification. The Owner and the Landscape Architect shall not be responsible for any damages to utility or irrigation lines (see Roadway Plans for more utility notes).

-Landscape Contractor is to verify all current drawings and check for discrepancies and bring to the attention of the Landscape Architect prior to commencing with the work.

-All unattended and unplanted tree pits are to be properly barricaded and flagged during installation.

-All planting plans are issued as directives for site layout. Any deviations, site changes, etcetera are to be brought to the attention of the Landscape Architect for clarification prior to installation.

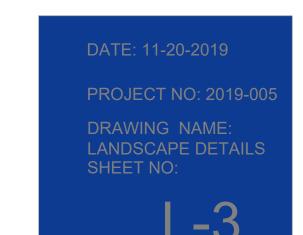

TREE DISPOSITION PLAN

Scale: 1"=20'-0"

SYMBOL LEGEND

Tree to Remove

Tree to Remain

MITIGATION REQUIRED				
TOTAL CANOPY REMOVED:	TOTAL CANOPY REPLACEMENT PROVIDED:			
15,373 sf	18 - Large Tree (500 sf each) = 9,000 sf 30 - Medium Tree Species (300 sf each) = 9,000 sf 8 - Large Palm Species (300 sf each) = 2,400 sf 34 - Small Palm Species (100 sf each) = 3,400 sf			
	Total Canopy Replacement Provided = 23,800 sf			


					/// (
No.	Common Name	Scientific Name	DBH (in)	Height (ft)	Spread (ft)	Canopy Removed (sf)	Disposition
1	Tree	Unknown	8	30	15	-	Remain
2	Queen Palm	Syagrus romanzoffiana	8	20	15	177	Remove
3	Queen Palm	Syagrus romanzoffiana	8	35	15	177	Remove
4	Queen Palm	Syagrus romanzoffiana	8	30	15	177	Remove
5	Queen Palm	Syagrus romanzoffiana	8	25	10	79	Remove
6	Queen Palm	Syagrus romanzoffiana	8	25	10	79	Remove
7	Queen Palm	Syagrus romanzoffiana	8	15	6	254	Remove
8	Queen Palm	Syagrus romanzoffiana	3	30	6	314	Remove
9	Coconut Palm	Cocos nucifera	12	30	15	314	Remove
10	Coconut Palm	Cocos nucifera	12	30	15	177	Remove
13	Tree Queen	Ailanthus altissima	10	25	15	177	Remove
14	Tree Queen	Ailanthus altissima	10	15	15	177	Remove
17	Tree Queen	Ailanthus altissima	10	20	10	79	Remove
18	Tree Queen	Ailanthus altissima	8	18	25	491	Remove
19	Almond Tree	Prunus dulcis	30	50	50	1963	Remove
25	Ficus	Ficus benjamina	6	10	10	79	Remove
26	Tree	Unknown	10	20	20		Remain
<u>2</u> 7	Silver Buttonwood	Conocarpus erectus	9	12	12	113	Remove
28	Areca Cluster	Areca catechu	10	20	15	-	Remain
30	Tree	Unknown	12	25	15	_	Remain
42	Areca Cluster	Areca catechu	12	10	8	50	Remove
44	Areca Cluster	Areca catechu		20	15	177	Remove
				20	15	177	Remove
45	Areca Cluster	Areca catechu	NI/A			177	
46	Umbrella Tree	Schefflera actinophylla	N/A	N/A	N/A	-	Remove
47	Areca Cluster	Areca catechu	4.4	10	8	50	Remove
48	Tree	Unknown	14	40	30	707	Remove
49	Tree	Unknown	14	20	20	314	Remove
51	Areca	Areca catechu		15	10	79	Remove
52	Areca	Areca catechu	10	15	10	79	Remove
53	Bottle Brush	Callistemon	10	18	12	113	Remove
55	Areca	Areca catechu	4	25	7	38	Remove
56	Areca	Areca catechu	3	25	6	28	Remove
57	Areca	Areca catechu	3	15	4	13	Remove
58	Bottle Brush	Callistemon		15	15	177	Remove
59	Coconut Palm	Cocos nucifera	18	25	20	314	Remove
60	Coconut Palm	Cocos nucifera	8	25	20	314	Remove
61	Areca Cluster	Areca catechu		15	10	79	Remove
62	Ficus	Ficus benjamina	48	50	50	1963	Remove
63	Almond Tree	Prunus dulcis	26	40	60	2826	Remove
64	Areca Cluster	Areca catechu		10	6	28	Remove
65	Areca Cluster	Areca catechu		10	6	28	Remove
66	Tree Queen	Ailanthus altissima	12	30	10	79	Remove
67	Tree Queen	Ailanthus altissima	10	25	10	79	Remove
68	Tree Queen	Ailanthus altissima	12	30	10	79	Remove
69	Areca Cluster	Areca catechu		15	20	314	Remove
70	Tree Queen	Ailanthus altissima	8	20	15	177	Remove
71	Areca Cluster	Areca catechu		15	10	79	Remove
72	Tree Queen	Ailanthus altissima	10	20	15	177	Remove
73	Tree Queen	Ailanthus altissima	12	25	8	50	Remove
74	Tree Queen	Ailanthus altissima	10	25	15	177	Remove
75	Areca Cluster	Areca catechu		15	10	79	Remove
76	Areca Cluster	Areca catechu		10	10	79	Remove
77	Areca Cluster	Areca catechu		20	15	177	Remove
78	Tree Queen	Ailanthus altissima	9	20	16	201	Remove
79	Tree Queen	Ailanthus altissima	9	20	10	79	Remove
80	Areca Cluster	Areca catechu	-	10	10	79	Remove
83	Traveler's Palm	Ravenala madagascariensis	8	20	20	314	Remove
86	Areca Cluster	Areca catechu		8	6	28	Remove
	Traveler's Palm	Ravenala madagascariensis	12	20	30	707	Remove

12

30

Total Canopy Removed 15373

87 Traveler's Palm Ravenala madagascariensis
88 Areca Cluster Areca catechu

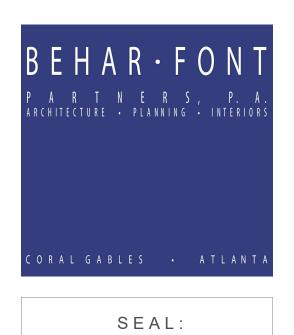

ANDREW M. WITKIN LIC. # LA0000889

301-341 301-3 CORAL



Remove Remove TREE DISPOSITION PLAN

Scale: 1"=20'-0"


SYMBOL LEGEND

Tree to Remove

Tree to Remain

MITIGATION REQUIRED				
TOTAL CANOPY REMOVED:	TOTAL CANOPY REPLACEMENT PROVIDED:			
15,373 sf	18 - Large Tree (500 sf each) = 9,000 sf 30 - Medium Tree Species (300 sf each) = 9,000 sf 8 - Large Palm Species (300 sf each) = 2,400 sf 34 - Small Palm Species (100 sf each) = 3,400 sf			
	Total Canopy Replacement Provided = 23,800 sf			

No.	Common Name	Scientific Name	DBH (in)	Height (ft)	Spread (ft)	Canopy Removed (sf)	Disposition
1	Tree	Unknown	8	30	15	-	Remain
2	Queen Palm	Syagrus romanzoffiana	8	20	15	177	Remove
3	Queen Palm	Syagrus romanzoffiana	8	35	15	177	Remove
4	Queen Palm	Syagrus romanzoffiana	8	30	15	177	Remove
5	Queen Palm	Syagrus romanzoffiana	8	25	10	79	Remove
6	Queen Palm	Syagrus romanzoffiana	8	25	10	79	Remove
7	Queen Palm	Syagrus romanzoffiana	8	15	6	254	Remove
8	Queen Palm	Syagrus romanzoffiana	3	30	6	314	Remove
9	Coconut Palm	Cocos nucifera	12	30	15	314	Remove
10	Coconut Palm	Cocos nucifera	12	30	15	177	Remove
13	Tree Queen	Ailanthus altissima	10	25	15	177	Remove
14	Tree Queen	Ailanthus altissima	10	15	15	177	Remove
17	Tree Queen	Ailanthus altissima	10	20	10	79	Remove
18	Tree Queen	Ailanthus altissima	8	18	25	491	Remove
19	Almond Tree	Prunus dulcis	30	50	50	1963	Remove
25	Ficus	Ficus benjamina	6	10	10	79	Remove
26	Tree	Unknown	10	20	20	-	Remain
27	Silver Buttonwood	Conocarpus erectus	9	12	12	113	Remove
28	Areca Cluster	Areca catechu	10	20	15	-	Remain
30	Tree	Unknown	12	25	15	-	Remain
42	Areca Cluster	Areca catechu		10	8	50	Remove
44	Areca Cluster	Areca catechu		20	15	177	Remove
45	Areca Cluster	Areca catechu		20	15	177	Remove
46	Umbrella Tree	Schefflera actinophylla	N/A	N/A	N/A	-	Remove
47	Areca Cluster	Areca catechu		10	8	50	Remove
48	Tree	Unknown	14	40	30	707	Remove
49	Tree	Unknown	14	20	20	314	Remove
51	Areca	Areca catechu		15	10	79	Remove
52	Areca	Areca catechu		15	10	79	Remove
53	Bottle Brush	Callistemon	10	18	12	113	Remove
55	Areca	Areca catechu	4	25	7	38	Remove
56	Areca	Areca catechu	3	25	6	28	Remove
57	Areca	Areca catechu	3	15	4	13	Remove
58	Bottle Brush	Callistemon	1.5	15	15	177	Remove
59	Coconut Palm	Cocos nucifera	18	25	20	314	Remove
60	Coconut Palm	Cocos nucifera	8	25	20	314	Remove
61	Areca Cluster	Areca catechu	40	15	10	79	Remove
62	Ficus	Ficus benjamina	48	50	50	1963	Remove
63	Almond Tree	Prunus dulcis	26	40	60	2826	Remove
64	Areca Cluster	Areca catechu		10	6	28	Remove
65	Areca Cluster	Areca catechu	10	10	6	28	Remove
66 67	Tree Queen	Ailanthus altissima	12	30 25	10 10	79 79	Remove
68	Tree Queen	Ailanthus altissima	12	30	10	79	Remove Remove
69	Tree Queen Areca Cluster	Ailanthus altissima Areca catechu	12	15	20	314	Remove
		Ailanthus altissima	8	20	15		Remove
70 71	Tree Queen Areca Cluster	Areca catechu	0	15	10	177 79	Remove
72	Tree Queen	Ailanthus altissima	10	20	15	177	Remove
73	Tree Queen	Ailanthus altissima	12	25	8	50	Remove
74	Tree Queen	Ailanthus altissima	10	25	15	177	Remove
	Areca Cluster	Areca catechu	10	15	10	79	Remove
	Areca Cluster	Areca catechu		10	10	79	Remove
	Areca Cluster	Areca catechu		20	15	177	Remove
78	Tree Queen	Ailanthus altissima	9	20	16	201	Remove
79	Tree Queen	Ailanthus altissima	9	20	10	79	Remove
	Areca Cluster	Areca catechu		10	10	79	Remove
83	Traveler's Palm	Ravenala madagascariensis	8	20	20	314	Remove
	Areca Cluster	Areca catechu		8	6	28	Remove
87	Traveler's Palm	Ravenala madagascariensis	12	20	30	707	Remove
	Areca Cluster	Areca catechu	· -	10	8	50	Remove
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ANDREW M. WITKIN
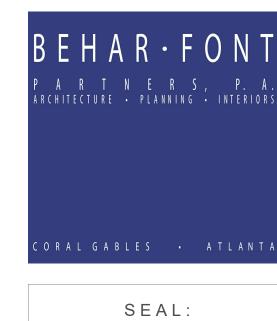
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