




AFA & COMPANY, INC. PROFESSIONAL LAND SURVEYORS AND MAPPERS

FLORIDA CERTIFICATE OF AUTHORIZATION No. LB 7498

MIAMI, FLORIDA 33186 E-MAIL: AFACO@BELLSOUTH.NET PH: 305-234-0588 FX: 206-495-0778



Location Sketch N.T.S.

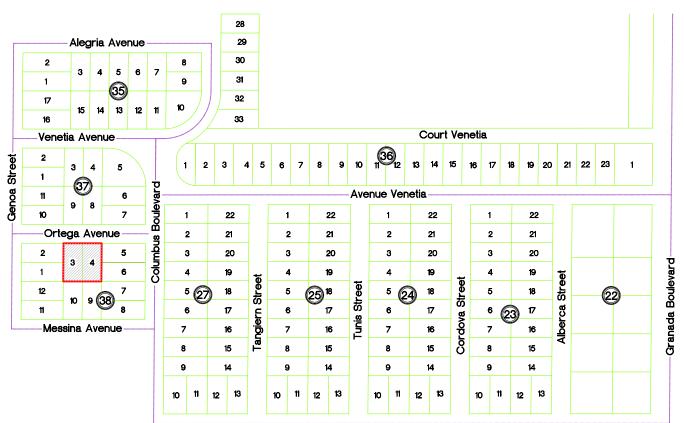

Sheet 1 of 2

Property Information

CERTIFIED ONLY TO:

Hector Lastre and Vivian Lastre

PROPERTY ADDRESS:

1220 Ortega Avenue Coral Gables, Florida 33134

LEGAL DESCRIPTION:

Lots 3 & 4, Block 38, of: "REVISED PLAT OF CORAL GABLES GRANADA SECTION", according to the Plat Thereof as Recorded in Plat Book 8, Page 113, of the Public Records of Miami-Dade County, Florida.

ELEVATION INFORMATION National Flood Insurance Program FEMA Elev. Reference to NGVD 1929

Comm Panel 120639 0294 Panel #

Firm Zone: "X"

Date of Firm: 09-11-2009

Base Flood Elev. N/A F.Floor Elev. 12.65' Garage Elev. 10.79' "L" Suffix:

Elev. Reference to NGVD 1929

JOB#	20-137
DATE	02-04-2020
PB	8-113

Surveyors Notes:

- #1 Land Shown Hereon were not abstracted for Easement and /or Right of Way Records. The Easement / Right of Way Show on Survey are as per plat of record unless otherwise noted. #2 Benchmark: Miami-Dade County Public Works Dep.
- #3 Bearings as Shown hereon are Based upon Venetia Avenue, N90°00'00"E
- #4 Please See Abbreviations
- #5 Drawn By: A. Torres
- #6 Date: 02-04-2020
- #7 Completed Survey Field Date: 02-04-2020
- #8 Disc No 2020, Station Surveying Scion
- #9 Last Revised:
- #10 Zoned Building setback line not determined

Surveyor's Notes:

- #11 The herein captioned Property was surveyed and described based on the Legal Description Provided by Client. #12 This Certification is Only for the lands as Described. it is not a
- certification of Title, Zoning, Easements, or Freedom of encumbrances. ABSTRACT NOT REVIEWED.
- #13 There may be additional Restrictions not Shown on this survey that may be found in the Public Records of Said County Examination of ABSTRACT OF TITLE will have to be made to determine recorded instruments, if any affecting this property. #14 Accuracy:
- The expected use of land, as classified in the Standards of Practice (5J-17.052), is residential. The minimum relative distance accuracy for this type of boundary survey is 1.0 foot in 10,000.00' feet. the accuracy obtained by measurement and calculation of a closed geometric figure was found to exceed this requirement.
- #15 Foundation and / or footing that may cross beyond the boundary lines of the parcel herein described are not shown hereon.
- #16 Not valid without the signature and original seal of a Florida Licensed Surveyor and Mapper. additions or deletions to survey maps or reports by other than the signing party or parties.
- #17 Contact the appropriate authority prior to any design work on the herein described parcel for building and zoning information.
- #18 Underground Utilities are not depicted hereon, contact the appropriate authority prior to any design work or construction on the property herein described. Surveyor shall be notified as to any deviation from utilities shown hereon.

This certifies that the survey of the property described hereon was made under my super-

vision & that the survey meets the Standards of Practice set forth by the Florida Board of Professional Land Surveyors & Mappers in Chapter 5J-17.052 of Florida

Administrative Code, pursuant to Section

accurate representation thereof to the best

of my knowledge and Belief, subject to notes

& That the Sketch hereon is a true and

472.027, Florida Statutes.





Professional Surveyors & Mappers LB 7498 13050 S.W. 133rd Court Miami Florida, 33186

E-mail: afaco@bellsouth.net Ph: (305) 234-0588 Fax: (206) 495-0778

Armando F. Alvarez Professional Surveyor & Mapper #5526 State of Florida Not Valid unless Signed & Stamped with Embossed Seal



Sheet 2 of 2

Abbreviations of Legend AVE. = AVENUE
ASPH = ASPHALT
A/W = ANCHORD WIRE
A/C = AIR CONDITIONER
BLDG = BUILDING
B. COR. = BLOCK CORNER
CAL = CALCULATED
C.B. = CATCH BASIN
CLF = CHAIN LINK FENCE
CONC. = CONCRETE
COL. = COULUMN
C.U.P. = CONCRETE UTILITY POLE
CLP. = CONCRETE LIGHT POLE
CBS = CONCRETE BIGHT FOLE
CBS = CONCRETE WILLITY FOLE
CTONCRETE BIGHT FOLE
CBS = CONCRETE BIGHT FOLE
CBS = CONCRETE BIGHT FOLE
CBS = TRUCTURE C.E.F. -CONCRETE EIGHT FOLE
CBS =CONCRETE BLOCK
STRUCTURE
C.M.E. =CANAL MAINTENANCE EASEMENT EASEMENT
=DELTA
-DRIVEWAY
=DRAINAGE & MAINTENANCE
EASEMENT
=ENCROACHMENT
=ELECTRIC TRANSFORMER PAD
=FLORIDA POWER AND LIGHT
=FIRE HYDRANT
=EOLINI IRON PIPE ENC. E.T.P. F.P.L. F.H. F.I.P. F.F. DH/F F.R. F/D F/N I/F =FOUND IRON PIPE =FINISH FLOOR =FINISH FLOOR =FOUND DRILL HOLE =FOUND REBAR =FOUND DISC F/D =FOUND DISC
F/N =FOUND NAIL
I/F =IRON FENCE
L =LENGHT
L.M.E. =LAKE MAINTENANCE EASEMENT
L.F.E. =LOWEST FLOOR ELEVATION
L.P. =LIGHT POLE
MEAS. =MEASURED
M.H. =MAN HOLE
M.L =MONUMENT LINE
N.G.V.D. =NATIONAL GEODETIC
VERTICAL DATUM
N.T.S. = NOT TO SCALE =NOT TO SCALE =OVERHEAD ELECTRIC LINE O.E. O/L P.C.P. P.M. P.C. P/W PL. P.O.C P.O.B =ON LINE
=PERMANENT CONTROL POINT
=PARKING METER
=POINT OF CURVATURE =PARKWAY =PLANTER =POINT OF COMMENCEMENT =POINT OF BEGINNING =CENTER LINE =EASEMENT +0.00' =DENOTES ELEVATIONS =BUILDING =DISTANCE

=CATCH BASIN

=WATER METER =W.U.P. =STATE ROAD =US HIGHWAY =INTERSTATE =MONITORY WELL

Company, Inc.

Prepared By:

AFA & COMPANY, INC.

PROFESSIONAL LAND SURVEYORS AND MAPPERS

FLORIDA CERTIFICATE OF AUTHORIZATION No. LB 7498
13050 SW 133RD COURT
MIAMI, FLORIDA 33186

E-MAIL: AFACO@BELLSOUTH.NET
PH: 305-234-0588
FX: 206-495-0778

25.00′				F	arkway					
		/N 19.AT		Ortega	36 AV	enue 100.00'		+9.51 -	/N	145.19'
					alt Paveme	nt	<u>-</u> ¢		• · · · · · · · · · · · · · · · · · · ·	Int.
Asphalt	25.00' N0000'00'W	C/B		Black Olive Dia. 2.0' H 40 S. 30'	гв.о-1ю.и С/	<u> </u>	Black Dia.	1.7'	N0000'00"W 25.00'	Blvc
5' Sidew	as beautiful.			N9000'00'E Ţ		100.00'		1/2 CID	A	115.00'
	½" FIP No Id	+9.64°	0.22	+998	1984	¥.	.6l.0	½" FIP No Id	4.88'	Conc. Corr D/W
Lot 2, Block 38	,00°001	9 0	±10.31	Vaca	int Lo	ot		±10.15	,00°00L	RES. #1402 GARAGE Lot 5, Block 38
Lot 1, Block 38	N0026'05'E			Lot 3. Block 38	Lot 4, Block 38		0.230 acres		5.39' N0056'05'E	CBS RES. #1406 Storage Lot 6, Block 38
	½" FIP No Id	4.79	⊠ W/M			0.0		WUP ⊚	½" FIP No Id	


OB#	20-137
DATE	02-04-2020
PB	8-113

The sketch hereon is a true and Accurate representation thereof to the best of my knowledge and belief, Subject to notes and Notations shown hereon.

Armando F. Alvarez Professional Surveyor & Mapper #5526 State of Florida Not Valid unless Signed & Stamped with Embossed Seal

PROPOSED RESIDENCE FOR: PERLAS 1220 ORTEGA, LLC

1220 ORTEGA AVENUE, CORAL GABLES FLORIDA 33143

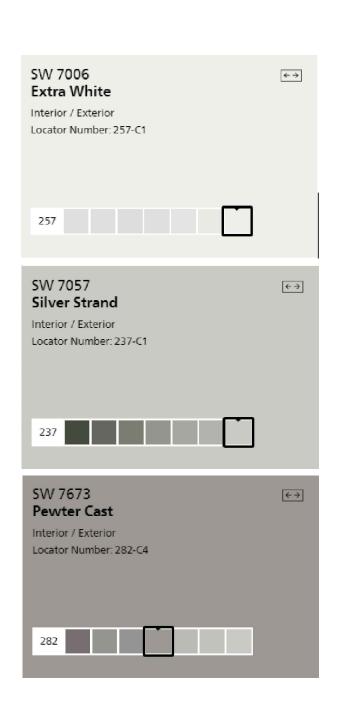




FRONT ELEVATION (NORTH)

1/4" = 1'-0"

ATELIER305 ARCHITECTURE URBAN PLANNING INTERIOR DESIGN AA 26002378 WWW.ATELER305.COM 2394 SW 6th STREET MIAMI, FL 33135 LPEREZ@ATELIER305.COM CONSULTANTS: ISSUE DATE: 11-04-2020 REVISIONS: 1220 ORTEGA HOUSE 1220 ORTEGA AVENUE CORAL GABLES, FL 33134 LESTER PEREZ PIZARRO AR95944 Project Number 2002 Drawing Name COVER

Drawing Number

Scale:

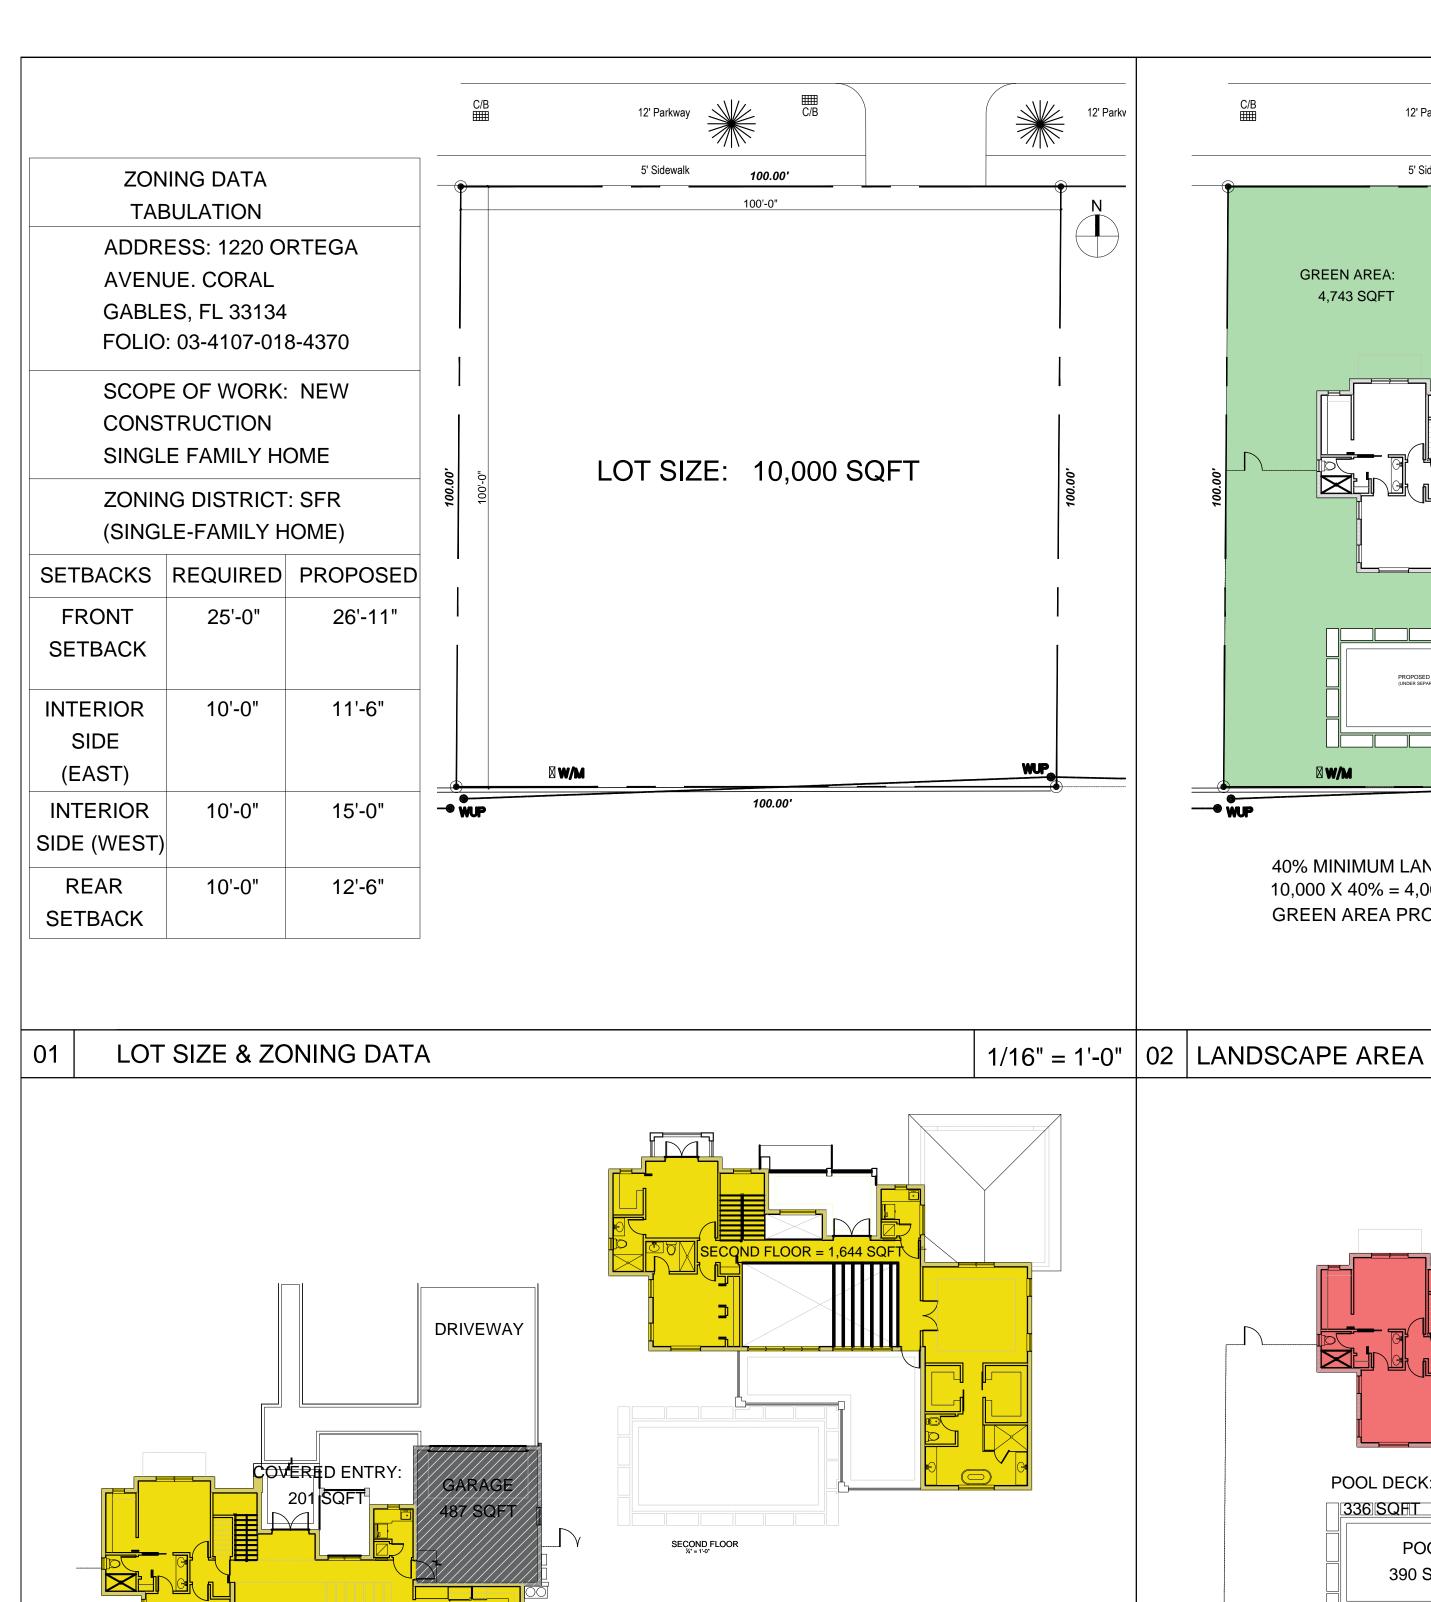


POOL DECK:

336 SQFT


04 | F.A.R DIAGRAMS

POOL:

390 SQFT

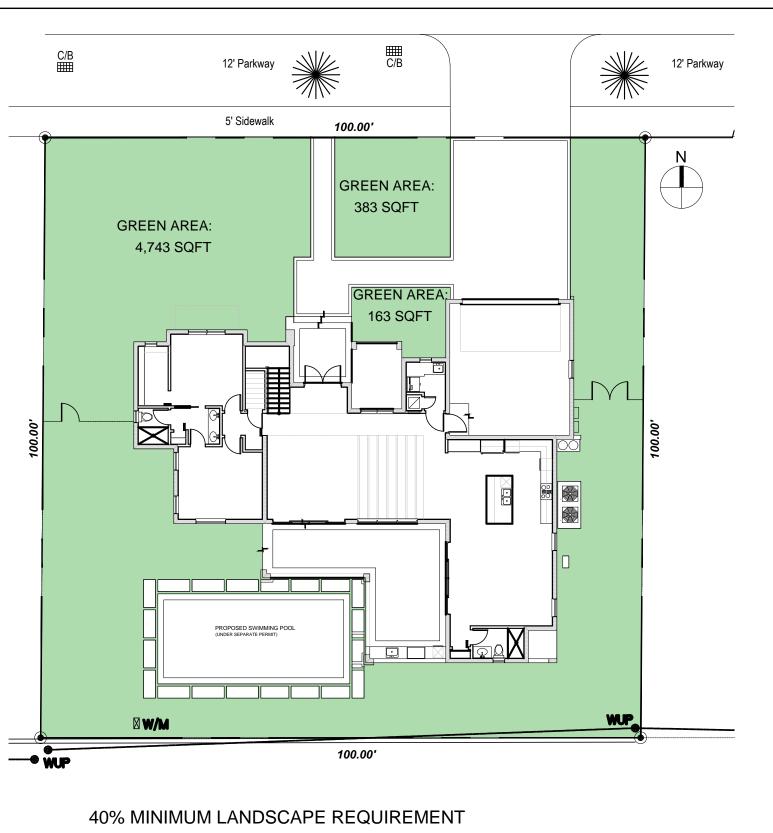

40% MINIMUM LANDSCAPE REQUIREMENT 10,000 X 40% = 4,000 SQFT MINIMUM REQUIRED GREEN AREA PROPOSED: 4,743 +383 + 163 = 5,289 SQFT (52.89%)

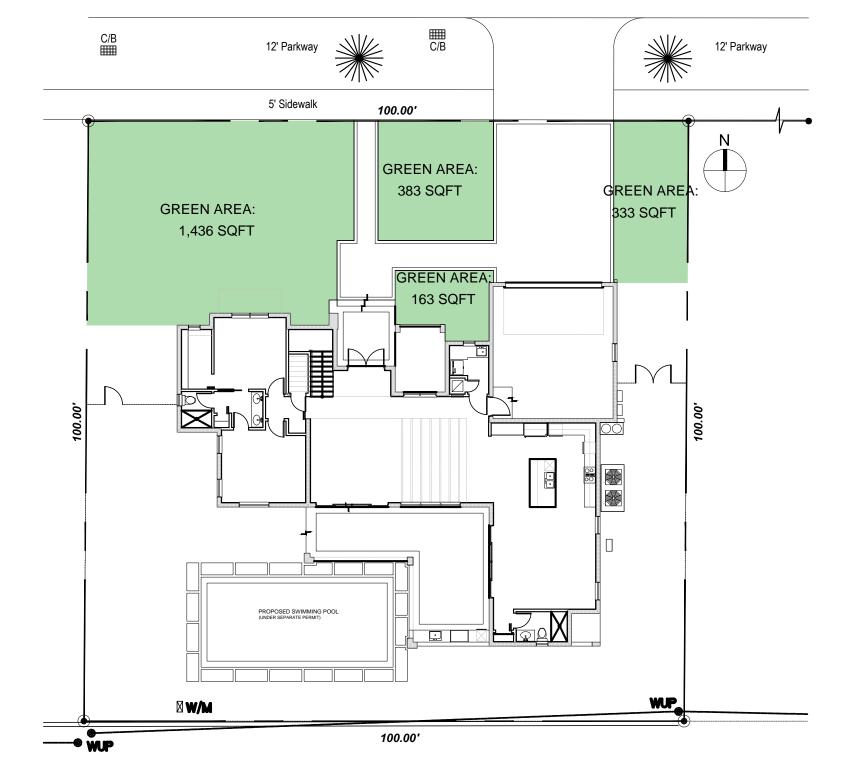


20% MINIMUM LANDSCAPE REQUIREMENT


4,000 X 20% = 800 SQFT MINIMUM REQUIRED


20% GREEN AREA PROPOSED: 1,436 + 383 + 163 + 333 = 2,315 SQFT (57.87%)

1/16" = 1'-0" | 03 | FRONT YARD LANDSCAPE AREA 1/16" = 1'-0" DRIVEWAY DRIVEWAY GARAGE FIRST FLOOR = 2,019 FIRST FLOOR = 2,019SQFT SQFT DS ADS COVERED TERRACE COVERED TERRACE: POOL DECK: POOL DECK: 463 SQFT 463 SQFT 336 SQHT 336 SQ#T POOL: POOL: 390 SQFT 390 SQFT EQUIPMENT FIRST FLOOR = 2,019 EQUIPMENT SQFT F.A.R. REQUIREMENT COVERED TERRACE: 5,000 X 48% = 2,400 SQFT 45% TOTAL AUXILIARY AND / OR FIRST FLOOR = 2.019 SQFT 463 SQFT FIRST FLOOR = 2,019 SQFT 35% GROUND COVERAGE **ACCESSORY** GARAGE = 487 SQFT 5,000 X 35% = 1,750 SQFT GARAGE = 487 SQFT COVERED ENTRY-PORCH = 201 COVERED ENTRY-PORCH = 201 $10,000 \times 35\% = 3,500 \text{ SQFT MAX}.$ 10,000 X 45% = 4,500 SQFT MAX.SQFT ALLOWED SQFT X POOL MAXIMUM ALLOWED = 4,150 SQFT COVERED TERRACE = 463 SQFT ALLOWED COVERED TERRACE = 463 SQFT EQUIPMENT POOL EQUIPMENT = 26 SQFT POOL EQUIPMENT = 26 SQFT FIRST FLOOR = 2,019 SQFT POOL = 390 SQFT SECOND FLOOR = 1,644 SQFT PROPOSED = 3,196 SQFT PROPOSED = 3,586 SQFT GARAGE = 487 SQFT MAXIMUM ALLOWED=3,500 SQFT MAXIMUM ALLOWED=4,500 SQFT PROPOSED = 3,196 SQF PROPOSED = 3,586 SQF 1/16" = 1'-0" | 05 | 35 % LOT COVERAGE 1/16" = 1'-0" | 06 | 45% LOT COVERAGE 1/16" = 1'-0"

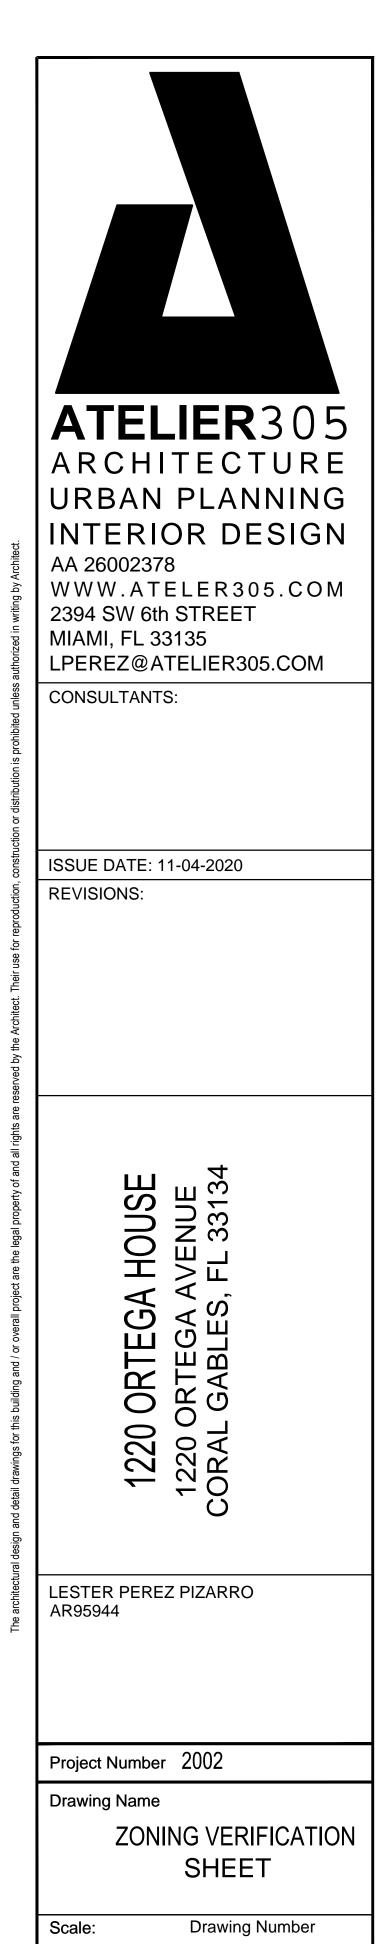


ZV-1

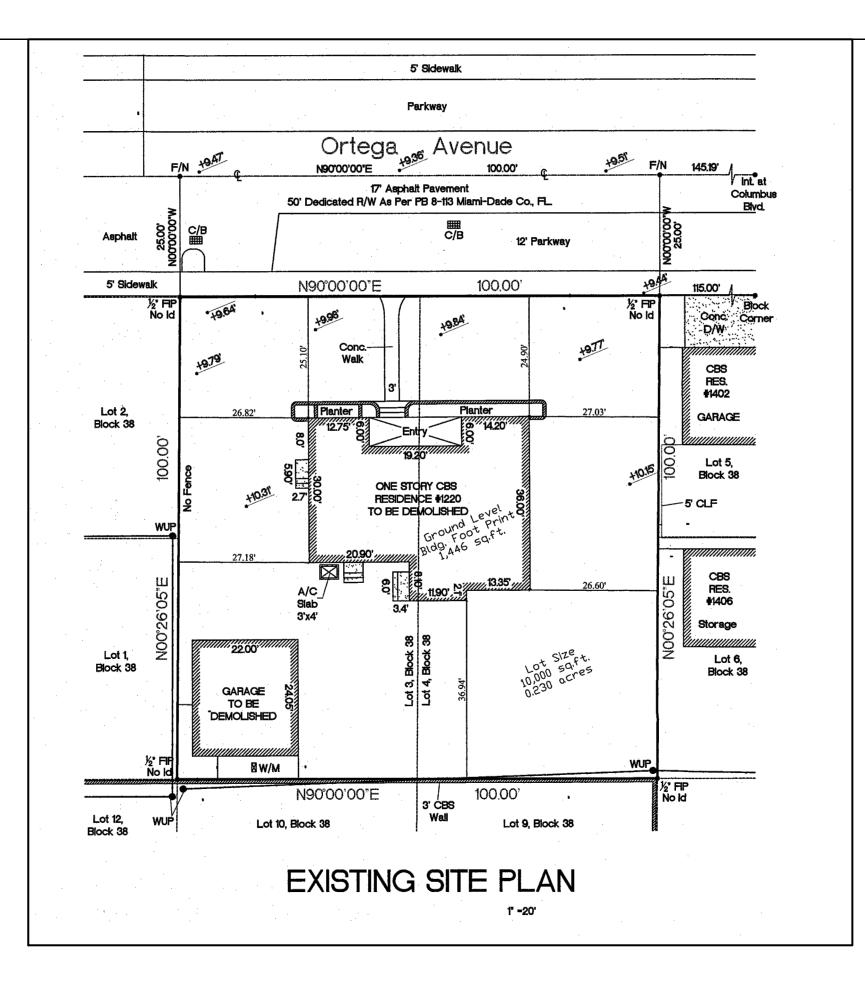

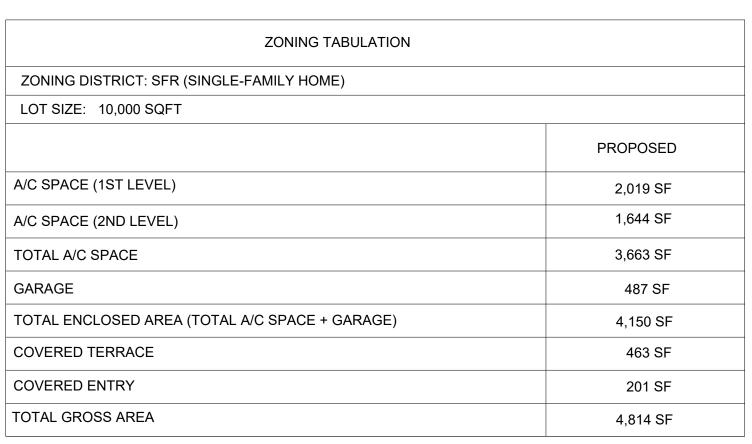


SEPTIC TANK CALCS. 3,669.11 square ft OF LIVING AREA - (3,669.11-3,300)= 339.11 S**K** 750 (add 60 GPD) = 60 GPD. + 400 GPD= 460 GPD SEPTIC TANK = 1,200 GALS DRAIN FIELD= 460 GPD/0.80(TRENCH) = 575 SF. 575 SF./15SF/CHAMBER = 39 CHAMBERS MIN. MIN. /15SF PER CHAMBER ARC-24, 5' LONG EACH ONE. UNOBSTRUCTED AREA = 411.90 SQUARE FT

THERE ARE NO PERTINENT FEATURES ON ADJACENT PROPERTIES AND ACROSS THE STREET THAT MAY AFFECT THE SYSTEM INSTALLATION

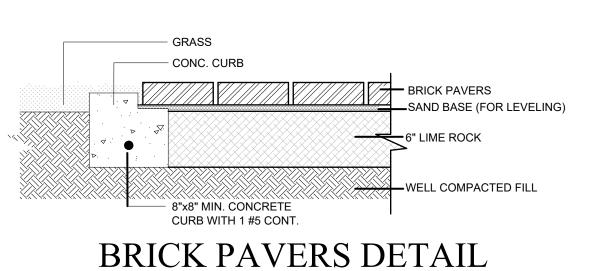

	ZONING DATA	
	TABULATION	
ZONING DISTRICT: SFR (SINGLE-FAN	(ILY HOME)	
LOT SIZE: 10,000 SQFT	ALLOWED	PROPOSED
MAXIMUM LOT COVERAGE		
FIRST FLOOR + GARAGE + COVERED TERRACE + COVERED ENTRY+POOL EQUIPMENT	3,500 SF (35%)	3,196 SF (31.96%)
FIRST FLOOR + GARAGE + COVERED TERRACE + COVERED ENTRY+POOL EQUIPMENT + POOL	4,500 SF (45%)	3,586 SF (35.58%)
MAXIMUM F.A.R. (0.48*5000+0.35*5000)	4,150 SF	4,150 SF
MAXIMUM HEIGHT	25"-0"	23'-0"
FRONT SETBACK SIDE SETBACK	25'-0" EAST: 10'-0" WEST: 10'-0"	26'-11" EAST: 11'-6" WEST: 15'-0"
REAR SETBACK	10'-0" MINIMUM	12'-6"
SIDE SETBACK (POOL)	10'-0" (WEST SIDE)	20'-4"
REAR SETBACK (POOL)	10'-0"	10'-0"
ANDSCAPE AREA	4,000 (40%)	5,289 (52.89%)
 _ANDSCAPE: EXISTING TO REMAIN,	NO ALTERATION TO EVICTING T	DEES AND / OD SHOUDS ADEA IN

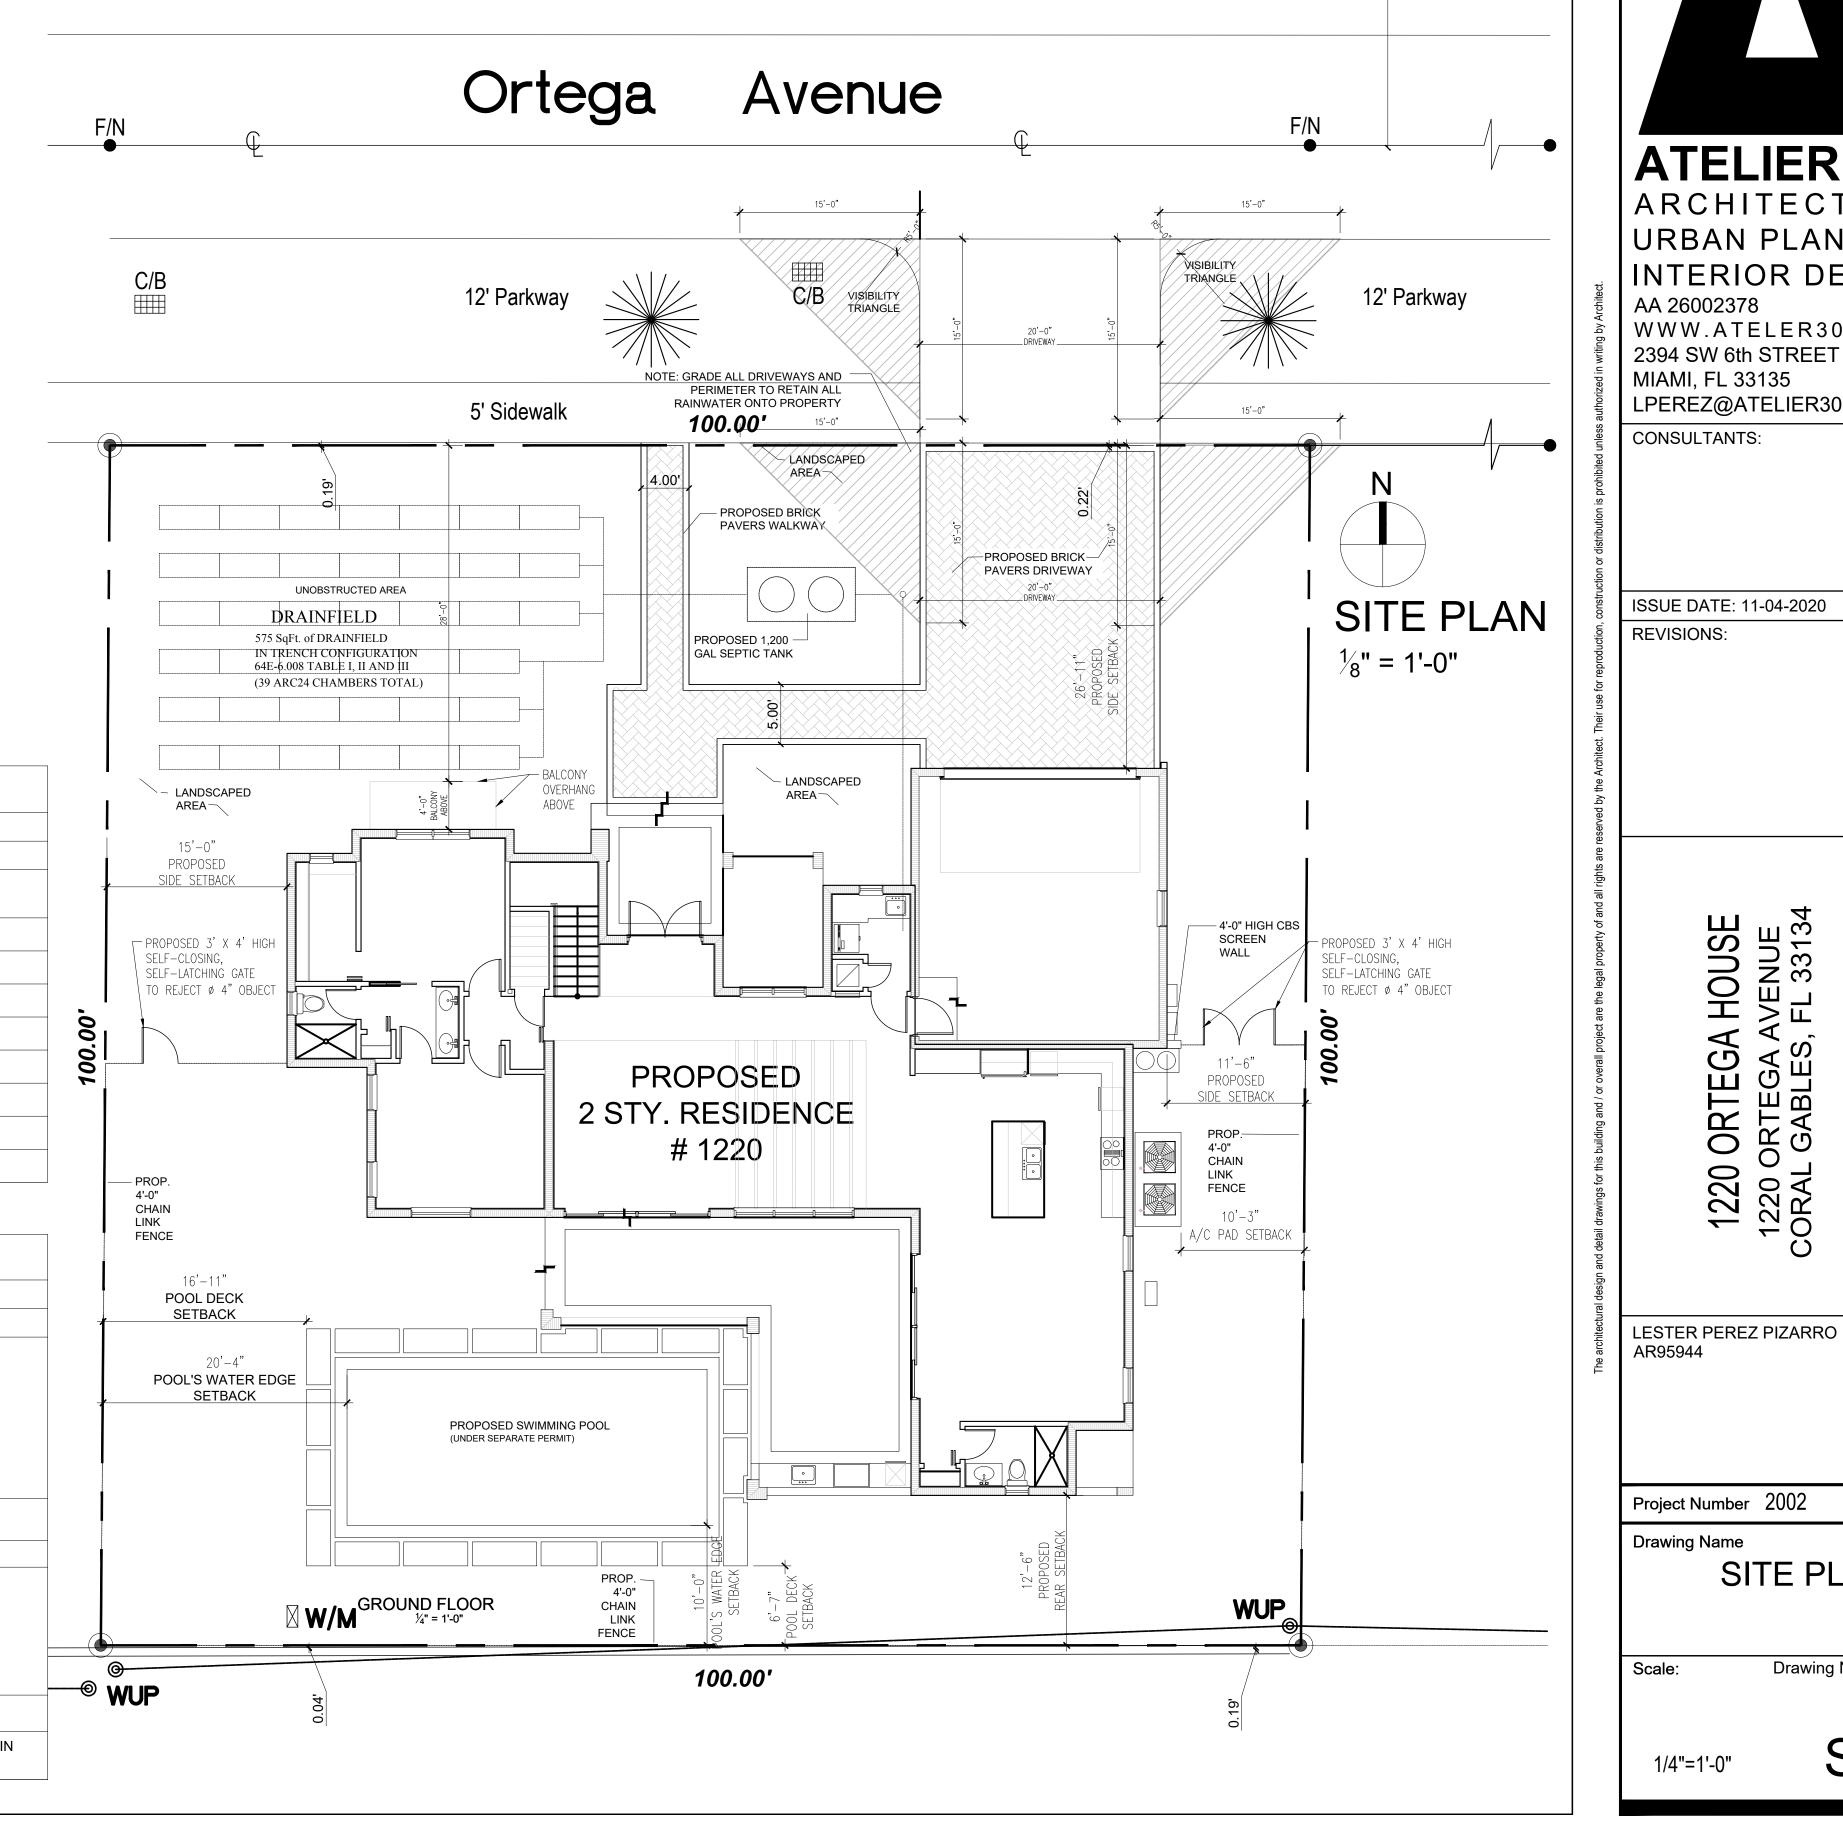



MIAMI, FL 33135 LPEREZ@ATELIER305.COM

CONSULTANTS:

ISSUE DATE: 11-04-2020

1220 ORTEGA HOUSE 1220 ORTEGA AVENUE CORAL GABLES, FL 33134

LESTER PEREZ PIZARRO AR95944


Project Number 2002

Drawing Name

SITE PLAN

Scale: Drawing Number



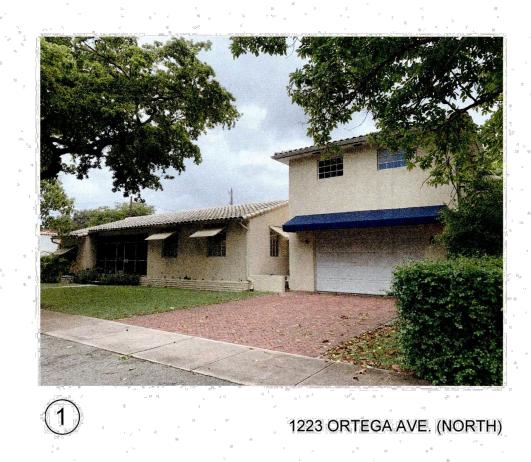




2



1402 COLUMBUS (EAST)

1403 GENOA ST. (WEST)



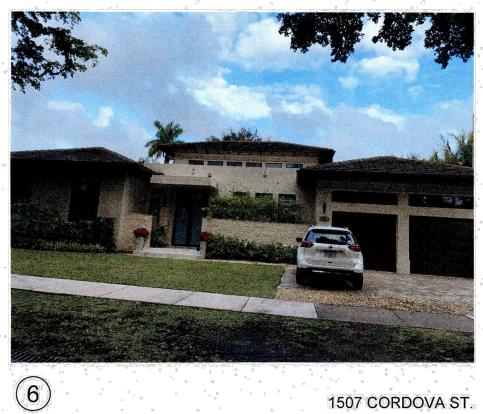

1200 MESSINA AVE.

(5) 432 MADIERA AVE. 1507 CORDOVA ST.







1259 ASTURIA AVE

(8) 1106 ASTURIA AVE.

1228 CATALONIA AVE.



SITE CONTEXT, PHOTOS AND ZONING ANALYSIS

ATELIER305 ARCHITECTURE URBAN PLANNING INTERIOR DESIGN AA 26002378 WWW.ATELER305.COM 2394 SW 6th STREET MIAMI, FL 33135 LPEREZ@ATELIER305.COM CONSULTANTS: ISSUE DATE: 11-04-2020 REVISIONS: 1220 ORTEGA HOUSE 1220 ORTEGA AVENUE CORAL GABLES, FL 33134

LESTER PEREZ PIZARRO AR95944


Project Number 2002

Drawing Name

Drawing Number Scale:

1/4"=1'-0"



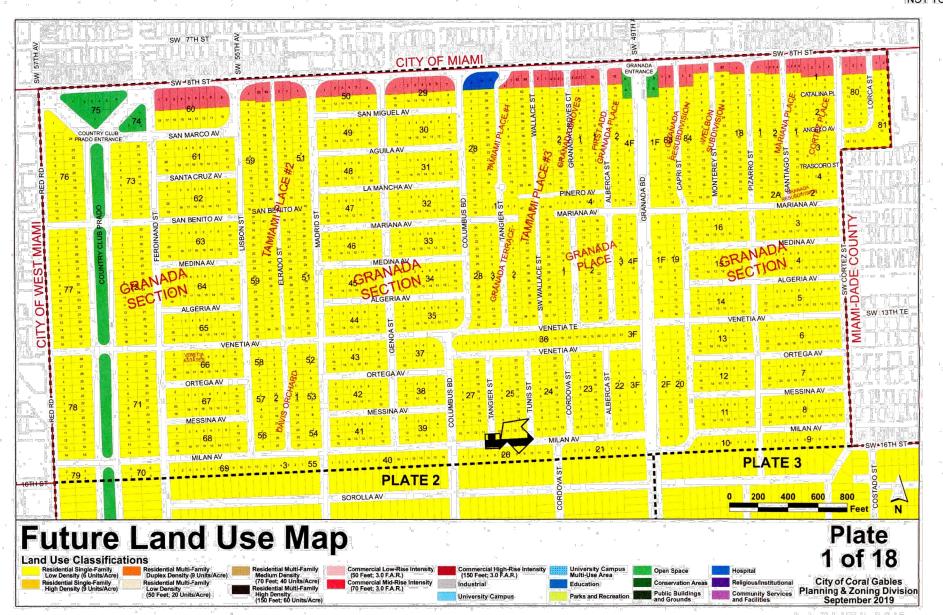



LAND USE MAP


PROPERTY ADDRESS: 1220 ORTEGA AVENUE CORAL GABLES, FLORIDA 33134 LEGAL DESCRIPTION:


LOTS 3 & 4, BLOCK 38, OF: "REVISED PLAT OF CORAL GABLES GRANADA SECTION", ACCORDING TO THE PLAT THEREOF AS RECORDED IN PLAT BOOK 8, PAGE 113, OF THE PUBLIC RECORDS OF MIAMI-DADE COUNTY, FLORIDA.

ELEVATION INFORMATION NATIONAL FLOOD INSURANCE PROGRAM FEMA ELEV. REFERENCE TO NGVD 1929 COMM PANEL 120639
PANEL # 0294
FIRM ZONE: "X"
DATE OF FIRM: 09-11-2009
BASE FLOOD ELEV. N/A
EXIST. F FLOOR ELEV. 12.65'
EXIST. GARAGE ELEV. 10.79'
SUFFIX: "L"

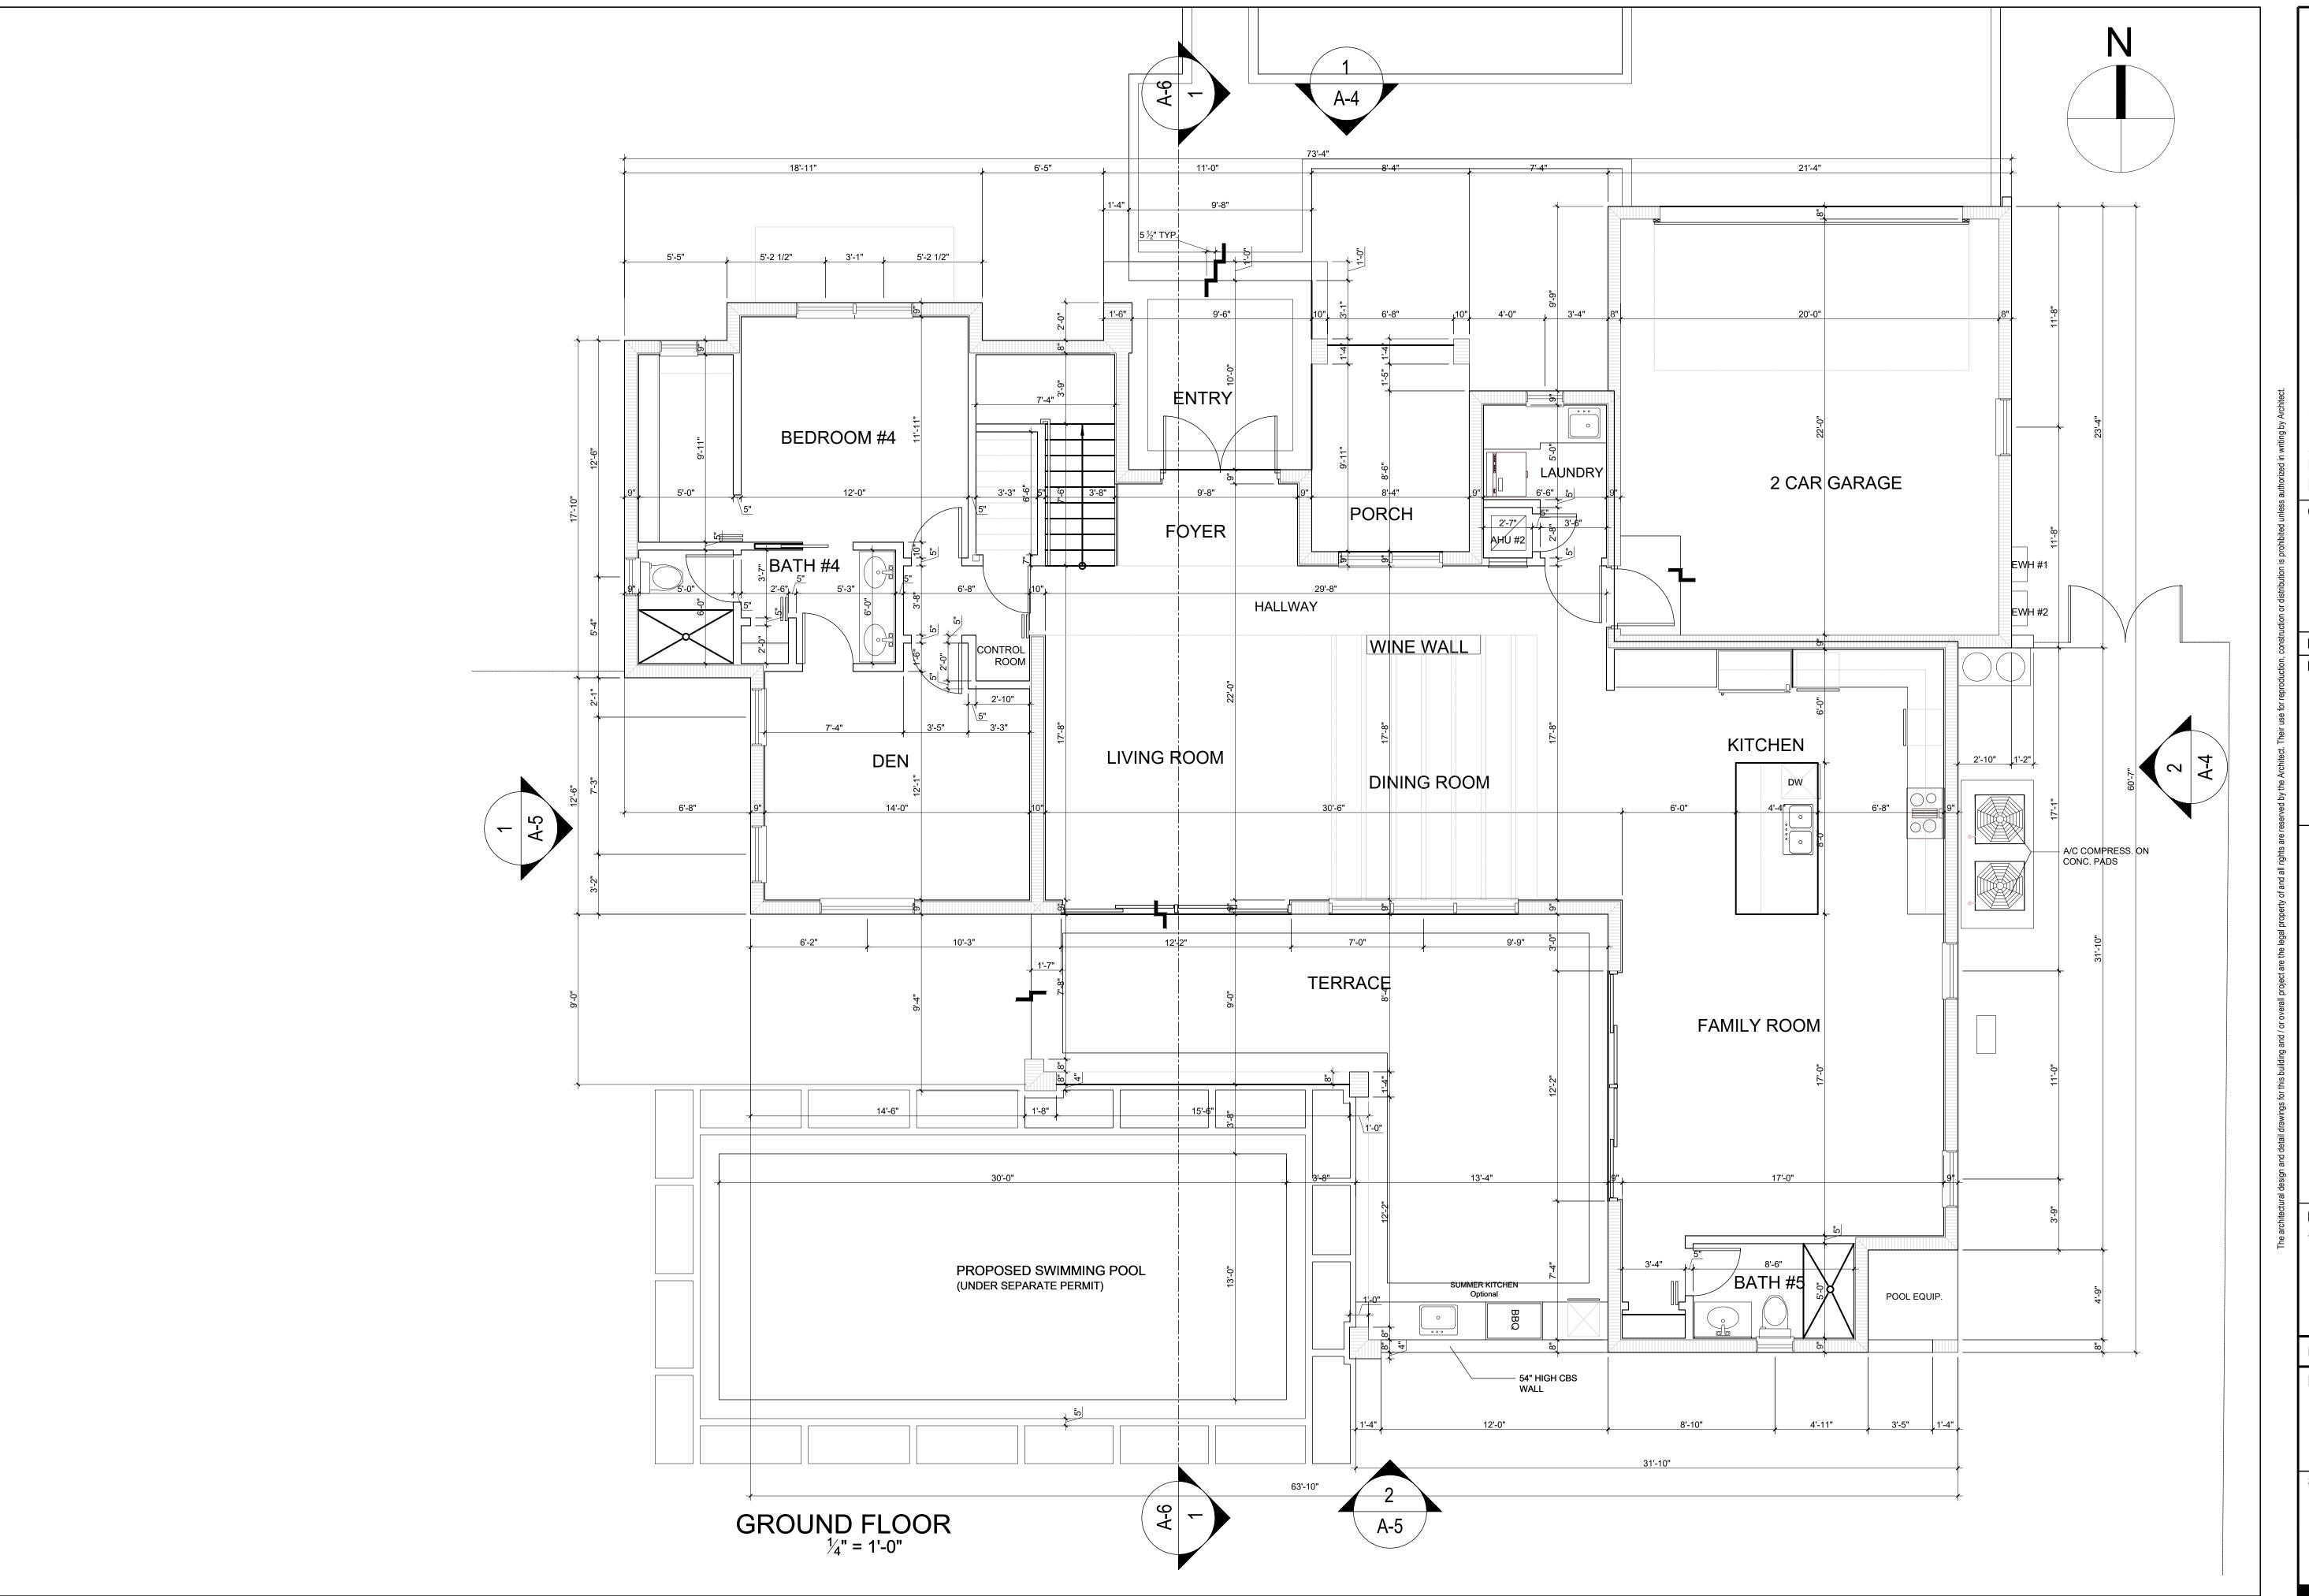

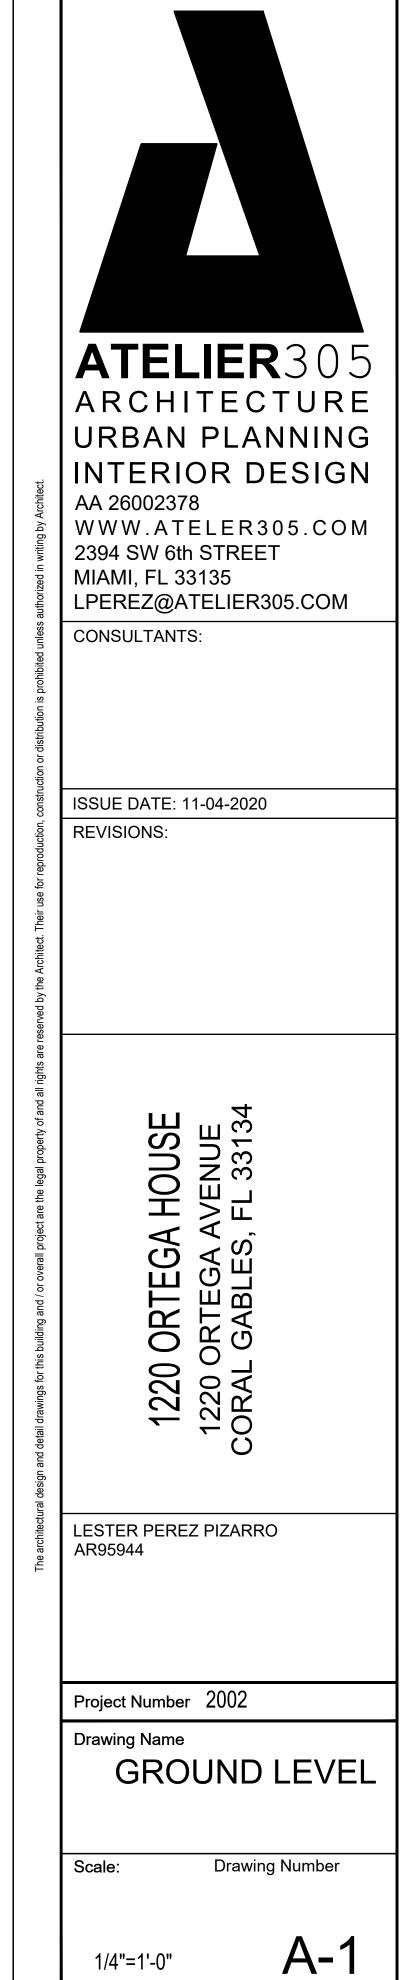

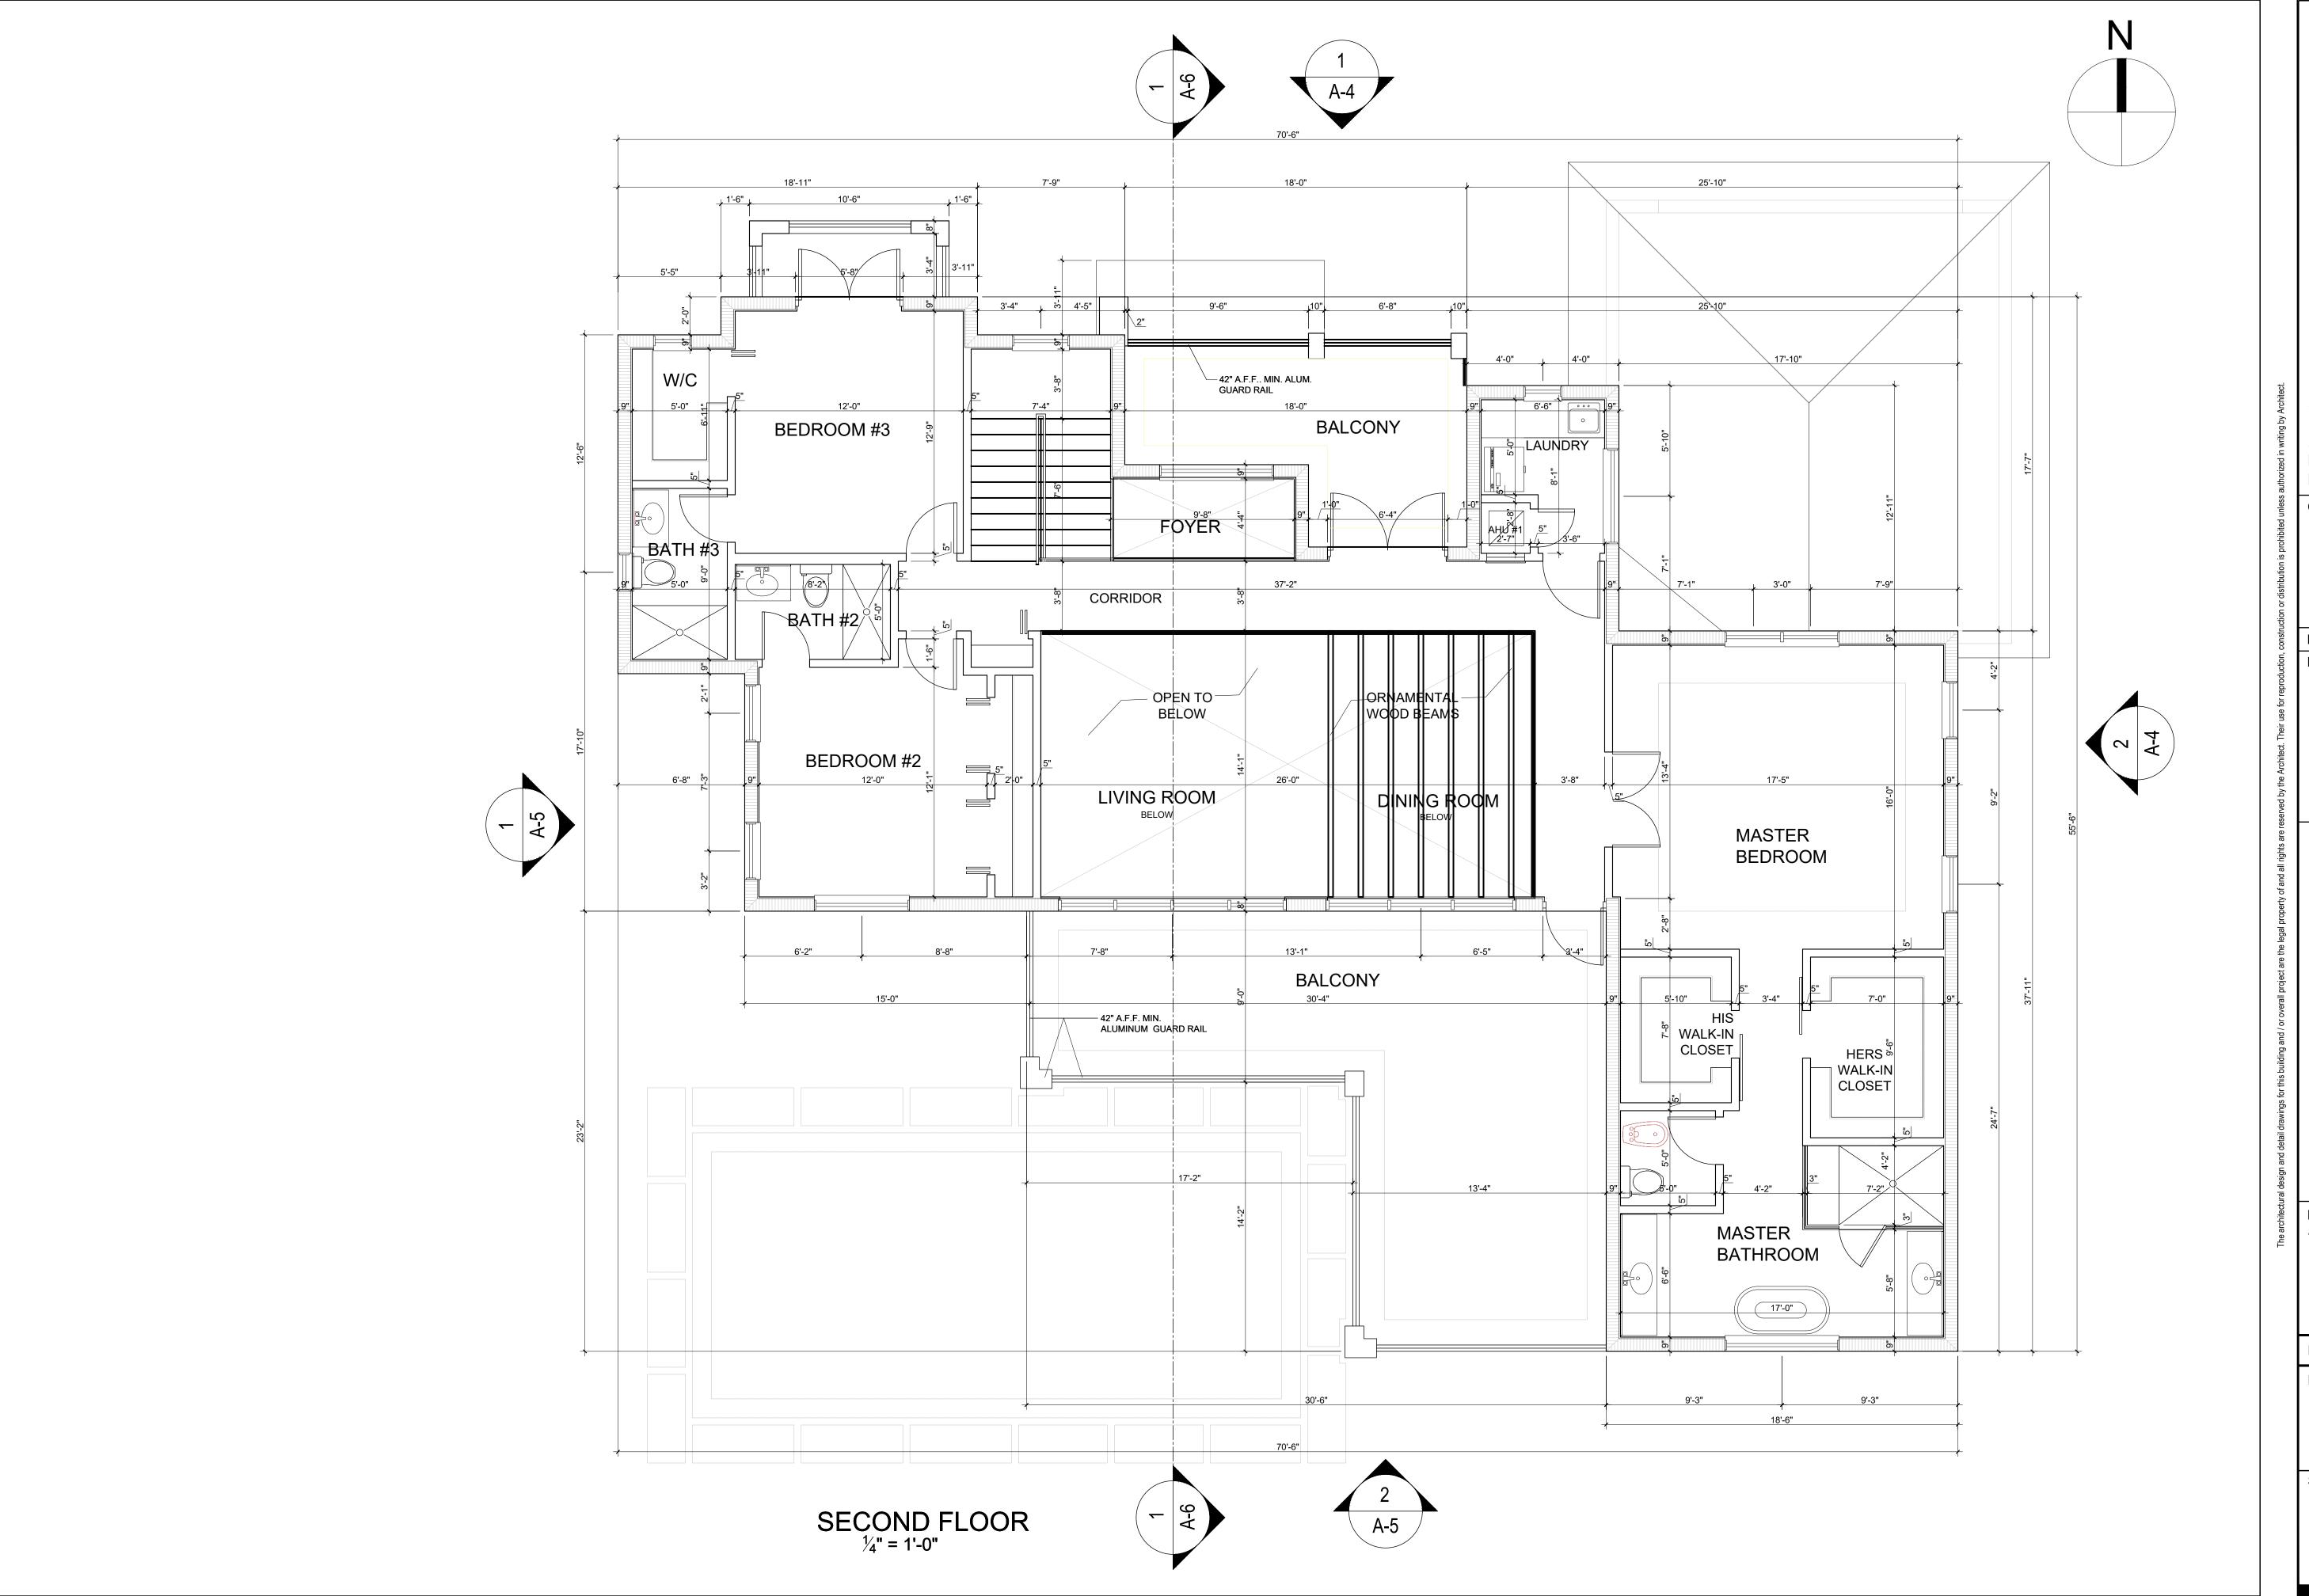

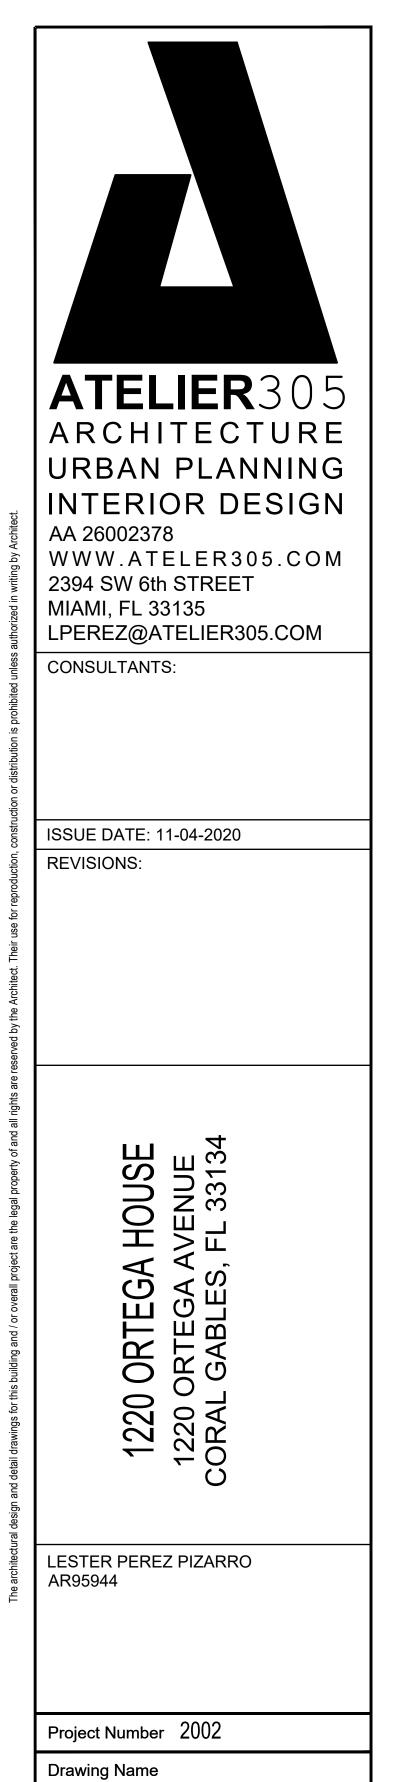



SECOND LEVEL

Scale: Drawing Number


1/4"=1'-0"


A-2

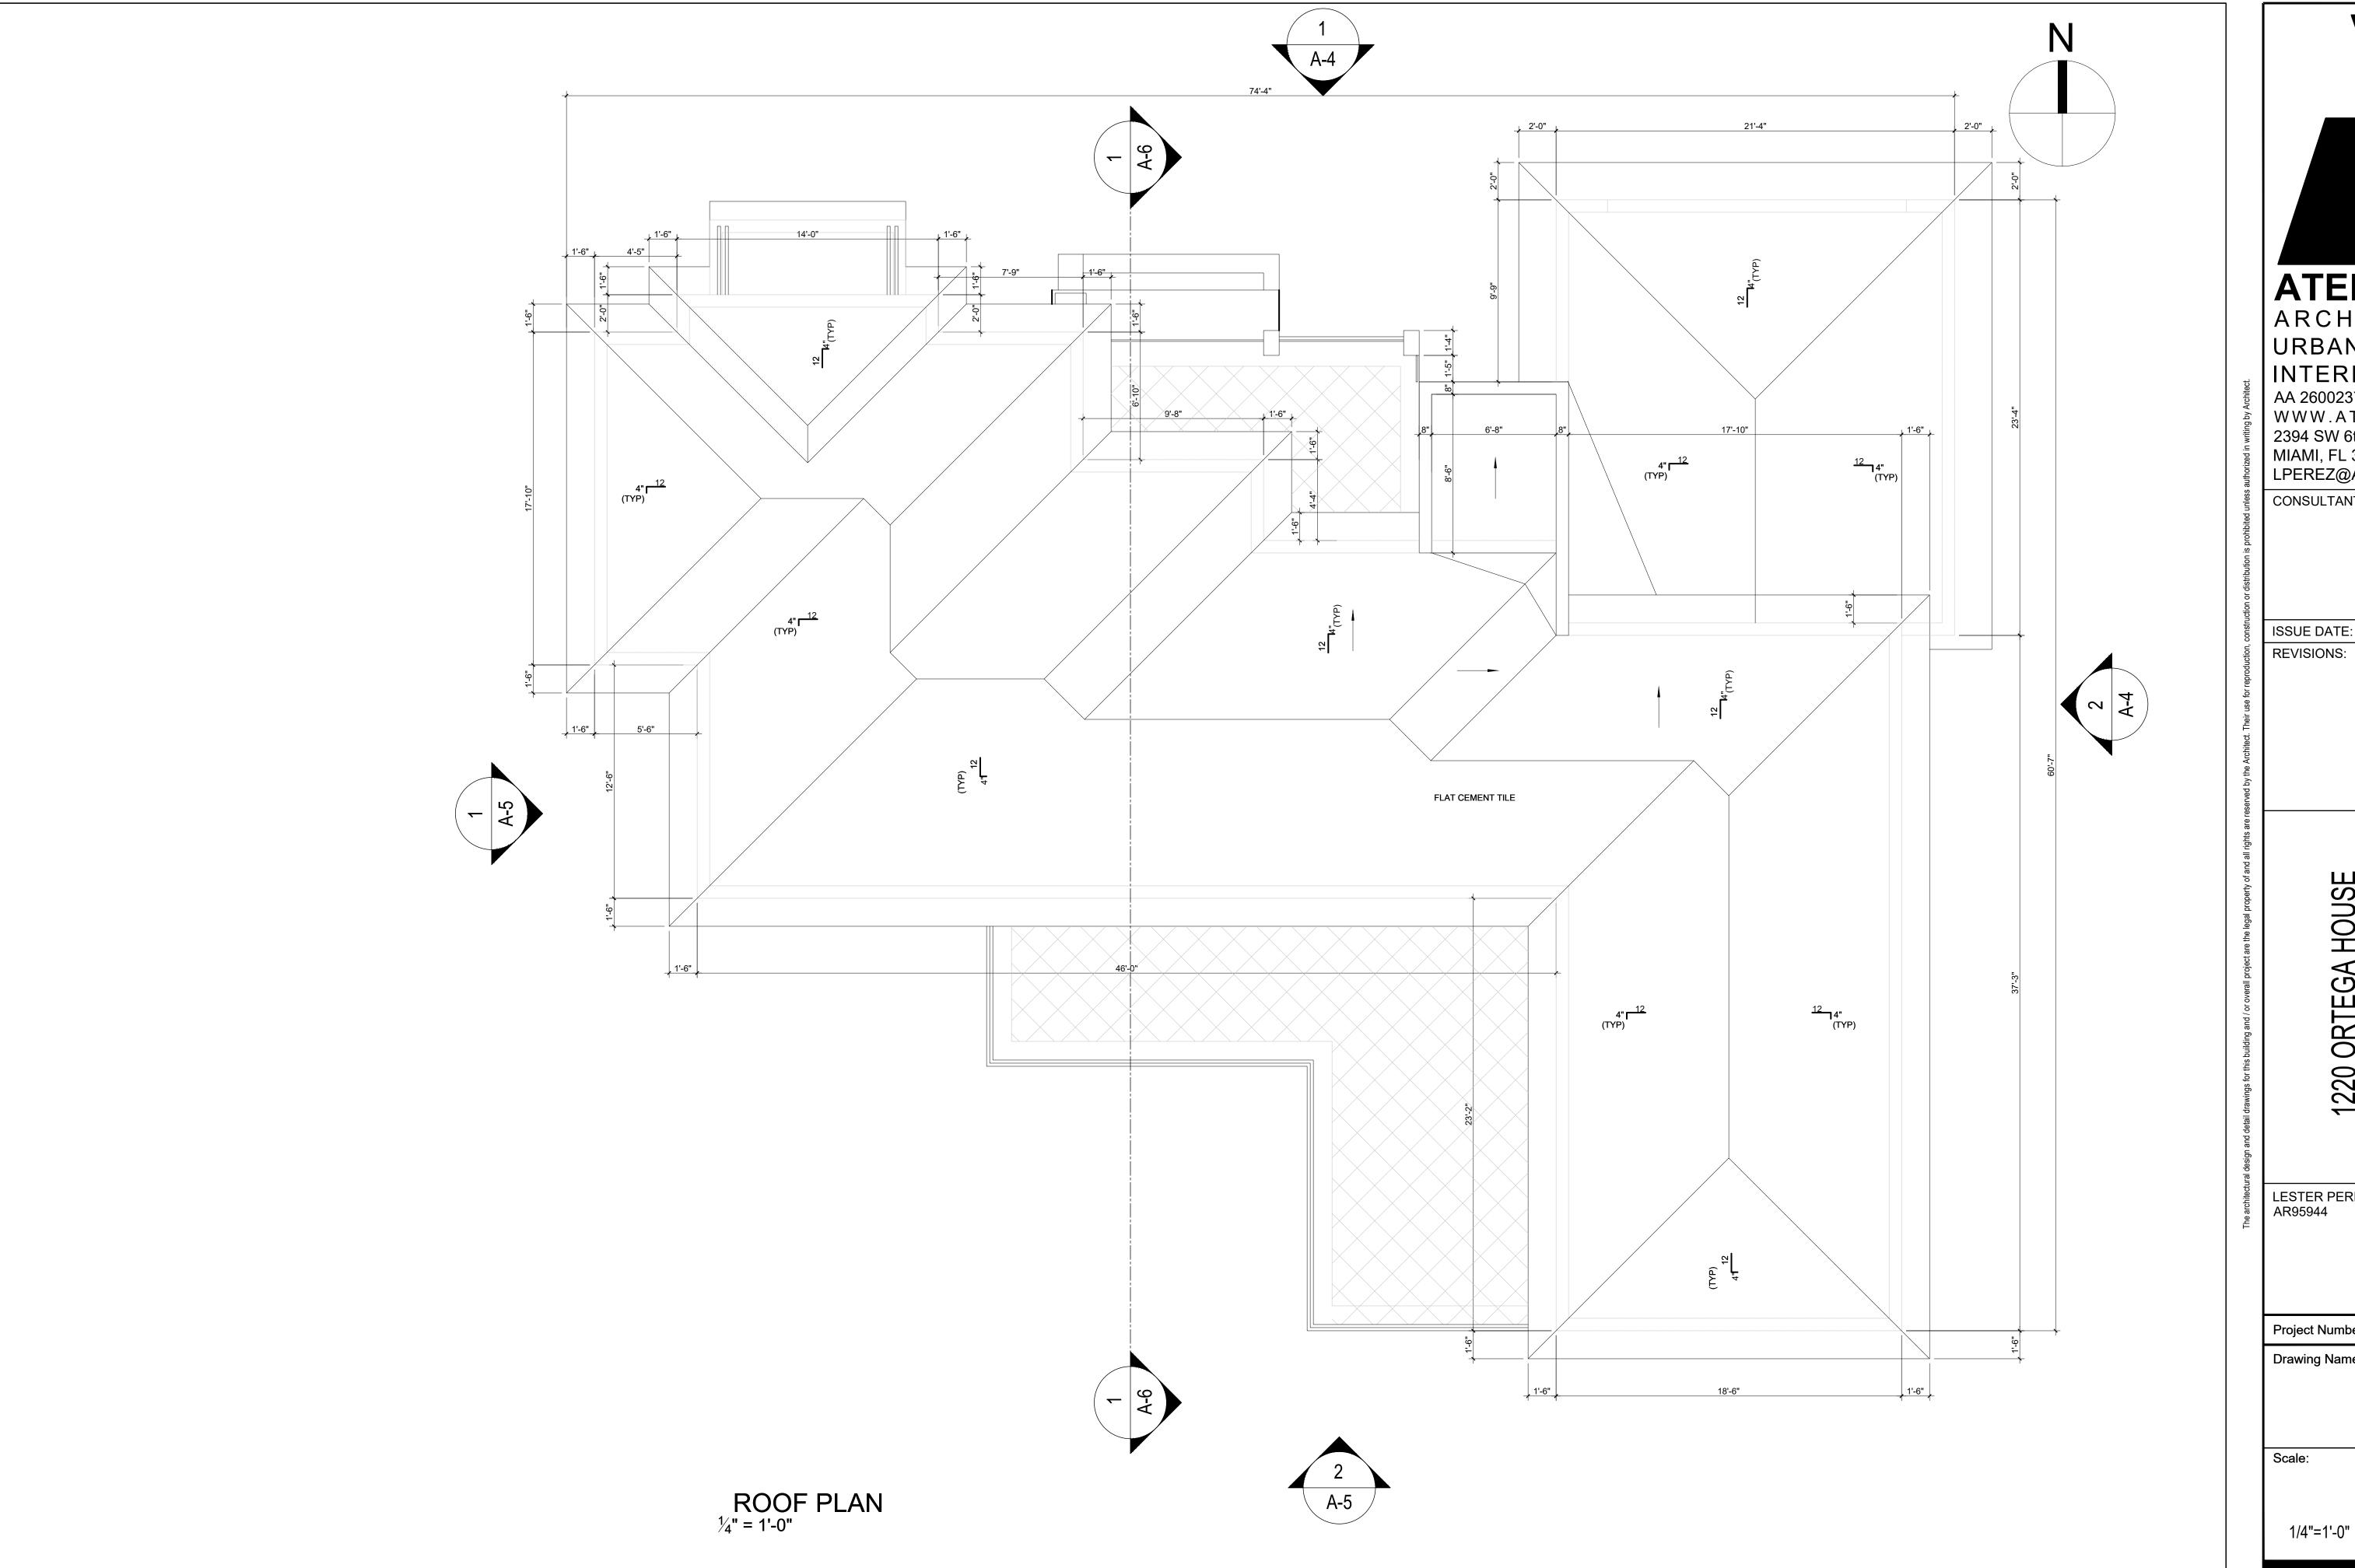

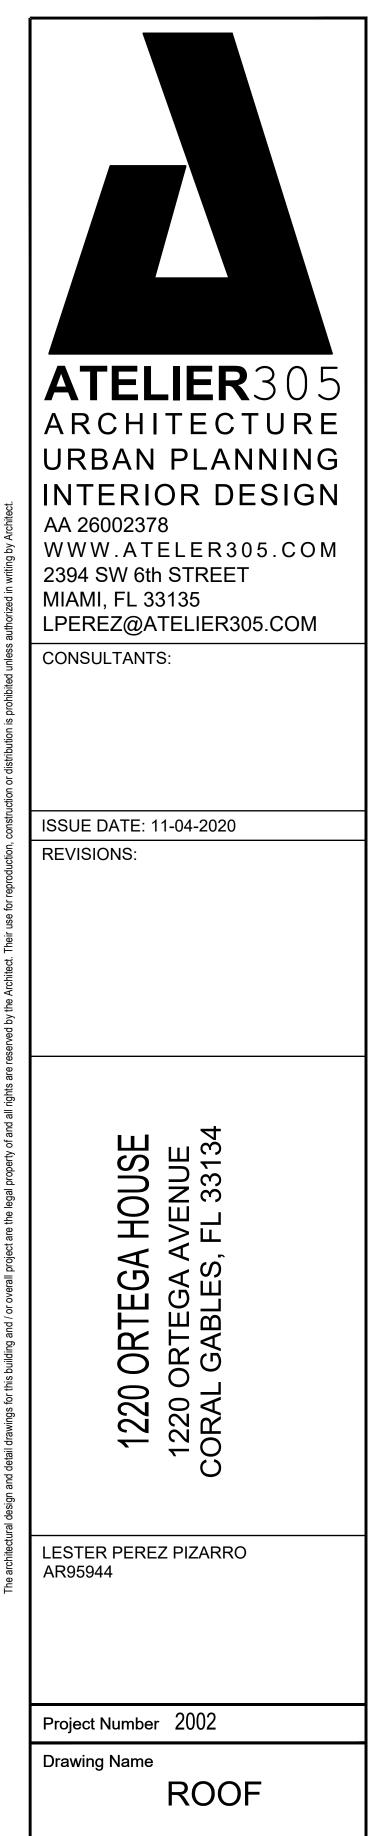

Drawing Number

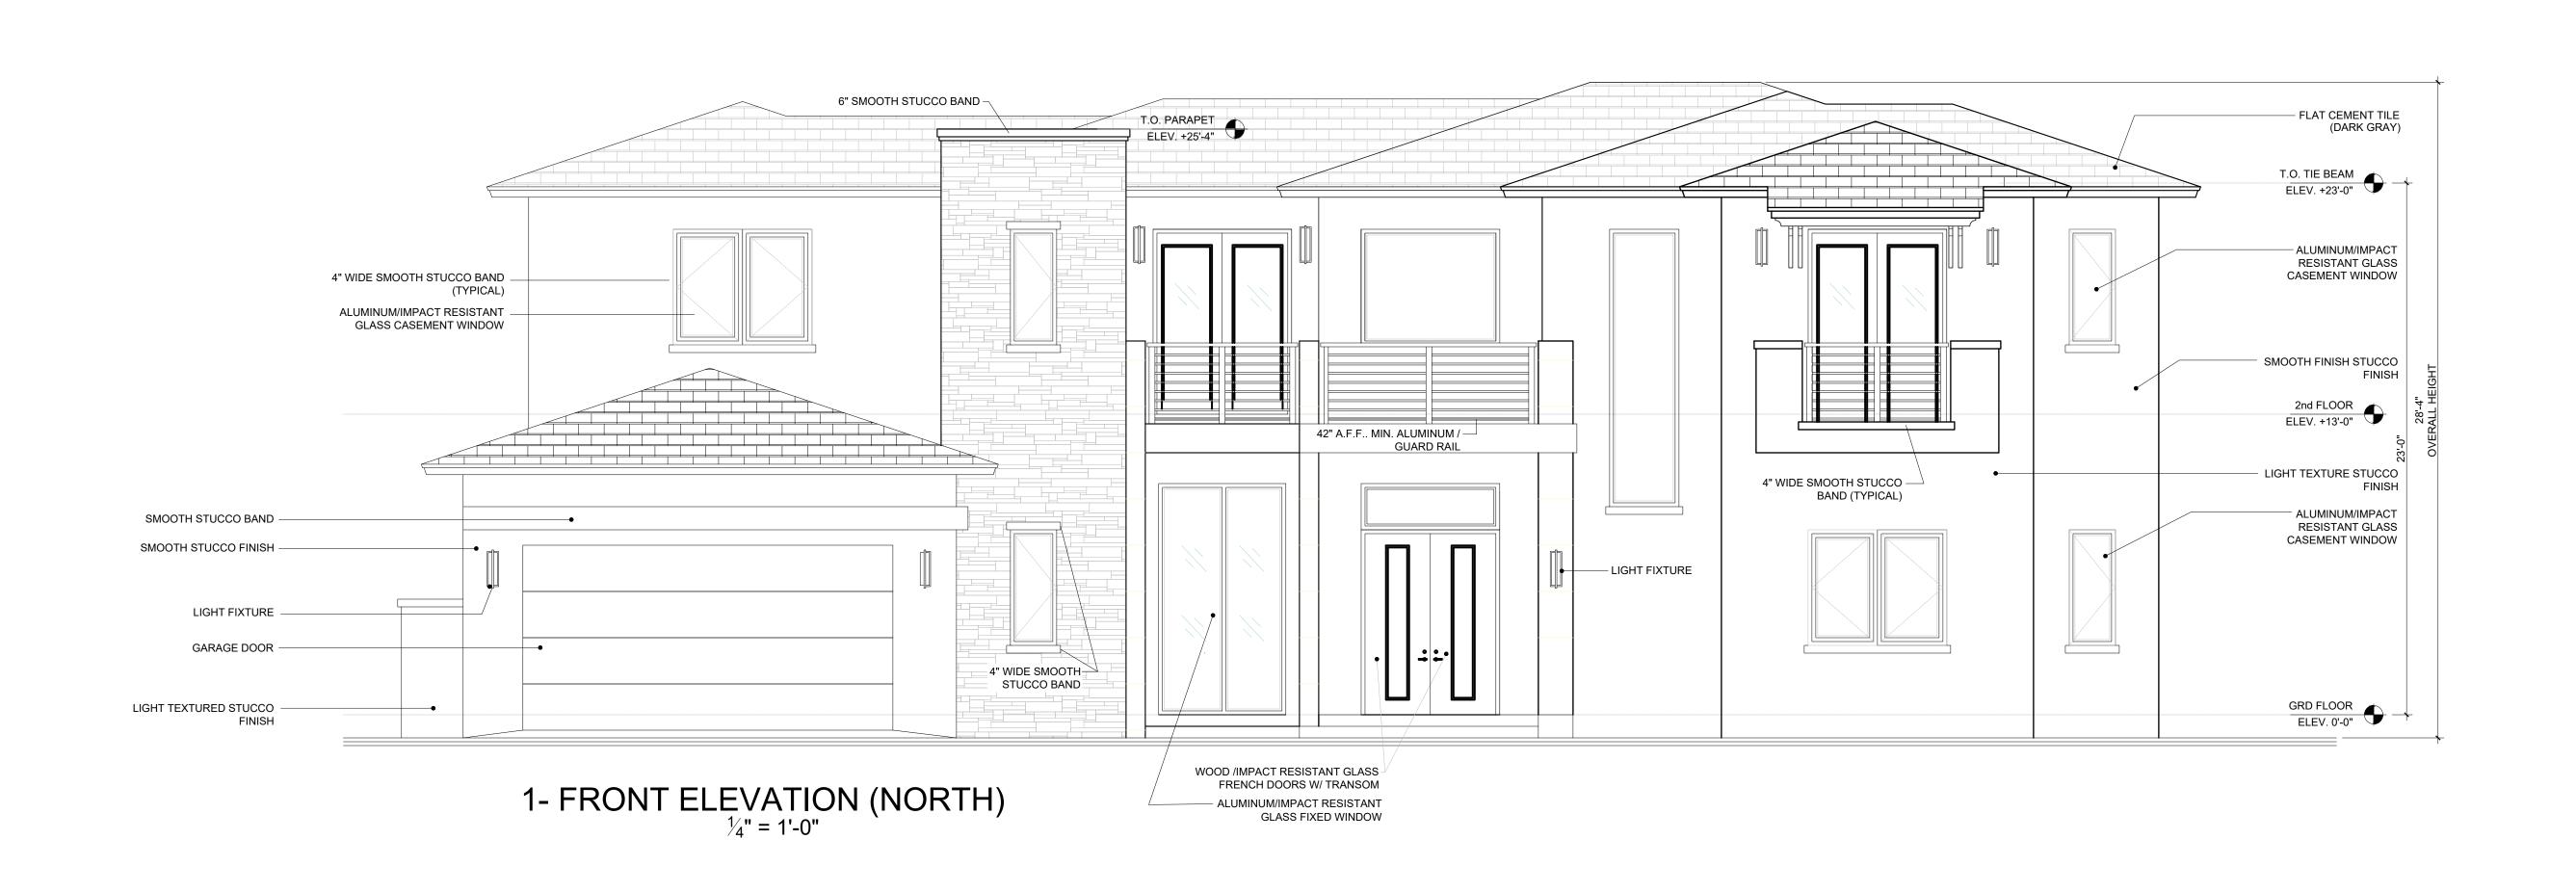

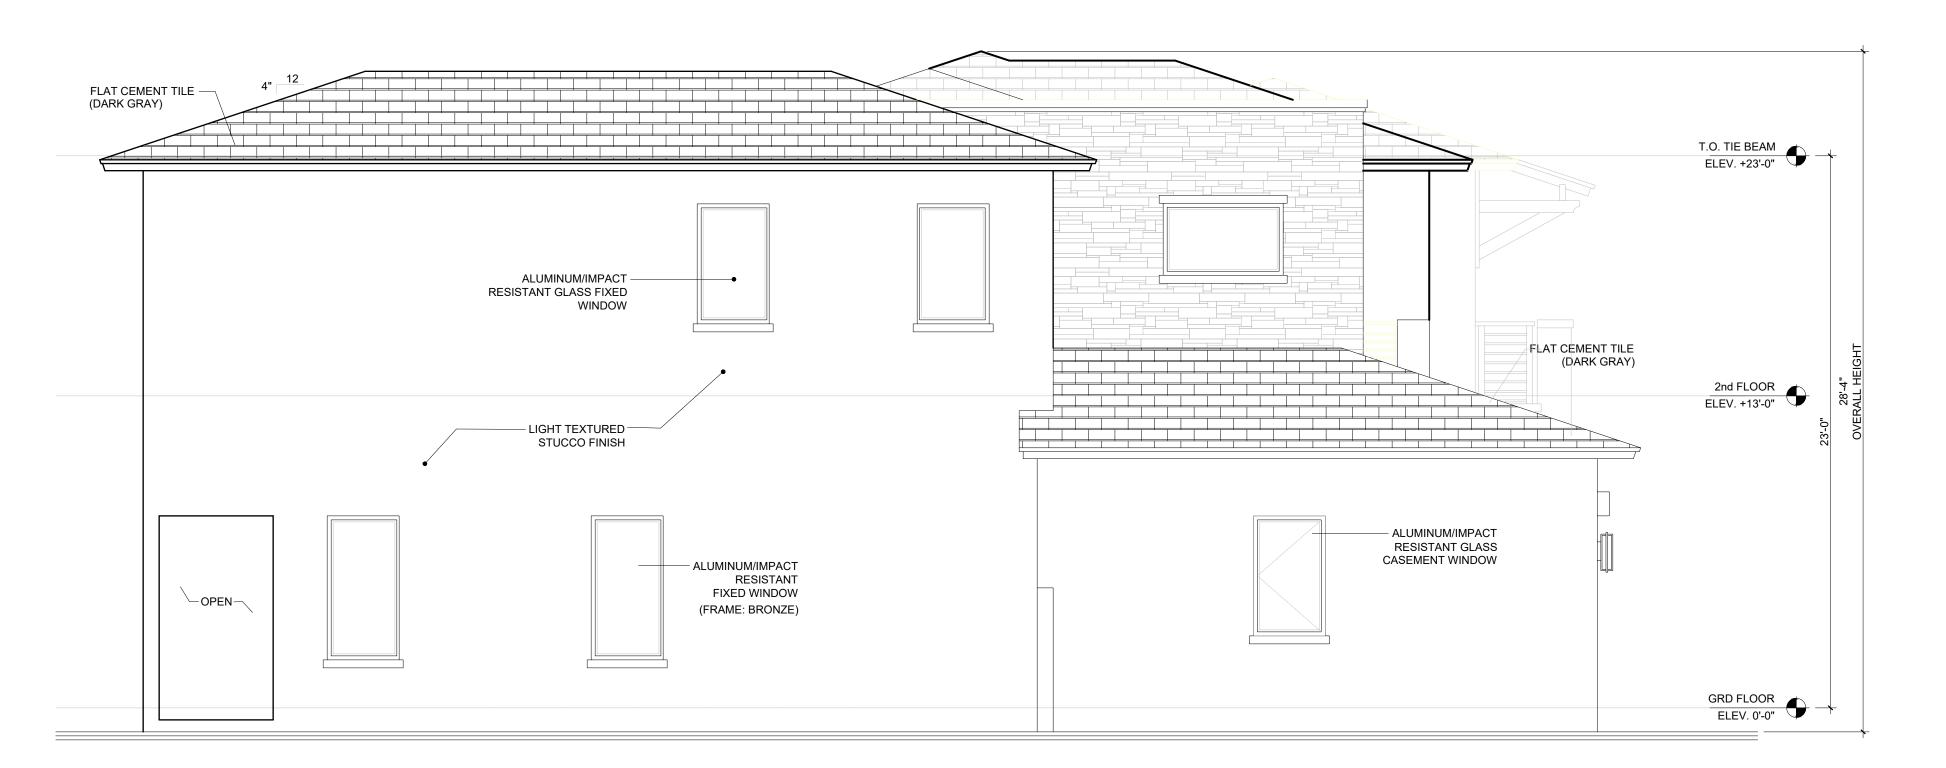

2- SIDE ELEVATION (EAST)

ATELIER 3 0 5
ARCHITECTURE
URBAN PLANNING
INTERIOR DESIGN
AA 26002378
WWW.ATELER 3 0 5 . C O M
2394 SW 6th STREET

LPEREZ@ATELIER305.COM
CONSULTANTS:

MIAMI, FL 33135

ISSUE DATE: 11-04-2020

REVISIONS:

1220 ORTEGA HOUSE 1220 ORTEGA AVENUE CORAL GABLES, FL 33134

LESTER PEREZ PIZARRO AR95944

Project Number 2002


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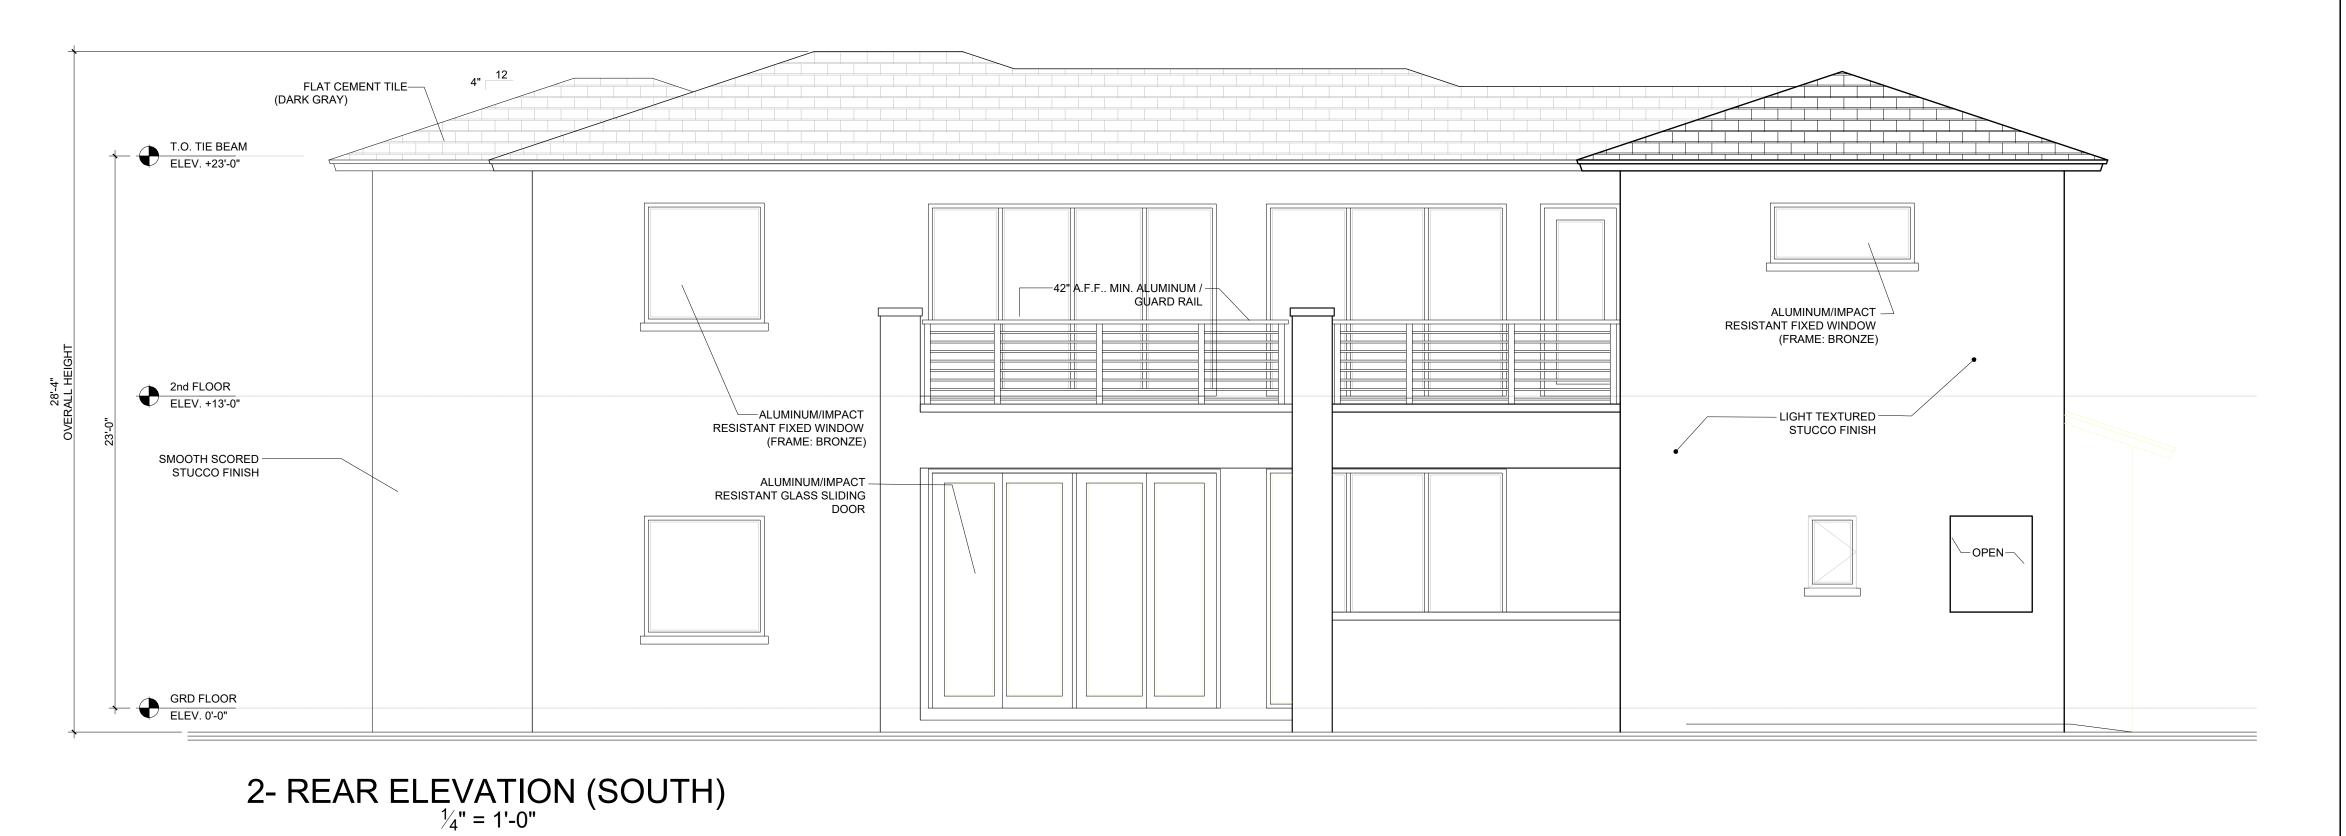
ELEVATIONS

Scale: Drawing Number

1/4"=1'-0"

A-4




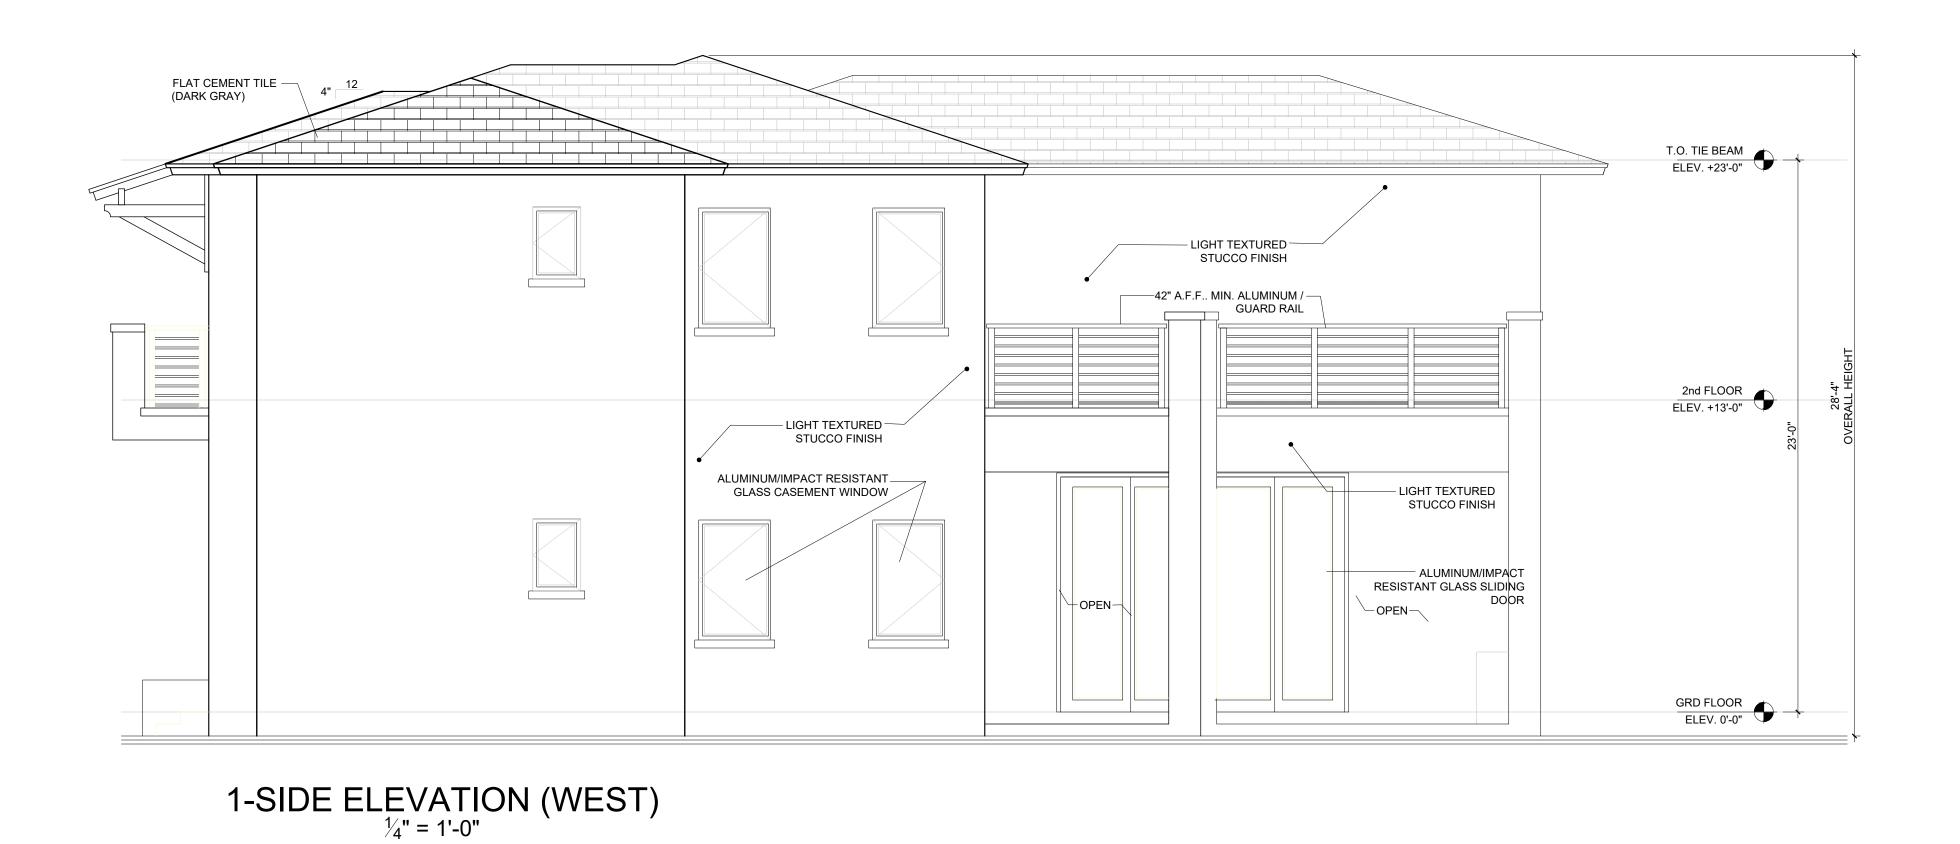


ATELIER305 ARCHITECTURE URBAN PLANNING INTERIOR DESIGN AA 26002378 WWW.ATELER305.COM 2394 SW 6th STREET MIAMI, FL 33135 LPEREZ@ATELIER305.COM CONSULTANTS: ISSUE DATE: 11-04-2020 REVISIONS: 1220 ORTEGA HOUSE 1220 ORTEGA AVENUE CORAL GABLES, FL 33134 LESTER PEREZ PIZARRO AR95944 Project Number 2002 Drawing Name **ELEVATIONS**


Drawing Number

Scale:

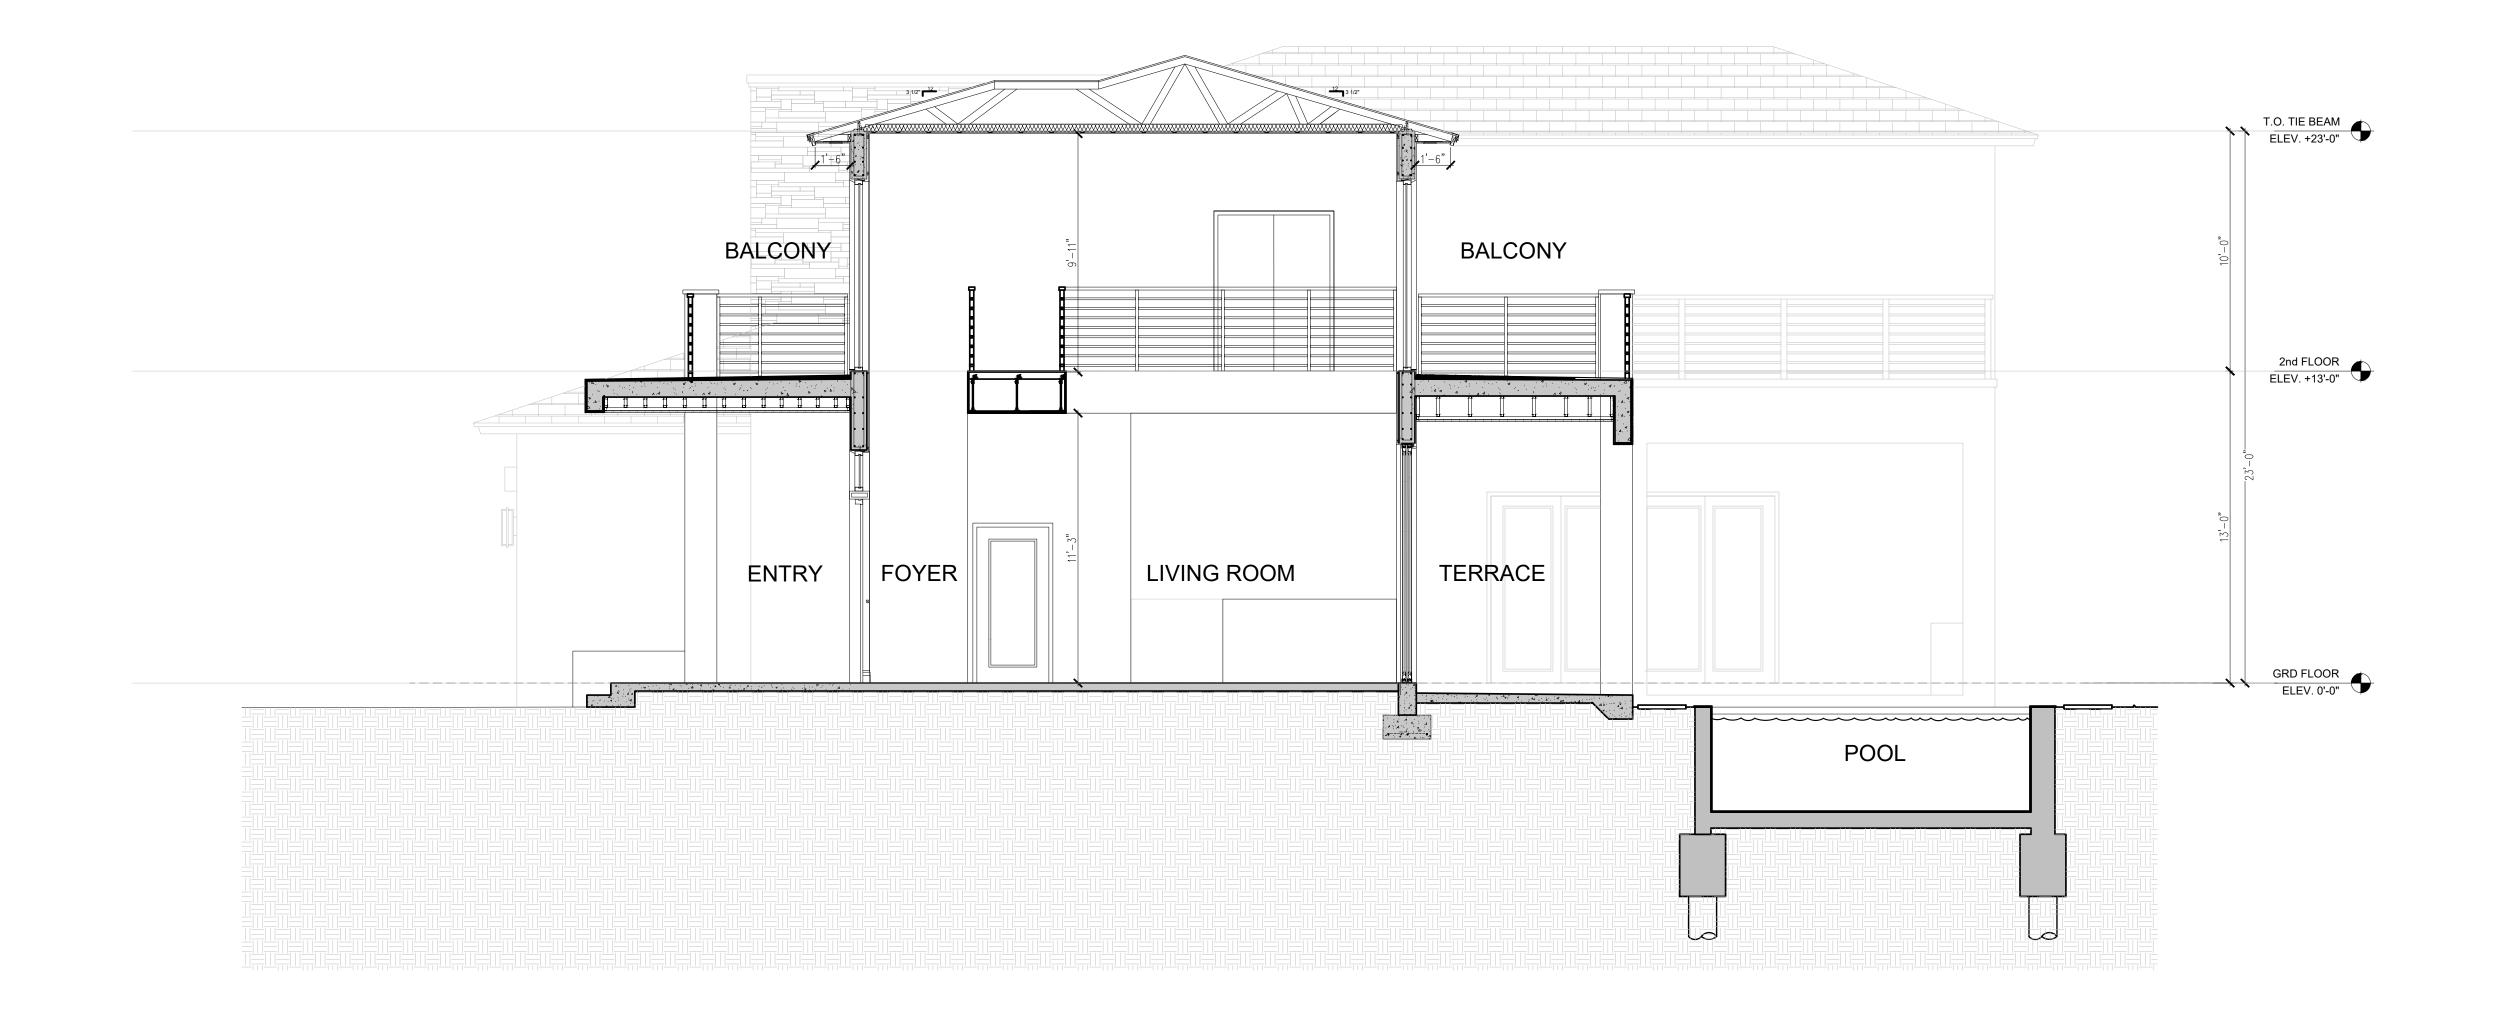

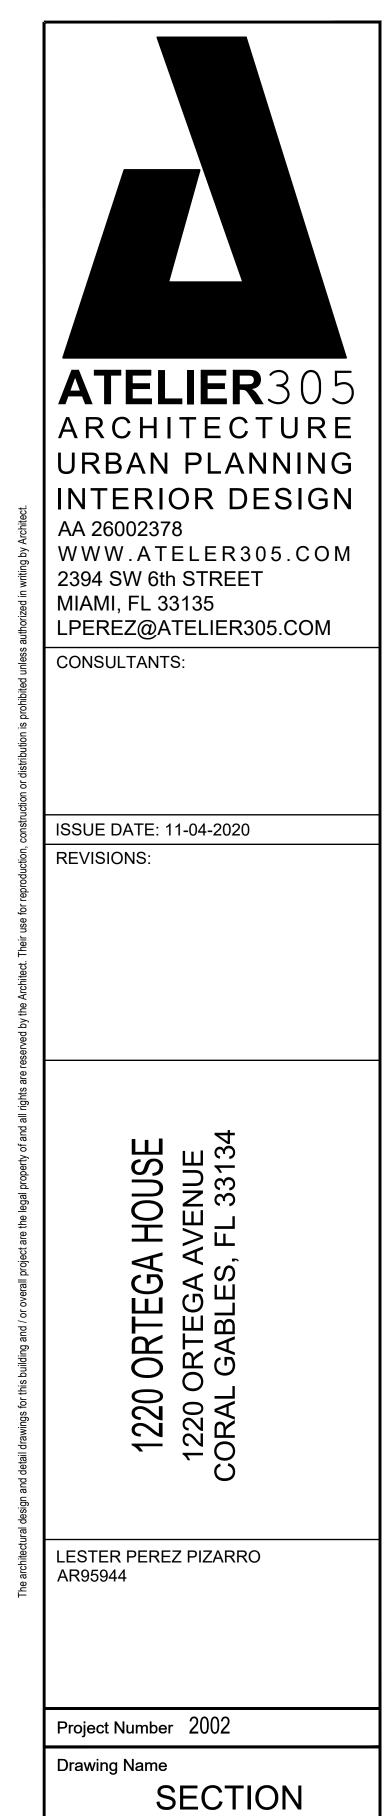

Drawing Number Scale:

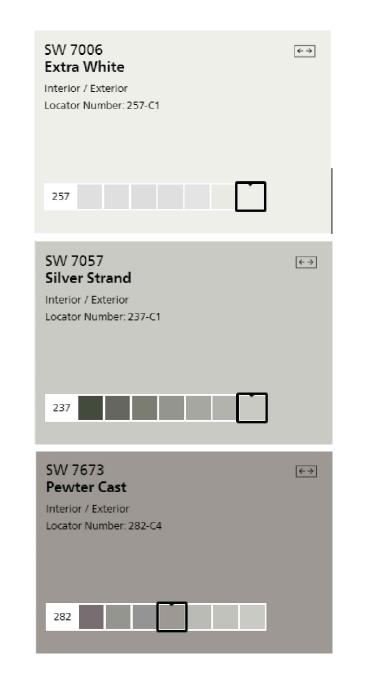

1. SMOOTH STUCCO PAINTED



FRONT ELEVATION (NORTH)

1/4" = 1'-0"



2. ALUMINUM GARAGE DOOR




3. HORIZONTAL ALUMINUM RAILING 42" A.F.F.



4. TRAVERTINE STONE CLADDING




5. CASEMENT ALUMINUM GLASS WINDOW BRONZE FINISH

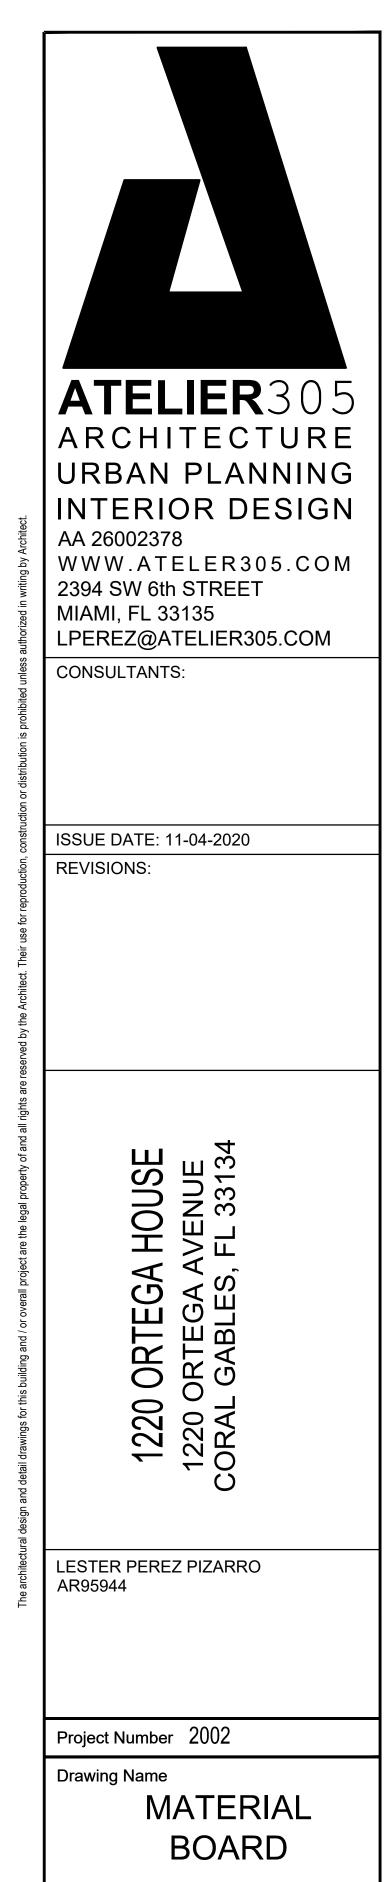


NT ALUMINUM GLASS WINDOW

Scale: Drawing Number

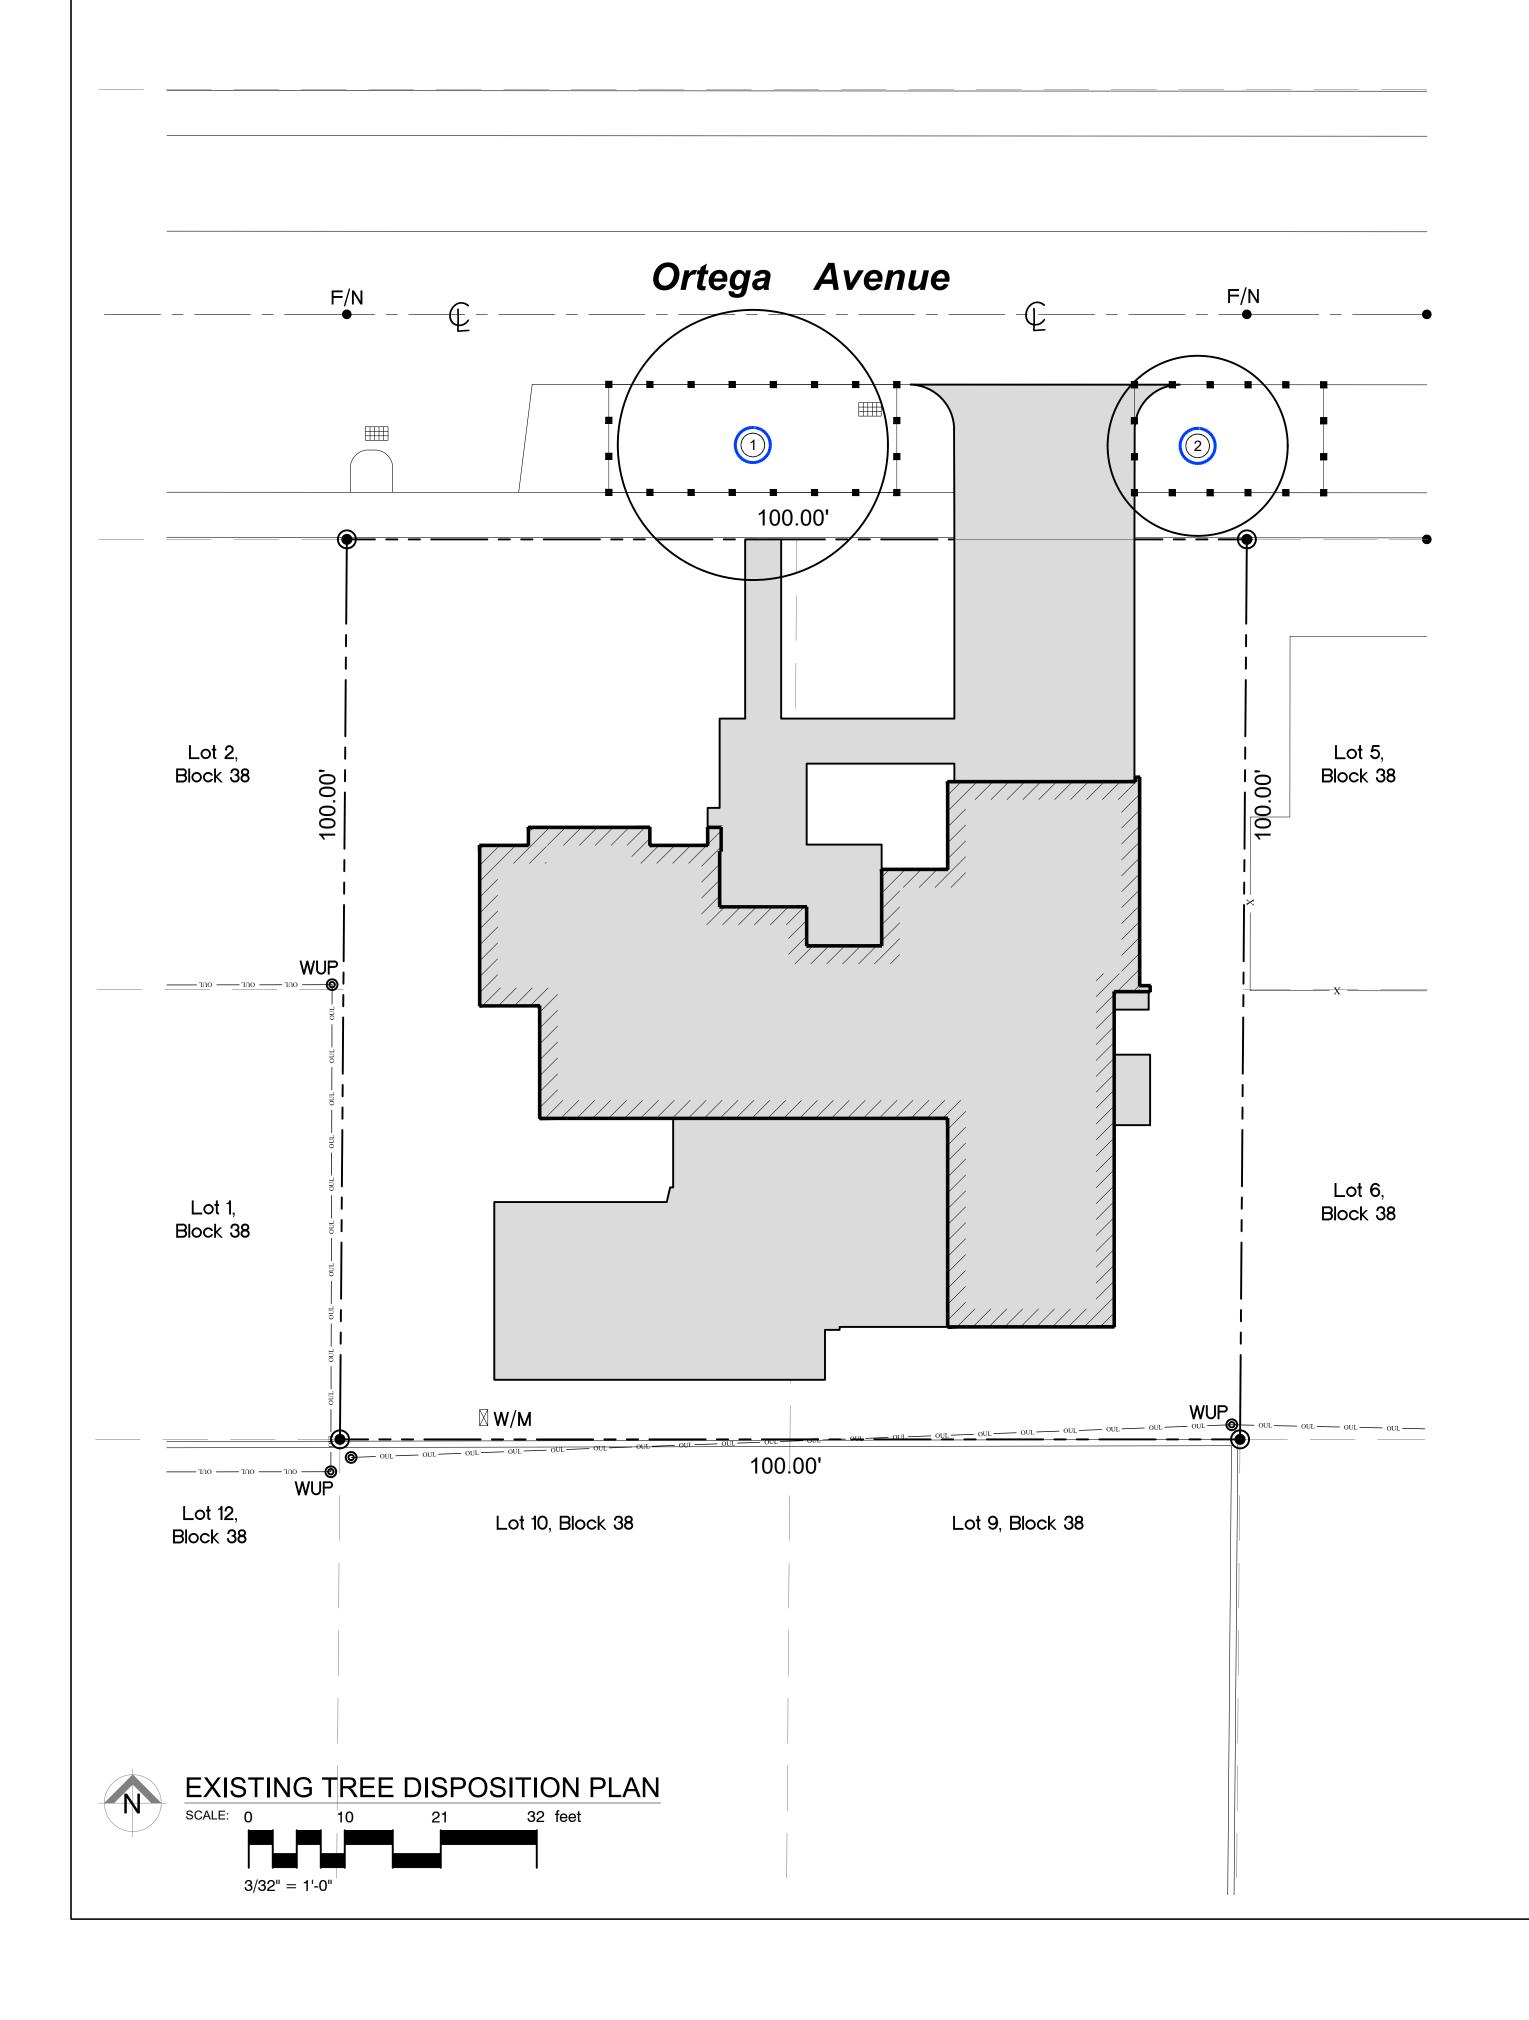


- Before beginning work, the General Contractor and Landscape Contractor is required to meet at the site with the Landscape Architect to review all work procedures, access routes, storage areas, and tree and palm protection measures.
- 2. The General Contractor is required to coordinate with the Landscape Architect to determine the amount of tree canopy or root zone that the General Contractor will be responsible for pruning. The trimming shall be as per the ANSI A-300 Standards.
- 3. The General Contractor shall erect fences to protect trees or palms to be preserved as per Tree Protection Detail 05/L-101 and Tree Disposition Plan L-100. Fences define a specific protection zone for each tree or to be protected. Fences are to remain until all site work has been completed. Fences may not be relocated or removed without the written permission of
- the Landscape Architect. 4. Construction trailers, traffic and storage areas must remain outside fenced areas at all times. 5. All underground utilities and drain or irrigation lines shall be routed outside the tree or palm
- protection zone. If lines must traverse the protection area, they shall be tunneled or bored 6. No construction materials, equipment, spoil, or waste or washout water may be deposited,
- stored, or parked within the tree or palm protection zone (fenced area). 7. Additional tree pruning required for clearance during construction shall be trimmed as per
- ANSI A-300 Standards and not by construction personnel. 8. Any herbicides placed under paving materials must be safe for use around trees and labeled for that use. Any pesticides used on site must be tree-safe and not easily transported by
- 9. If injury should occur to any tree during construction, the General Contractor is responsible for notifying the Landscape Architect as soon as possible for evaluation so that appropriate
- treatments can be applied. 10. The General Contractor shall notify the Landscape Architect of any grading, construction, demolition, or other work that is expected to encounter tree or palm roots.
- 11. All trees to remain on site shall be irrigated three times a week for the duration of construction. At each irrigation procedure shall apply to the soil area within the tree or palm protection zone 2-3 gallons of water per inch of trunk caliper.
- 12. Erosion control devices such as silt fencing, debris basins, and water diversion structures shall be installed to prevent siltation and/or erosion within the tree and palm protection zone.
- 13. Before grading, pad preparation, or excavation for foundations, footings, walls, or trenching near trees the trees shall be root pruned 12 inches outside the tree protection zone by cutting all roots cleanly to a depth of 36 inches. Roots shall be cut manually by digging a trench and cutting exposed roots with a saw, vibrating knife, rock saw, narrow trencher with sharp blades, or other approved root-pruning equipment.
- 14. Any roots damaged during grading or construction shall be exposed to sound tissue and cut
- 15. If temporary haul or access roads must pass over the root area of trees to be retained, a road bed of 6 inches of mulch or gravel shall be created to protect the soil. The road bed material shall be replenished as necessary to maintain a 6-inch depth.
- 16. Spoil from trenches, basements, or other excavations shall not be placed within the tree protection zone, either temporarily or permanently.
- 17. No burn piles or debris pits shall be placed within the tree protection zone. No ashes, debris, or garbage may be dumped or buried within the tree protection zone.
- 18. Maintain fire-safe areas around fenced areas. Also, no heat sources, flames, ignition sources, or smoking is allowed near mulch or trees.


TREE PROTECTION NOTES

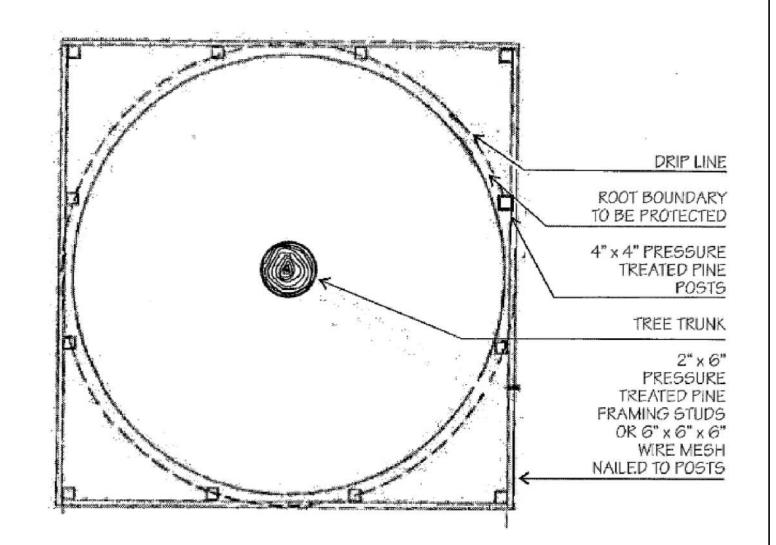

IT IS CRITICAL TO EXISTING TREE SURVIVAL TO PROVIDE PROTECTION DURING CONSTRUCTION. THIS DETAIL CAN BE USED AROUND ONE OR MORE TREES AND WILL PROVIDE PROTECTION FROM CONSTRUCTION EQUIPMENT.

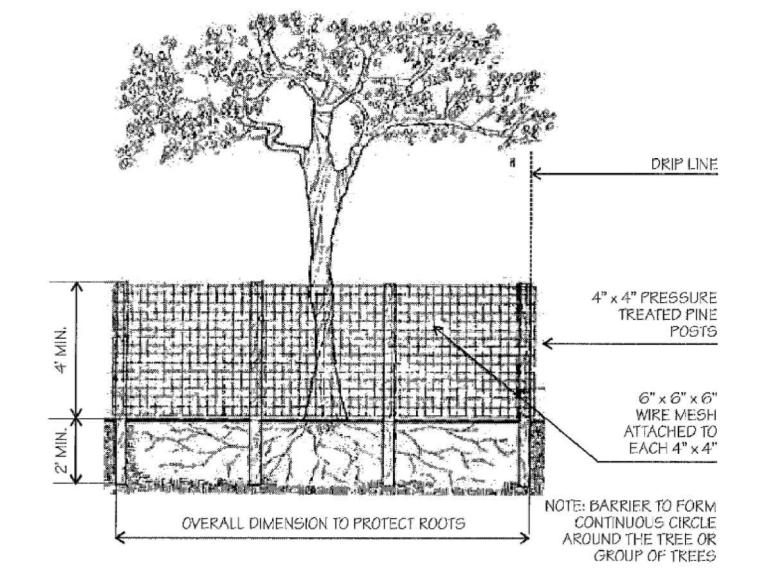

No.	BOTANICAL NAME	COMMON NAME	HEIGHT (FT)	SPREAD (FT)	DIAMETER DBH (IN)	TREE CANOPY (SQ.FT)	TREE PROTECTION ZONE (TPZ) / (FT)	COND	ACTION
1	Bucida buceras 'Shady Lady'	Black Olive	40	30	24	707	16	Good	Remain
2	Bucida buceras 'Shady Lady'	Black Olive	30	20	20	314	14	Good	Remain

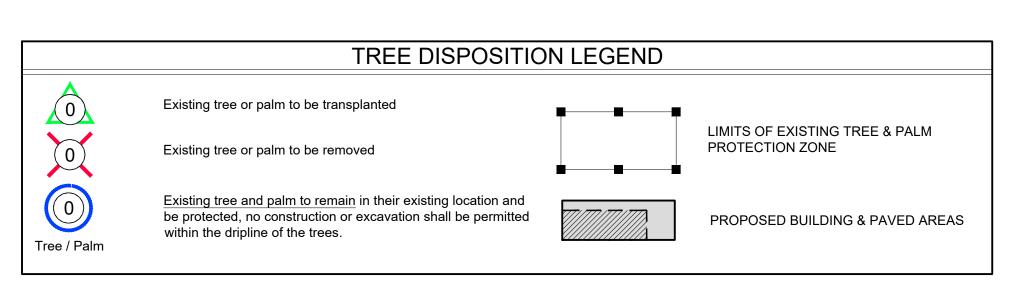



AA 26002378 WWW.ATELER305.COM 2394 SW 6th STREET MIAMI, FL 33135 LPEREZ@ATELIER305.COM



REVISIONS:

1220 ORTEGA HOUSE 1220 ORTEGA AVENUE SORAL GABLES, FL 33134

LESTER PEREZ PIZARRO AR95944


Project Number 2002

Drawing Name

EXISTING TREE DISPOSITION PLAN

Drawing Number

3/32"=1'-0"

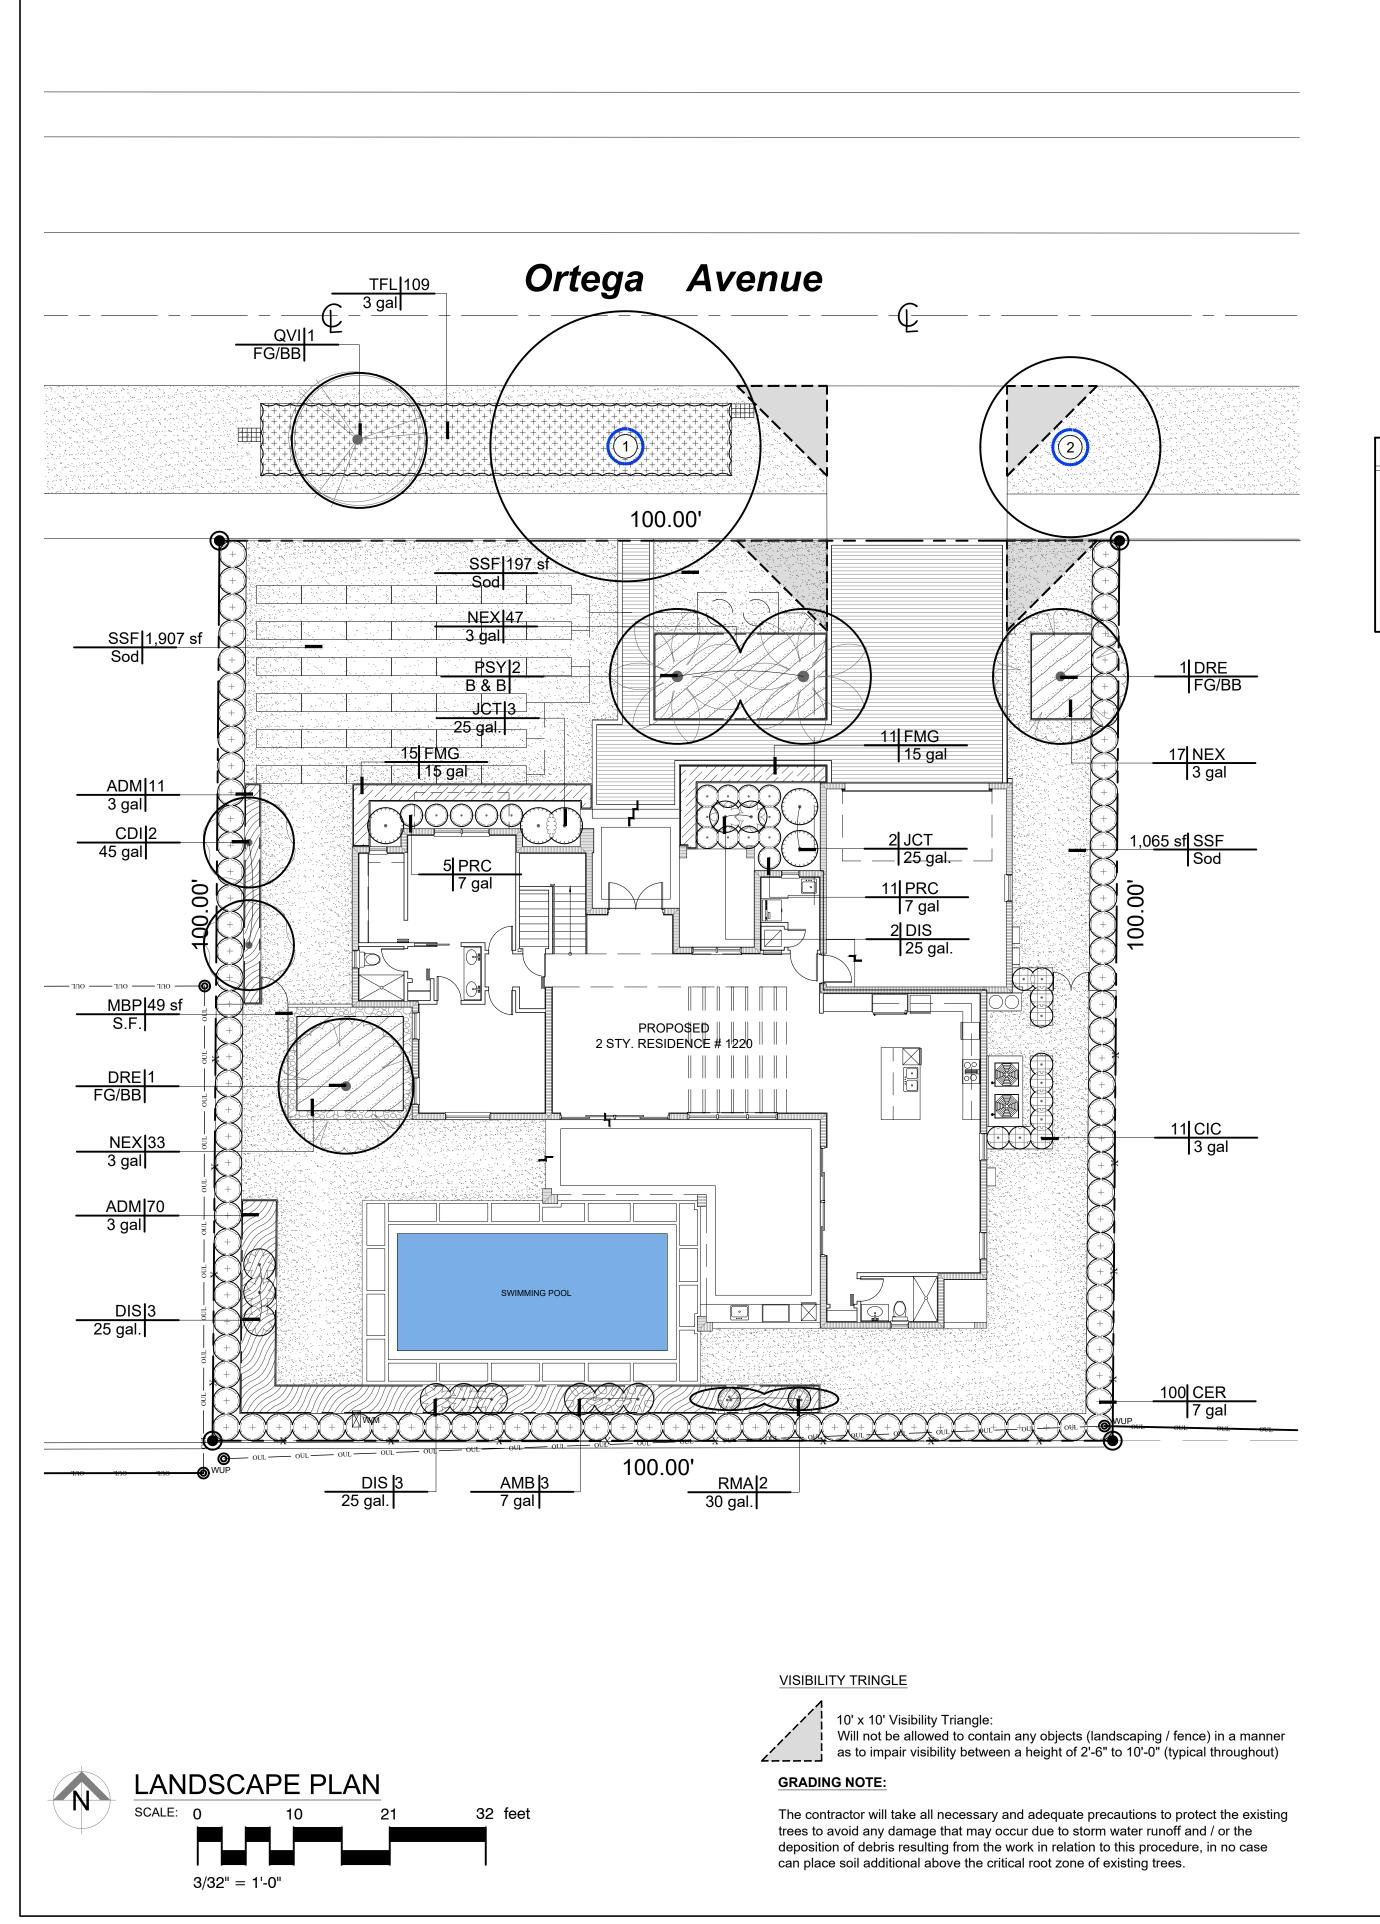





The Existing trees or palms transplanted, new location The Existing trees and palms that remained in their original location Tree / Palm

	Mia	mi-Dade County	Ordinance	•
RIGHT-OF-WAY PLA	ANTING			
MINIMUM NUMBE	R OF TREES (16' OA / 3.5" Cal.)			-
Shall be provided alo	ong all roadways at a maximum aver	age spacing of thin	ty (35') feet on center	
74	ys: 100 feet / 35 feet = 2.8			
Street Trees Require				
Street Trees Provide	d: 3 (2 existing + 1 proposed)			
MINIMUM NUMBE				
	Number of Shrubs (1) per linear foot of the (ROW)	30% Natives	50 %Low Maintenance & Drought Tolerant	80% Listed in the Miami-Dade Landscape Manual
REQUIRED	100	30	50	80
PROVIDED	109	109	109	109
LOT PLANTING				
The minimum number	er of required trees, in addition to str	eet trees		
Large Shade Trees	s Required: 2 Large Shade	e Trees Provided:	2	
(1) Large Shade Tree	e (12' OA x 2" Cal.) for each 5,000 s	f (10,000 s.f. 5,0	000) = 2	
			hade Trees Provided: 4	
(2) Palm and Mediur	m Shade Tree (10' OA x 1.5" Cal.) fo	r each 5,000 s.f. (1	0,000 s.f. 5,000) = 4	
	esidence Required: 2		Provided: 3	
MINIMUM NUMBE	R OF SHRUBS			
	Number of Shrubs: (15) for each 5,000 s.f.	30% Natives	50 %Low Maintenance & Drought Tolerant	80% Listed in the Miami-Dade Landscape Manual
REQUIRED	30	9	15	24
PROVIDED	145	111	111	111
Shrubs (66% of the	required) in Front of Residence	Required: 20	Provided: 60	
	maximum of sixty 60% of the to		000 s.f. x 60% = Allowed 6,0	00 s.f. Provided: 3,169 s.f.
	SPACE CALCULATION			
Required:	4,000 s.f.			
40% of lot area: Lo	t area (10.000 s.f. x 40% = 4,000 s	s.f.)		
Provided:	5,230 s.f.			
(Landscape s.f. Brea	akdown)			
	rd 20% min. of 40% Total	2,853	s.f.	
Landscape Backyar		2,377	s.f.	

CITY OF CORAL GABLES (Z. DISTRICT SFR) LANDSCAPE ORDINANCE (REQUIRED VS. PROVIDED)

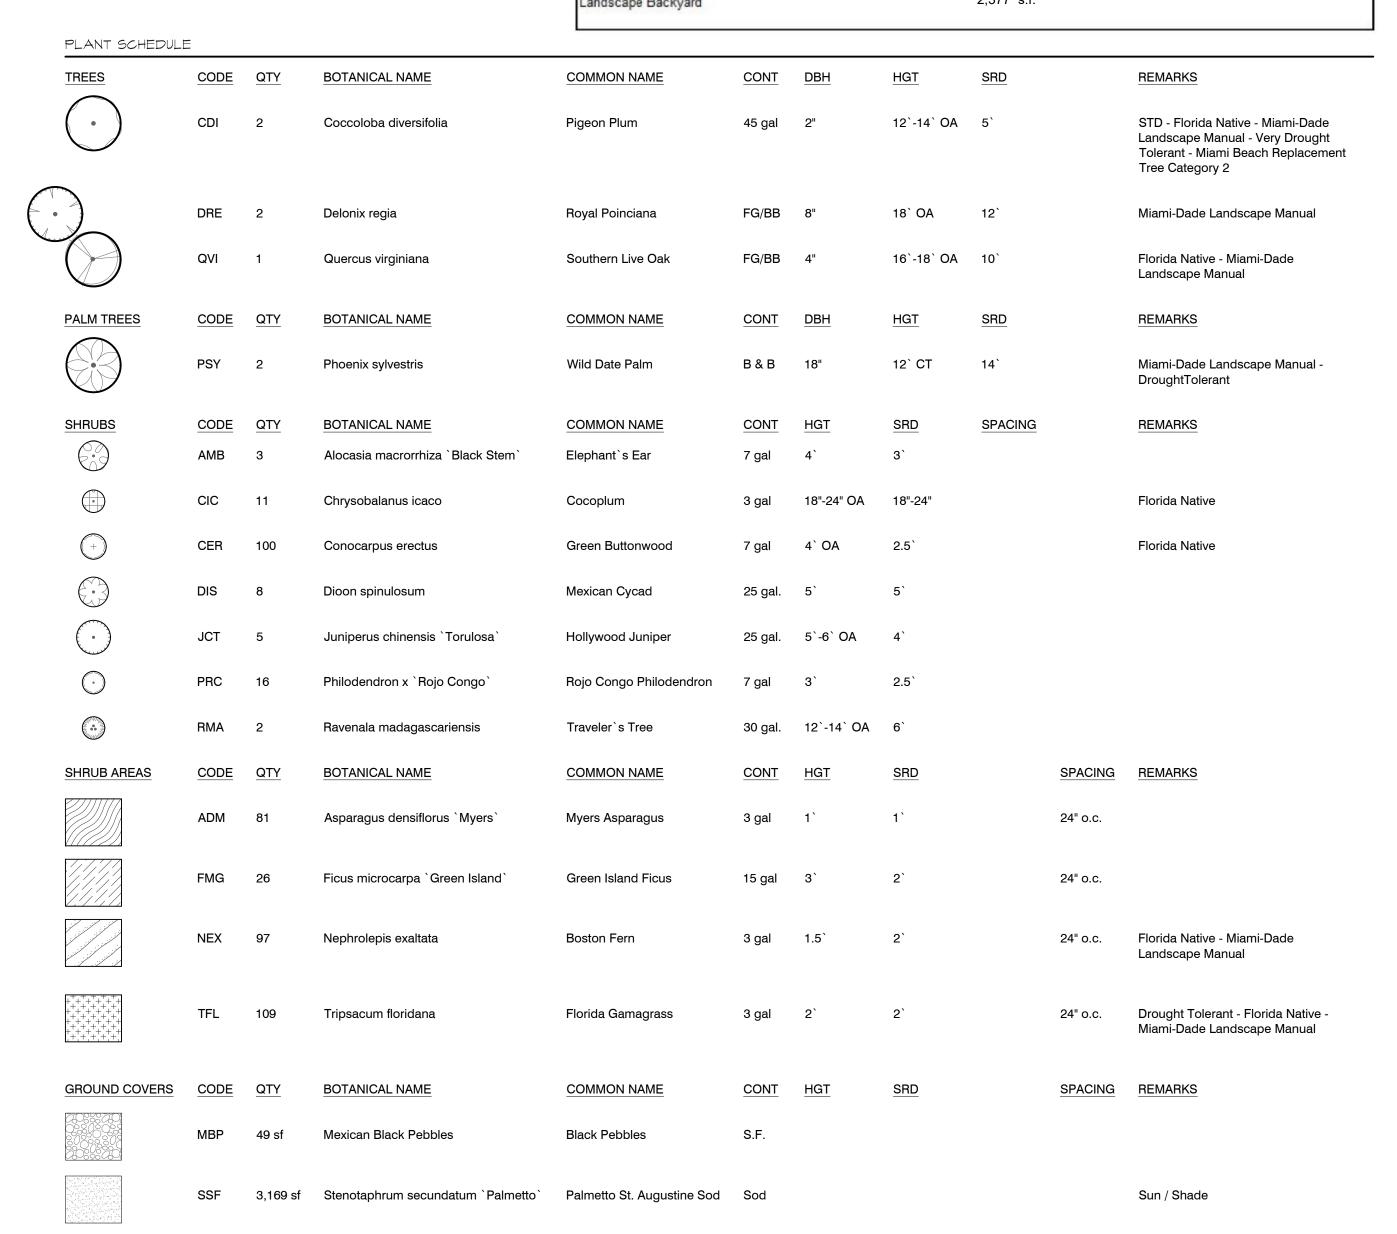

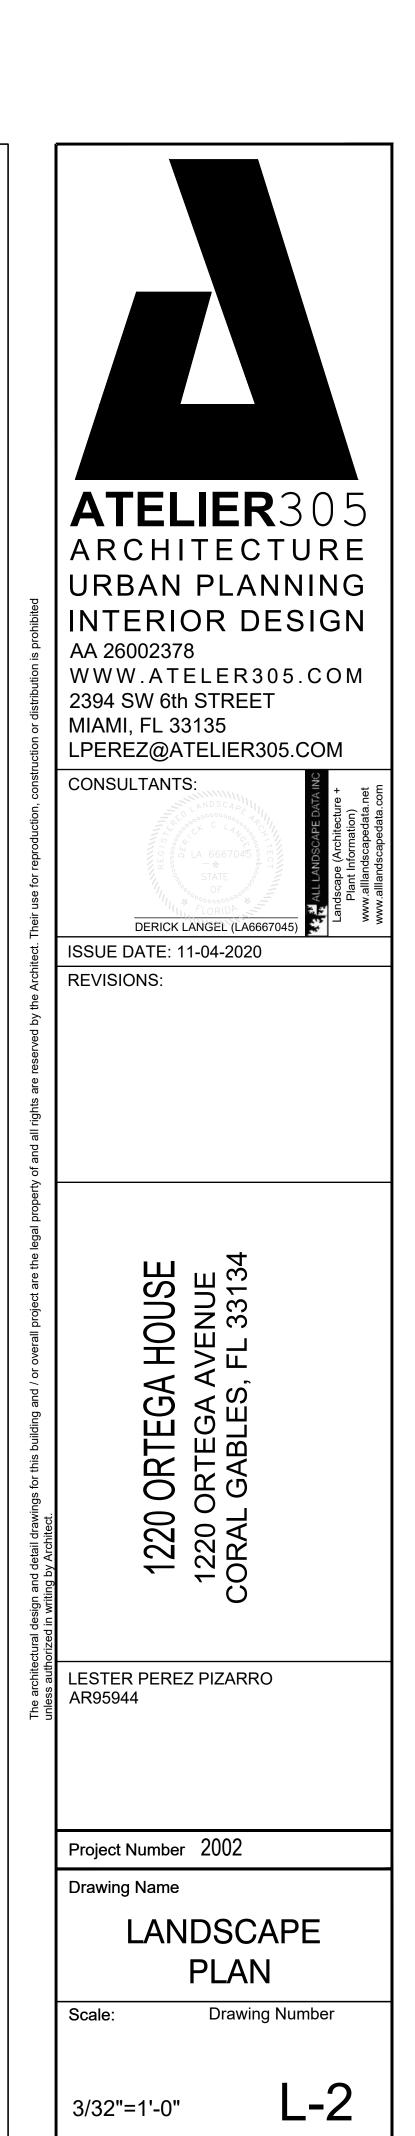





CONSULTANTS:

CONSULTANTS:

STATE

OF

DERICK LANGEL (LA66667045)

ISSUE DATE: 11-04-2020

REVISIONS:

220 ORTEGA HOUSE 220 ORTEGA AVENUE RAL GABLES, FL 33134

LESTER PEREZ PIZARRO AR95944

Project Number 2002

Drawing Name

LANDSCAPE IMAGES

Scale:

Drawing Number

N.T.S.

L-3

GENERAL NOTES


- 1. Landscape Contractor is responsible for verifying locations of all underground and overhead utilities and easements prior to commencing work. All Utility companies and/or the General Contractor shall be notified to verify utility locations prior to digging. Utility trenching is to be coordinated with the Landscape plans prior to beginning of project. The Owner or Landscape Architect shall not be responsible for damage to utility or irrigation lines.
- 2. Landscape Contractor shall examine the site and become familiar with conditions affecting the installation prior to submitting bids. Failure to do so shall not be considered cause for change orders.
- 3. Landscape Contractor is responsible for verifying all plant quantities prior to bidding and within (7) seven calendar days of receipt of these plans shall notify the Landscape Architect in writing of any and all discrepancies. In case of discrepancies planting plans shall take precedence over plant list.
- 4. No substitutions are to be made without prior consent of the Landscape Architect. Plant material supply is the responsibility of the Landscape Contractor, and he/she shall take steps to insure availability at time of planting.
- 5. All plant material shall meet or exceed the size on the plant list. In all cases meeting the height and the spread specifications shall take precedence over container size.
- 6. All planted areas to be outfitted with automatic irrigation system providing 100% coverage and 50% overlap. A rain sensor must be part of the irrigation system.
- 7. Landscape Contractor shall be responsible for providing temporary hand watering to all proposed & landscape areas, during construction.
- 8. The Landscape Contractor is responsible for coordinating tree and palm removals and transplants shown on the Tree/Palm Disposition Plan. The Landscape Contractor is to remove and discard from site existing unwanted trees, palms, shrubs, groundcovers, sod and weeds within landscape areas.


9. All permitting and fees to be the responsibility of the Contractor.


PLANTING NOTES

- 1. Landscape Contractor shall furnish and install all trees, palms, shrubs, groundcover, sod, planting soil, herbicide, preemergence herbicide, seed, and mulch. Landscape Contractor to provide Landscape Architect with at least 5 days notice
- 2. Landscape Contractor shall guarantee all plant material for a period of one year from the day of final acceptance by the
- 3. All plant material shall be Florida #1 or better, as defined in the Grades and Standards for Nursery Plants, Part I and II by the State of Florida Department of Agriculture.
- 4. Landscape Contractor is responsible for scheduling a nursery visit for Landscape Architect to approve all trees, palms and shrubs prior to delivery to the project site.
- 5. Landscape Contractor shall coordinate his work with that of the Irrigation and Landscape Lighting Contractor.
- 6. The Landscape Contractor shall treat planted areas with preemergence herbicide after weeds and grass have been removed. Landscape Contractor shall apply pre emergent herbicide per manufacturer's recommendation, wait period prior to planting as specified. Planting soil mix/backfill shall be clean and free of construction debris, weeds, rock and noxious pests and disease.
- 7. All soil mix in plant beds for ground covers, shrubs, palms and trees shall be as per details. All other areas shall be dressed with a minimum of 4" topsoil "if required".
- All planting areas and planting pits shall be tested for sufficient percolation prior to final planting and irrigation installation to ensure proper drainage. Plant beds in parking lots and in areas compacted by heavy equipment shall be de-compacted so that
- 9. All synthetic burlap, string, cords or wire baskets shall be removed before trees are planted, without breaking the soil ball. All synthetic tape shall be removed from branches and trunks prior to final acceptance. The top 1/3 of natural burlap shall be removed, after the tree is set in the planting hole and before the tree is backfilled. Landscape Contractor is to check for root defects including deep planting in the root ball and circling roots, trees with root problems will not be accepted.
- 10. Landscape Contractor is responsible for mulching all plant beds and planters with a minimum 3" layer of natural color Eucalyptus or Environmulch immediately after planting. In no case shall Cypress mulch be used.
- 11. All Trees/Palms in sod areas are to receive a 48" diameter mulched saucer at the base of the trunk respectively.
- 12. Landscape Contractor shall guy and stake all trees and palms as per specifications and details. No nails, screws or wiring shall penetrate the outer surface of trees and palms. All guying and staking shall be removed twelve months after planting.
- 13. All palm and tree guy wires and bracing are to be flagged for visibility, for their duration. All unattended and unplanted tree pits shall be properly barricaded and flagged during construction.
- 14. All broken branches and clear trunk branches on street trees are to be pruned according to ANSI A 300 Guidelines for Tree Pruning to min. 5' - 0" height clearance to the base of canopy.
- 15. Landscape Contractor shall fertilize plant material as needed to support optimum healthy plant growth. All fertilization shall be performed in compliance with the latest ANSI A300 (Part 2) Standards.
- 16. Stake all trees and palms for approval by Landscape Architect prior to installation.
- 17. Any sod areas damaged by construction are to be replaced with St. Augustine 'Floratam' sod.
- 18. All areas within limits of work not covered by walks, buildings, playground, and/or any other hardscape feature shall be sodded with St. Augustine 'Floratam' sod.
- 19. St. Augustine 'Floratam' Contractor's responsibility to verify quantity.
- 20. Install rootbarrier as per manufacturer's recommendation on all large trees that are 6' or closer to any pavement or building, as
- 21. Root barrier shall be Vespro Inc. or approved equal.




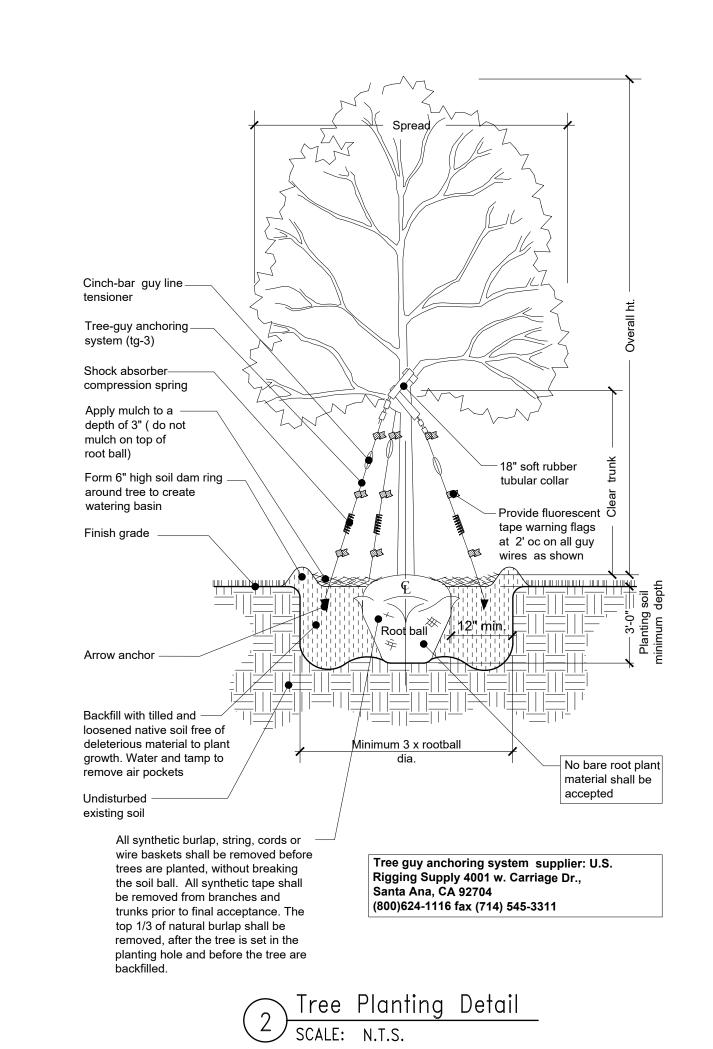

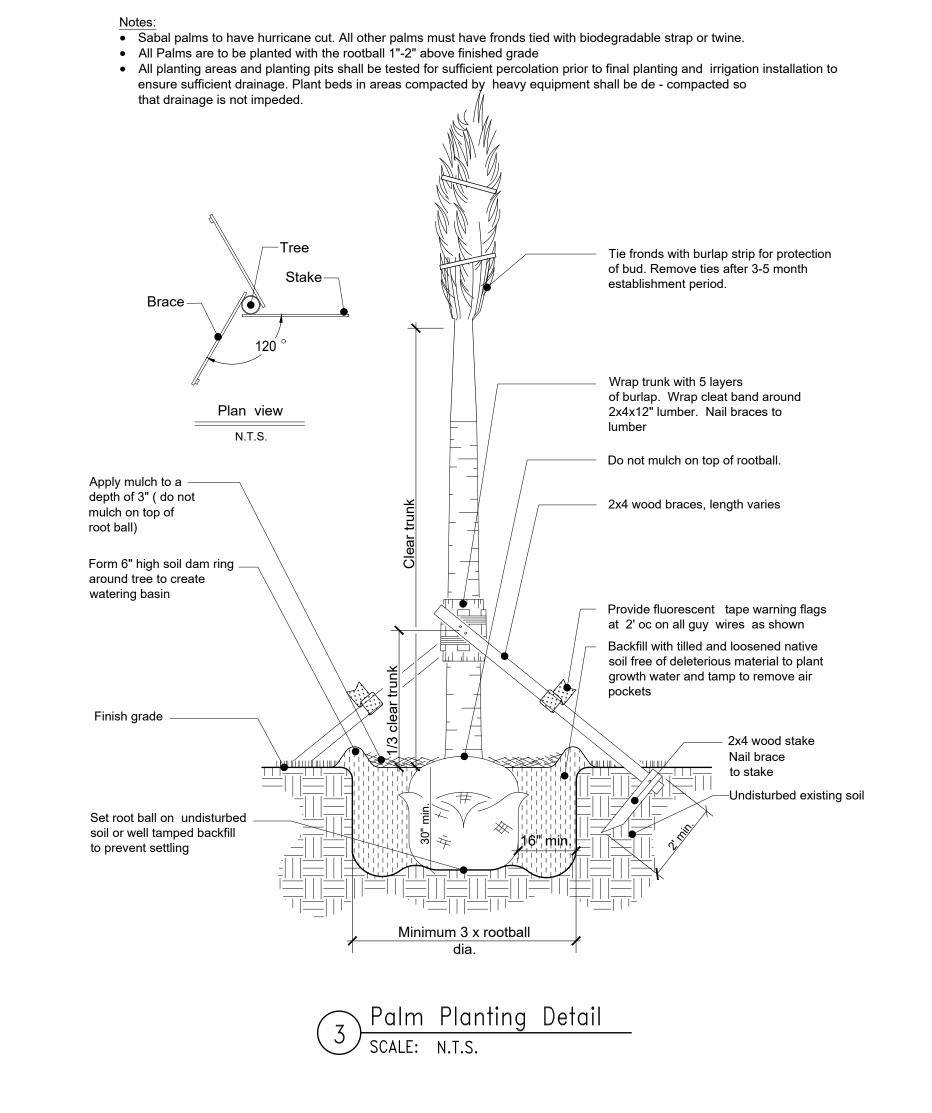

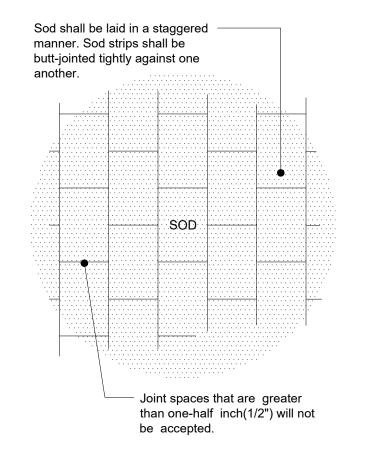



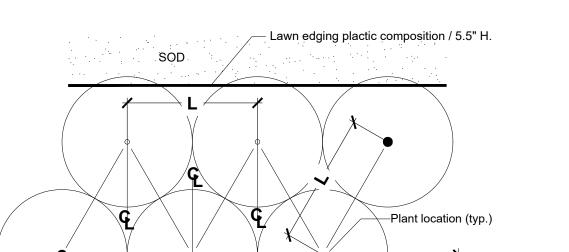

Paving edge / building / curb / edge of planting bed.


Set plants; "back for groundcover,

12" back for shrubs




Spacing diagram refers to all planting unless noted otherwise

L= Spacing as called for in planting plan and plant list

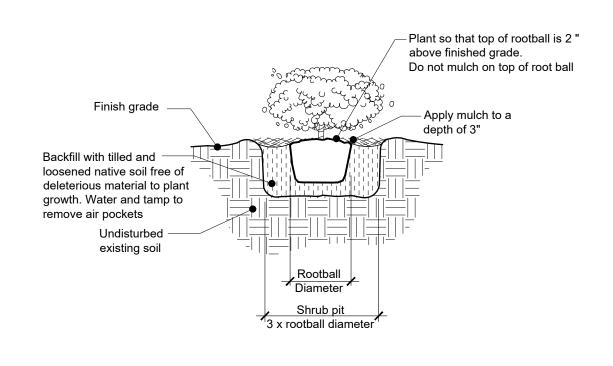

∖Shrubs Planting Detail

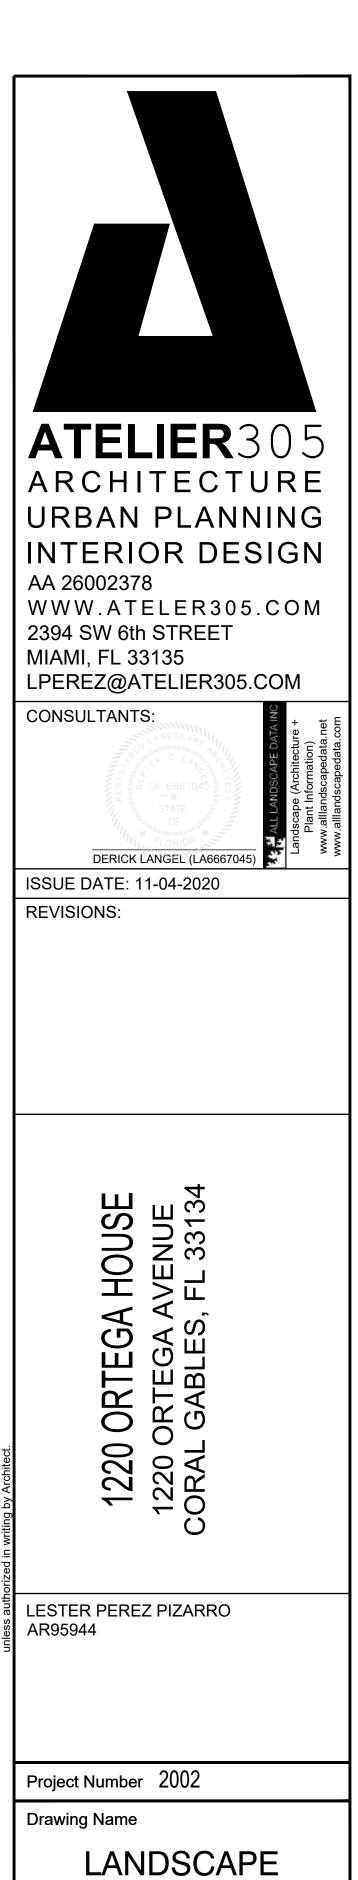

NOTES & DETAILS

Scale: **Drawing Number**

N.T.S.

L-4