
LOPEZ RESIDENCE

9501 JOURNEY'S END LANE CORAL GABLES, FL 33156

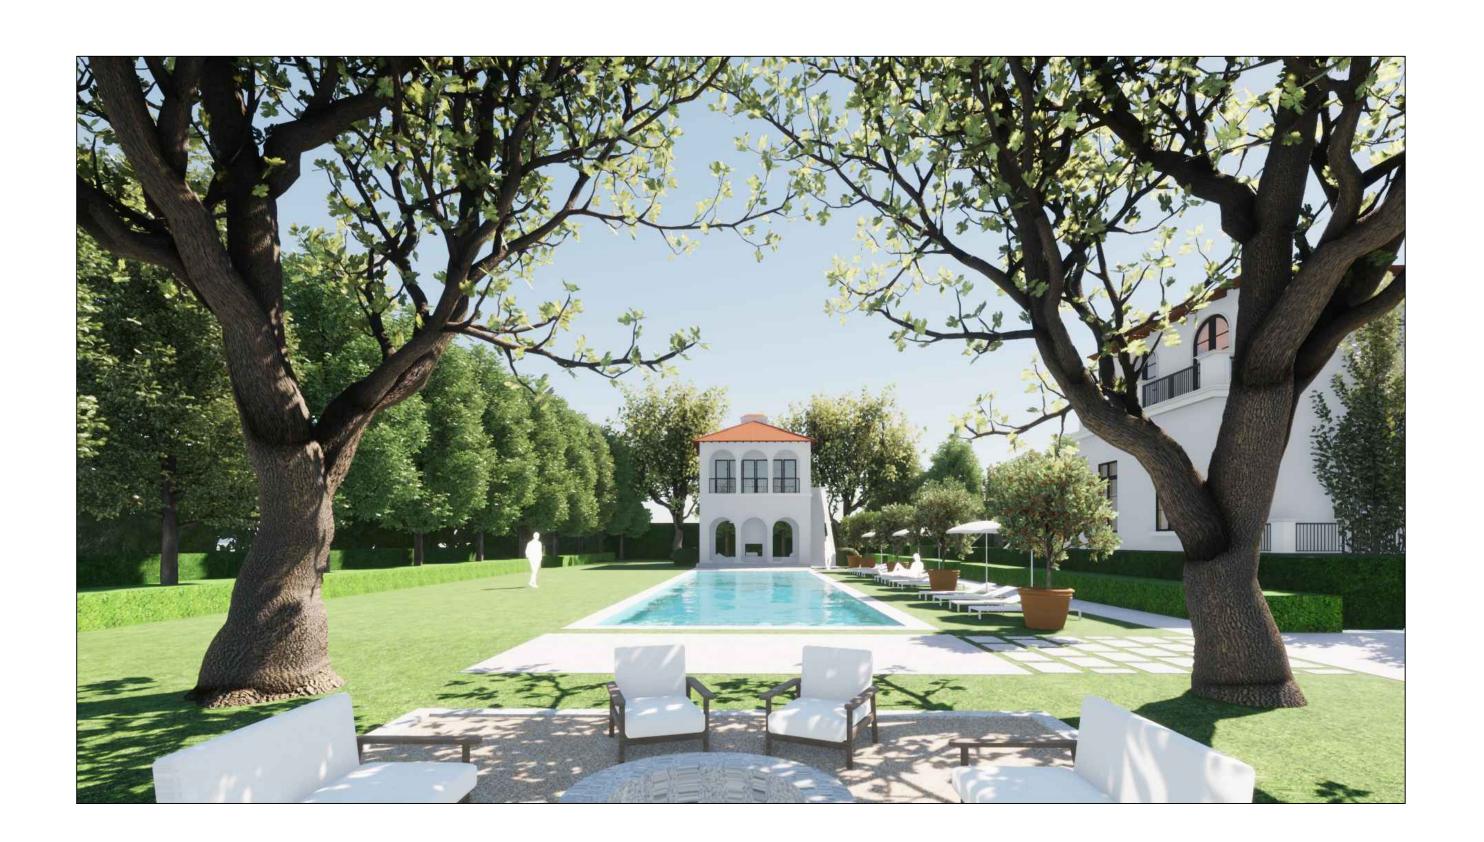




ARCHITECTURE SHEET INDEX


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GENERAL
      INDEX AND DATA
      CONTEXT AND EXISTING PHOTOS
      SURVEY
      TREE SURVEY
AR200 EXISTING ELEVATIONS
      EXISTING ELEVATIONS
A100
      SITE PLAN
     FIRST FLOOR PLAN
A101
      PROPOSED ELEVATIONS
    PROPOSED ELEVATIONS
A110 ENLARGED FLOOR PLANS - SERVICE
      ENLARGED ELEVATIONS - SERVICE
A110b ENLARGED FLOOR PLANS - GUESTHOUSE
A210b ENLARGED ELEVATIONS - GUESTHOUSE
```

GRAPHICAL SYMBOLS

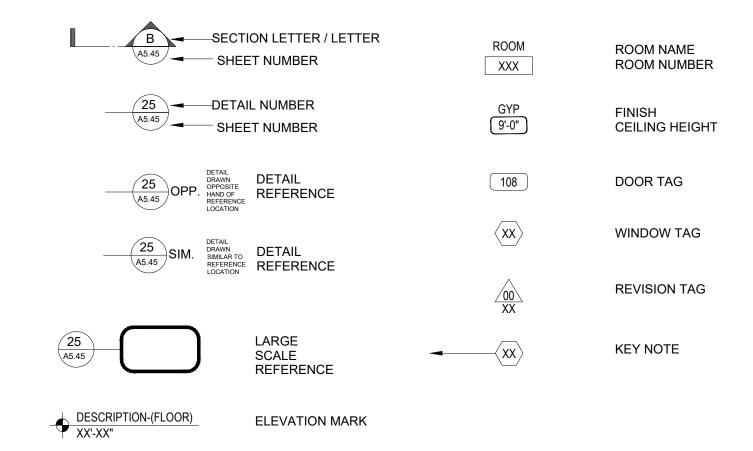

LOCATION:



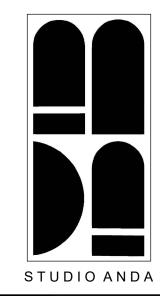

PROJECT TITLE:

LOPEZ RESIDENCE

PROJECT LOCATION:

9501 JOURNEY'S END LANE
CORAL GABLES, FL 33156

PROJECT CLIENT/OWNER(S):
ANTHONY M. LOPEZ

ARCHITECT:

ANA GUARACAO SERRANO

1800 N BAYSHORE DR #402,

LIC#: AR100664


MIAMI, FL 33132

PH: (214)708-7454 STRUCTURAL ENGINEERING:

MEP ENGINEERING:

LANDSCAPE ARCHITECT:

PROFESSIONAL SEALS:

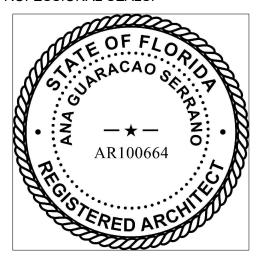

01/14/2021 REVISION 2

01 09/24/2020 REVISION 1

08/10/2020 B.O.A

NO. DATE DESCRIPTION

SHEET ISSUE/ REVISION LOG

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PROJECT ID: DRAWN BY:

1003 AR/AG

PRINT DATE: SCALE:


7/19/20


DRAWING TITLE:

INDEX & DATA

SHEET NO.


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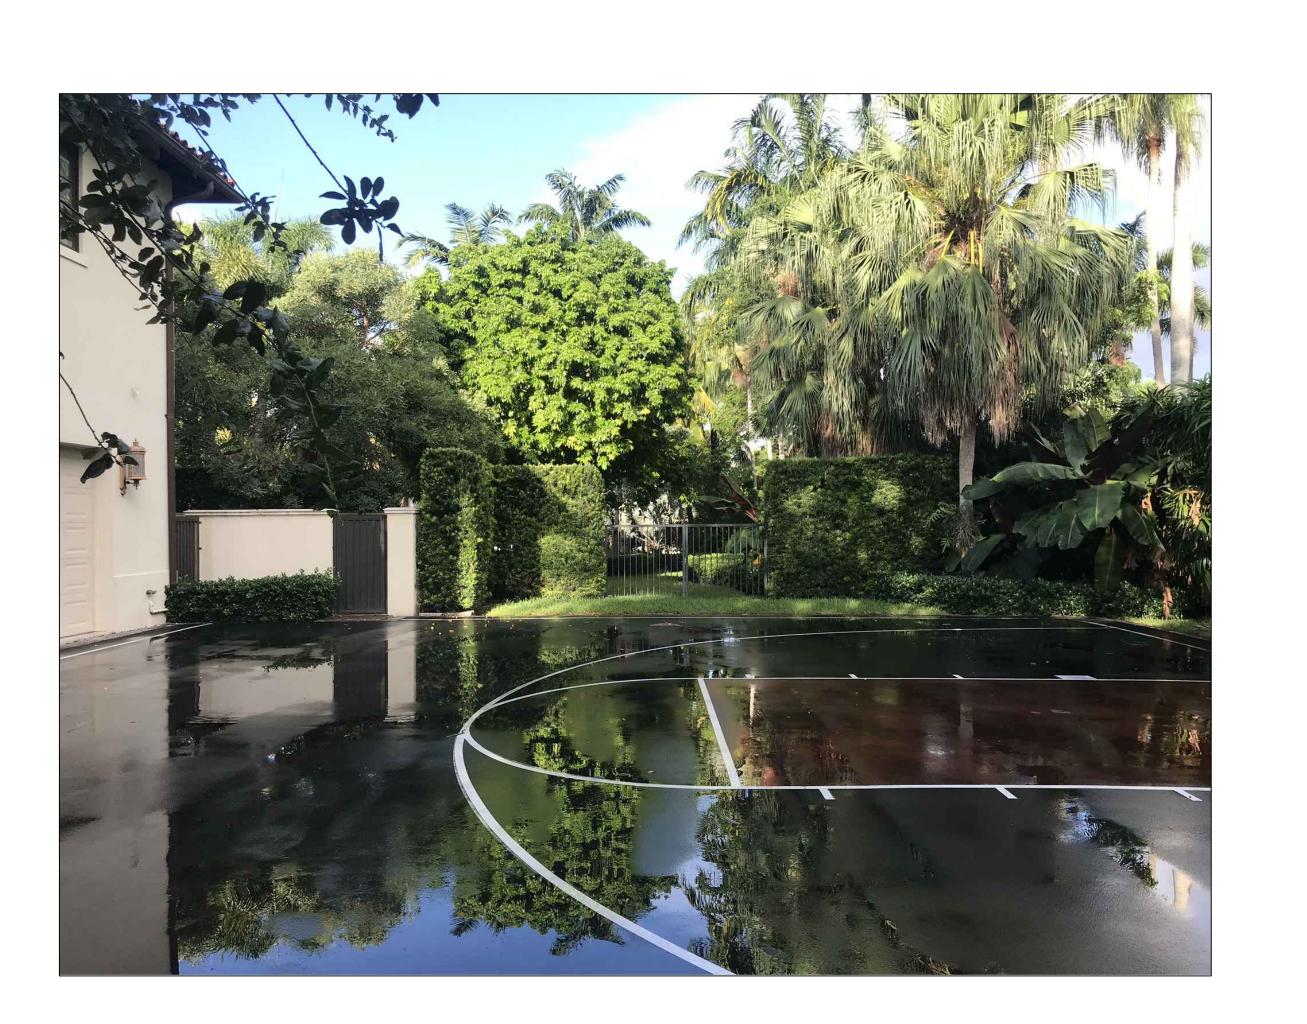


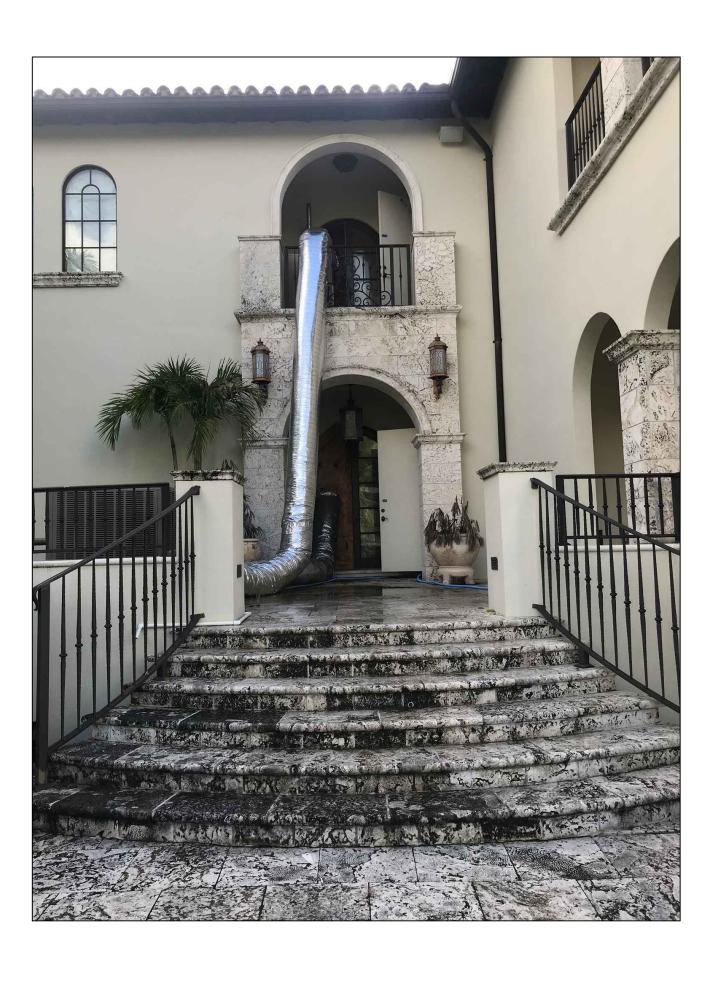

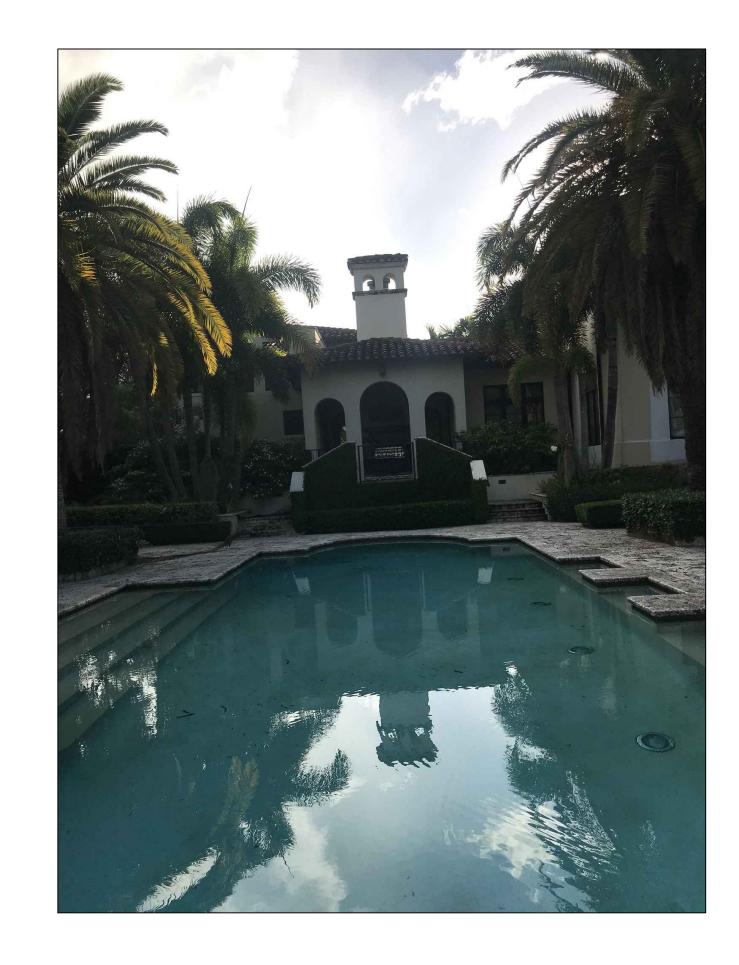





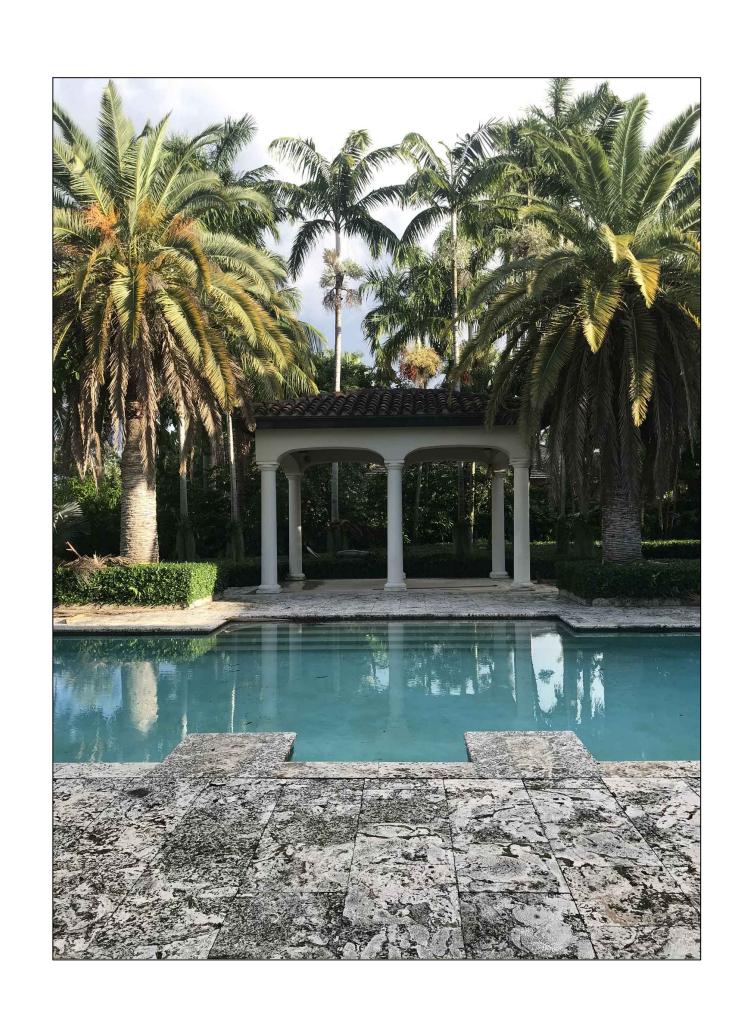



PROJECT TITLE:

LOPEZ RESIDENCE

PROJECT LOCATION: 9501 JOURNEY'S END LANE CORAL GABLES, FL 33156

PROJECT CLIENT/OWNER(S):
ANTHONY M. LOPEZ


ARCHITECT:
ANA GUARACAO SERRANO
LIC#: AR100664
1800 N BAYSHORE DR #402,
MIAMI, FL 33132

PH: (214)708-7454
STRUCTURAL ENGINEERING:

MEP ENGINEERING:

LANDSCAPE ARCHITECT:

PROFESSIONAL SEALS:

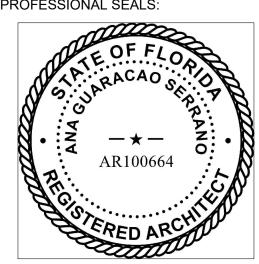

02 01/14/2021 REVISION 2 01 09/24/2020 REVISION 1

D. DATE DESCRIPTION

B.O.A

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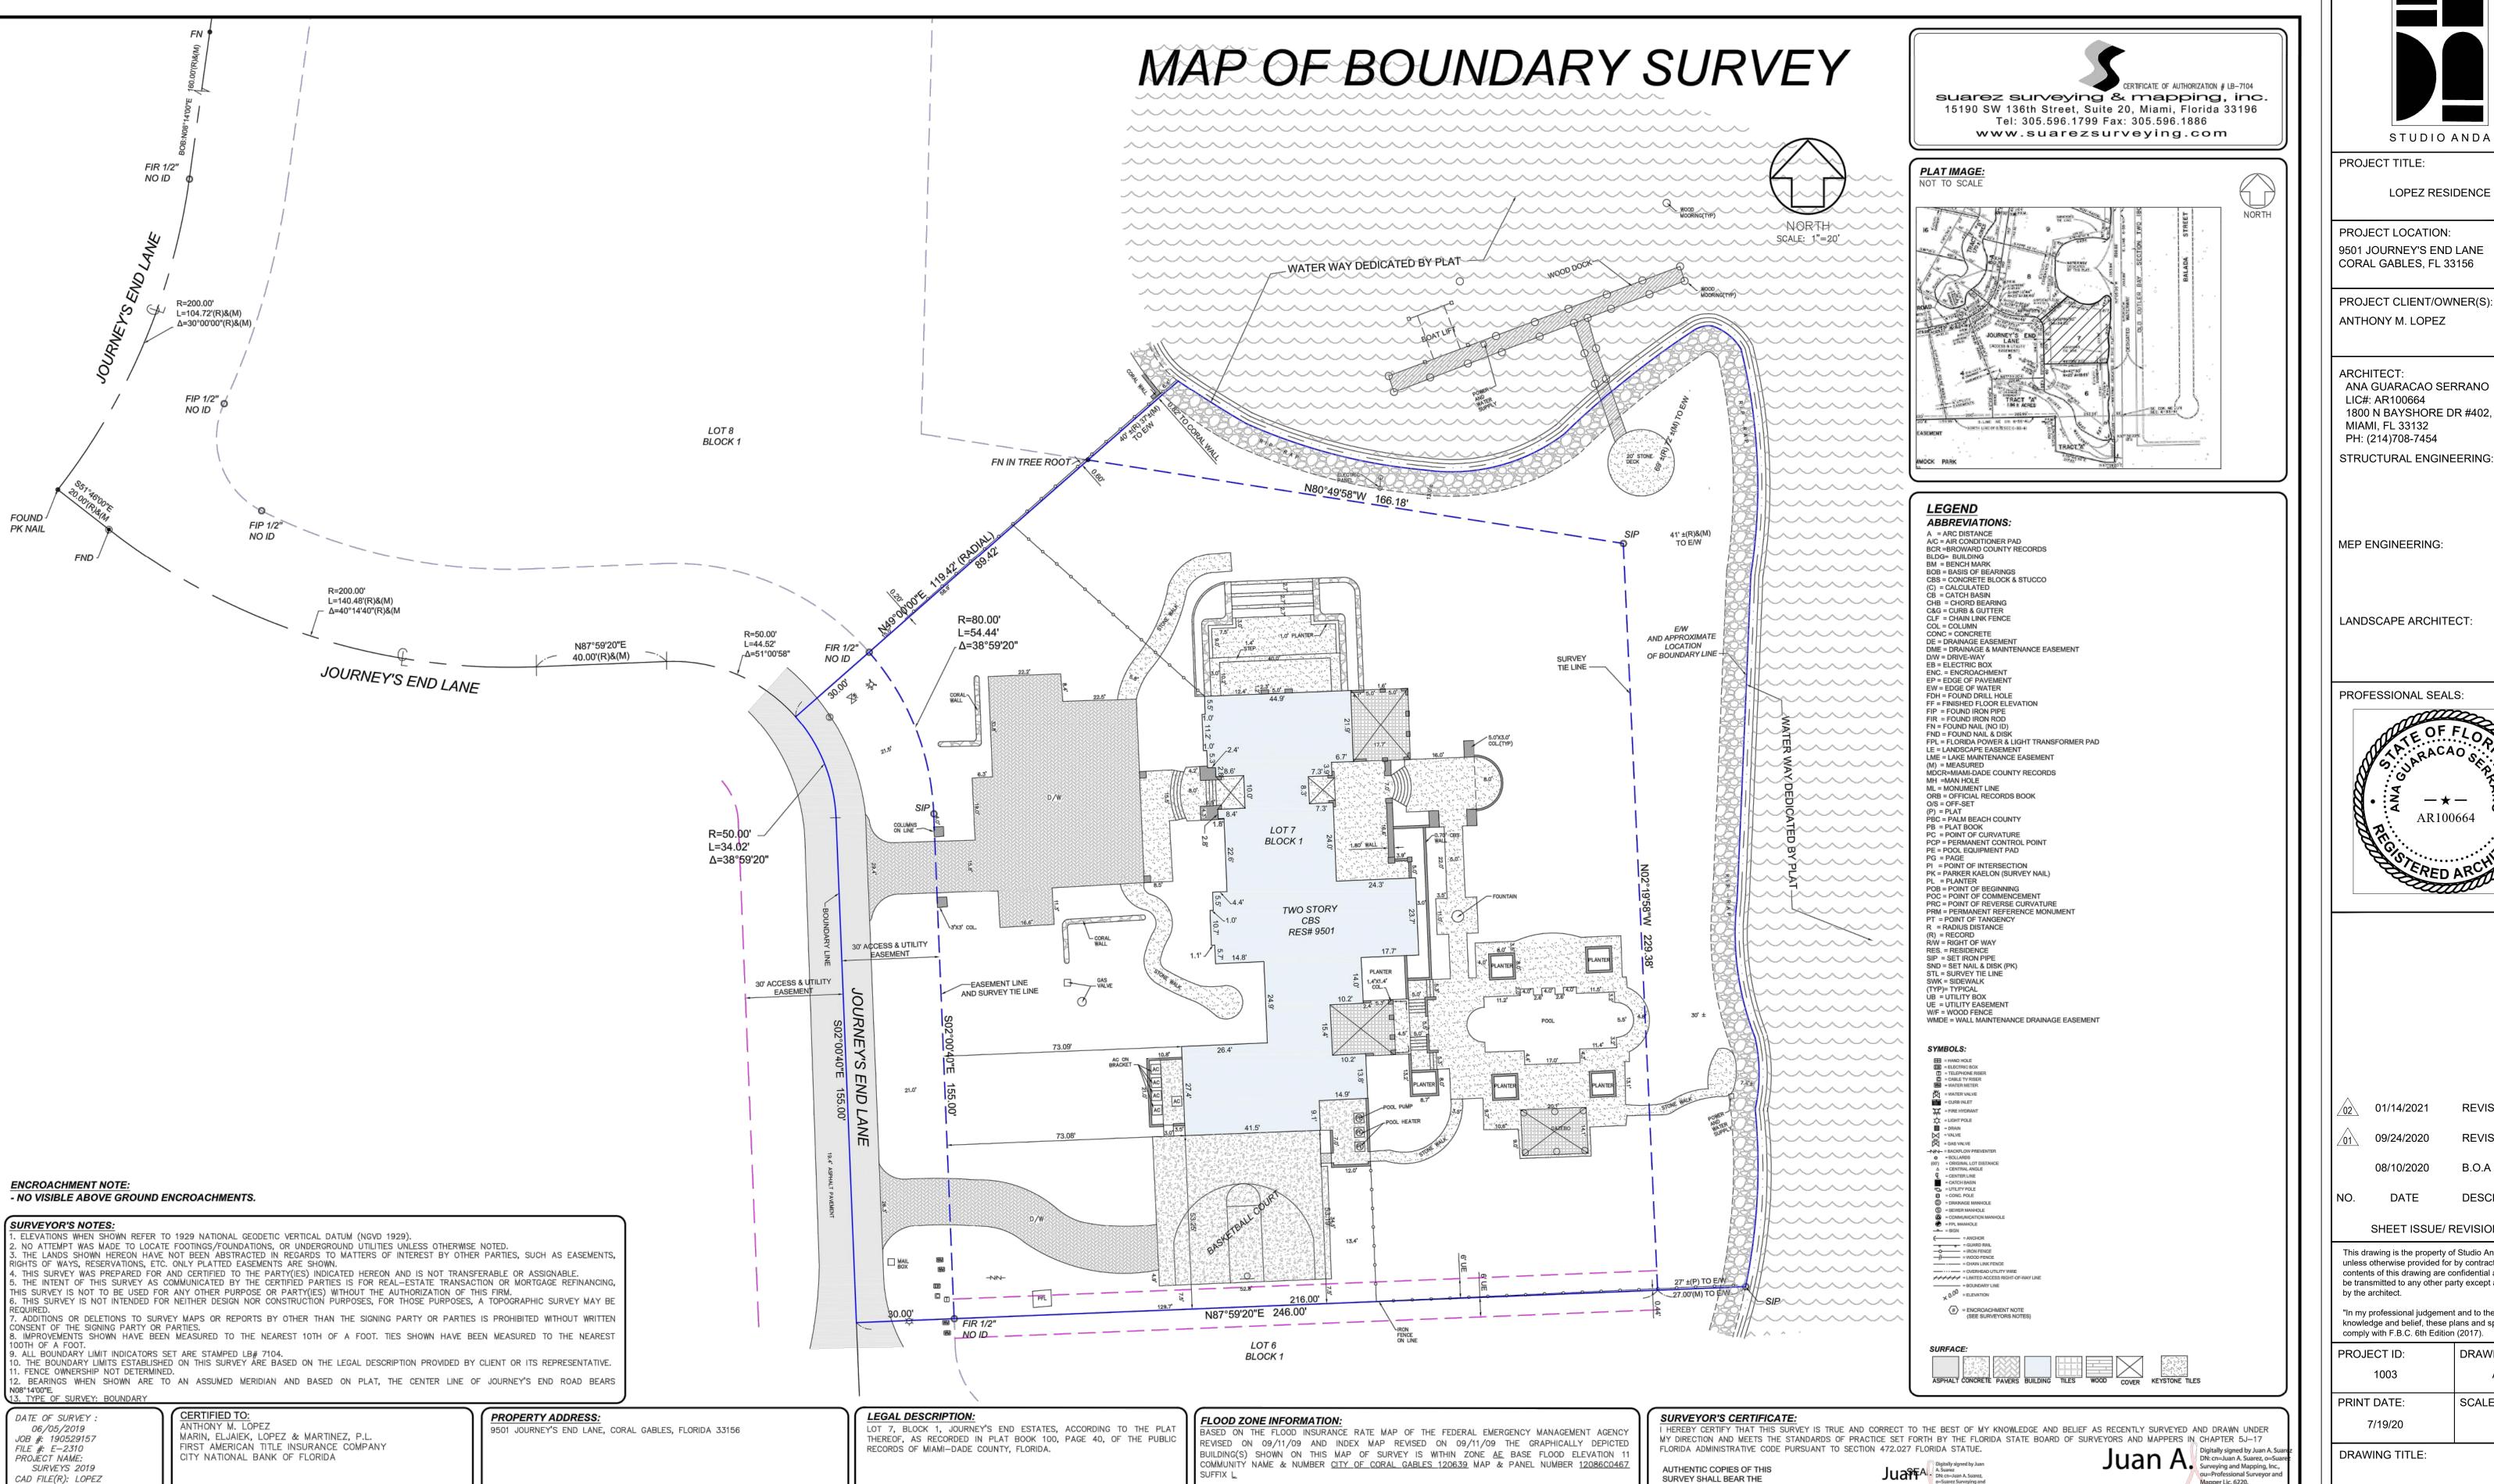
PROJECT ID:	DRAWN BY:				
1003	AR/AG				
PRINT DATE:	SCALE:				
7/19/20					

DRAWING TITLE:

CONTEXT IMAGES

SHEET NO.

A002




PARTY CHIEF:

JUAN

SHEET 1 OF 1

REVISIONS:

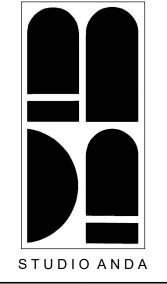

PROJECT TITLE:

LOPEZ RESIDENCE


PROJECT LOCATION: 9501 JOURNEY'S END LANE CORAL GABLES, FL 33156

PROJECT CLIENT/OWNER(S): ANTHONY M. LOPEZ

ARCHITECT: ANA GUARACAO SERRANO LIC#: AR100664 1800 N BAYSHORE DR #402, MIAMI, FL 33132 PH: (214)708-7454

LANDSCAPE ARCHITECT:

PROFESSIONAL SEALS:

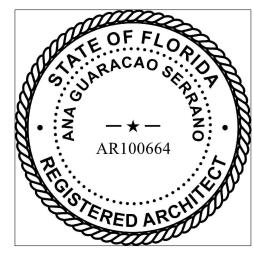

REVISION 2 09/24/2020 **REVISION 1**

DESCRIPTION

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PROJECT ID: DRAWN BY: PRINT DATE:

DRAWING TITLE:

SITE SURVEY

SHEET NO.

Mapper Lic. 6220,

PROFESSIONAL SURVEYOR & MAPPER


STATE OF FLORIDA LIC. # 6220

ORIGINAL SIGNATURE AND

Suarez gmail.com, c=US Date: 2019.06.13

RAISED SEAL OF THE

ATTESTING REGISTERED SURVEYOR AND MAPPER

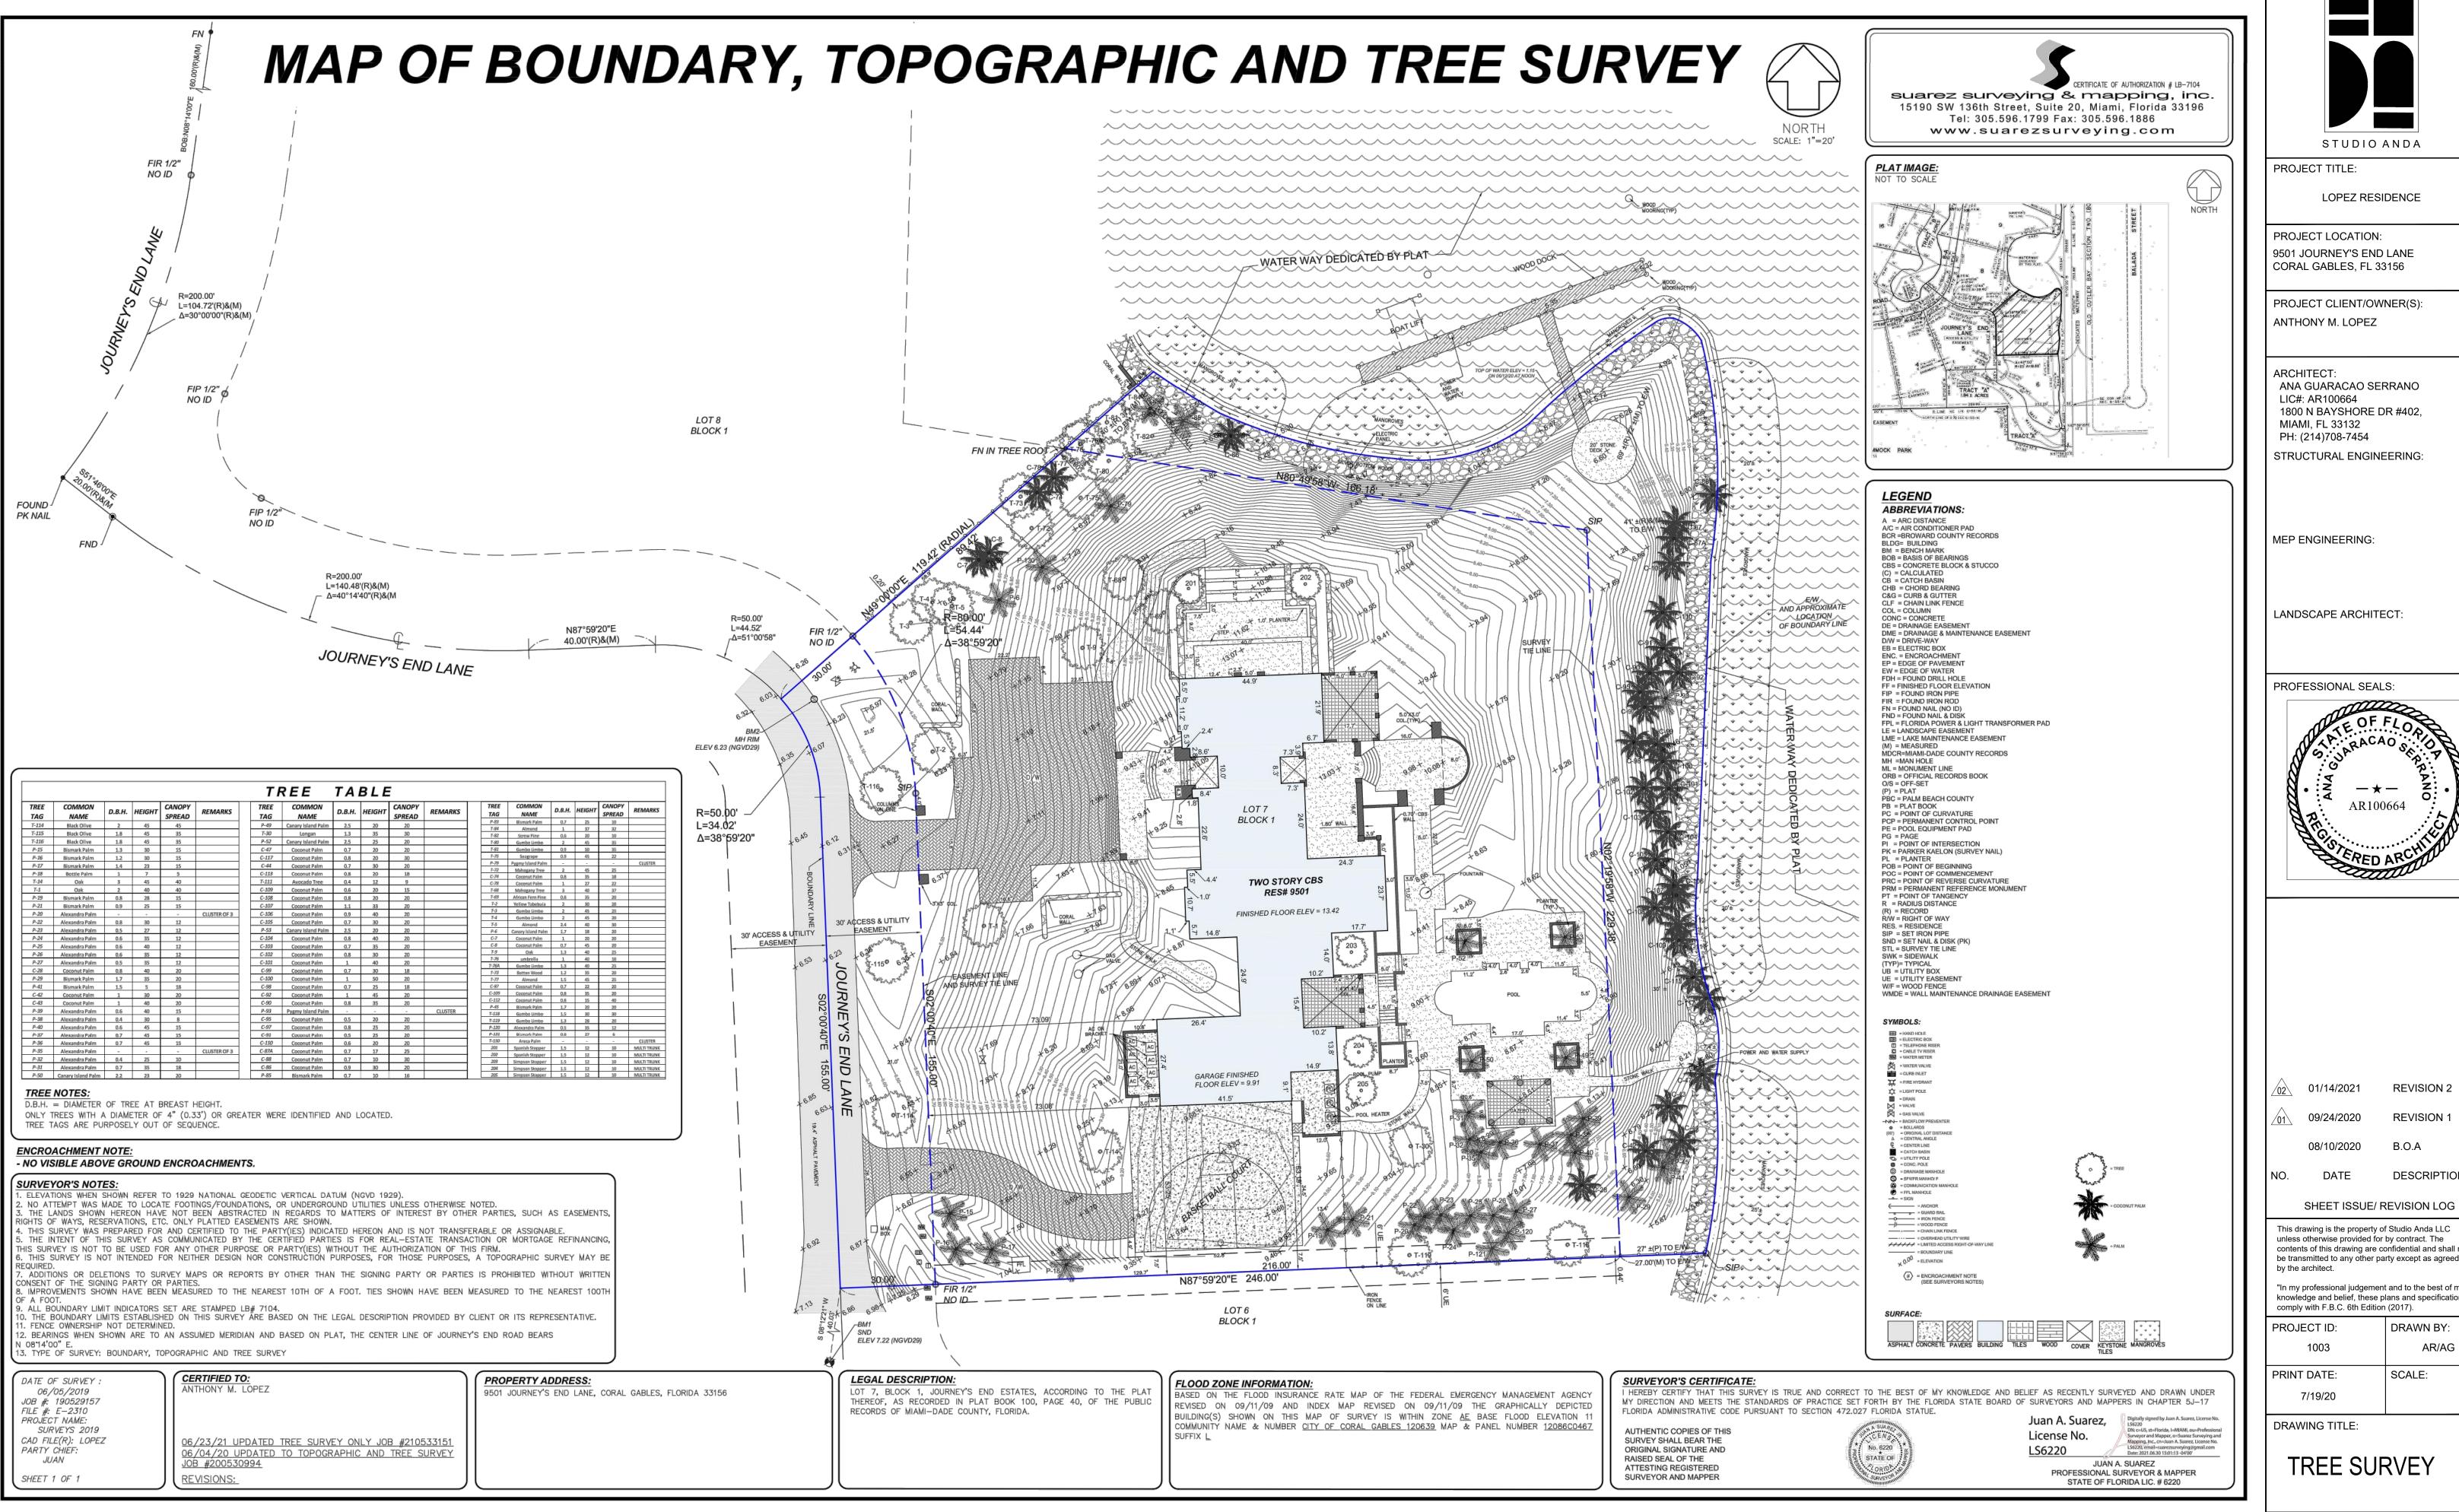

PROJECT TITLE:

LOPEZ RESIDENCE

PROJECT LOCATION: 9501 JOURNEY'S END LANE CORAL GABLES, FL 33156

PROJECT CLIENT/OWNER(S) ANTHONY M. LOPEZ

ANA GUARACAO SERRANO LIC#: AR100664 1800 N BAYSHORE DR #402, MIAMI, FL 33132 PH: (214)708-7454

LANDSCAPE ARCHITECT

PROFESSIONAL SEALS:



01/14/2021 **REVISION 2** 09/24/2020 **REVISION 1** 08/10/2020

DESCRIPTION

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DRAWN BY:

PRINT DATE: SCALE:

DRAWING TITLE:

TREE SURVEY

SHEET NO.



STUDIO ANDA

PROJECT TITLE:

LOPEZ RESIDENCE

PROJECT LOCATION: 9501 JOURNEY'S END LANE CORAL GABLES, FL 33156

PROJECT CLIENT/OWNER(S): ANTHONY M. LOPEZ


ARCHITECT: ANA GUARACAO SERRANO LIC#: AR100664 1800 N BAYSHORE DR #402, MIAMI, FL 33132 PH: (214)708-7454 STRUCTURAL ENGINEERING:

MEP ENGINEERING:

LANDSCAPE ARCHITECT:

PROFESSIONAL SEALS:



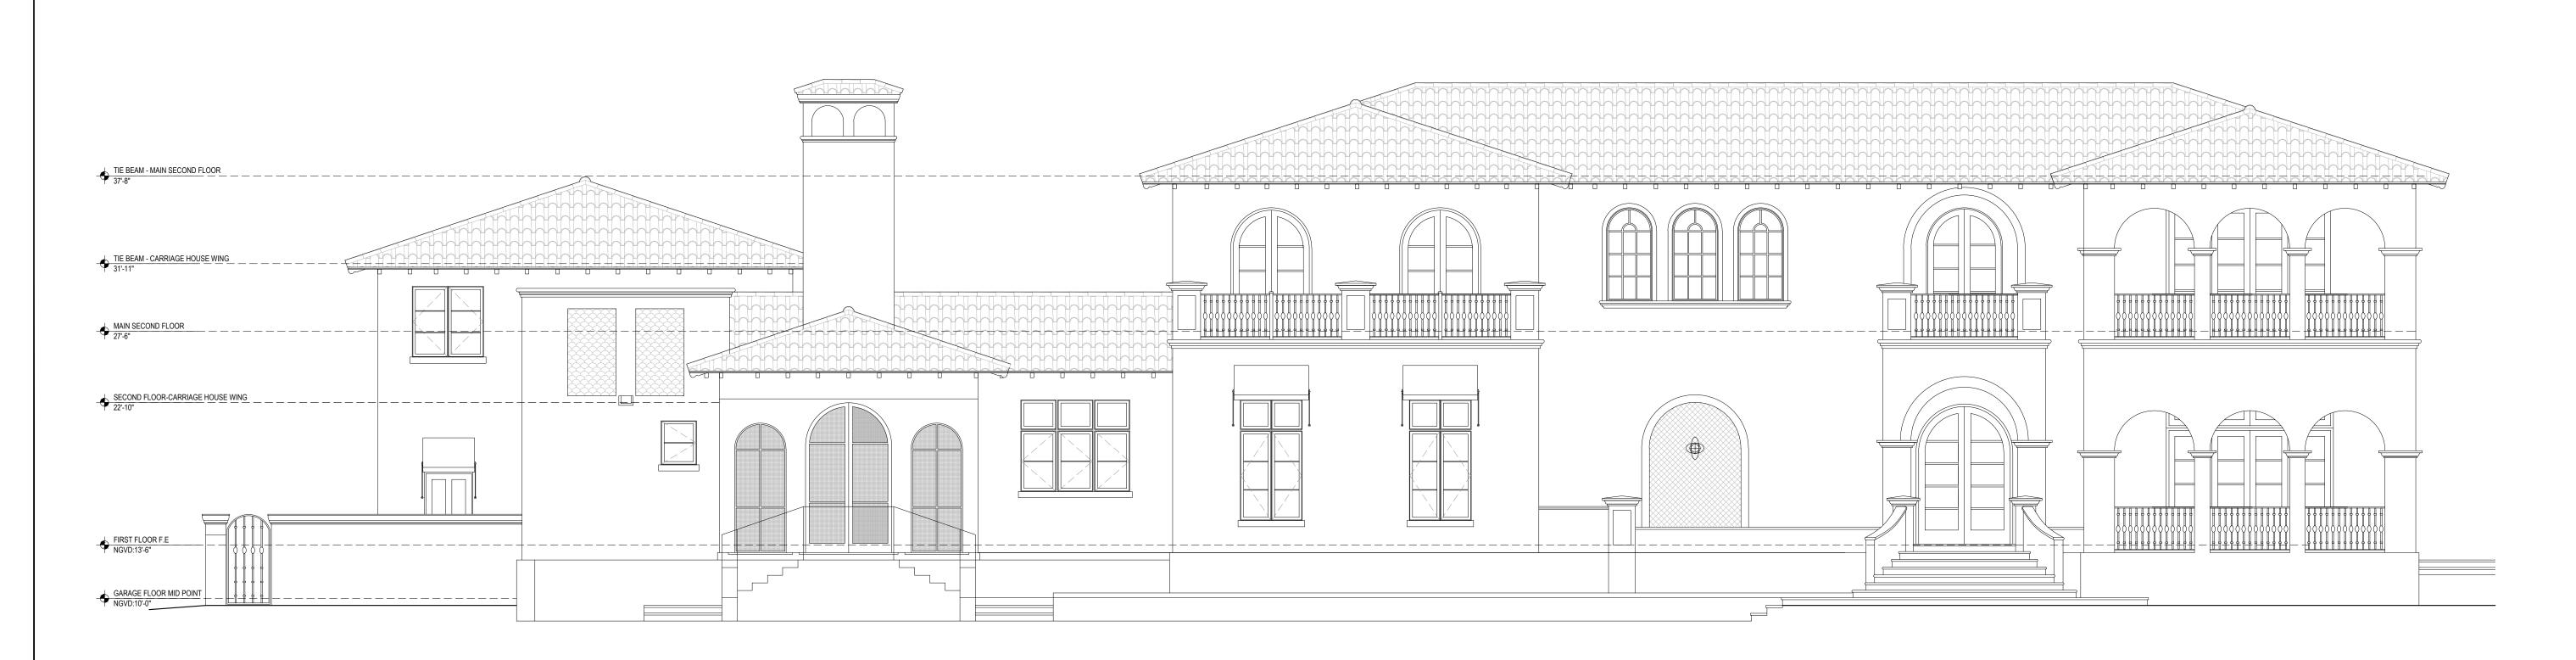

01/14/2021 **REVISION 2** <u>01</u> 09/24/2020

08/10/2020

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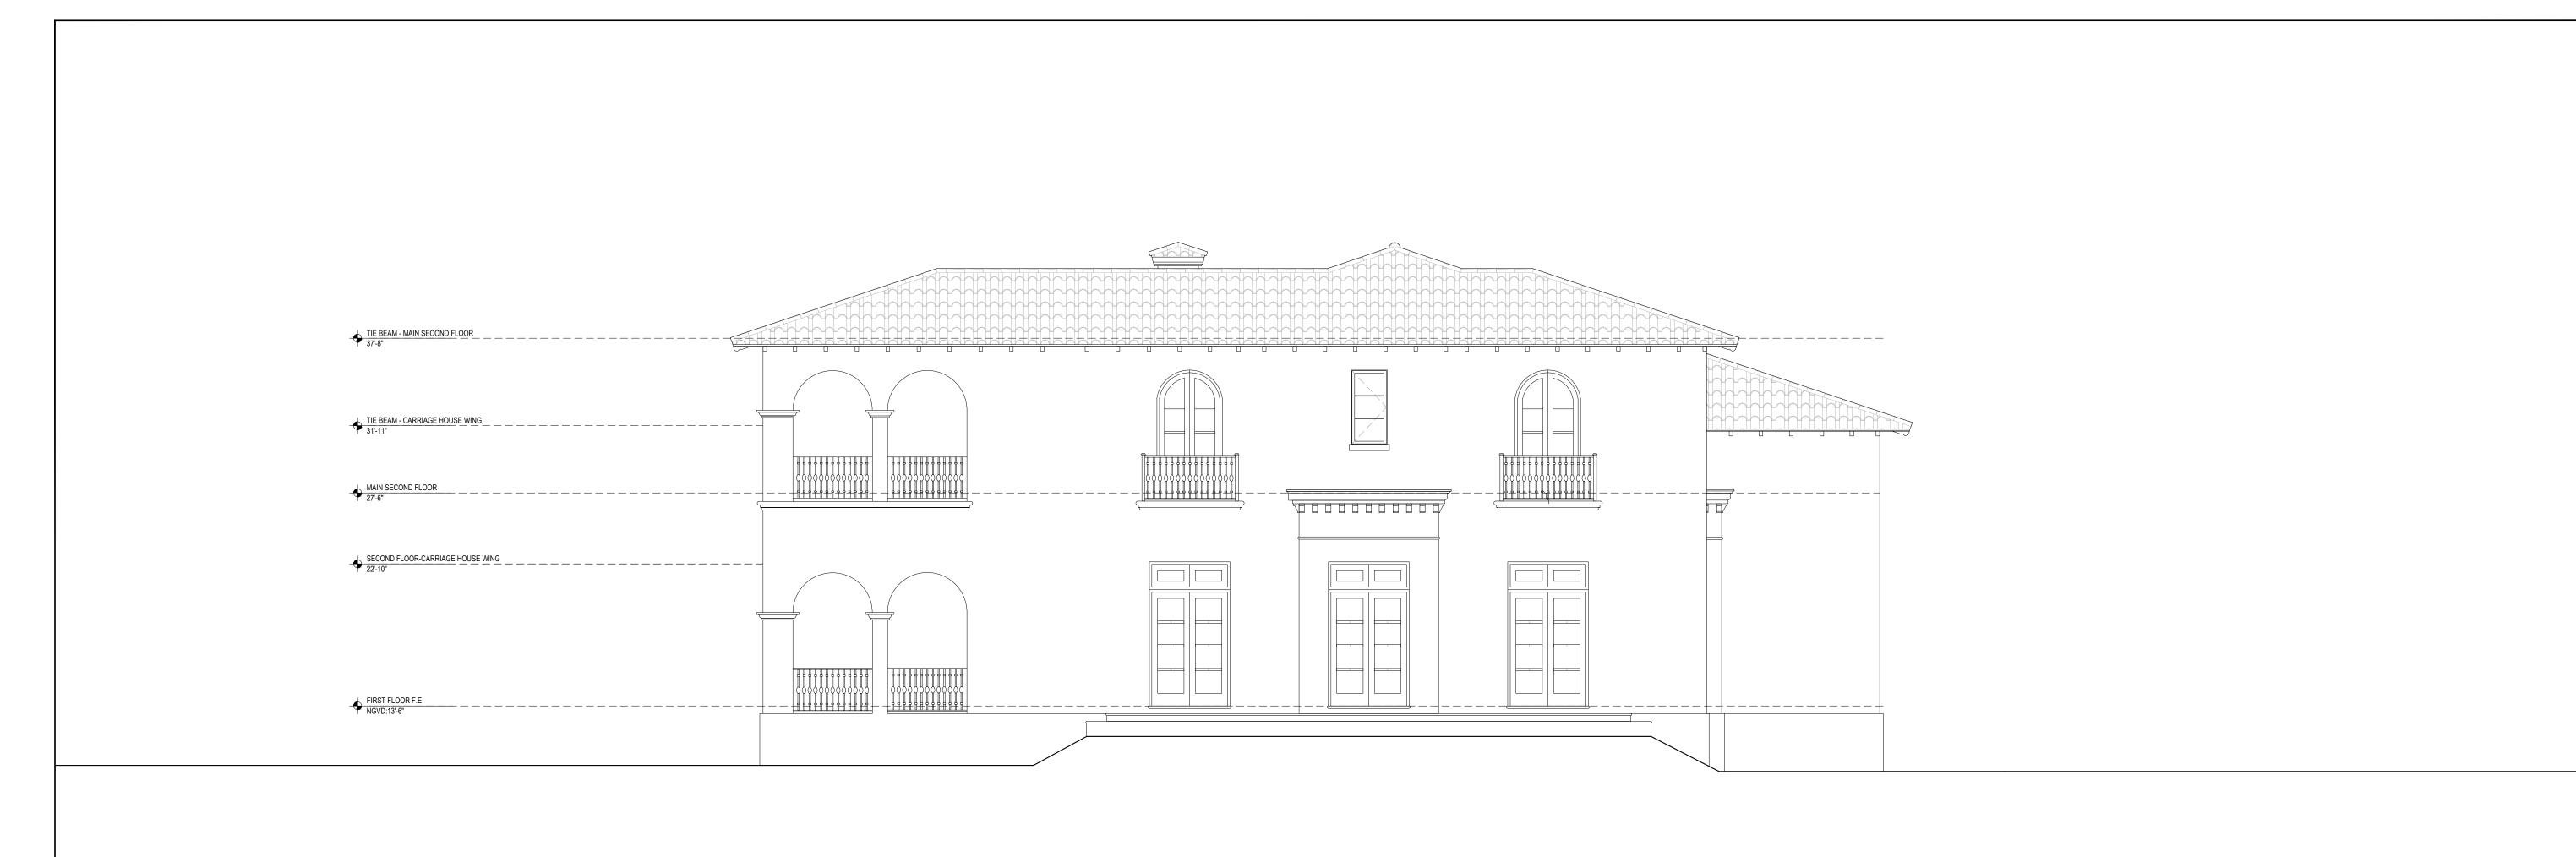
PROJECT ID: DRAWN BY: 1003 SCALE: PRINT DATE: 3/16"-1'-0" 7/19/20

DRAWING TITLE:

EXISTING

ELEVATIONS

SHEET NO. AR-200



STUDIO ANDA

PROJECT TITLE:

LOPEZ RESIDENCE

PROJECT LOCATION: 9501 JOURNEY'S END LANE CORAL GABLES, FL 33156

PROJECT CLIENT/OWNER(S):
ANTHONY M. LOPEZ

ARCHITECT:
ANA GUARACAO SERRANO
LIC#: AR100664
1800 N BAYSHORE DR #402,
MIAMI, FL 33132
PH: (214)708-7454
STRUCTURAL ENGINEERING:

MEP ENGINEERING:

LANDSCAPE ARCHITECT:

PROFESSIONAL SEALS:

OFESSIONAL SEALS.

WE OF FLOAD

AR100664

AR100664

EXISTING NORTH ELEVATION

Scale: 3/16" = 1'-0"



02 01/14/2021 REVISION 2 01 09/24/2020 REVISION 1

08/10/2020 B.O.A

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PROJECT ID: DRAWN BY:

1003 AR/AG

PRINT DATE: SCALE:

ELEVATIONS

3/16"-1'-0"


DRAWING TITLE:

EXISTING

7/19/20

SHEET NO.

AR-201

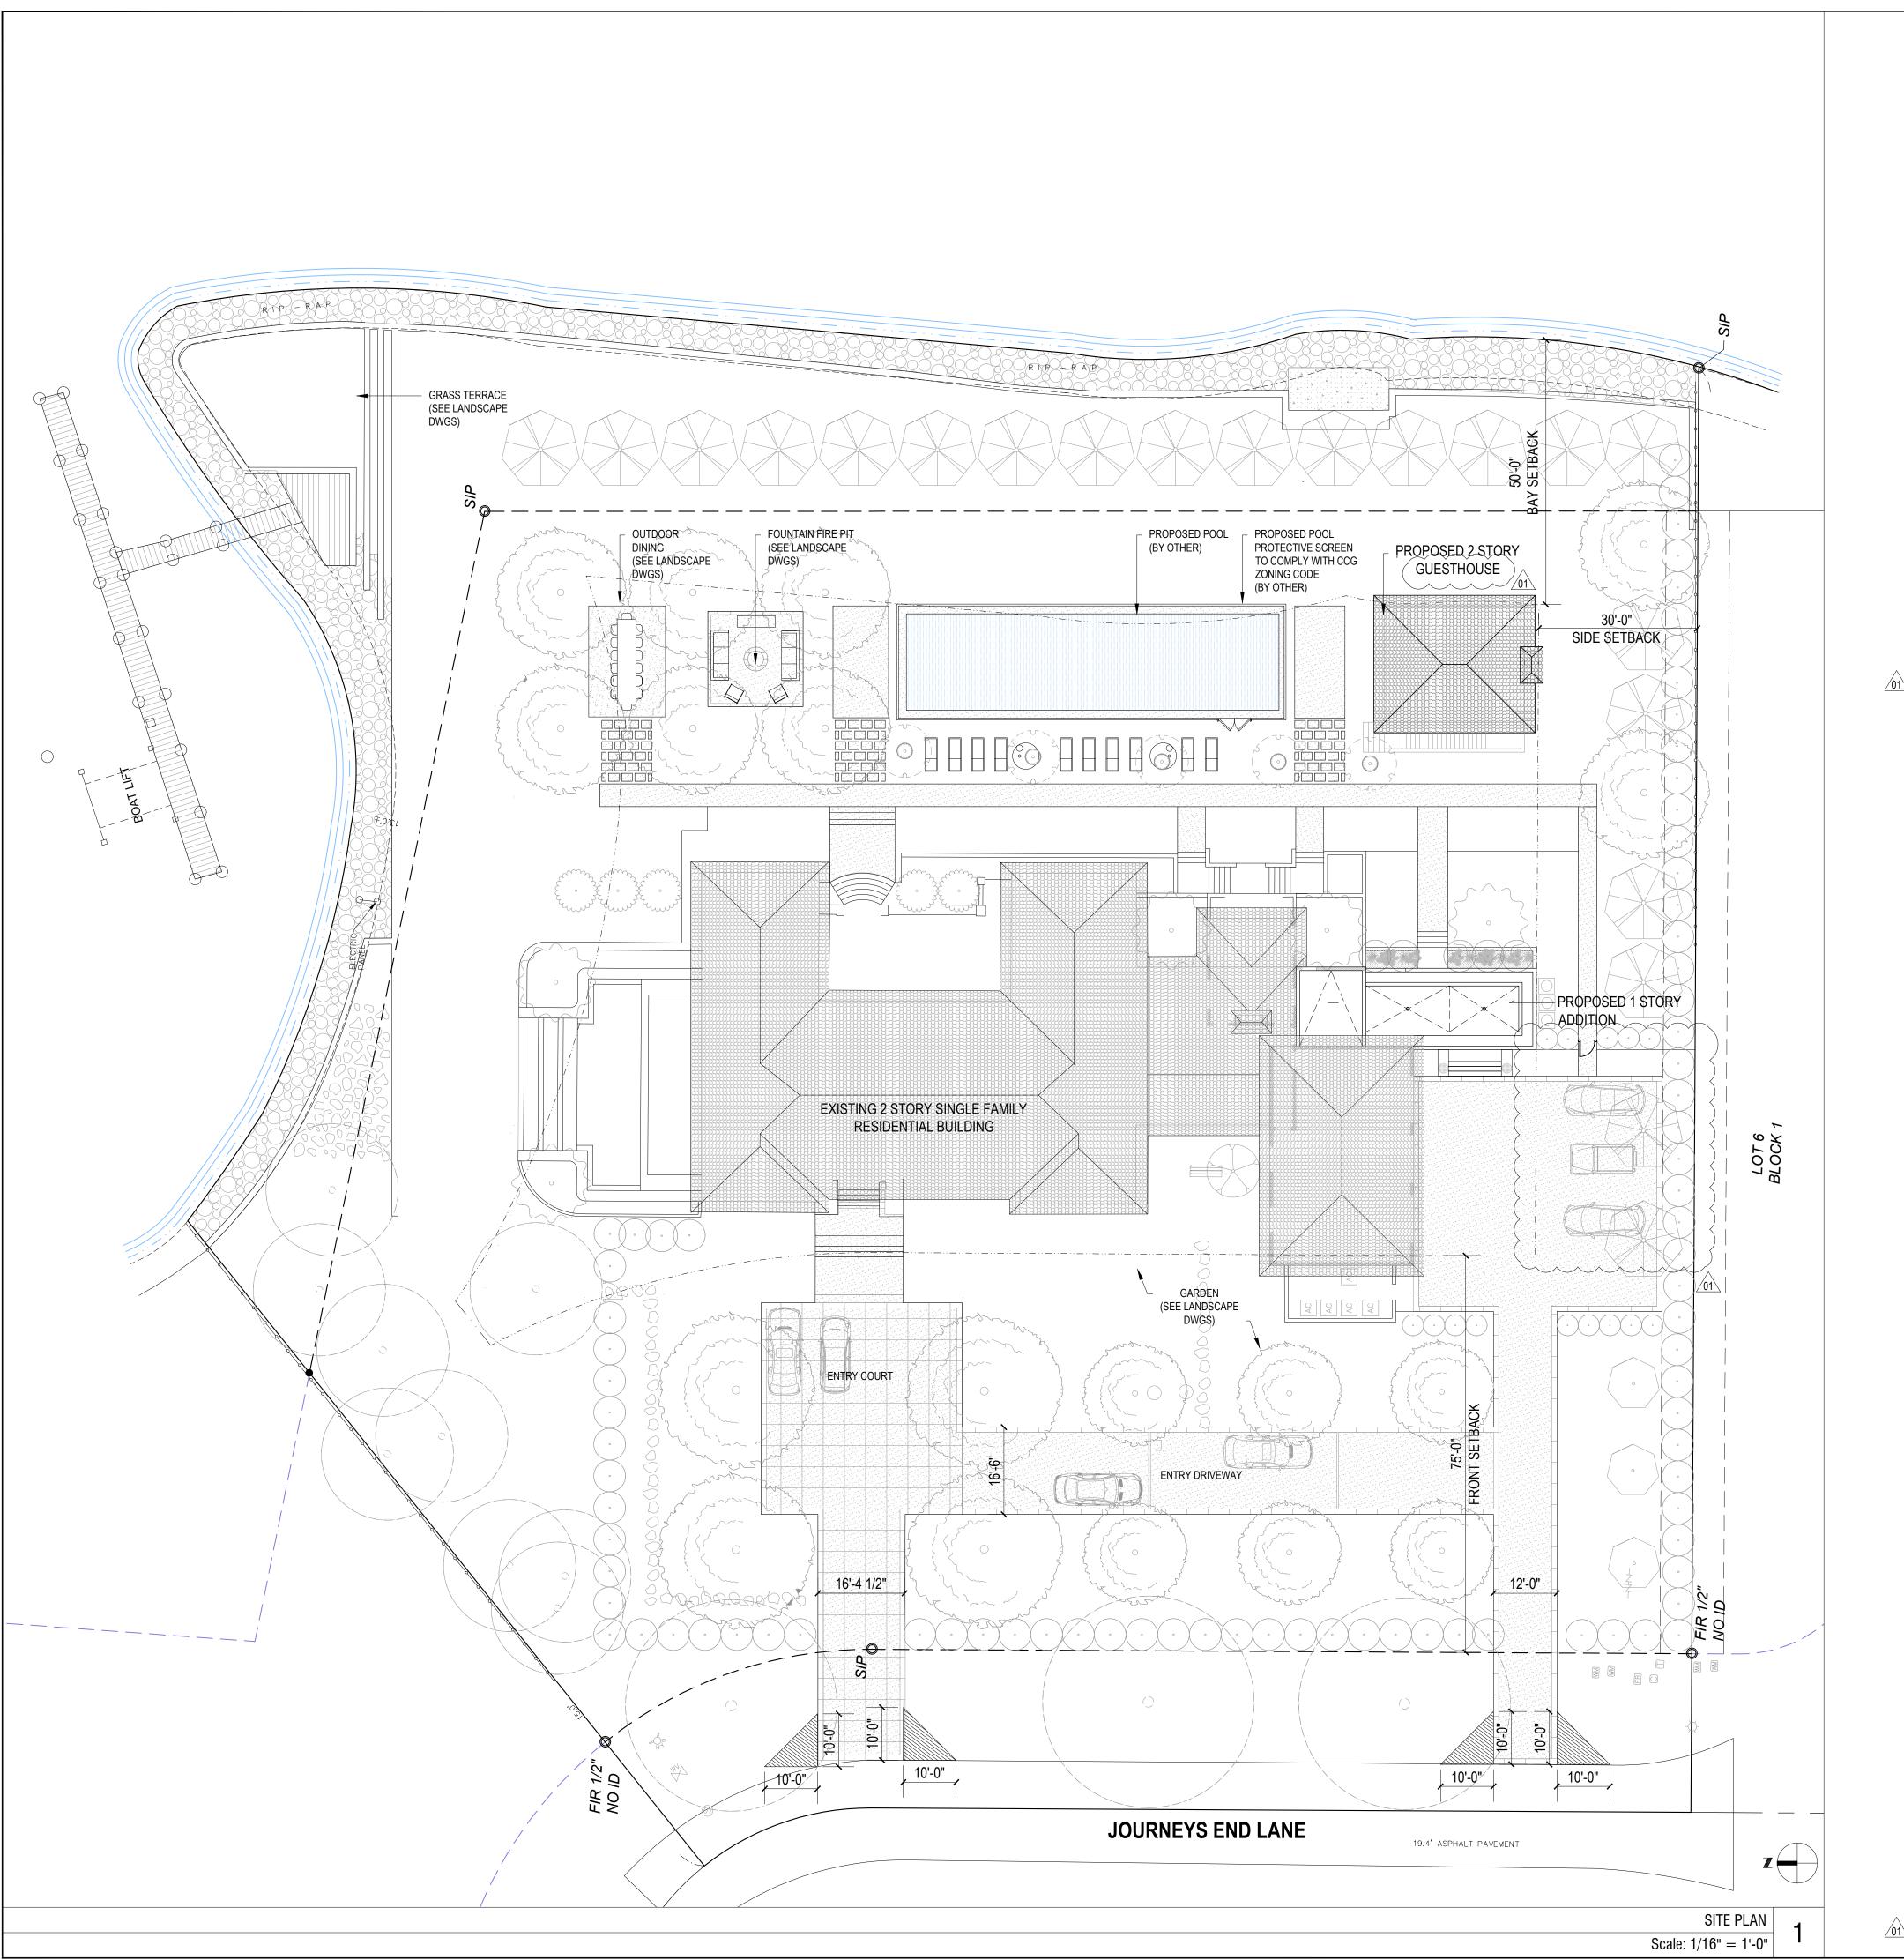

PROJECT & ZONING DATA

SITE INFORMATION:

TYPE **FOLIO NUMBER** LOT AREA

:SFR :03-5106-022-0070

:92,452 Sq.Ft LEGAL DESCRIPTION :JOURNEY'S END ESTS PB 100-40

LOT 7 BLK 1 &

PROP INT IN & TO COMMON ELEMENTS NOT SEPARATELY ASSESSED LOT SIZE IRREGULAR 92452 SQFT

OR 15136-657 0891 4

FEMA FIRM ZONE :AE-BASE FLOOD ELEVATION 11-'0"

MAX ALLOWED **PROPOSED GROUND COVERAGE:** MAIN STRUCTURE :25% (23,113 Sq.Ft) : 6,947 Sq.Ft. :5% (4,622 Sq.Ft) AUX. STRUCTURE : 1,939 Sq.Ft. **GUEST HOUSE** :10% OF MAIN(694 Sq.Ft) : 654 Sq.Ft. MAX F.A.R. MAX ALLOWED 48% OF 5,000 : 2,400 Sq. Ft 35% OF NEXT 5,000 : 1,750 Sq. Ft :24,735 Sq. Ft 30% OF REMAINING =28,885 Sq. Ft Max TOTAL F.A.R PROPOSED **PROPOSED**

:16,456 Sq. Ft. **EXISTING** SERVICE WING : 570 Sq. Ft.

GUEST HOUSE : 400 Sq. Ft. TOTAL :17,426 Sq.Ft.

LANDSCAPE OPEN SPACE MIN. REQUIRED **PROPOSED**

: 68,492 Sq.FT (74%) 40% OF BUILDING SITE

BUILDING HEIGHT: MAX ALLOWED MAX PROPOSED :25' :24' (TO EAVE) (TO EAVE)

MAIN BUILDING

REQUIRED **SETBACKS:** PROPOSED FRONT :75' :75' SIDE :30' :30' :50' :50' WATER

PROJECT TITLE:

LOPEZ RESIDENCE

STUDIO ANDA

PROJECT LOCATION:

9501 JOURNEY'S END LANE CORAL GABLES, FL 33156

PROJECT CLIENT/OWNER(S):

ANTHONY M. LOPEZ

ARCHITECT: ANA GUARACAO SERRANO LIC#: AR100664 1800 N BAYSHORE DR #402, MIAMI, FL 33132 PH: (214)708-7454

STRUCTURAL ENGINEERING:

MEP ENGINEERING:

LANDSCAPE ARCHITECT:

PROFESSIONAL SEALS:



01/14/2021 09/24/2020

B.O.A

DATE

SHEET ISSUE/ REVISION LOG

REVISION 2

REVISION 1

DESCRIPTION

3/16"-1'-0"

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PROJECT ID: DRAWN BY: 1003 AR/AG SCALE: PRINT DATE:

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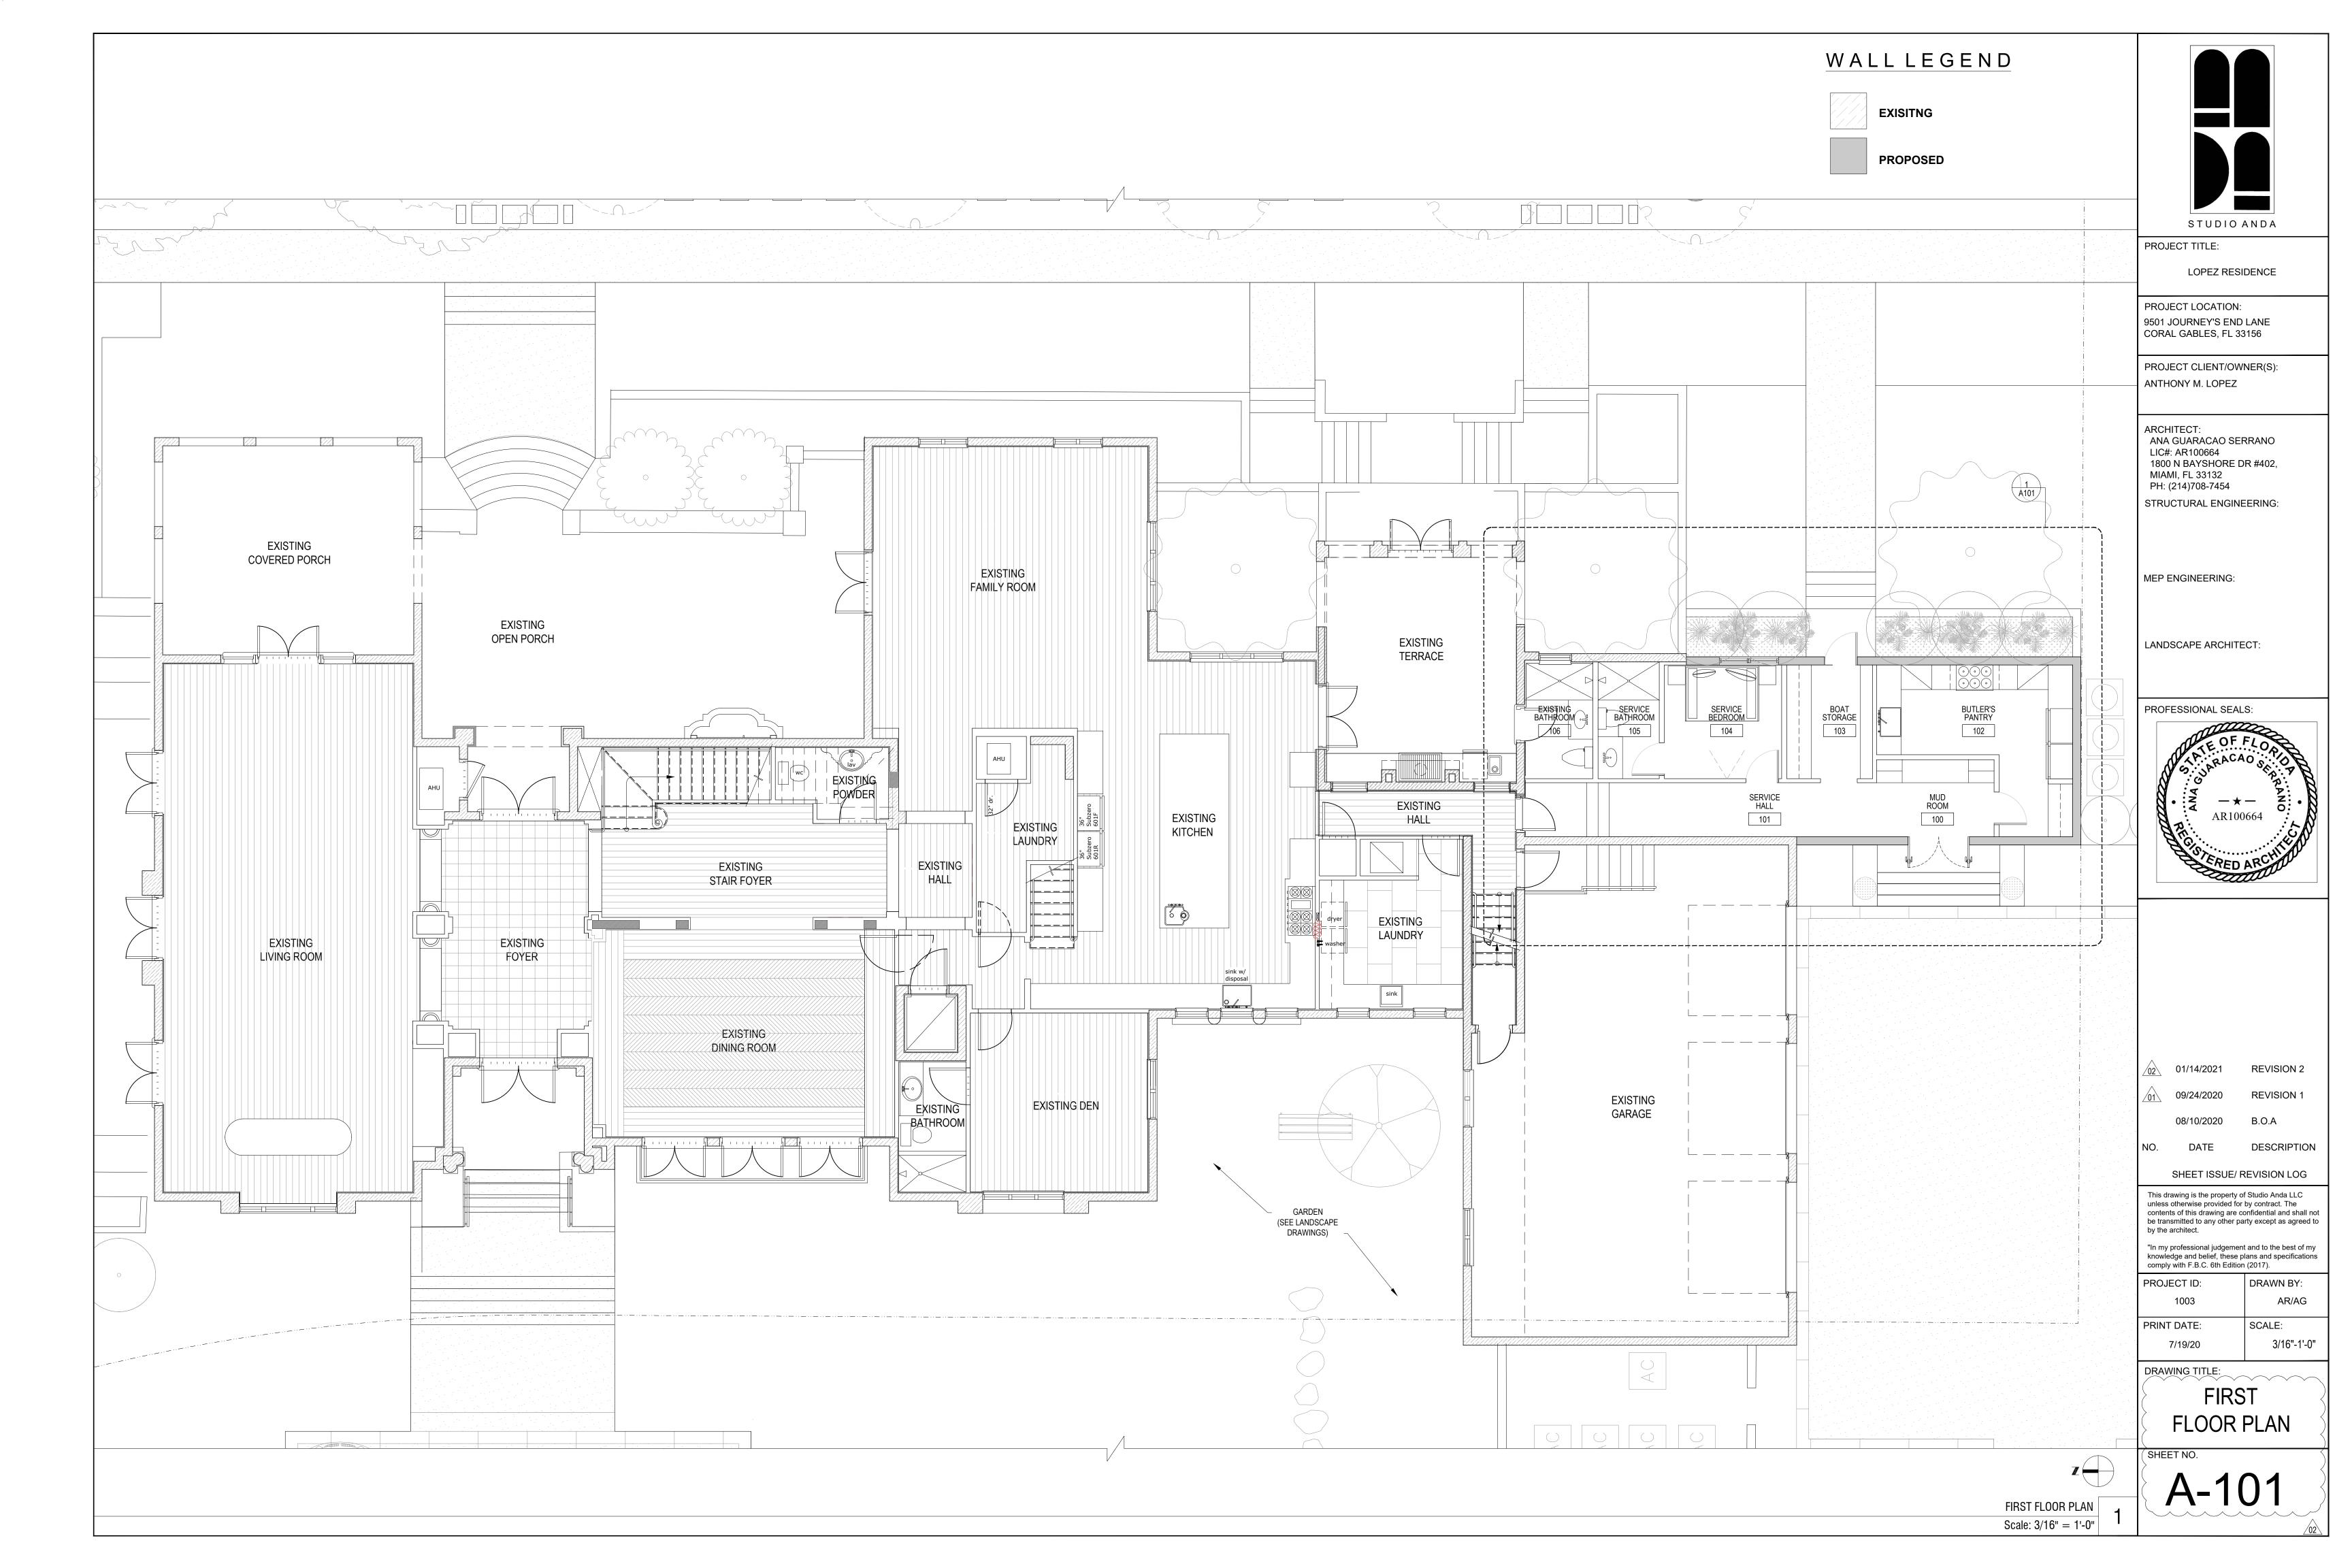
> > SITE PLAN


SHEET NO.

A-100


NOTES:

- REFER TO LANDSCAPE DRAWINGS FOR LANDSCAPE DETAILS - ALL RAINWATER MUST BE RETAINED WITHIN PRIVATE PROPERTY. - ALL REQUIREMENTS FOR LANDSCAPE AS LISTED IN ZONING CODE ARTICLE 5, DIVISION 11 WILL BE COMPLIED WITH. -ALL POOL GATES ARE SELF CLOSING AND SELF LATCHING



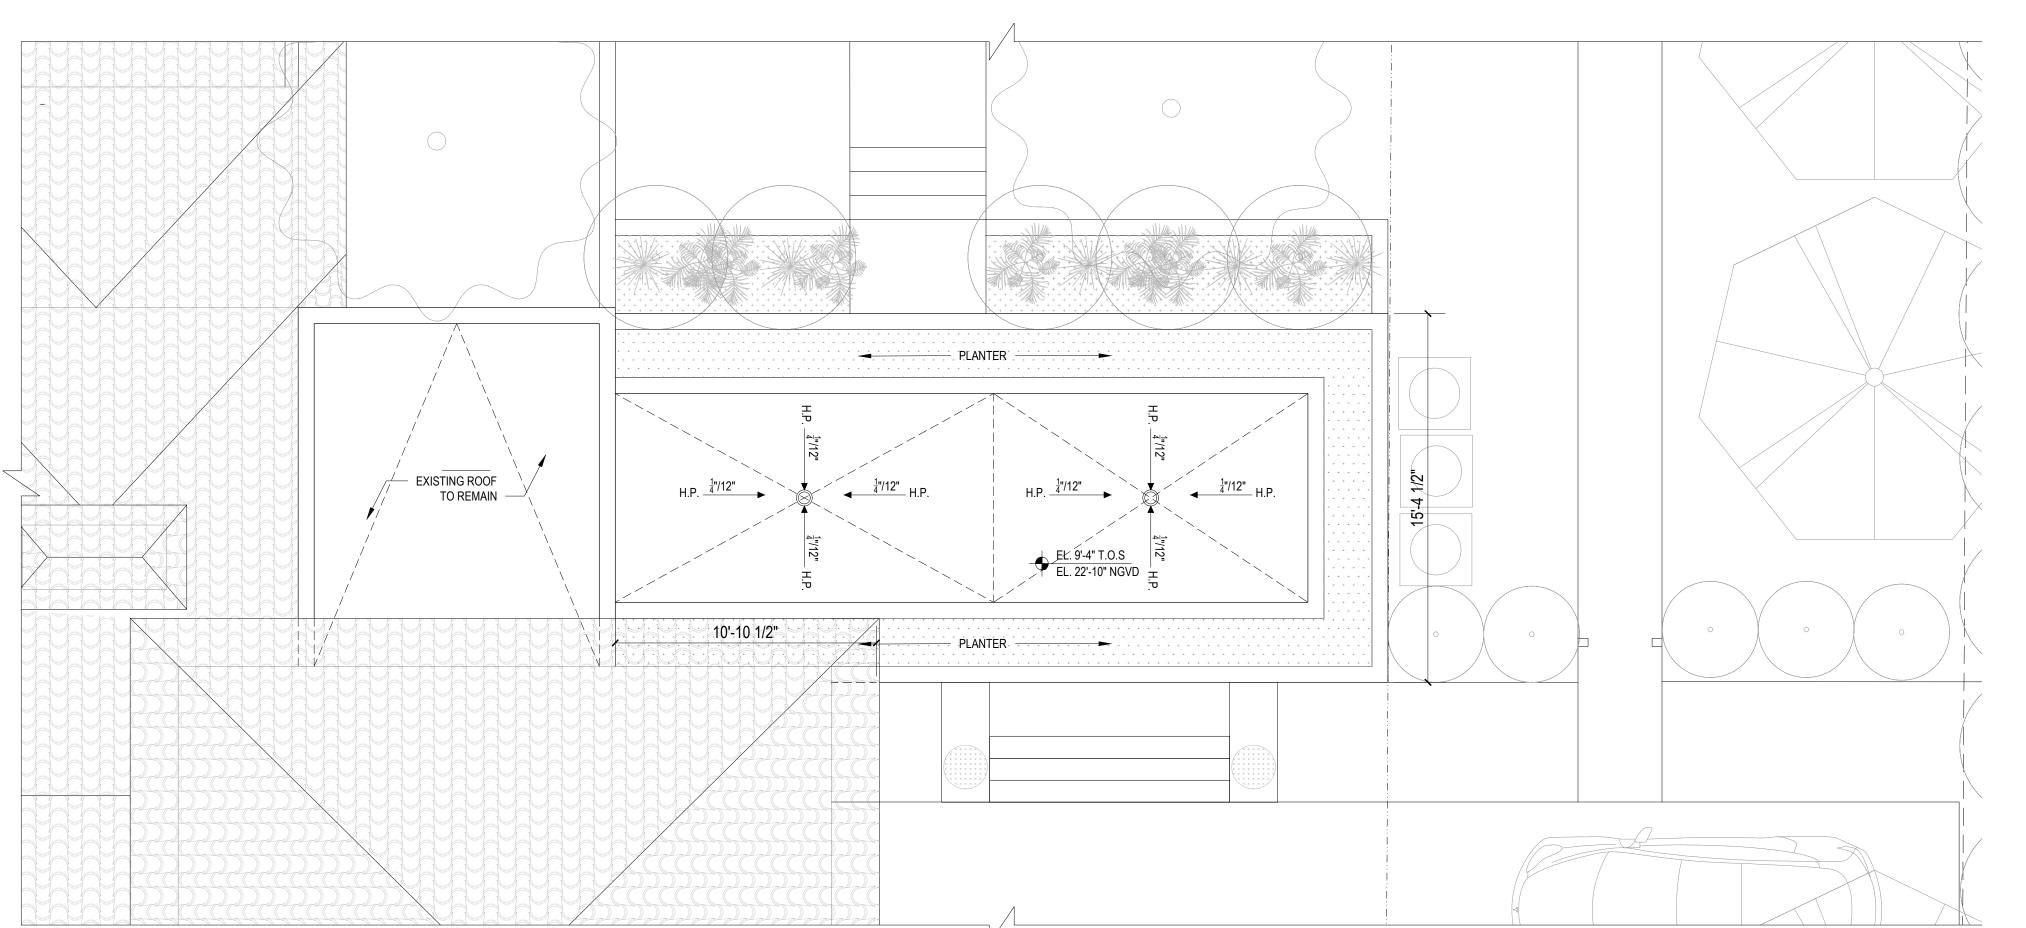


SERVICE WING ROOF PLAN Scale: 1/4" = 1'-0"

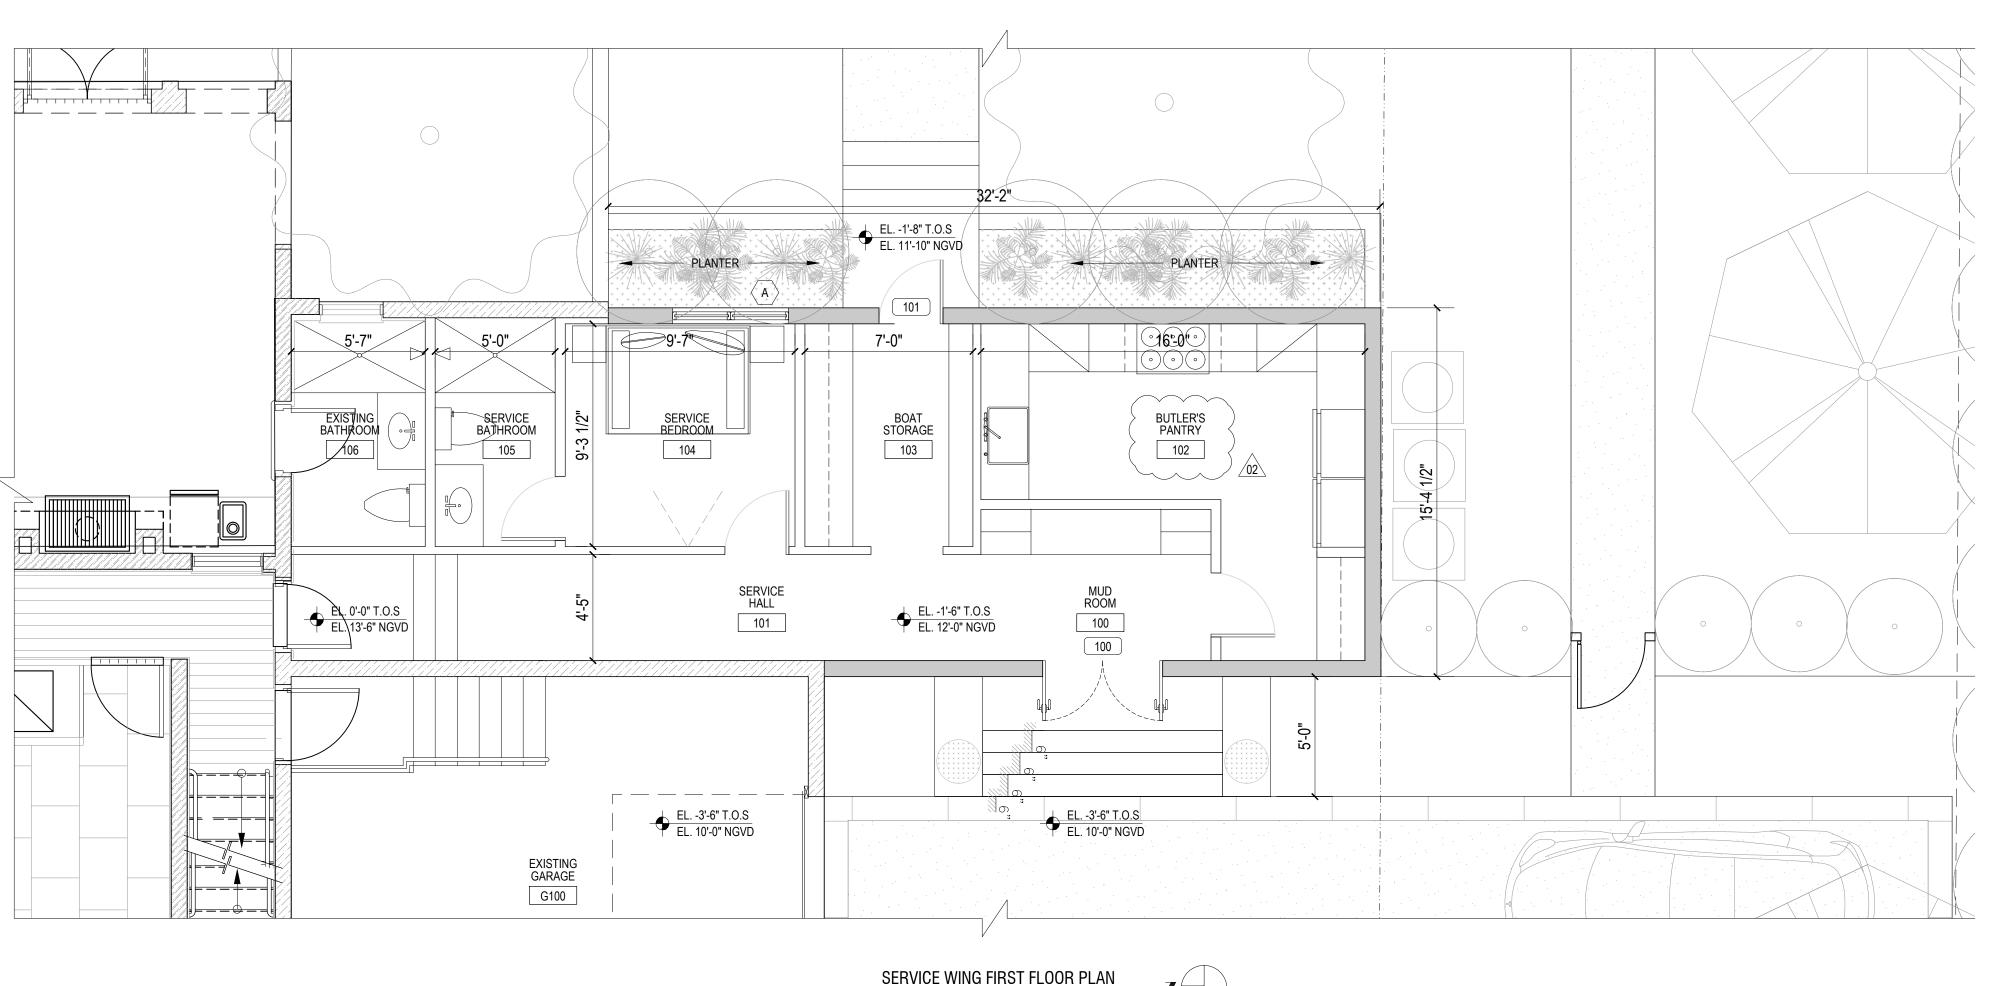

WALLLEGEND



EXISITNG

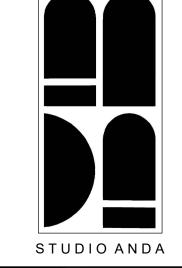

PROJECT TITLE:

LOPEZ RESIDENCE

PROJECT LOCATION: 9501 JOURNEY'S END LANE CORAL GABLES, FL 33156

PROJECT CLIENT/OWNER(S): ANTHONY M. LOPEZ

ARCHITECT: ANA GUARACAO SERRANO LIC#: AR100664 1800 N BAYSHORE DR #402, MIAMI, FL 33132 PH: (214)708-7454 STRUCTURAL ENGINEERING:

MEP ENGINEERING:

LANDSCAPE ARCHITECT:

PROFESSIONAL SEALS:



07/14/2021 **REVISION 2**

REVISION 1

<u>01</u> 09/24/2020

08/10/2020 B.O.A

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PROJECT ID:	DRAWN BY:						
1003	AR/AG						
PRINT DATE:	SCALE:						
7/19/20	1/4"-1'-0"						
	PROJECT ID: 1003 PRINT DATE:						


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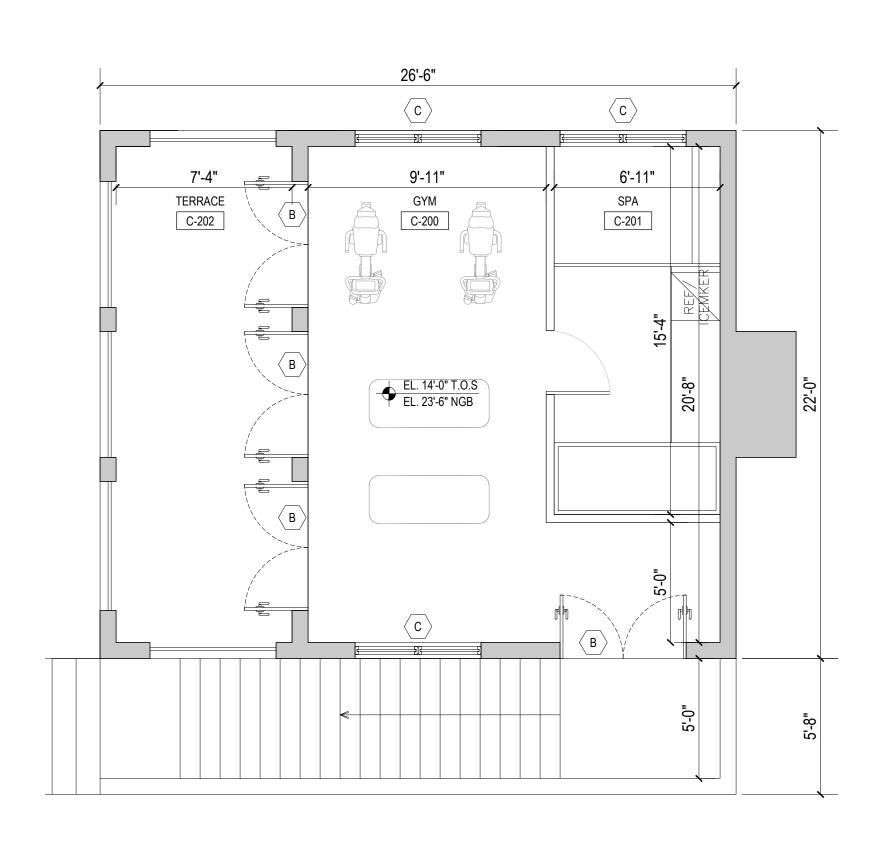
SERVICE WING FLOOR PLANS


SHEET NO.

SERVICE WING FIRST FLOOR PLAN Scale: 1/4" = 1'-0"





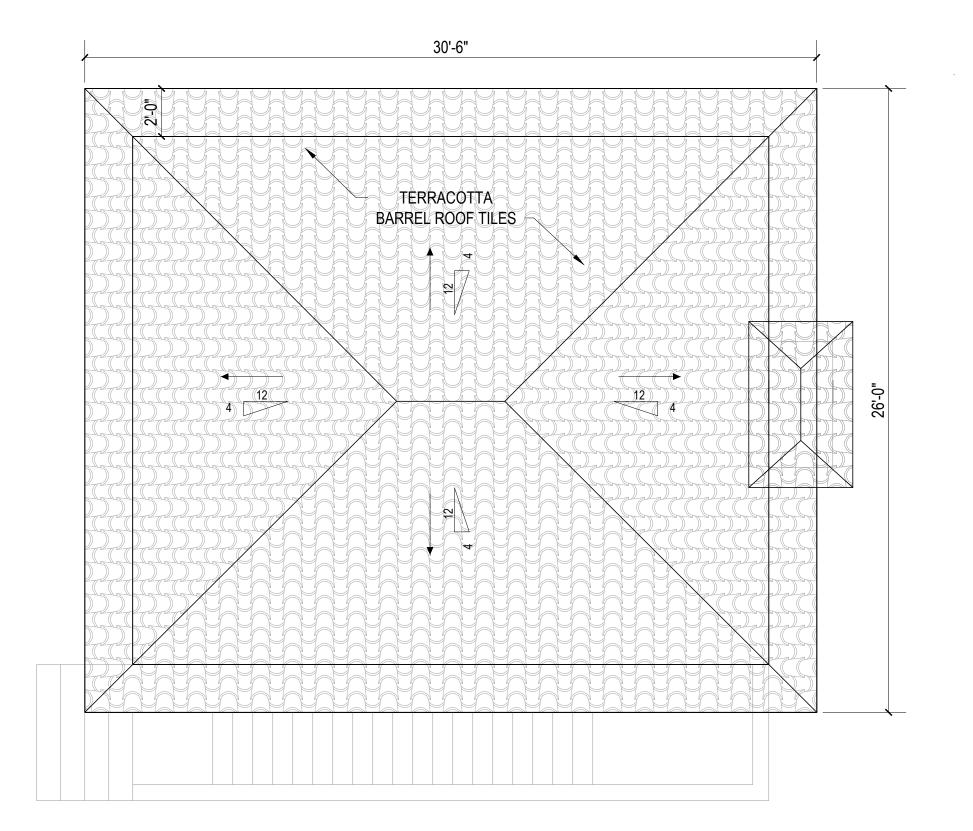


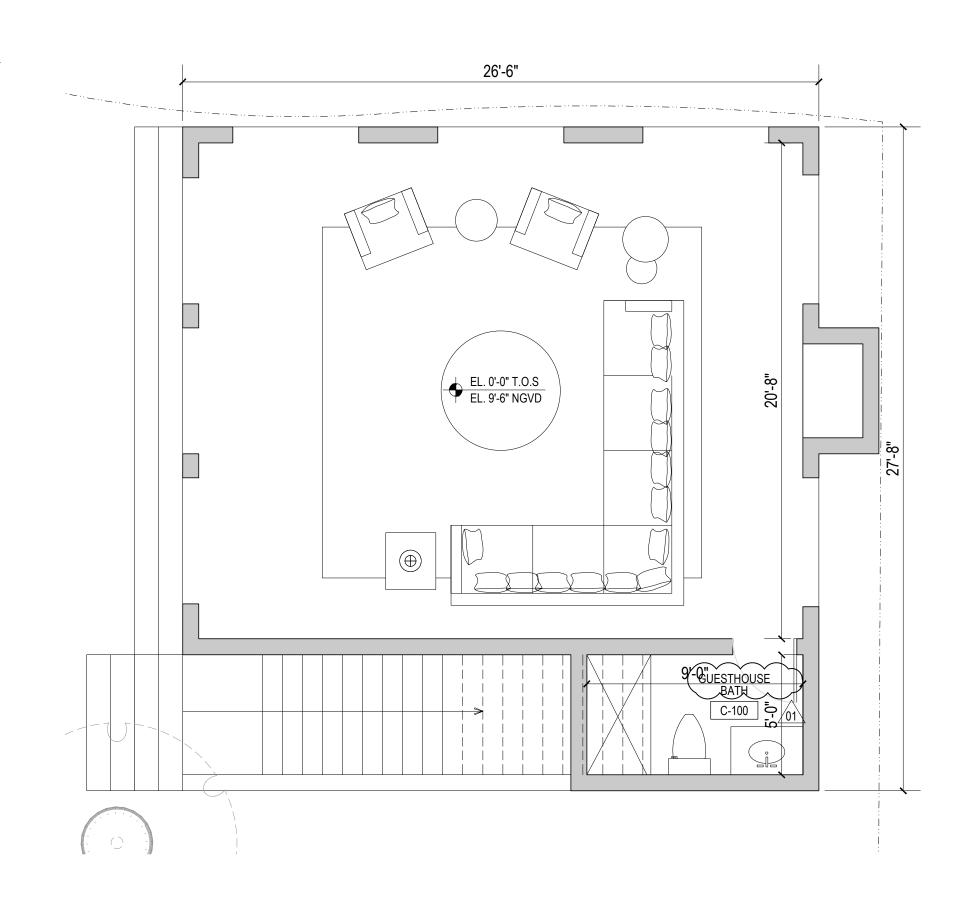

GUESTHOUSE ROOF PLAN Scale: 1/4" = 1'-0"

GUESTHOUSE SECOND FLOOR PLAN Scale: 1/4" = 1'-0"

GUEST HOUSE FIRST FLOOR PLAN Scale: 1/4" = 1'-0"

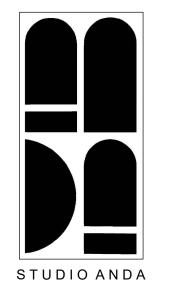

PROJECT TITLE:

LOPEZ RESIDENCE

PROJECT LOCATION: 9501 JOURNEY'S END LANE CORAL GABLES, FL 33156

PROJECT CLIENT/OWNER(S): ANTHONY M. LOPEZ

ARCHITECT: ANA GUARACAO SERRANO LIC#: AR100664 1800 N BAYSHORE DR #402, MIAMI, FL 33132 PH: (214)708-7454 STRUCTURAL ENGINEERING:

MEP ENGINEERING:

LANDSCAPE ARCHITECT:

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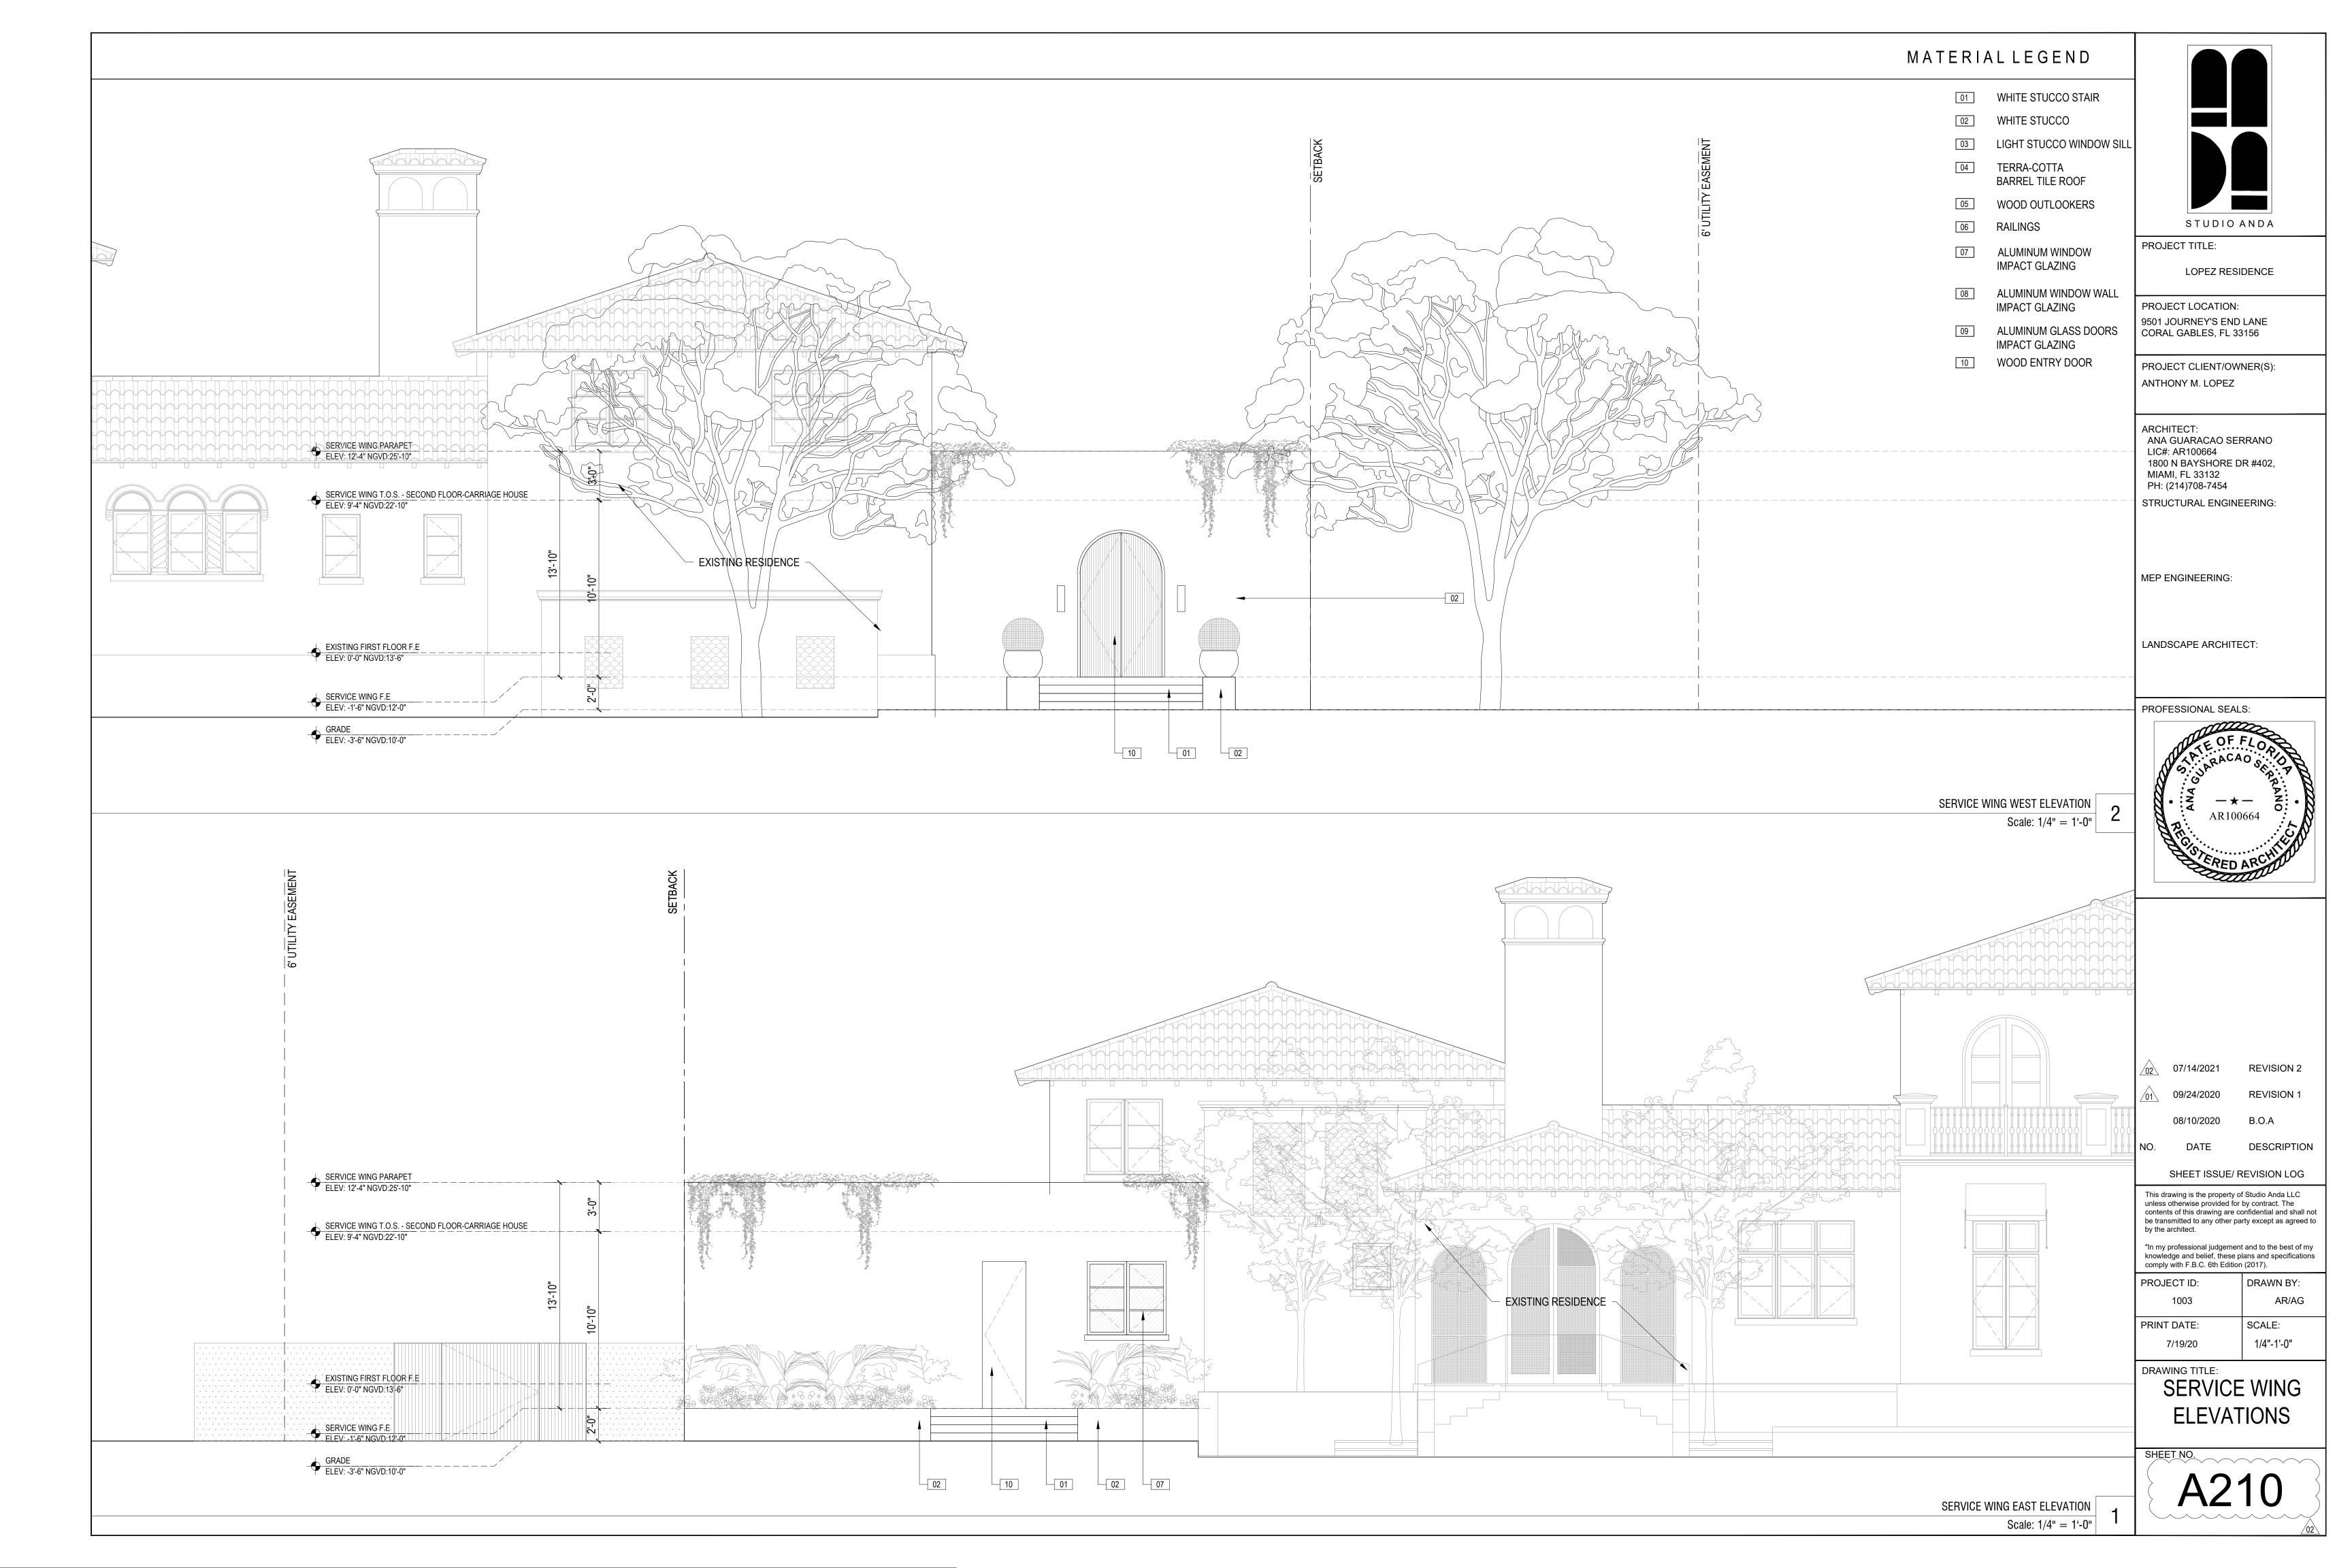
comply with F.B.C. 6th Edition (2017).						
PROJECT ID:	DRAWN BY:					
1003	AR/AG					
PRINT DATE:	SCALE:					
7/19/20	1/4"-1'-0"					


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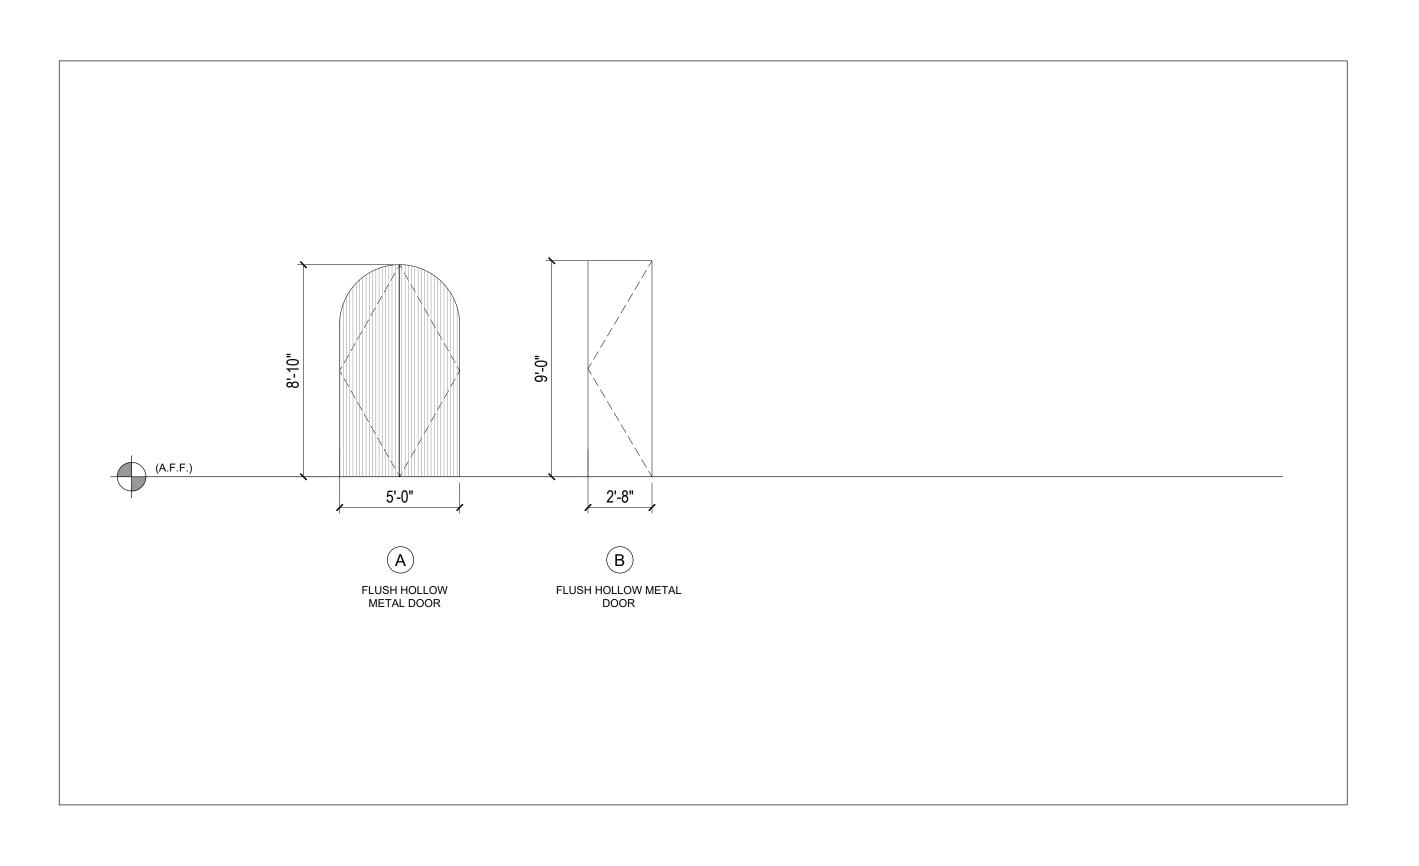
FLOOR PLANS










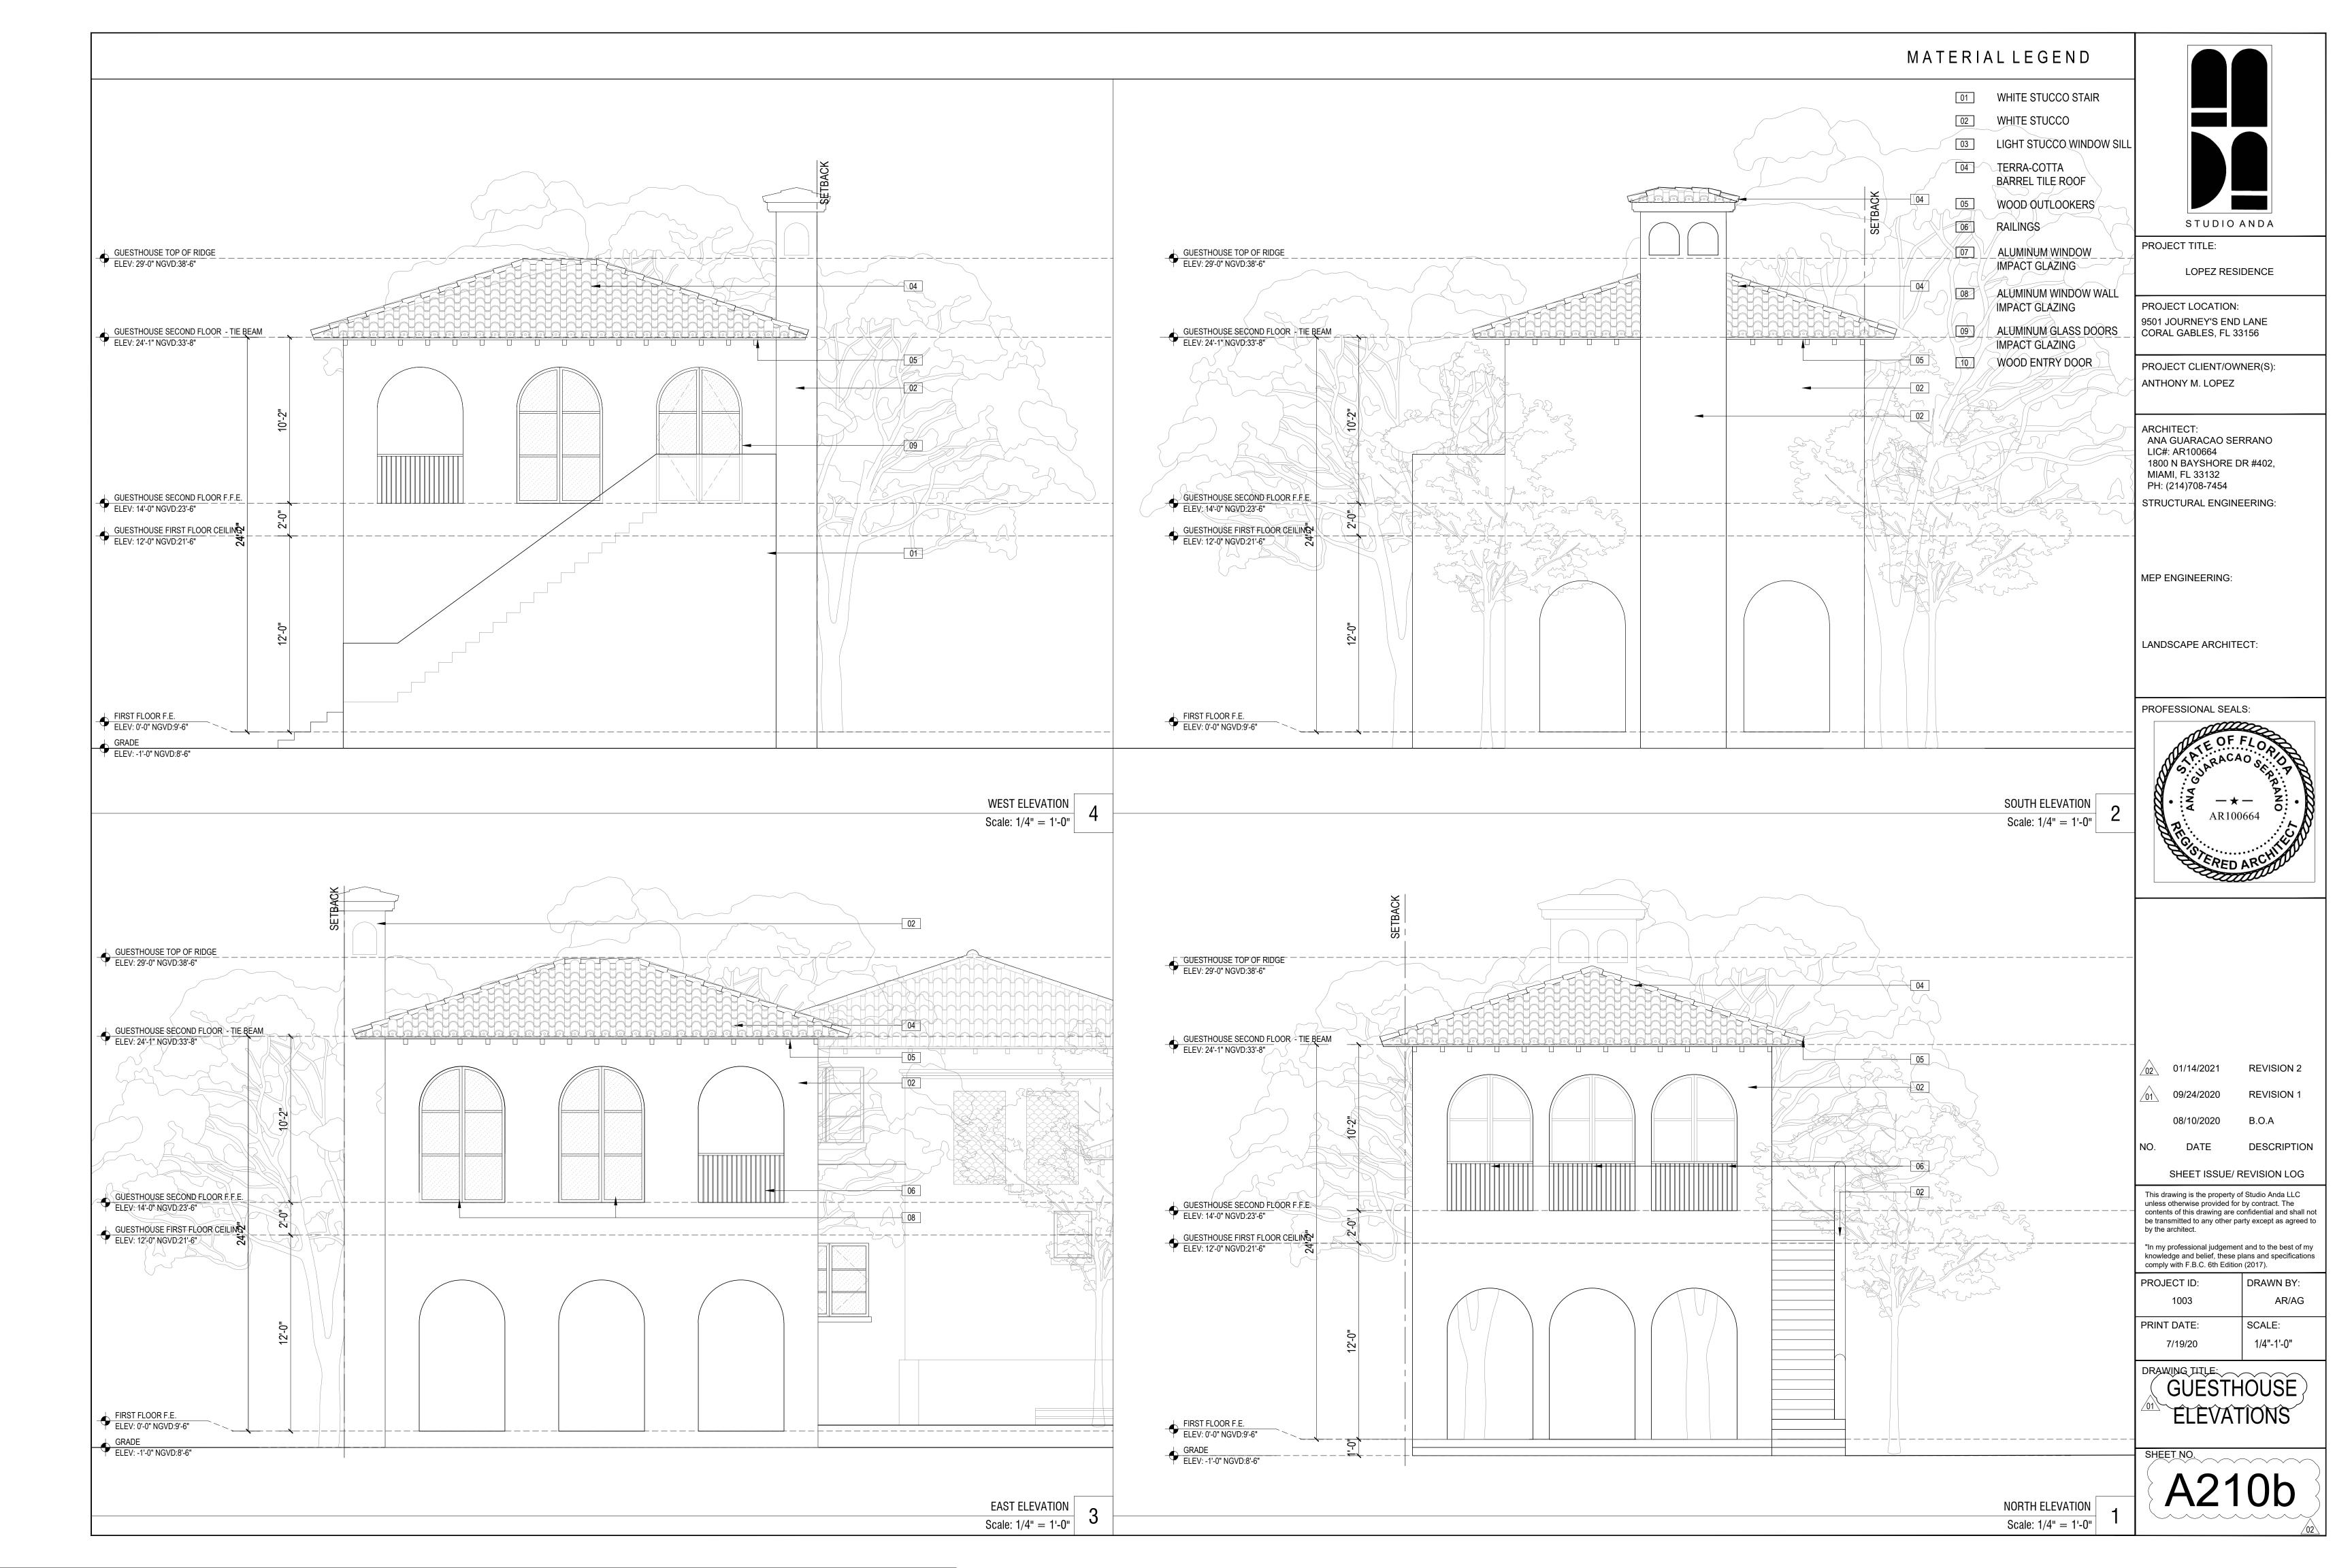

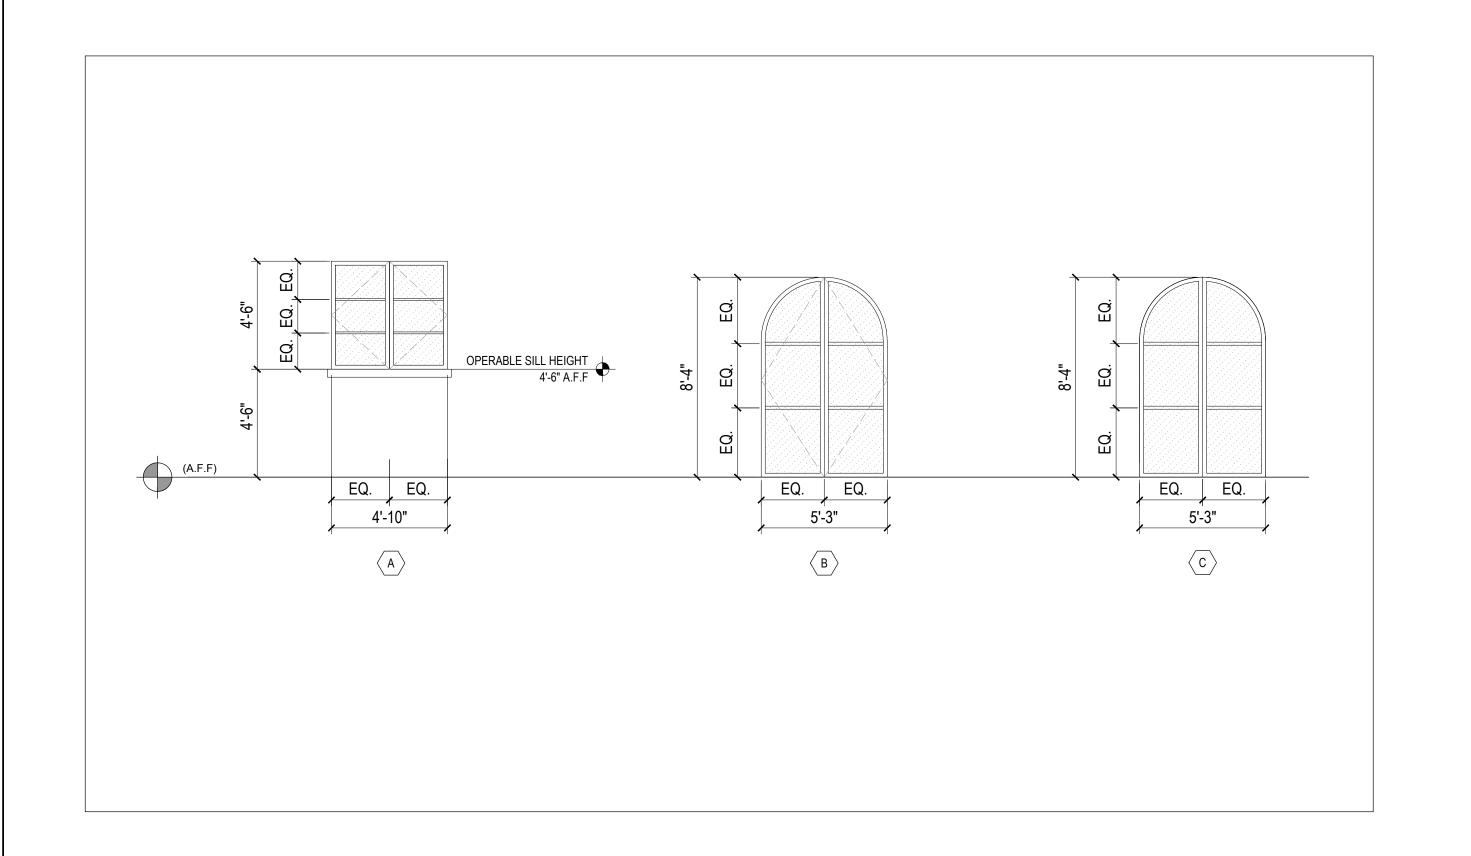

DOOR SCHEDULE

FIRST FLOOR

DOOR No.	TYPE	LOCATION	WIDTH	HEIGHT	THICKNESS	DESCRIPTION	FINISH	MANUFACTURER	APPROVALS	COMMENTS
100	Α	ENTRY	5'-0"	8'-0"	1 3/4"	SWING	HM/WOOD	S.I.W	NOA#14-0926.13	SERVICE WING ENTRY DOOR
101	В	BOAT STORAGE-EXTERIOR	2'-8"	9'-0"	2"	SWING	HM/WOOD	T.B.D	T.B.D.	

NOTE

- 1. ALL EXTERIOR DOORS SHALL MEET FLORIDA BUILDING CODE STANDARDS FOR SAFETY COMPLIANCE.
- 2. DIMENSIONS SHOWN ON THE SCHEDULE ARE APPROXIMATE AND BASED ON FINISHED OPENINGS. THEY ARE TO BE USED FOR THE REQUIRED CALCULATIONS FOR BOTH PRODUCT APPROVAL AND BIDDING. MANUFACTURER SHALL VERIFY ALL DIMENSIONS WITH THE CONTRACTOR AND SUBMIT SHOP DRAWINGS TO THE ARCHITECT AND THE CITY FOR FINAL APPROVAL BEFORE PRODUCTION ORDER IS ISSUED.
- 3. ALL SHOWER COMPARTMENT ACCESS AND EGRESS OPENINGS SHALL HAVE A MIN. CLEAR AND UNOBSTRUCTED FINISHED WIDTH OF 22 INCHES AS PER FBC P2708.1.1
- 4. ALL GLASS SHOWER ENCLOSURES AND GLASS GUARDRAILS SHALL BE SAFETY CATEGORY 2.
- 5. ANY DOORS LOCATED BELOW THE DESIGN FLOOD ELEVATION MUST BE FLOOD RESISTANT. EX:GARAGE DOORS, STORAGE ROOM DOORS.

GLAZING SCHEDULE

SAFETY GLASS ASS
ASS

NOTES

- 1. ALL EXTERIOR DOORS SHALL MEET FLORIDA BUILDING CODE STANDARDS FOR SAFETY COMPLIANCE.
- 2. APERTURES SHOWN MUST MEET OR EXCEED FLORIDA ENERGY CODE SECTION 7-D AS PREPARED EXCLUSIVELY FOR THE PROJECT
- 3. DIMENSIONS SHOWN ON THE SCHEDULE ARE APPROXIMATE AND BASED ON FINISHED OPENINGS. THEY ARE TO BE USED FOR THE REQUIRED CALCULATIONS FOR BOTH PRODUCT APPROVAL AND BIDDING. MANUFACTURER SHALL VERIFY ALL DIMENSIONS WITH THE CONTRACTOR AND SUBMIT SHOP DRAWINGS TO THE ARCHITECT AND THE CITY FOR FINAL APPROVAL BEFORE PRODUCTION ORDER IS ISSUED.
- 4. ALL BEDROOM EGRESS WINDOWS SHALL BE OPERABLE FROM INSIDE WITHOUT THE USE OF TOOLS AND HAVE A CLEAR MIN. WIDTH OF 20", MIN 24" IN HEIGHT. TOTAL CLEAR AREA OF 5.7 SQ.FT.
- 5. GLASS AREA IN WINDOWS 42" A.F.F. THAT ARE LOCATED ABOVE GRADE DROPS > 30" SHALL PASS ANSI TEST: Z97.1 1984.
- 6. WINDOWS WITH SILL HEIGHT LESS THAN 36" AND WITH A DROP MORE THAN 4' ON THE FAR SIDE SHALL BE PROVIDED WITH SAFEGUARDS.
- 7. ALL EXTERIOR GLASS SHOULD MEET MIAMI-DADE COUNTY MISSILE IMPACT RATINGS. NO SHUTTERS HAVE BEEN SPECIFIED FOR USE ON THIS PROJECT, CONTRACTOR SHALL SUBMIT NOTICE OF ACCEPTANCE WITH SHOP DRAWINGS OR APPROVAL.
- 8. ALL GLASS SHALL ACHIEVE A MIN. U-VALUE OF 1.10 AND MIN. SOLAR HEAT GAIN COEFFICIENT OF .50, SEE ENERGY SHEET CALCULATIONS
- 9. STRUCTURAL MEMBERS SHOWN ARE NOT PROVIDED IN THE APERTURE PACKAGE AND CONTRACTOR SHALL COORDINATE WITH STRUCTURAL. STRUCTURAL MEMBERS
- 10. GLAZING IN WINDOWS WHERE THE BOTTOM EDGE OF THE GLAZING IS UNDER 18" ABOVE THE FINISH FLOOR SHALL BE CATEGORY II SAFETY GLASS.FBC R 308.4.3
- 11. EXTERIOR DOOR AND SIDELIGHTS SHALL HAVE CATEGORY II SAFETY GLASS. FBC R 308.4.1.



PROJECT TITLE:

LOPEZ RESIDENCE

PROJECT LOCATION:

9501 JOURNEY'S END LANE
CORAL GABLES, FL 33156

PROJECT CLIENT/OWNER(S):
ANTHONY M. LOPEZ

ARCHITECT:
ANA GUARACAO SERRANO
LIC#: AR100664
1800 N BAYSHORE DR #402,
MIAMI, FL 33132
PH: (214)708-7454
STRUCTURAL ENGINEERING:

MEP ENGINEERING:

LANDSCAPE ARCHITECT:

PROFESSIONAL SEALS:



02 01/14/2021 REVISION 2

01 09/24/2020 REVISION 1

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PROJECT ID:
DRAWN BY:
AR/AG

PRINT DATE:
SCALE:
7/19/20

DRAWING TITLE:

DOOR & WINDOW SCHEDULE

SHEET NO

A-600

GENERAL LANDSCAPE NOTES:

- A. The scope of work includes all labor, materials, appliances, tools, equipment, facilities, transportation and services necessary for, and incidental to performing all operations in connection with furnishing, delivery, and installation of plant (also known as "landscaping") complete as shown on the drawings and as specified herein.
- A. All scaled dimensions on the drawings are approximate. Before proceeding with any work, the Contractor shall carefully check and verify all dimensions and quantities, and shall immediately inform the Owner's Representative of any discrepancies between the information on the drawings and the actual conditions, refraining from doing any work in said areas until given approval to do so by the Owner's Representative.
- B. In the case of a discrepancy in the plant quantities between the plan drawings and the plant call outs, list or plant schedule, the number of plants or square footage of the planting bed actually drawn on the plan drawings shall be deemed correct and prevail.
- 3. PERMITS AND REGULATIONS
- A. The Contractor shall obtain and pay for all permits related to this section of the work unless previously excluded under provision of the contract or
- B. The contractor shall perform all work in accordance with all local, state and federal regulations. If the Contractor observes that a conflict exists between permit requirements and the work outlined in the contract documents, the Contractor shall promptly notify the Owner's Representative in writing including a description of any necessary changes and changes to the contract price resulting from changes in the work.
- 4. PROTECTION OF WORK, PROPERTY AND PERSON
- A. The Contractor shall adequately protect the work, adjacent property, and the public, and shall be responsible for any damages or injury due to his/her
- 5. CHANGES IN THE WORK
- A. The Owner's Representative may order changes in the work, and the contract sum should be adjusted accordingly. All such orders and adjustments plus claims by the Contractor for extra compensation must be made and approved in writing before executing the work involved.
- A. The Contractor, at their own cost, shall re-execute any work that fails to conform to the requirements of the contract and shall remedy defects due to faulty materials or workmanship upon written notice from the Owner's Representative, at the soonest as possible time that can be coordinated with other work and seasonal weather demands.
- 7. OBSERVATION OF WORK
- A. Contractor shall provide digital photographic documentation during installation for Owner's Representative review, daily. B. The Owner's Representative may observe the work at any time. They may remove samples of materials for conformity to specifications. Rejected materials shall be immediately removed from the site and replaced at the Contractor's expense. The cost of testing materials not meeting specifications
- shall be paid by the Contractor. C. Contractor shall field stake the location of all plant material prior to initiating installation for the review and approval of the Owner and/or Landscape
- D. The Owner's Representative shall be informed of the progress of the work so the work may be observed at the following key times in the construction process. The Owner's Representative shall be afforded sufficient time to schedule visit to the site. Failure of the Owner's Representative to make field
- observations shall not relieve the Contractor from meeting all the requirements of this specification.
- 1. SITE CONDITIONS PRIOR TO THE START OF PLANTING: review the soil and drainage conditions. 2. COMPLETION OF THE PLANT LAYOUT STAKING: Review of the plant layout.
- 3. PLANT QUALITY: Review of plant quality at the time of delivery and prior to installation. Review tree quality prior to unloading where possible, but in
- 4. INSTALLATION OF TREES: Oversee tree installation to specify desired rotation and tilt of each tree 5. COMPLETION OF THE PLANTING: Review the completed planting.
- 8. PRE-CONSTRUCTION CONFERENCE
- A. Schedule a pre-construction meeting with the Owner's Representative at least seven (7) days before beginning work to review any questions the Contractor may have regarding the work, administrative procedures during construction and project work schedule.
- 9. QUALITY ASSURANCE
- A. Substantial Completion Acceptance Acceptance of the work prior to the start of the warranty period:
 - 1. Once the Contractor completes the installation of all items in this section, the Owner's Representative will observe all work for Substantial Completion Acceptance upon written request of the Contractor. The request shall be received at least ten calendar days before the anticipated date of
- 2. Substantial Completion Acceptance by the Owner's Representative shall be for general conformance to specified size, character and quality and not relieve the Contractor of responsibility for full conformance to the contract documents, including correct species. 3. Any plants that are deemed defective as defined under the provisions below shall not be accepted.
- B. The Owner's Representative will provide the Contractor with written acknowledgment of the date of Substantial Completion Acceptance and the beginning of the warranty period.
- Installer Qualifications: The installer shall be a firm having at least 5 years of successful experience of a scope similar to that required for the work, including the handling and planting of large specimen trees in urban areas. The same firm shall install planting soil (where applicable) and plant material The bidders list for work under this section shall be approved by the Owner's Representative.
- Installer Field Supervision: When any planting work is in progress, installer shall maintain, on site, a full-time supervisor who can communicate in
- 3. Installer's field supervisor shall have a minimum of five years experience as a field supervisor installing plants and trees of the quality and scale of the proposed project, and can communicate in English with the Owner's Representative. 4. The installer's crew shall have a minimum of 3 years experienced in the installation of Planting Soil, Plantings, and Irrigation (where applicable) and
- interpretation of soil plans, planting plans and irrigation plans. 5. Submit references of past projects, employee training certifications that support that the Contractors meets all of the above installer qualifications
- 10. PLANT WARRANTY
- A. Plant Warranty:
- 1. The Contractor is responsible to ensure proper watering and maintenance of new and relocated materials during the warranty period. 2. The Contractor agrees to replace defective work and defective plants. The Owner's Representative shall make the final determination if plants meet these specifications or that plants are defective. 3. The Contractor shall be responsible for the guarantee of all plant material for a period of twelve (12) months from the date of substantial completion.
- Substantial completion constitutes the beginning of guarantee period.
- 11. SELECTION AND OBSERVATION OF PLANTS
- A. All planting materials shall meet or exceed Florida Grade # 1 as specified in Grades and Standards for Nursery Plants and Part II, Palms and Trees,
- B. The Owner's Representative may review all plants subject to approval of size, health, quality, character, etc. Review or approval of any plant during the process of selection, delivery, installation and establishment period shall not prevent that plant from later rejection in the event that the plant quality changes or previously existing defects become apparent that were not observed.
- C. Plant Selection: The Owner's Representative reserves the right to select and observe all plants at the nursery prior to delivery and to reject plants that do not meet specifications as set forth in this specification. If a particular defect or substandard element can be corrected at the nursery, as determined by the Owner's Representative, the agreed upon remedy may be applied by the nursery or the Contractor provided that the correction allows the plant to meet the requirements set forth in this specification. Any work to correct plant defects shall be at the contractor's expense.
- 1. The Owner's Representative may make invasive observation of the plant's root system in the area of the root collar and the top of the root ball in general in order to determine that the plant meets the quality requirements for depth of the root collar and presence of roots above the root collar. Such observations will not harm the plant.
- 2. Corrections are to be undertaken at the nursery prior to shipping. D. The Contractor shall bear all cost related to plant corrections.
- E. All plants that are rejected shall be immediately removed from the site and acceptable replacement plants provided at no cost to the Owner.
- F. Where requested by the Owner's Representative, submit photographs of plants or representative samples of plants. Photographs shall be legible and clearly depict the plant specimen. Each submitted image shall contain a height reference, such as a measuring stick. The approval of plants by the Owner's Representative via photograph does not preclude the Owner's Representative's right to reject material while on site.
- 12. PLANT SUBSTITUTIONS FOR PLANTS NOT AVAILABLE
- A. Submit all requests for substitutions of plant species, or size to the Owner's Representative, for approval, prior to purchasing the proposed substitution. Request for substitution shall be accompanied with a list of nurseries contacted in the search for the required plant and a record of other attempts to locate the required material. Requests shall also include sources of plants found that may be of a smaller or larger size, or a different shape or habit than specified, or plants of the same genus and species but different cultivar origin, or which may otherwise not meet the requirements of the specifications, but which may be available for substitution.
- 13. SITE CONDITIONS
- A. It is the responsibility of the Contractor to be aware of all surface and sub-surface conditions, and to notify the Owner's Representative, in writing, of any circumstances that would negatively impact the health of plantings ie., compacted soil / subgrade, poor drainage, unconsolidated soil, erosion, insufficient rooting space. Do not proceed with work until unsatisfactory conditions have been corrected.
- B. Should subsurface drainage or soil conditions be encountered which would be detrimental to growth or survival of plant material, the Contractor shall notify the Owner's Representative in writing, stating the conditions and submit a proposal covering cost of corrections. If the Contractor fails to notify the Owner's Representative of such conditions, he/she shall remain responsible for plant material under the warranty clause of the specifications.
- C. It is the responsibility of the Contractor to be familiar with the local growing conditions, and if any specified plants will be in conflict with these conditions. Report any potential conflicts, in writing, to the Owner's Representative.
- 14. PLANTING AROUND UTILITIES

9501 Journey's End Ln

A. Contractor shall carefully examine the civil, record, and survey drawings to become familiar with the existing underground conditions before digging. B. Determine location of underground utilities and perform work in a manner that will avoid possible damage. Hand excavate, as required. Maintain grade stakes set by others until parties concerned mutually agree upon removal.

ABBREVIATIONS LIST

APPROX APPROXIMATE ARCHITECT **AVG AVERAGE** B&B BALLED AND BURLAPPED BC BOTTOM OF CURB **BLDG** BUILDING **BENCHMARK BACK OF CURB BOTTOM OF RAMP BOTTOM OF STEP BOTTOM OF WALL**

CALIPER

CATCH BASIN **CUBIC FEET** CIP CAST IN PLACE CENTER LINE CLEARANCE CENTIMETER **CLEAN OUT** CONTINUOUS

CY CUBIC YARD DEG DEGREE **DEMO** DEMOLISH, DEMOLITION DIA DIAMETER DIM DIMENSION DET DETAIL DWG DRAWING

EACH **ELEVATION ENG ENGINEER** EQ **EQUAL EST ESTIMATE** E.W. EACH WAY **EXIST EXISTING**

EXP EXPANSION, EXPOSED FFE FINISHED FLOOR ELEVATION FG FINISHED GRADE

FLOW LINE FACE OF CURB FOOT(FEET) FOOTING GALLON **GAUGE GENERAL**

GRADE ELEVATION HORIZ HORIZONTAL **HIGH POINT** HEIGHT INSIDE DIAMETER INVERT ELEVATION INCH(ES) INCLUDE(D) JOINT

LINEAR FEET LOW POINT MAXIMUM MIN MINIMUM **MISCELLANEOUS** NORTH NOT IN CONTRACT NO NUMBER

NOM NOMINAL NTS NOT TO SCALE OC ON CENTER OD **OUTSIDE DIAMETER** PC POINT OF CURVATURE PΕ POLYURETHANE

POINT OF INTERSECTION PROPERTY LINE POINT, POINT OF TANGENCY PVC POLY VINYL CHOLRIDE QTY QUANTITY

RADIUS **REF REFERENCE** REINF REINFORCED REQ'D REQUIRED REVISION, REVISED ROW RIGHT OF WAY SOUTH SAN SANITARY

SD STORM DRAIN SQUARE FOOT (FEET SHT SHEET SIM **SIMILAR** SPECIFICATIONS STORM SEWER **SQUARE YARD** STA STATION STD STANDARD SYM SYMMETRICAL

T&B TOP AND BOTTOM **TBC** TOP OF BACK OF CURB TC TOP OF CURB TOP OF FOOTING TH THICK **TOPOGRAPHY** TR TOP OF RAMP TOP OF STEP TW TOP OF WALL TYP **TYPICAL**

WELDED WIRE FABRIC

VAR VARIES VOL VOLUME WITH W/O WITHOUT WT WEIGHT WL WATER LEVEL WWF

YD YARD ΑT

Journey's End Residence

9501 Journey's End Ln Coral Gables, Site State/Province


SUBMITTAL TYPE:

CONSTRUCTION DOCUMENTS

PREPARED BY:

1330 West Ave, ste 512 Miami Beach FL, 33139 PREPARED FOR:

ANTHONY LOPEZ

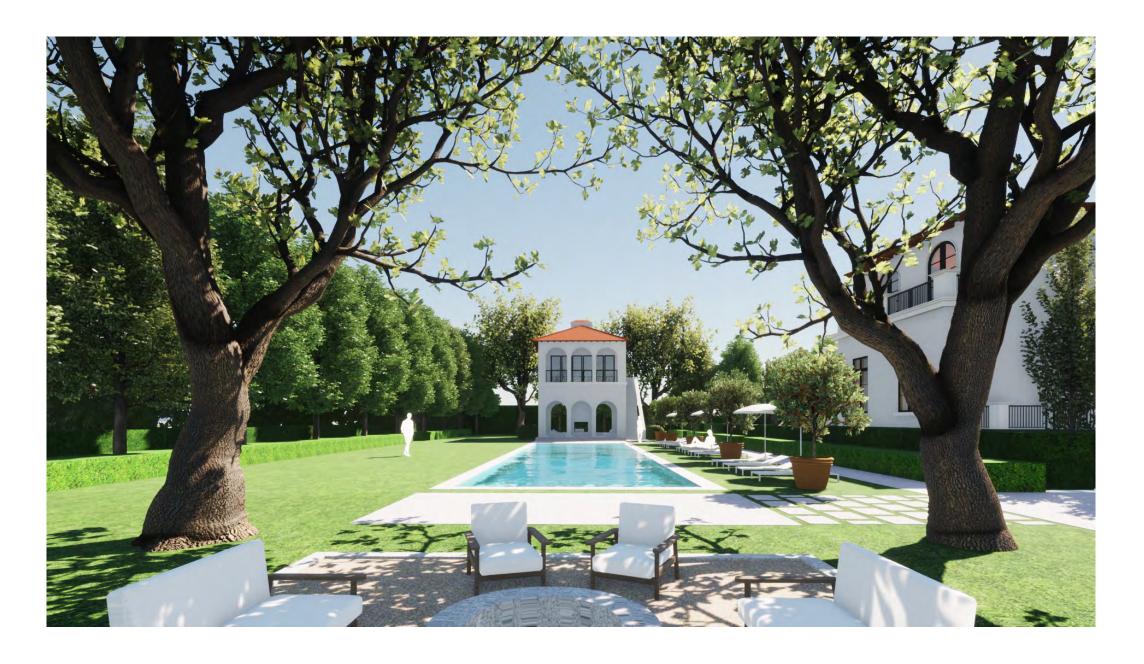

7/19/21


SHEET INDEX

- **Cover Sheet**
- Tree Protection & Removal Plan
- Tree Disposition Schedules
- Landscape Plan
- Perspective 1: Entry View
- Perspective 2: Alle view
- Perspective 3: Cabana View
- Perspective 4: Pool View
- Perspective 6: Pool View
- Perspective 7: Terrace View



Journey's End Residence L-0 **Cover Sheet**



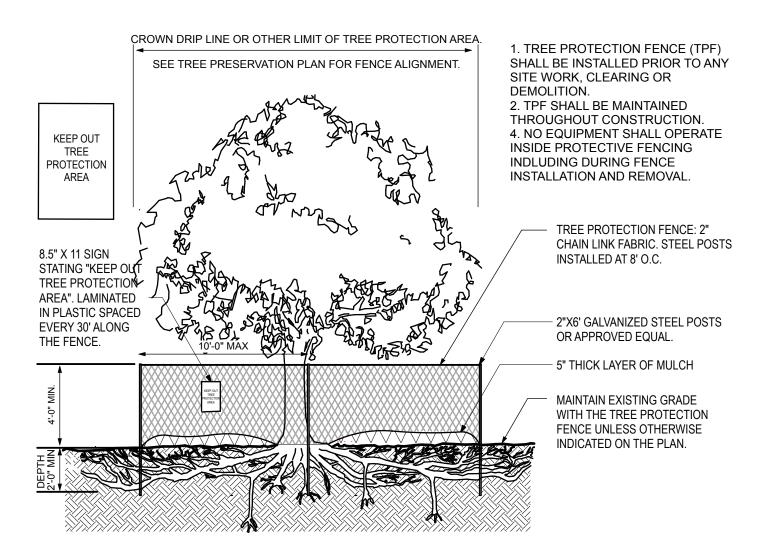



Tree Protection Detail

NOT TO SCALE

NOTE:

All Palms on site shall be removed to achieve desired formal mediterranean landscape design.

TOTAL CANOPY REMOVED = 12,866 SQFT

TOTAL MITIGATION PROVIDED = 15,300 SQFT

15 Large trees: 15 Oaks :: 7,500 sqft 21 Medium trees: 21 Brazilian Beautleaf :: 6,400 sqft 7 Small Trees: 1 Angel's Trumpet, 5 Spanish Stoppers, 1 Simpson's Stopper :: 1,400 sqft

	Existing Trees to Relocate											
ID	Botanical Name	Common Name	DBH	Height	Sprd.	Remarks						
T-1	Quercus virginiana	Southern Live Oak	24"	40'	40'							
T-116	Terminalia buceras	Black Olive	22"	45'	35'							
T-14	Quercus virginiana	Southern Live Oak	36"	45'	40'							
T-9	Quercus virginiana	Southern Live Oak	16"	40'	24'							
Site Ex Trees to Remain												
ID	Botanical Name	Common Name	DBH	Height	Sprd.	Remarks						
201	Myrthianthes fragrans	Simpson's Stopper	18"	12'	10'							
202	Myrthianthes fragrans	Simpson's Stopper	18"	12'	10'							
203	Myrthianthes fragrans	Simpson's Stopper	18"	12'	10'							
204	Myrthianthes fragrans	Simpson's Stopper	18"	12'	10'							
205	Myrthianthes fragrans	Simpson's Stopper	18"	12'	10'							
T-114	Terminalia buceras	Black Olive	24"	45'	45'							
T-115	Terminalia buceras	Black Olive	22"	45'	35'							
T-118	Bursera simaruba	Gumbo Limbo	18"	30'	30'							
T-2	Tabebuia chrysotricha	Yellow Tabebuia	24"	30'	28'							
T-3	Bursera simaruba	Gumbo Limbo	24"	35'	25'							
T-4	Bursera simaruba	Gumbo Limbo	24"	35'	25'							
T-5		Almond	29"	40'	30'							
T-68	Swietenia mahogani	Mahogany	36"	40'	37'							
T-72	Swietenia mahogani	Mahogany	24"	45'	25'							
T-75		Seagrape	11"	45'	22'							
T-763		Buttonwood	14"	35'	25'							
T-76A	Bursera simaruba	Gumbo Limbo	16"	40'	25'							
T-77		Almond	18"	45'	25'							
T-80	Bursera simaruba	Gumbo Limbo	24"	45'	35'							
T-81	Bursera simaruba	Gumbo Limbo	11"	50'	35'							
T-84		Almond	12"	37'	32'							
* REI	FER TO SHEET L-2	FOR TREE RE	MOVAL C	HART								

		Existing Trees to be Removed				Existing Trees to be Removed							
ID	Botanical Name	Common Name	DBH	Height	Sprd.	ID .	Botanical Name	Common Name	DBH	Height	Sprd.		
C-100	Cocos nucifera	Coconut Palm	12"	50'	20'	P-130	Phoenix canariensis	Canary Island Palm	20"	18'	20'		
C-101	Cocos nucifera	Coconut Palm	12"	40'	20	P-15	Bismarckia nobilis	Bismarck Palm	16"	30'	15'		
C-102	Cocos nucifera	Coconut Palm	10"	30'	20'	P-16	Bismarckia nobilis	Bismarck Palm	14"	30'	15'		
C-103	Cocos nucifera	Coconut Palm	8"	35'	20'	P-18	Hyophorbe lagenicaulis	Bottle Palm	12"	7'	5'		
C-104	Cocos nucifera	Coconut Palm	10"	40'	20'	P-19	Bismarckia nobilis	Bismarck Palm	10"	28'	15'		
C-105	Cocos nucifera	Coconut Palm	8"	30'	20'	P-20	Archontophoenix alexandrae	Alexander Palm	Cluster	20'	20'		
C-106	Cocos nucifera	Coconut Palm	11"	40'	20'	P-21	Bismarckia nobilis	Bismarck Palm	11"	25'	28'		
C-107	Cocos nucifera	Coconut Palm	14"	33'	20'	P-22	Archontophoenix alexandrae	King Alexander Palm	10"	30'	12'		
C-108	Cocos nucifera	Coconut Palm	10"	20'	20'	P-23.	Archontophoenix alexandrae	King Alexander Palm	6"	27'	12'		
C-109	Cocos nucifera	Coconut Palm	10"	35'	20'	P-24	Archontophoenix alexandrae	King Alexander Palm	7"	35'	12'		
C-109	Cocos nucifera	Coconut Palm	7"	20'	15'	P-25	Archontophoenix alexandrae	King Alexander Palm	7"	35'	12'		
C-110	Cocos nucifera	Coconut Palm	7"	20'	20'	P-26	Archontophoenix alexandrae	King Alexander Palm	7"	35'	12'		
C-112	Cocos nucifera	Coconut Palm	10"	15'	40'	P-27	Archontophoenix alexandrae	King Alexander Palm	6"	35'	12'		
C-113	Cocos nucifera	Coconut Palm	10"	20'	18'	P-29	Bismarckia nobilis	Bismarck Palm	17"	30'	15'		
C-117	Cocos nucifera	Coconut Palm	10"	20'	30'	P-29	Bismarckia nobilis	Bismarck Palm	20"	35'	20'		
C-28	Cocos nucifera	Coconut Palm	10"	40'	20'	P-31	Archontophoenix alexandrae	King Alexander Palm	8"	35'	18'		
C-42	Cocos nucifera	Coconut Palm	12"	30'	20'	P-32	Archontophoenix alexandrae	King Alexander Palm	5"	25'	10'		
C-43	Cocos nucifera	Coconut Palm	12"	40'	20'	P-35	Archontophoenix alexandrae	King Alexander Palm	Cluster	20'	20'		
C-44	Cocos nucifera	Coconut Palm	8"	30'	20'	P-36	Archontophoenix alexandrae	King Alexander Palm	8"	45'	15'		
C-47	Cocos nucifera	Coconut Palm	8"	20'	20'	P-37	Archontophoenix alexandrae	King Alexander Palm	8"	45'	15'		
C-7	Cocos nucifera	Coconut Palm	12"	20'	20'	P-38	Archontophoenix alexandrae	King Alexander Palm	5"	25'	10'		
C-74	Cocos nucifera	Coconut Palm	10"	35'	18'	P-39	Archontophoenix alexandrae	King Alexander Palm	7"	40'	15'		
C-78	Cocos nucifera	Coconut Palm	12"	27'	22'	P-40	Archontophoenix alexandrae	King Alexander Palm	7"	45'	15'		
C-8	Cocos nucifera	Coconut Palm	8"	45'	20'	P-41	Bismarckia nobilis	Bismarck Palm	18"	5'	18'		
C-86	Cocos nucifera	Coconut Palm	11"	30'	20'	P-45	Bismarckia nobilis	Bismarck Palm	20"	20'	20'		
C-87	Cocos nucifera	Coconut Palm	8"	22'	20'	P-49	Phoenix canariensis	Canary Island Palm	30"	20'	20'		
C-87A	Cocos nucifera	Coconut Palm	8"	17'	25'	P-52	Phoenix canariensis	Canary Island Palm	30"	25'	20'		
C-88	Cocos nucifera	Coconut Palm	8"	10'	30'	P-53	Phoenix canariensis	Canary Island Palm	30"	20'	20'		
C-90	Cocos nucifera	Coconut Palm	10"	35'	20'	P-6	Phoenix canariensis	Canary Island Palm	20"	18'	20'		
C-91	Cocos nucifera	Coconut Palm	6"	25'	20'	P-6	Phoenix canariensis	Canary Island Palm	26"	23'	20'		
C-92	Cocos nucifera	Coconut Palm	12"	45'	20'	P-85	Bismarckia nobilis	Bismarck Palm	8"	10'	16'		
C-95	Cocos nucifera	Coconut Palm	6"	20'	20'	P-85	Bismarckia nobilis	Bismarck Palm	8"	25'	10'		
C-97	Cocos nucifera	Coconut Palm	10"	25'	20'	T-119	Bursera simaruba	Gumbo Limbo	16"	28'	20'		
C-98	Cocos nucifera	Coconut Palm	8"	25'	18"	T-30	Dimocarpus longan	Longan (fruit tree)		35'	30'		
C-99	Cocos nucifera	Coconut Palm	8"	30'	18'	T-69		African Fern Pine	10"	35'	20'		
P-120	Archontophoenix alexandrae	Kind Alexander Palm	6"	35'	12'	T-76		Umbrella	12"	40'	18'		
P-121	Bismarckia nobilis	Bismarck Palm	10"	27'	6'	T-82		Screw Pine	7"	20'	10'		
									,				

	Existing Trees to be Relocated										
ID	Botanical Name	Common Name	DBH	Height	Sprd.						
T-1	Quercus virginiana	Southern Live Oak	24"	40'	40'						
T-116	Terminalia buceras	Black Olive	22"	45'	35'						
T-14	Quercus virginiana	Southern Live Oak	36"	45'	40'						
T-9	Quercus virginiana	Southern Live Oak	16"	40'	24'						

Existing Trees To Remain											
ID	Botanical Name	Common Name	DBH	Height	Sprd.						
201	Myrthianthes fragrans	Simpson's Stopper	18"	12'	10'						
202	Myrthianthes fragrans	Simpson's Stopper	18"	12'	10'						
203	Myrthianthes fragrans	Simpson's Stopper	18"	12'	10'						
204	Myrthianthes fragrans	Simpson's Stopper	18"	12'	10'						
205	Myrthianthes fragrans	Simpson's Stopper	18"	12'	10'						
T-114	Terminalia buceras	Black Olive	24"	45'	45'						
T-115	Terminalia buceras	Black Olive	22"	45'	35'						
T-118	Bursera simaruba	Gumbo Limbo	18"	30'	30'						
T-2	Tabebuia chrysotricha	Yellow Tabebuia	24"	30'	28'						
T-3	Bursera simaruba	Gumbo Limbo	24"	35'	25'						
T-4	Bursera simaruba	Gumbo Limbo	24"	35'	25'						
T-5		Almond	29"	40'	30'						
T-68	Swietenia mahogani	Mahogany	36"	40'	37'						
T-72	Swietenia mahogani	Mahogany	24"	45'	25'						
T-75		Seagrape	11"	45'	22'						
T-763		Buttonwood	14"	35'	25'						
T-76A	Bursera simaruba	Gumbo Limbo	16"	40'	25'						
T-77		Almond	18"	45'	25'						
T-80	Bursera simaruba	Gumbo Limbo	24"	45'	35'						
T-81	Bursera simaruba	Gumbo Limbo	11"	50'	35'						
T-84		Almond	12"	37'	32'						





					Existing Trees	s to Reloc	cate					
ID	Bota	nical Na	ame	Common Name	DBH	Height	Sprd.	Remarks				
T-1	Quero	cus virg	iniana	Southern Live Oak	24"	40'	40'					
T-116	Termi	nalia bu	uceras	Black Olive	22"	45'	35'					
T-14	Quero	cus virg	iniana	Southern Live Oak	36"	45'	40'					
T-9	Quero	cus virg	iniana	Southern Live Oak	16"	40'	24'					
					Site Ex Tree							
ID		nical Na		Common Name	DBH	Height		Remarks				
201			fragran		18"	12'	10'					
202			fragran		18"	12'	10'					
203			fragran		18"	12'	10'					
204			fragran		18"	12'	10'					
205 ———			fragran		18"	12'	10'					
T-114		nalia bu		Black Olive	24"	45' 	45'					
T-115 T-118		nalia bu era sima		Black Olive Gumbo Limbo	22" 18"	45' 30'	35' 30'					
T-2					24"	30' 30'	28'					
T-3		era sima	ysotrich	Gumbo Limbo	24 24"	 35'	 					
T-4		era sima		Gumbo Limbo	24 24"	 35'	 					
T-5	Duise		ai uba	Almond	24 	———— 40'	30'					
T-68	Swiot	onia ma	ahogani	Mahogany	36"	40' 40'	30 37'					
T-72			ahogani	Mahogany		 45'	 25'					
T-75	SWIE	Cilia ilia	anogani	Seagrape	11"	 45'	22'					
T-763				Buttonwood	14"	 35'	 25'					
	Ruree	era sima	aruha	Gumbo Limbo	16"	 40'	25'					
T-77	Duise	iia 511116	ai uba	Almond	18"	45'	25'					
T-80	Rurse	era sima	aruha	Gumbo Limbo	24"	45'	35'					
T-81		era sima		Gumbo Limbo	11"	 50'	35'					
T-84				Almond	12"	37'	32'					
					Tree So							
Sym	bol	ID	Qty	Botanical Name	Common Na	me	Ca	al Height	Sprd.	Native	Remark	ks
		BW	1	Brugmansia 'White'	White Angel	's Trumpe	et 2	" 12'	10'	N	:	
	X				g		_	- -				
6	1	CS	5	Citrus sp	Orange Tree	Э	1.	5" 8'	4'	N		
Eum	3	EF	5	Eugenia foetida	Spanish Sto	pper	2	" 12'	6'	Y		
V.	مورد	10	0.1		D 1111 D				401			
Ž	5	IC	21	Calophyllum brasiliense	Brazillian Be	eautyleat	4	" 16'	10'	N		
(.		М	3	Magnolia grandiflora	Southern Ma	agnolia	3	" 20'	8'	Υ		
~~~		MF	1	Myrcianthes fragrance	Simpson's S	Stonner	1.5	5" 12'	10'	Y		
\ \tag{\chi}	~	IVII	'		Ollipsoits C	otoppei	1.0	J 12	10	'		
$(\cdot$		PM	101	Podocarpus macrophyllus	Podocarpus		1.	5" 8'	4'	N		
(	(A)	QV	15	Quercus virginiana	Oak Tree		18	3" 30'	16'	Y		
	9_			<u> </u>	Shrub S	 chedule						
Sym	bol	ID	Qty	Botanical Name	Common Na		Siz	ze Height	Spr.	Spac.	Native	Remarks
		1) / A			D. conf Halle		7g-			•	Υ	2'; 3'; 4'
	<i>)</i> →	IVA	155	llex vomitoria 'nana'	Dwarf Holly		g				ĭ	topiary globes
	3	MF	8	Myrcianthes fragrans 'compacta'	Dwarf SImps Stopper	son's	15	5g 4'	4'		Υ	
$\overline{C}$	)	PM	584	Podocarpus	Podocarpus		45	5g 8'	4'		N	
				macrophyllus	Site Groundco				•			
Sym	bol	ID	Qty	Botanical Name		on Name	Siz	ze Height	Spr.	Spac.	Native	Remarks
	<u> </u>		-	Myrcianthes fragrans	0: 1.0	<u> </u>				(in)		
		Mf	64	'compacta'	Simpson's S	olopper	7		18"	21	Y	
	555	PI	900	Psychotria ligustrifolia	Bahama Co	ffee	7	g 24"-3 6"	24"-3 6"	24	Υ	Bush
		Та	8,222	Trachelospermum	Asiatic Jasm	nine	1	g 6"	12"	12	N	
(5/2)		·u	-,	asiaticum	5.640 00011		1				. •	
(1-1), 1-1,		sj	1,142	Serissa foetida	Snow Rose		3	g 18"	18"	18	N	















Perspective 4: Pool View









