


LOCATION MAP

Project: Fadel Residence 817 Alhambra Circle Coral Gables, Fl 33134



Project: Fadel Residence 817 Alhambra Circle Coral Gables, Fl 33134

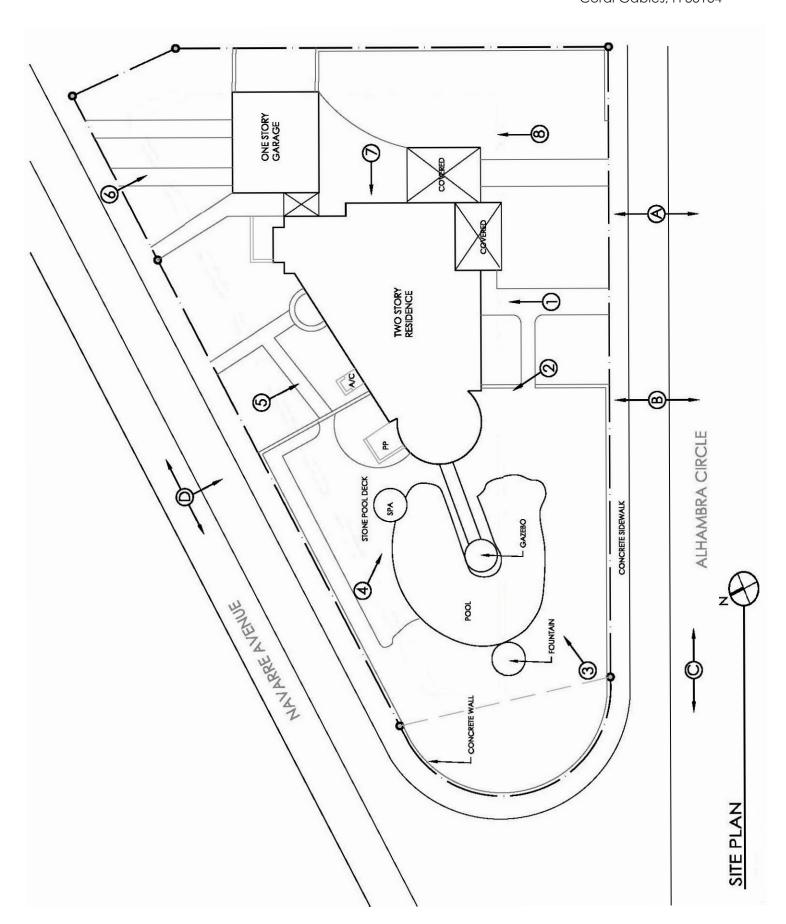


01



Project: Fadel Residence 817 Alhambra Circle Coral Gables, Fl 33134



03

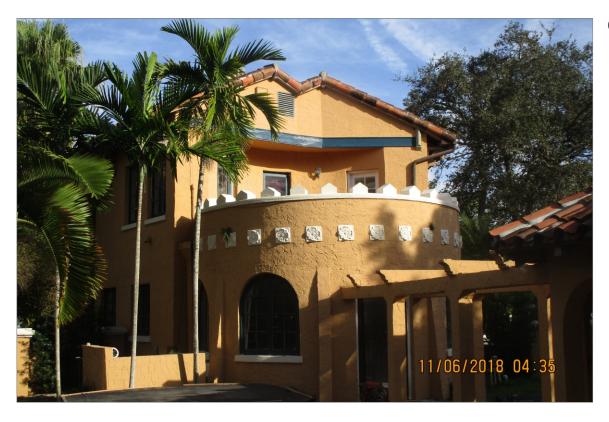

Project: Fadel Residence 817 Alhambra Circle Coral Gables, Fl 33134



05



Project: Fadel Residence 817 Alhambra Circle Coral Gables, Fl 33134



07



Project: Fadel Residence 817 Alhambra Circle Coral Gables, Fl 33134

A- Alhambra Circle





Project: Fadel Residence 817 Alhambra Circle Coral Gables, Fl 33134

B- Alhambra Circle





Project: Fadel Residence 817 Alhambra Circle Coral Gables, Fl 33134

C- Alhambra Circle





Project: Fadel Residence 817 Alhambra Circle Coral Gables, Fl 33134

D- Navarro Avenue






Project: Fadel Residence 817 Alhambra Circle Coral Gables, Fl 33134

D- Navarro Avenue



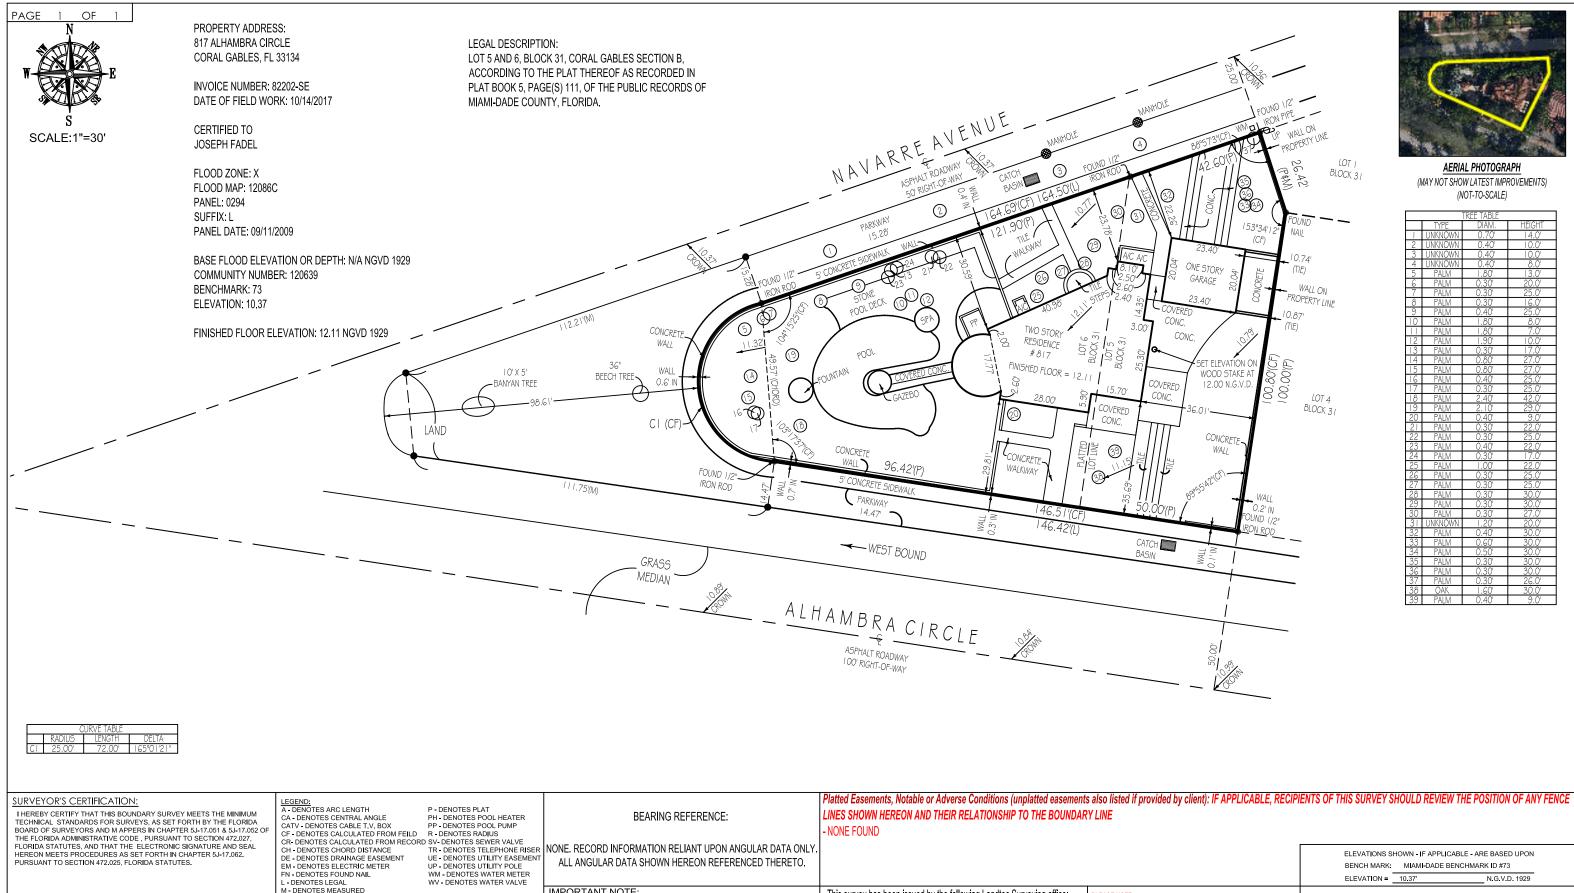

ANDREW SNYDER PROFESSIONAL SURVEYOR AND MAPPER FLORIDA REGISTRATION No. 5639 (NOT VALID WITHOUT THE SIGNATURE AND THE ORIGINAL OR raised seal of the florida licensed surveyor and mapper shown above

DATE: 11/02/2020

OHC - DENOTES OVERHEAD CABLE ■ BOUNDARY LINE BUILDING LINE

CENTERLINE ----- EASEMENT LINE — x — x — METAL FENCE
—// —// — WOODEN FENCE → PVC FENCE

IMPORTANT NOTE:

F THIS SKETCH OF SURVEY HAS BEEN PREPARED FOR THE PURPOSES OF A MORTGAGE TRANSACTION, IT IS LIMITED TO THE INFORMATION REQUIRED FOR THAT PURPOSE, NO FUTURE CONSTRUCTION SHALL BE BASED UPON THIS SURVEY WITHOUT FIRST OBTAINING APPROVAL AND/OR UPDATES FROM LANDTEC. SAID APPROVAL SHALL BE CONFIRMED BY AN ADDITIONAL SIGNED NOTATION: "LANDTEC APPROVAL FOR CONSTRUCTION" LISTED IN THE REVISION BAR BELOW, LANDTECH ASSUMES NO RESPONSIBILITY FOR ERRORS RESULTING FROM FAILURE TO ADHERE TO THIS CLAUSE.

This survey has been issued by the following Landtec Surveying office: 481 E. Hillsboro Blvd. Ste 100-A Deerfield Beach, FL 33441 Office: (561) 367-3587 Fax: (561) 465-3145 www.LandtecSurvey.com

PLEASE NOTE: SUBJECT PROPERTY IS SERVICED BY PUBLIC UTILITIES. APPROVED FOR CONSTRUCTION HAS BEEN MADE BY THIS OFFICE.

Job Number: 82202-SE Rev.: 11/02/2020 B. ZAB Drawn By: L.G. Date of Field Work: 10/14/2020



... measurably better!

ALHAMBRA CIRCLE

EXISTING SITE PLAN
SCALE: 1/16"=1'-0"

JOHN R. MEDINA & ASSOC.

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REVISIONS	DATE	BY

John Richard Medina & Associates, Architects



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FADEL

re and shall remain the property of litect and shall remain the property of a Architect whether the project for her were made is executed or not.

other projects or extendors to this pro except by agreement in willing and with appropriate compensation to the Archi Reproduction of drawings specifications without the written conse

of 817 Alhambra Circle, Coral Gables, FL 33134

EXISTING SITE SCALE:1/16"=1"-0" DATE:09-2020 DRAWN: MR



EXISTING FLOOR PLAN-LEVEL 1
SCALE: 1/4"=1'-0"

John Richard Medina & Associates, Architects

JOHN R. MEDINA & ASSOC.


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EXISTING SCALE: 1/16"=1'-0"
DATE: 09-2020
DRAWN: MR

SCHEMATIC DESIGN - NOT FOR CONSTRUCTION -



EXISTING FLOOR PLAN-LEVEL 2
SCALE: 1/4"=1'-0"

JOHN R. MEDINA & ASSOC. ARCHITECTS
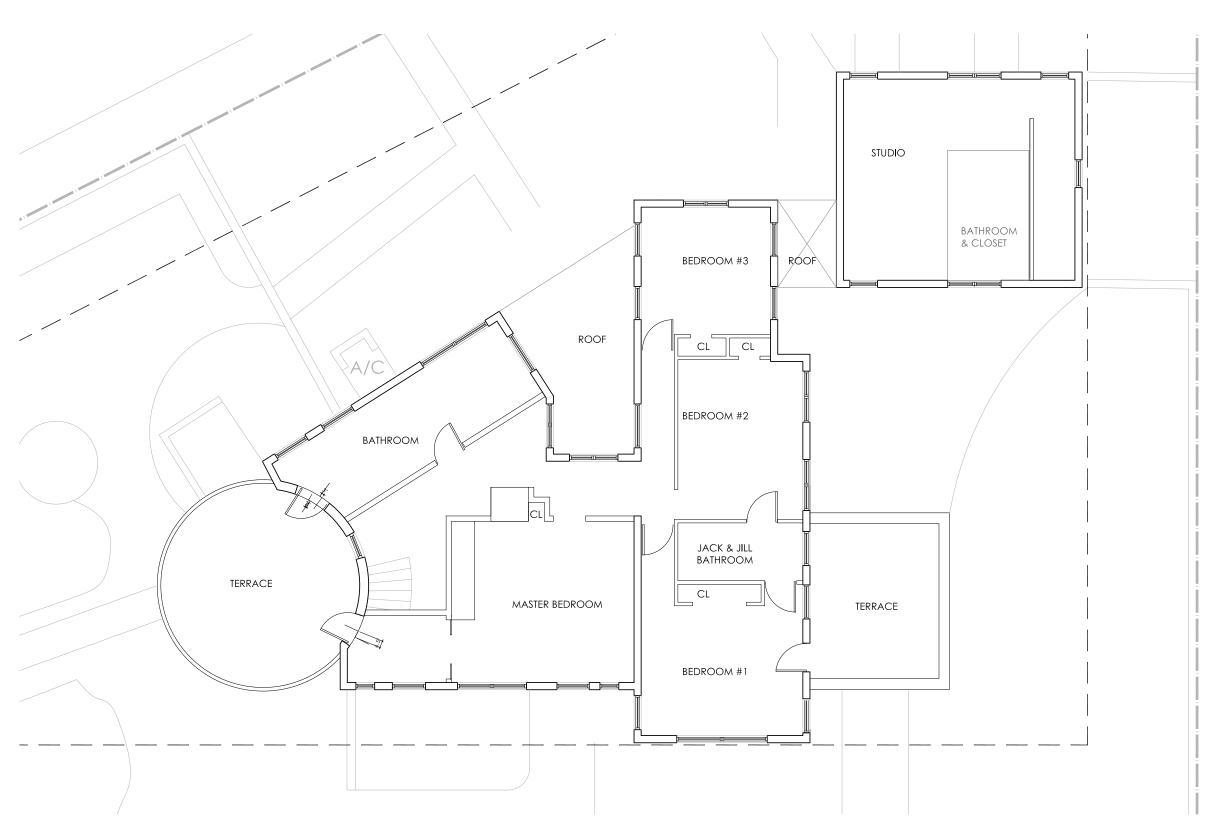
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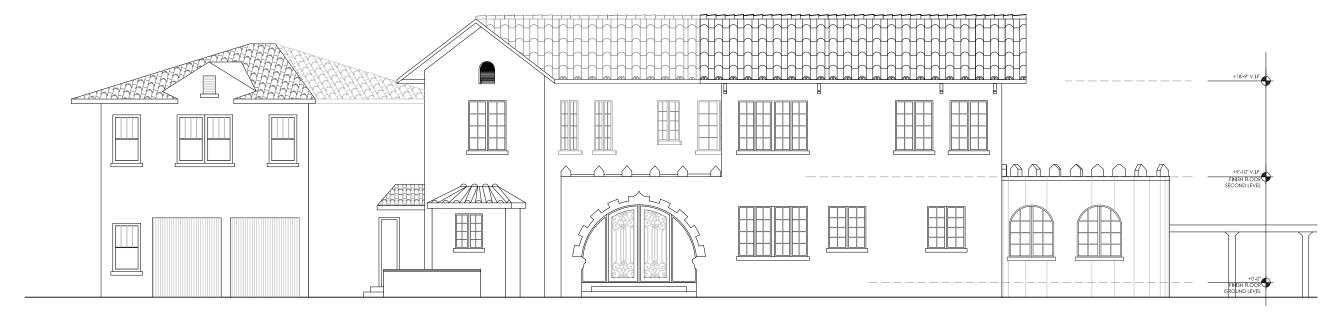
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not to be used in any manner on species or estimation to this project greement in waiting and with the supermount of the Activities. Reproduction of diovelage and any without the wellen content of the Activities is promitted. Coral Gables, FL 33134


EXISTING SCALE: 1/16"=1"-0" DATE:09-2020 DRAWN: MR



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EXISTING NORTH ELEVATION
SCALE: 1/4"=1'-0"



John Richard Medina & Associates, Architects

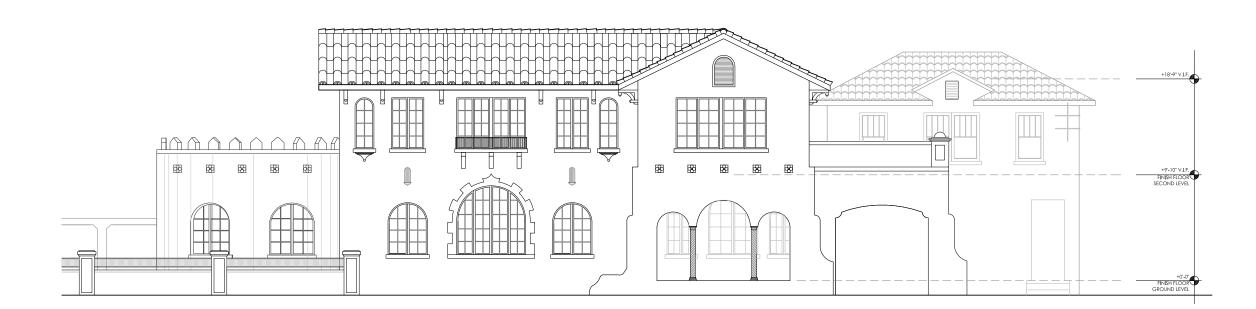REVISIONS DATE

REV 1 1-18-2021

JOHN RICHARD MEDINA AR 014867

Specifications as instrument of and shall remain the property of and shall remain the property of and shall remain the property.

of the Architect whether the project which they were made is executed or They are not to be used in any manne other projects or extensions to this purexcept by agreement in witting and with appropriate compensation to the Archit Reproduction of drowings

817 Alhambra Circle, Coral Gables, FL 33134

SCALE: DATE:09-2020 DRAWN: MR

EXISTING SOUTH ELEVATION
SCALE: 1/4"=1'-0"

SCHEMATIC DESIGN BOA A-03

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SCALE: DATE:09-2020 DRAWN: MR

BOA A-04 SCHEMATIC DESIGN - NOT FOR CONSTRUCTION -



EXISTING EAST ELEVATION SCALE: 1/4"=1'-0"



EXISTING WEST ELEVATION
SCALE: 1/4"=1'-0"

FADEL RESIDENCE

JOHN R. MEDINA & ASSOCIATES ARCHITECTS

SCOPE OF WORK:

- THE PROJECT CONSISTS OF A NEW TWO STORY ADDITION AND INTERIOR RENOVATION INCLUDING REPLACEMENT OF WINDOWS AND DOORS ON AN EXISTING RESIDENTIAL BUILDING AS PER FBCB 2017, 6TH EDITION & FBCR 2017,6TH EDITION.

JOHN R. MEDINA & ASSOC.

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DAIL	

John Richard Medina & Associates, Architects

JOHN AR 01

AR 014867

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ritten consent of 817 Alhambra Circle, ect is prohibited. Coral Gables, FL 33134

COVER SCALE:N.T.S DATE:09-2020 DRAWN: MR



JOHN R. MEDINA & ASSOC. ARCHITECTS

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REVISIONS DATE

Architects *Anno2647 Associates, ≪ Medina Richard John I

FADEL RESIDENCE service are and shall remain the property of the Architect and shall remain the propert

817 Alhambra Circle, Coral Gables, FL 33134

EXISTING SITE PLAN SCALE: AS SHOWN DATE: 09-2020 DRAWN: MR

THE PROJECT CONSIST OF A NEW TWO STORY ADDITION AND INTERIOR RENOVATION INCLUDING REPLACEMENT OF WINDOWS AND DOORS ON AN EXISTING RESIDENTIAL BUILDING

TREE PROTECTION DIAGRAM

EXISTING TREES AND PALMS

UMBER COMMON DBH HEIGHT STATUS


TREE #4 UNKNOWN 0.40 FT 8 FT REMAIN

TREE #12 PALM TREE #13 PALM

TREE #15 PALM

TREE #36 PALM TREE #37 PALM

0.30 FT 26 FT REMAIN

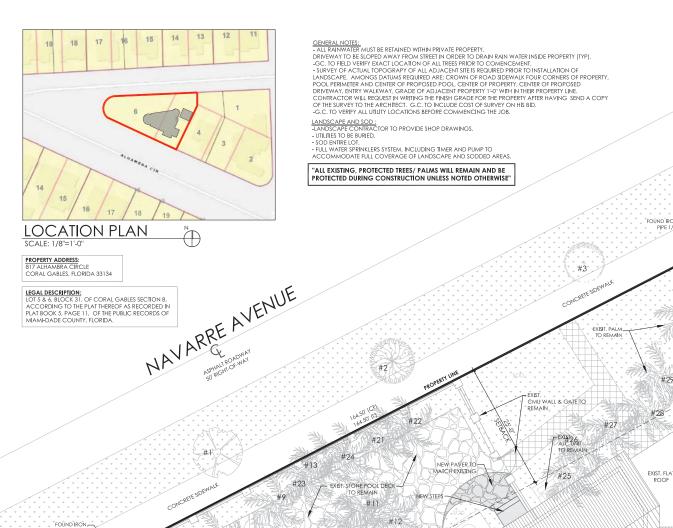

PAVER DETAIL
SCALE: 3/4"=1"-0" #36 ONE STORY GARAGE EXISTING TWO STORY RESIDENCE

ADDITION EXÎSIJ. PALÂ TO REMAÎ EXIST. CONCRETE -


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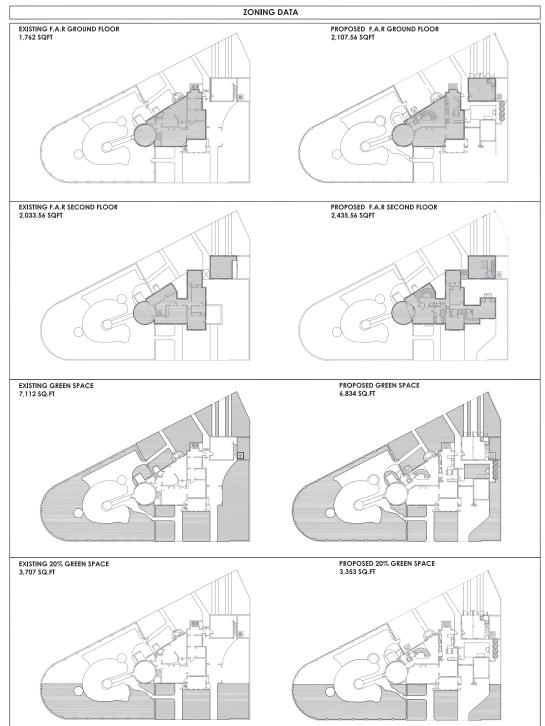
ALHAMBRA CIRCLE

SITE PLAN

CONCRETE SIDEWALK

BOA AS-1.0



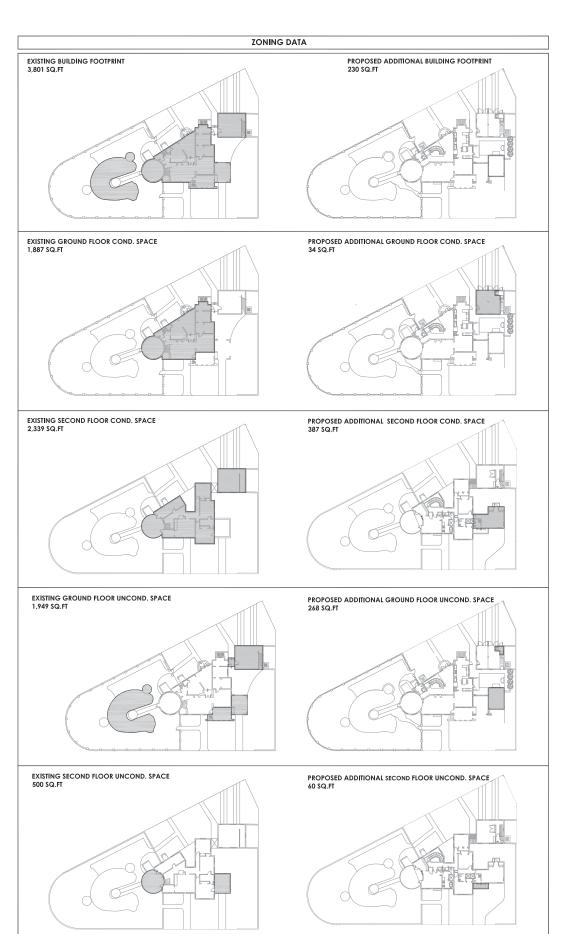

ZONING CRITERIA ZONING CLASSIFICATION: SFI	?				
TOTAL LOT AREA: 13,953 SQFT					
DESCRIPTION	%	ALLOWED	EXISTING	PROPOSED	TOTAL
BUILDING FOOTPRINT	35%	4,884 SQ FT	3,801 SQ FT	230 SQFT	3,571 SQFT
NUMBER OF FLOORS		2	2	2	2
HEIGHT OF BUILDING		2 STORIES	2 STORY	2 STORY	2 STORY
GROUND FLOOR COND. SPACE			1,887 SQ FT	382 SQFT	2,269 SQFT
SECOND FLOOR COND. SPACE			2,339 SQ FT	387 SQFT	2,726 SQFT
TOTAL COND. SPACE			4,216 SQ FT	765 SQFT	4,995 SQFT
GROUND FLOOR UNCOND. SPACE			1,481 SQ FT	268 SQFT	1,213 SQFT
SECOND FLOOR UNCOND. SPACE			500 SQ FT	60 SQ FT	440 SQFT
TOTAL UNCOND, SPACE			1,981 SQ FT	332 SQ FT	1,653 SQ FT
AUXILIARY BUILDING	45%	6,279 SQ FT	1,032 SQ FT	0 SQ FT	1,032 SQ FT
MAXIMUN F.A.R		5,086 SQ FT	3.795.56 SQ FT	- 391.56 SQFT	4,187.12 SQFT
GREEN AREA	40%MIN	5,581 SQ FT	7,112 SQFT	- 278 SQFT	6,834 SQFT
GREEN AREA	20% of 40%	1,116 SQ FT	3,707 SQ FT	- 354 SQFT	3,353 SQFT

SETBACKS: PRINCIPAL FRONT: 25 FT MIN. SIDE: 5 FT (20% OF LOT WIDTH) REAR: 25 FT MIN.

JOHN R. MEDINA & ASSOC. ARCHITECTS

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revisions date

Associates, Architects ∞ John Richard Medina



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ZONING CALCULATIONS SCALE:AS SHOWN DATE:09-2020 DRAWN: MR

JOHN R. MEDINA & ASSOC.

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REVISIONS	DATE	BY
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John Richard Medina & Associates, Architects



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They are not to be used in any manner
other projects or extensions to this proje
except by agreement in writing and with it
appropriate compensation to the Archite
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n consent of 817 Alhambra Circle, is prohibited. Coral Gables, FL 33134

DEMOLITION PLAN-GROUND FLOOR SCALE: 1/4"=1'-0" DATE:09-2020 DRAWN: MR

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REVISIONS DATE


Architects AA0002647 Associates, ≪ Medina John Richard




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DEMOLITION PLAN-SECOND FLOOR SCALE:1/16"=1"-0" DATE:09-2020 DRAWN: MR



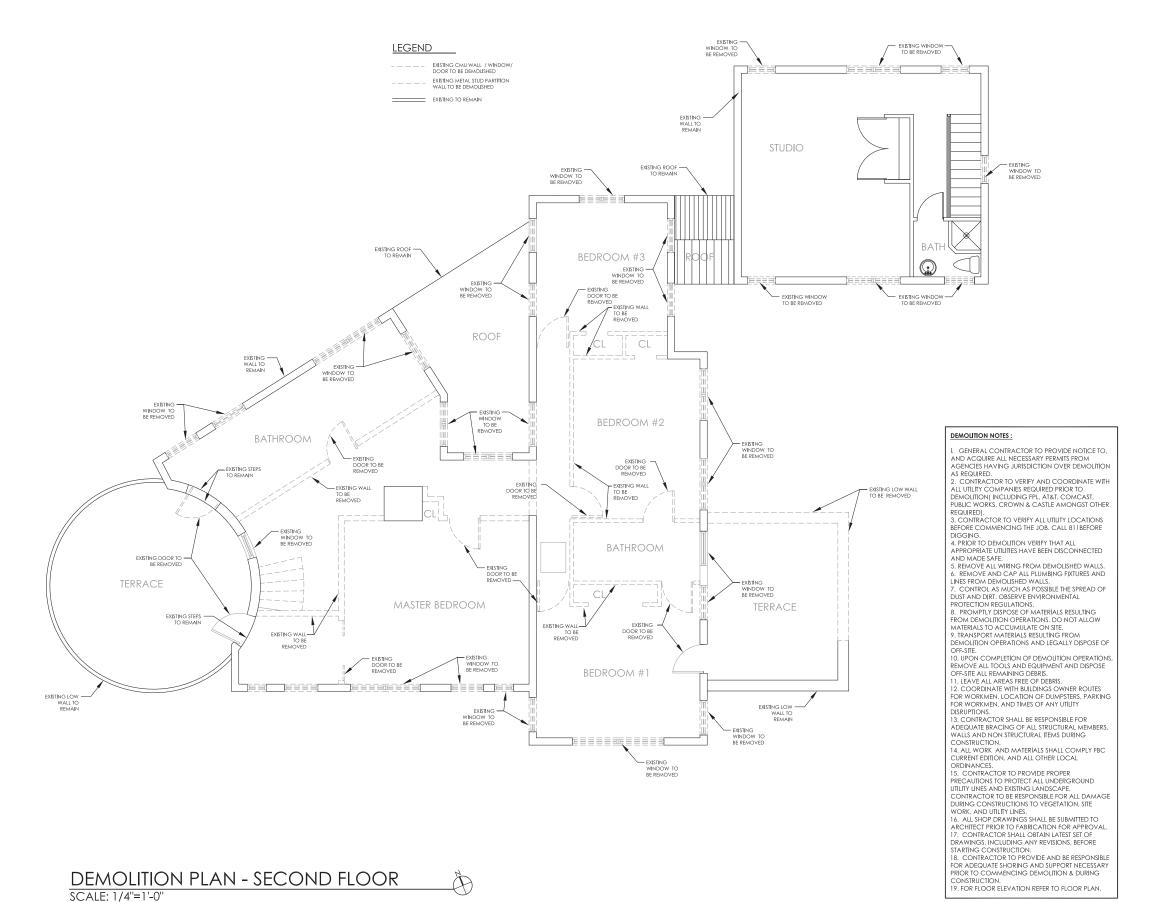

TERMITE PROTECTION STATEMENT AS PER FBC- 5TH EDITION 2014:

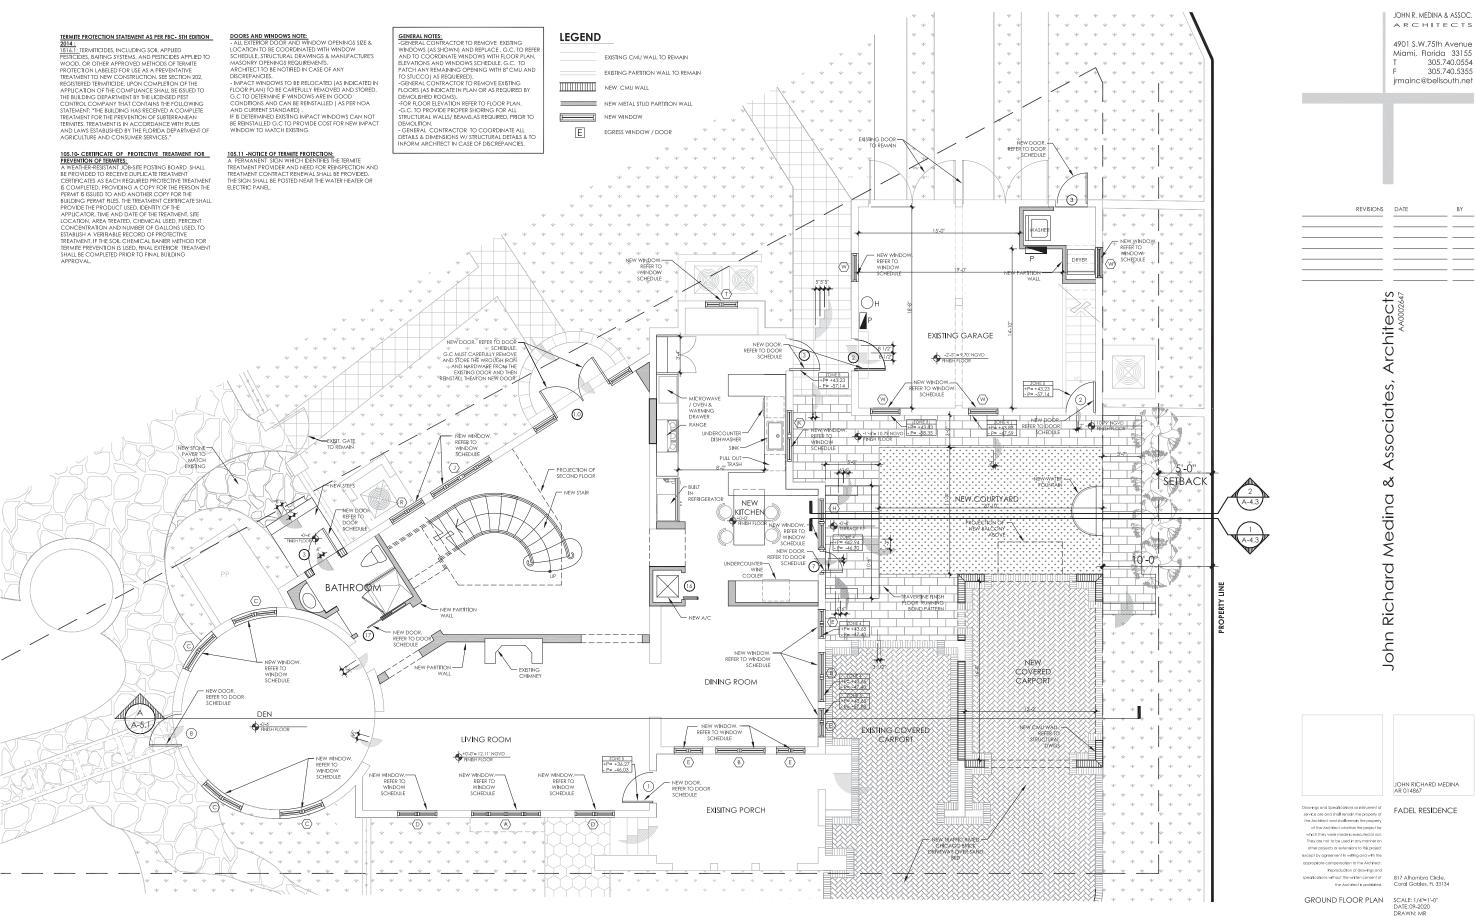2014:
1816.1: TERMITICIDES, INCLUDING SOIL APPLIED
PESTICIDES, BAITING SYSTEMS, AND PESTICIDES APPLIED TO
WOOD, OR OTHER APPROVED METHODS OF TERMITE
PROTECTION LABELED FOR USE AS A PREVENTATIVE
TREATMENT TO NEW CONSTRUCTION, SEE SECTION 202.
REGISTERED TERMITICIDE. UPON COMPLETION OF THE
APPLICATION OF THE COMPILANCE SHALL BE ISSUED TO
THE BUILDING DEPARTMENT BY THE LICENSED PEST
CONTROL COMPANY THAT CONTAINS THE FOLLOWING
STATEMENT: THE BUILDING HAS RECEIVED A COMPLETE
TREATMENT FOR THE PREVENTION OF SUBTERRANEAN
TERMITES. TREATMENT IS IN ACCORDANCE WITH RULES
AND LAWS ESTABLISHED BY THE FLORIDA DEPARTMENT OF

DORS AND WINDOWS NOTE:

- ALL EXTERIOR DOOR AND WINDOW OPENINGS SIZE &
LOCATION TO BE COORDINATED WITH WINDOW
SCHEDULE, STRUCTURAL DRAWINGS & MANUFACTURES
MASONRY OPENINGS REQUIREMENTS.
ARCHITECT TO BE NOTIFIED IN CASE OF ANY
DISCREPANCIES.
- IMPACT WINDOWS TO BE RELOCATED (AS INDICATED IN
FLOOR PLAN) TO BE CAREFULLY REMOVED AND STORED.
GC TO DETERMINE IF WINDOWS ARE IN GOOD
CONDITIONS AND CAN BE REINSTALLED (AS PER NOA
AND CURRENT STANDARD).
IF IS DETERMINED EXISTING IMPACT WINDOWS CAN NOT
BE REINSTALLED G.C. TO PROVIDE COST FOR NEW IMPACT

GENERAL NOTES:

GENERAL CONTRACTOR TO REMOVE EXISTING
WINDOWS (AS SHOWN) AND REPLACE, G.C. TO REFE
AND TO COORDINATE WINDOWS WITH FLOOR PLAN,
ELEVATIONS AND WINDOWS SCHEDULE, G.C. TO
PATCH ANY REMAINING OPENING WITH BE WIND AND
TO STUCCO(AS REQUIERED).
GENERAL CONTRACTOR TO REMOVE EXISTING
FLOORS (AS INDICATE IN PLAN OR AS REQUIRED BY
DEMOLISHED ROOMS).

LEGEND

EXISTING CMU WALL TO REMAIN

EXISTING PARTITION WALL TO REMAIN

FOR FLOOR FLEVATION REFER TO FLOOR PLAN

JOHN R. MEDINA & ASSOC. ARCHITECTS

> 4901 S W 75th Avenue Miami, Florida 33155 305.740.0554 305.740.5355 jrmainc@bellsouth.net

REVISIONS DATE

Architects Associates, ⋖ Medina Richard John

VOID JOHN RICHARD MEDINA AR 014867


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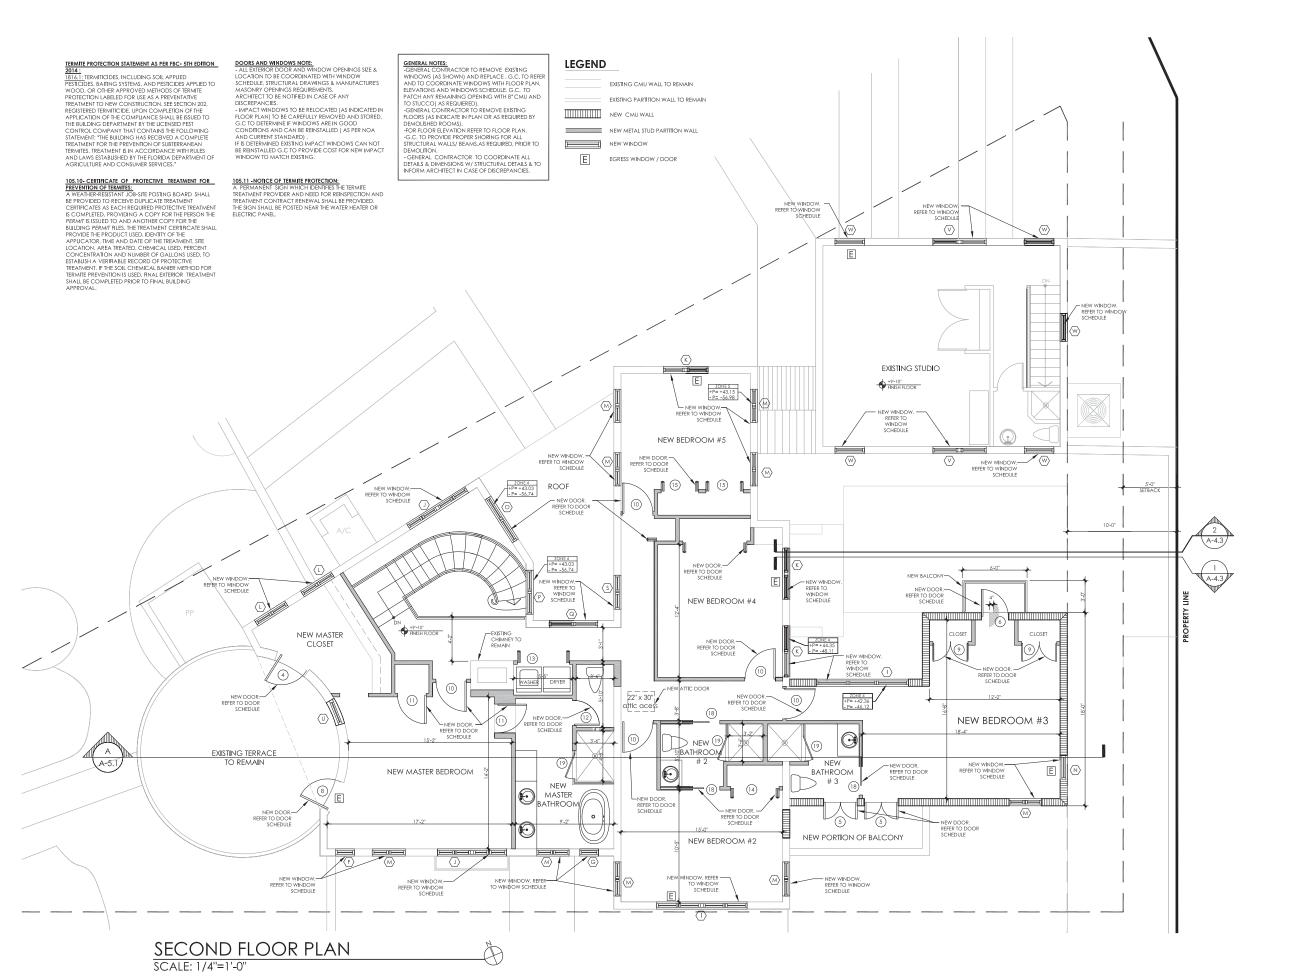
which they were made is executed or not.
They are not to be used in any manner on
other projects or extensions to this project
except by agreement in withing and with the appropriate compensation to the Architec Reproduction of drawings and

GROUND FLOOR PLAN

SCALE: 1/4"=1'-0" DATE:09-2020 DRAWN: MR

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REVISIONS DATE BY

John Richard Medina & Associates, Architects

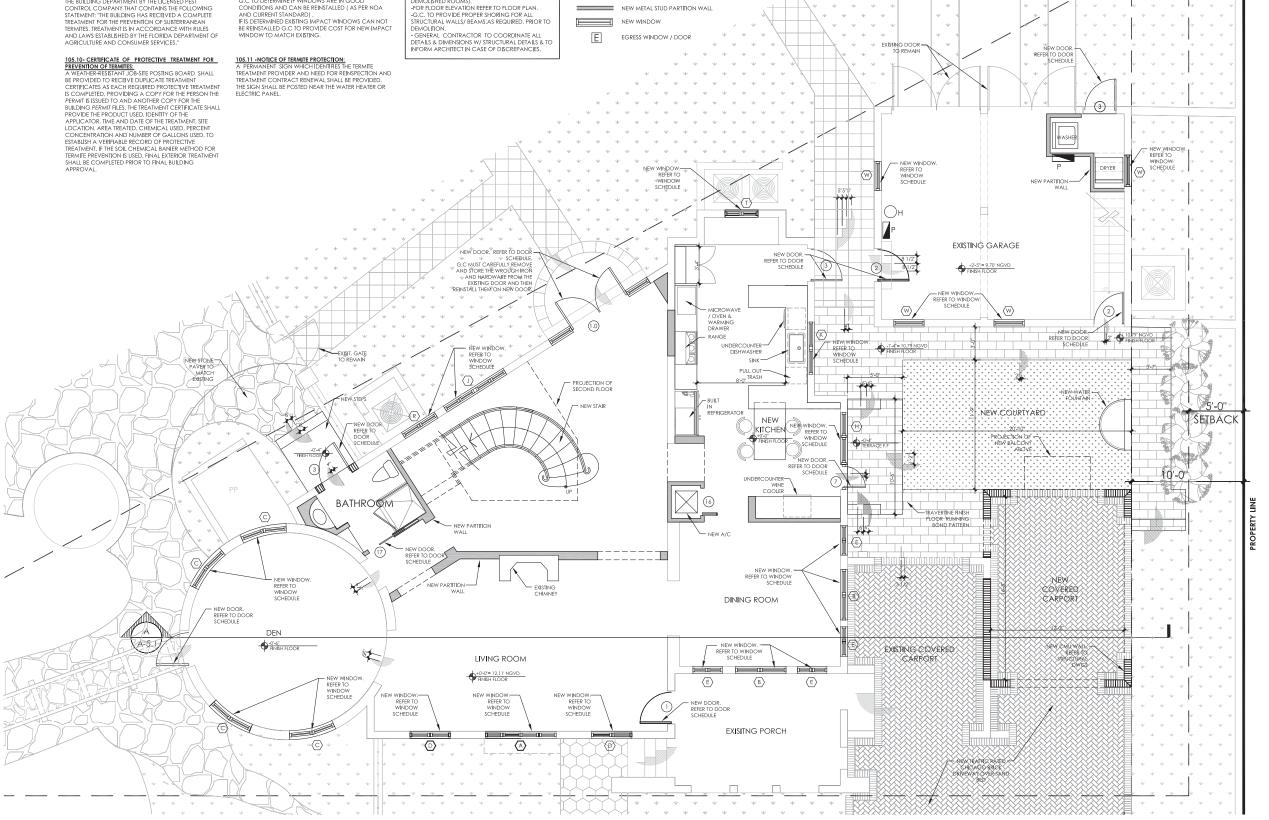JOHN RICHARD MEDINA AR 014867

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special control in the Architect is prohibited.

SECOND FLOOR PLAN

SCALE: 1/4"=1"-0"

N SCALE: 1/4"=1"-DATE:09-2020 DRAWN: MR



2014:
1816.1. TREMITICIDES. INCLUDING SOIL APPLIED
PESTICIDES. BAITING SYSTEMS. AND PESTICIDES APPLIED TO
WOOD. OR OTHER APPROVED METHODS OF FERMITE
PROTECTION LABELED FOR USE AS A PREVENTATIVE
TREATMENT TO NEW CONSTRUCTION. SEE SECTION 202,
REGISTERED TREMITICIDE. UPON COMPLETION OF THE
APPLICATION OF THE COMPLIANCE SHALL BE ISSUED TO
THE BUILDING DEPARTMENT BY THE LICENSED PEST
CONTROL COMPANY THAT CONTRIANS THE FOLLOWING CONTROL COMPANY THAT CONTAINS THE FOLLOWING STATEMENT: "THE BUILDING HAS RECEIVED A COMPLETE TREATMENT FOR THE PREVENTION OF SUBTERRANEAN TERMITES. TREATMENT IS IN ACCORDANCE WITH RULES AND LAWS ESTABLISHED BY THE FLORIDA DEPARTMENT OF AGRICULTURE AND CONSUMER SERVICES."

105.10- CERTIFICATE OF PROTECTIVE TREATMENT FOR PREVENTION OF TERMITES:

A WEATHER-RESISTANT JOB-SITE POSTING BOARD SHALL BE PROVIDED TO RECEIVE DUPILCATE TREATMENT CERTIFICATES AS EACH REGUIRED PROTECTIVE TREATMENT IS COMPLETED, PROVIDING A COPY FOR THE PRESON THE PERMIT IS SUILDING PREMIT FILES. THE REATMENT CERTIFICATE SHALL PROVIDE THE PRODUCT USED, IDENTITY OF THE APPLICATOR, TIME AND DATE OF THE TREATMENT, SITE LOCATION, AREA TREATED, CHEMICAL USED, PERCENT CONCENTRATION AND NUMBER OF GALLON SUSD, TO ESTABLISH A VERIFIABLE RECORD OF PROTECTIVE TREATMENT, THE SOLL CHEMICAL BANDER METHOD FOR LATINUSTIA A VERIFICALE RECUPIO DE PROJECTIVE TREATMENT, IF THE SOIL CHEMICAL BANDER METHOD FOR TERMITE PREVENTION IS USED, FINAL EXTERIOR TREATMENT SHALL BE COMPLETED PRIOR TO FINAL BUILDING APPROVAL.

A-5.1

DOORS AND WINDOWS NOTE:

- ALL EXTERIOR DOOR AND WINDOW OPENINGS SIZE &
LOCATION TO BE COORDINATED WITH WINDOW
SCHEDULE, STRUCTURAL DRAWINGS & MANUFACTURE'S MASONRY OPENINGS REQUIREMENTS ARCHITECT TO BE NOTIFIED IN CASE OF ANY DISCREPANCIES.

discrepancies. - Impact windows to be relocated (as Indicated In FLOOR PLAN) TO BE CAREFULLY REMOVED AND STORED. G.C TO DETERMINE IF WINDOWS ARE IN GOOD CONDITIONS AND CAN BE REINSTALLED (AS PER NOA

AND CURRENT STANDARD).

IF IS DETERMINED EXISTING IMPACT WINDOWS CAN NOT BE REINSTALLED G.C. TO PROVIDE COST FOR NEW IMPACT WINDOW TO MATCH EXISTING.

105.11 - NOTICE OF TERMITE PROTECTION:
A PERMANENT SIGN WHICH IDENTIFIES THE TERMITE
TREATMENT PROVIDER AND NEED FOR REINSPECTION AND
TREATMENT CONTRACT RENEWAL SHALL BE PROVIDED.
ITE SIGN SHALL BE POSTED NEAR THE WATER HEATER OR
ELECTRIC PANEL.

NEW MASTER

CLOSET

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GENERAL NOTES: CENERAL CONTRACTOR TO REMOVE EXISTING CENERAL CONTRACTOR TO REMOVE EXISTING CENERAL CONTRACTOR TO REMOVE EXISTING

-GENERAL CONTRACTOR TO REMOVE EXISTING WINDOWS (AS SHOWN) AND REPLACE. 6, C. TO REFE AND TO COORDINATE WINDOWS WITH FLOOR PLAN, LEVATIONS AND WINDOWS SCHEDULE, G.C. TO PATCH ANY REMAINING OPENING WITH 8" CMU AND TO STUCCO(AS REQUIERED).

-GENERAL CONTRACTOR TO REMOVE EXISTING

LOORS (AS INDICATE IN PLAN OR AS REQUIRED BY FOR FLOOR ELEVATION REFER TO FLOOR PLAN.

EXISTING CMU WALL TO REMAIN

NEW CMU WALL

Ε EGRESS WINDOW / DOOR

SCHEDULE $\langle \nabla \rangle$ E

Ε

NEW BEDROOM #5

ROOF 15

10

+9'-10" FINISH FLOOR

REFER TO DOOR SCHEDULE

NEW MASTER BEDROOM NEW **①** MASTER BATHROOM

 $\langle M \rangle$

SECOND FLOOR PLAN SCALE: 1/4"=1'-0"

EXISTING TERRACE

TO REMAIN

LEGEND

-G.C. TO PROVIDE PROPER SHORING FOR ALL STRUCTURAL WALLS/ BEAMS, AS REQUIRED, PRIOR TO

DEMOLITION.

- GENERAL CONTRACTOR TO COORDINATE ALL
DETAILS & DIMENSIONS WY STRUCTURAL DETAILS & TO
INFORM ARCHITECT IN CASE OF DISCREPANCIES.

EXISTING PARTITION WALL TO REMAIN NEW METAL STUD PARTITION WALL

NEW WINDOW

 $\langle w \rangle$

EXISTING STUDIO

+9'-10" FINISH FLOOR

NEW BEDROOM #4

(10

(18) NEW BEDROOM #3

NFW E BATHROOM 14 $\langle M \rangle$

REFER TO D SCHEDULE NEW PORTION OF BALCONY NEW BEDROOM #2 - NEW WINDOW. REFER TO WINDOW SCHEDULE

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SECOND FLOOR PLAN

JOHN R. MEDINA & ASSOC.

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Miami, Florida 33155

jrmainc@bellsouth.net

REVISIONS DATE

Architects

Associates,

≪

Medina

Richard

John

VOID

JOHN RICHARD MEDINA AR 014867

FADEL RESIDENCE

817 Alhambra Circle, Coral Gables, FL 33134

305.740.0554 305.740.5355

SCHEMATIC DESIGN BOAA1.2


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JOHN RICHARD MEDINA AR 014867

FADEL RESIDENCE

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ROOF PLAN SCALE:1/4"=1'-0" DATE:09-2020 DRAWN; MR

NOTE:

- OPERABLE WINDOWS AT SECOND LEVEL TO BE 36" MIN FROM FINISH FLOOR, IF EXISTING WINDOW IS BELLOW 36" AFF. ADD A CONTROL DEVICE THAT ALLOWS A 4" Ø SPHERE REJECTED. REFER TO WINDOWS SCHEDULE FOR WINDOWS WITH THIS REQUIREMENT.

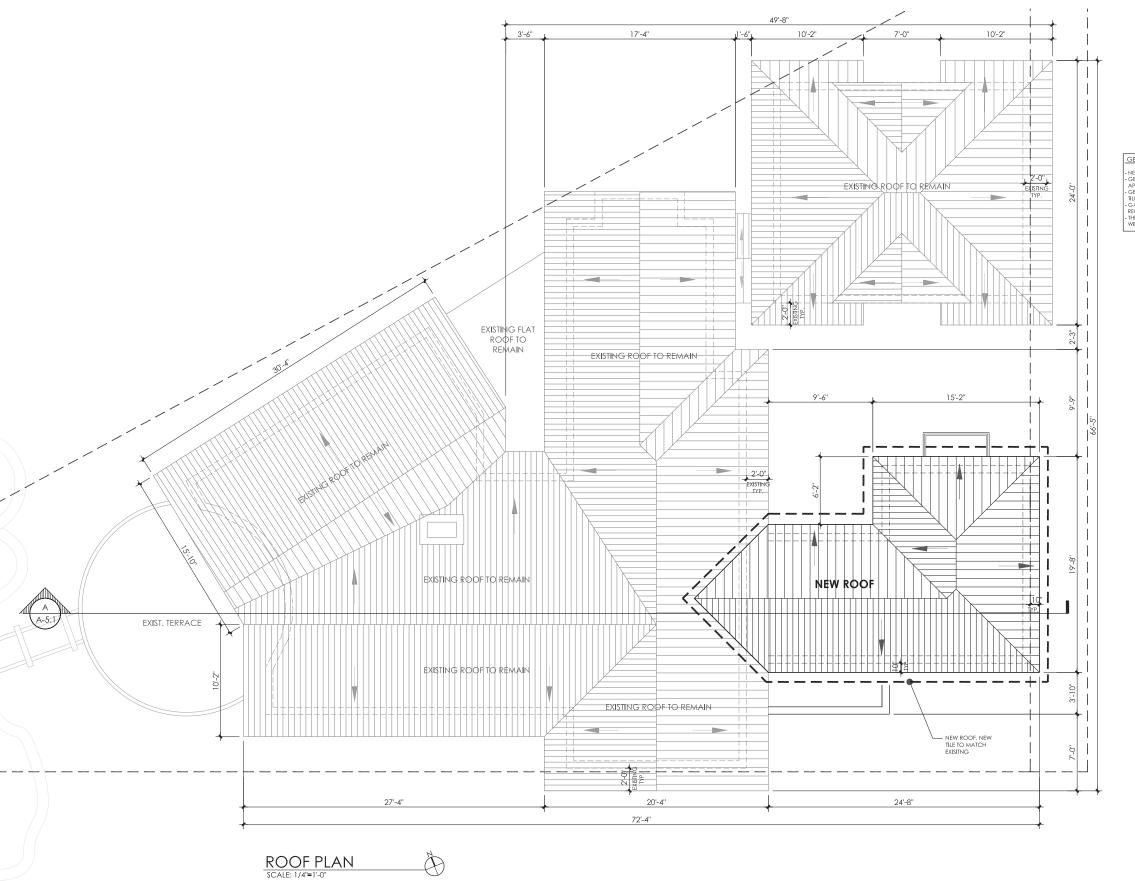- REFER FLOOR PLAN FOR EXACT LOCATION OF NEW WINDOWS.

- REFER TO FLOOR PLANS FOR WIND PRESSURES OF WINDOWS NOT REFLECTED IN ELEVATIONS.

ARCHITECTS

JOHN R. MEDINA & ASSOC.

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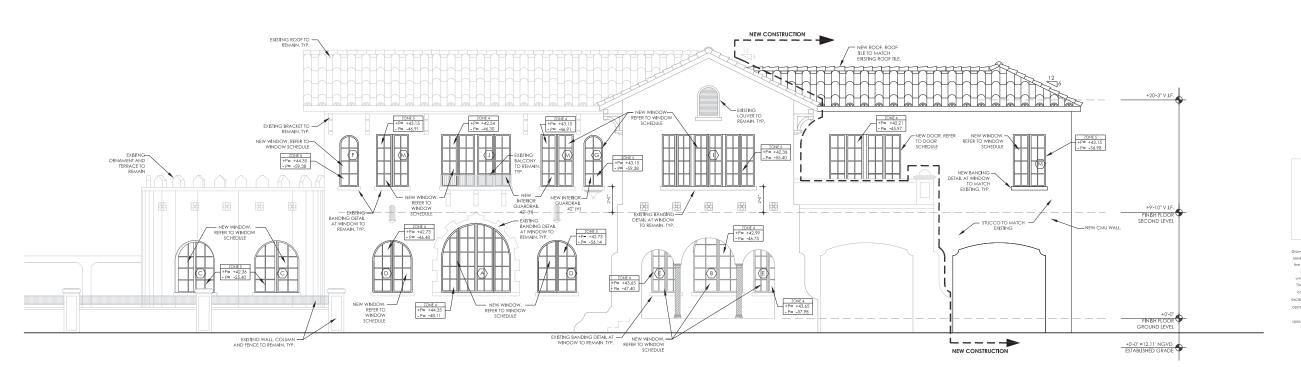
John Richard Medina & Associates, Architects

FADEL RESIDENCE



NORTH ELEVATION SCALE: 1/4"=1'-0"

ZONE 4 +P= +43.23 - P= -46.99



SOUTH ELEVATION
SCALE: 1/4"=1'-0"

BOA 4.1 SCHEMATIC DESIGN - NOT FOR CONSTRUCTION -

NORTH & SOUTH ELEVAT**I**ON


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REVISIONS DATE


& Associates, Architects

NOTE:

- OPERABLE WINDOWS AT SECOND LEVEL TO BE 36" MIN FROM FINISH FLOOR, IF EXISTING WINDOW IS BELOW 36" AFF. ADD A CONTROL DEVICE THAT ALLOWS A 4" Ø SPHERE REJECTED. REFER TO WINDOW SCHEDULE FOR WINDOWS WITH THIS REQUIREMENT.

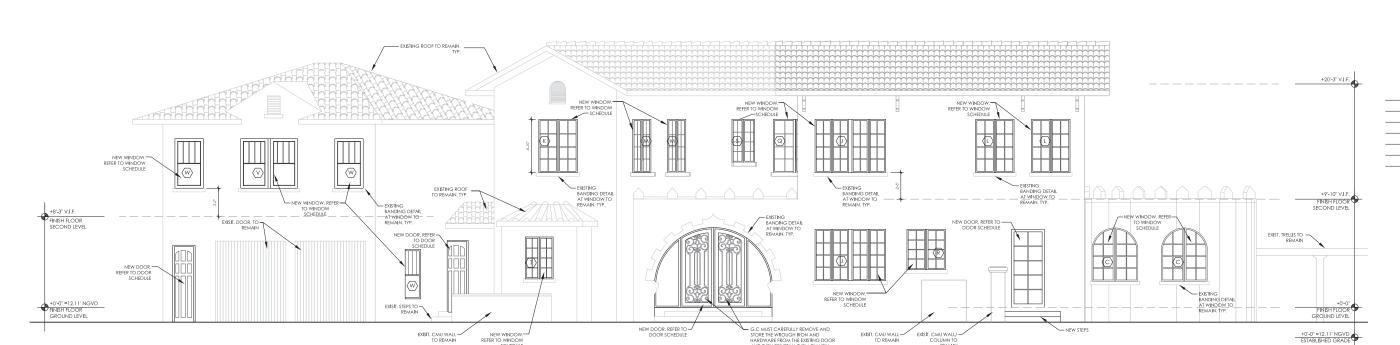

NORTH ELEVATION SCALE: 1/4"=1'-0"

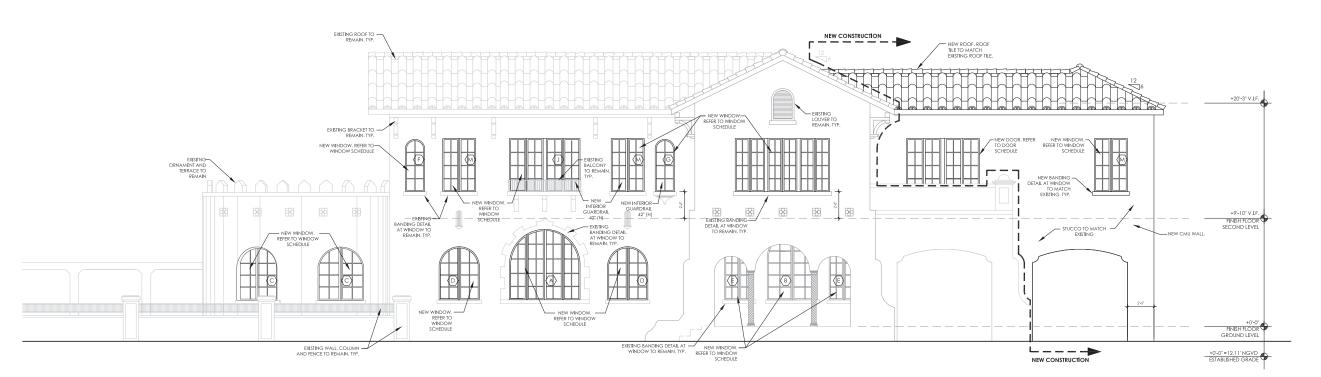

SOUTH ELEVATION SCALE: 1/4"=1'-0"

John Richard Medina **VOID**

JOHN RICHARD MEDINA AR 014867

FADEL RESIDENCE

817 Alhambra Circle, Coral Gables, FL 33134

NORTH & SOUTH SCALE:1/4"=1"-0" DATE:10-2020 DRAWN: MR

SCHEMATIC DESIGN

4901 S.W.75th Avenue Miami, Florida 33155 T 305.740.0554 F 305.740.5355 jrmainc@bellsouth.net


revisions date

NOTE:

- OPERABLE WINDOWS AT SECOND LEVEL TO BE 36" MIN FROM FINISH FLOOR, IF EXISTING WINDOW IS BELLOW 36" AFF. ADD A CONTROL DEVICE THAT ALLOWS A 4" Ø SPHERE REJECTED. REFER TO WINDOW SCHEDULE FOR WINDOWS WITH THIS REQUIREMENT.
- REFER FLOOR PLAN FOR EXACT LOCATION OF NEW WINDOWS.


WINDOWS.

- REFER TO FLOOR PLANS FOR WIND PRESSURES OF WINDOWS NOT REFLECTED IN ELEVATIONS.

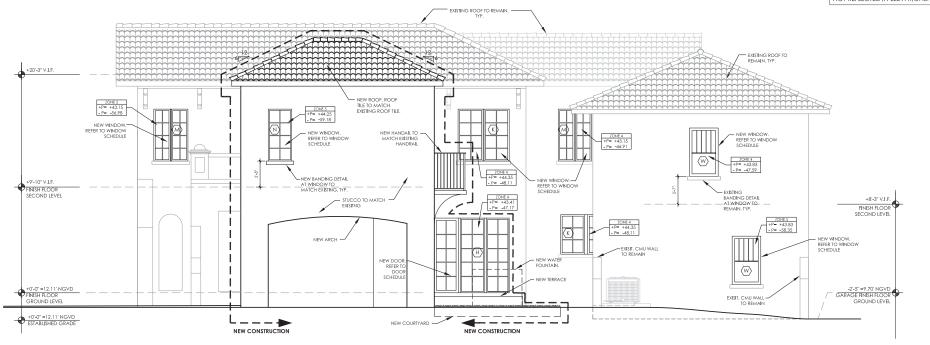

EAST ELEVATION

SCALE: 1/4"=1'-0"

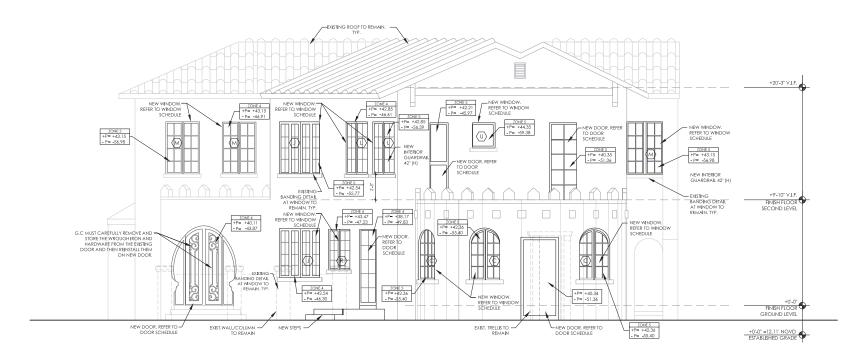

WEST ELEVATION
SCALE: 1/4"=1"-0"

John Richard Medina & Associates, Architects

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817 Alhambra Circle, Coral Gables, FL 33134

SCALE:1/4"=1'-0" DATE: DRAWN: MR EAST & WEST ELEVATION

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revisions date

John Richard Medina & Associates, Architects




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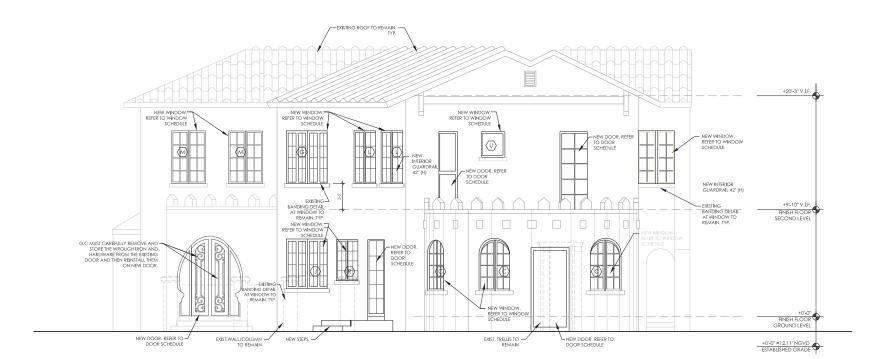
EAST & WEST SCALE:1/4"=1'-0"
ELEVATION DATE:10-2020
DRAWN: MR

NOTE:

- OPERABLE WINDOWS AT SECOND LEVEL TO BE 36" MIN FROM FINISH FLOOR, IF EXISTING WINDOW IS BELOW 36" AFF. ADD A CONTROL DEVICE THAT ALLOWS A 4" Ø SPHERE REJECTED. REFER TO WINDOW SCHEDULE FOR WINDOWS WITH THIS REQUIREMENT.

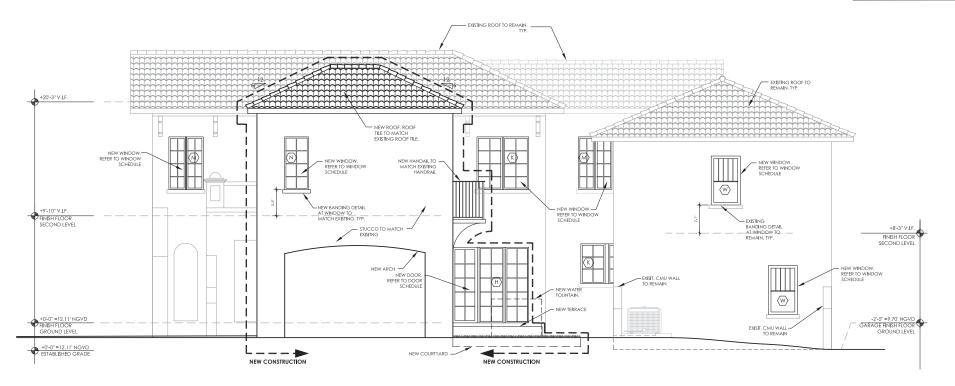

EAST ELEVATION SCALE: 1/4"=1'-0"



WEST ELEVATION SCALE: 1/4"=1'-0"

SCHEMATIC DESIGN - NOT FOR CONSTRUCTION -



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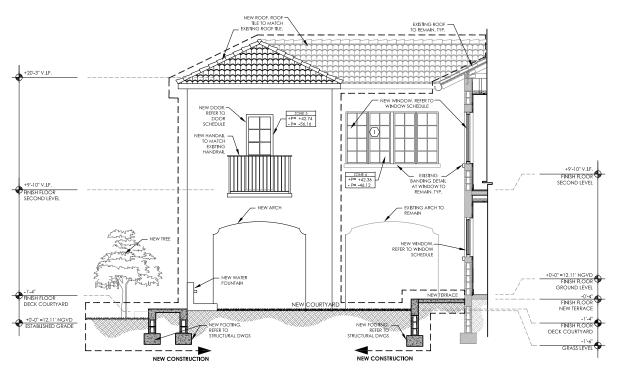


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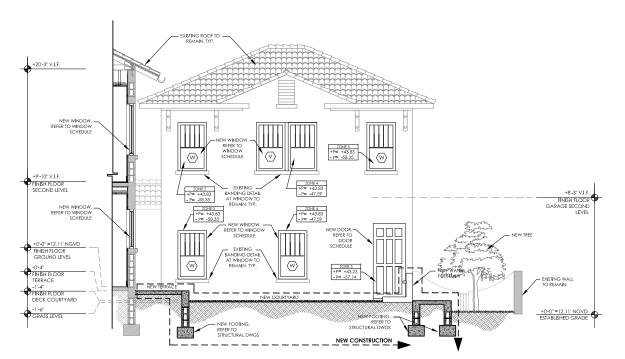
INTERIOR NORTH & SCALE:1/4"=1-0"

SOUTH
ELEVATION/SECTION

SCALE:1/4"=1-0"
DATE: 2/2021
DRAWN: MR



INTERIOR NORTH ELEVATION/SECTION SCALE: 1/4"=1'-0"



INTERIOR SOUTH ELEVATION/SECTION SCALE: 1/4"=1'-0"

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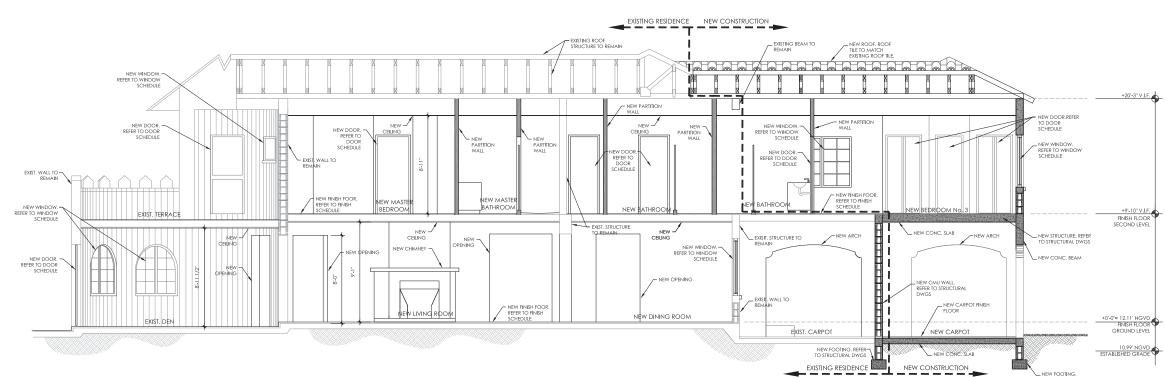
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817 Alhambra Circle, Coral Gables, FL 33134 SECTIONS SCALE:1/4"=1'-0" DATE:09-2020 DRAWN: MR

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SECTION SCALE = 1/4"=1'-0"

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Associates, Arch ≪ John Richard Medina


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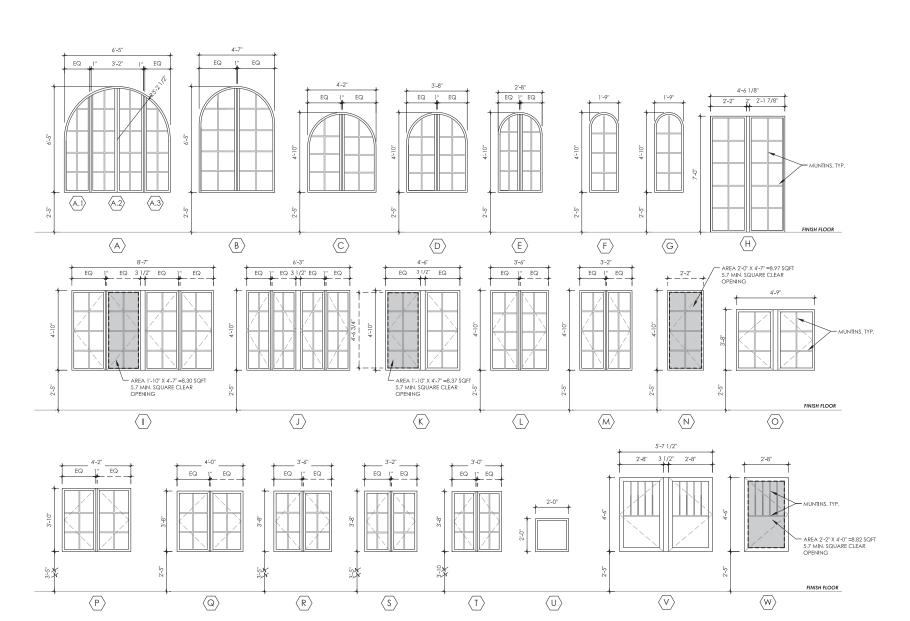
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WALL SECTION SCALE:1/4"=1'-0" DATE:09-2020 DRAWN: MR



1 TYP. TWO STORY WALL SECTION SCALE = 3/4"=1'-0"



WINDOW ELEVATIONS

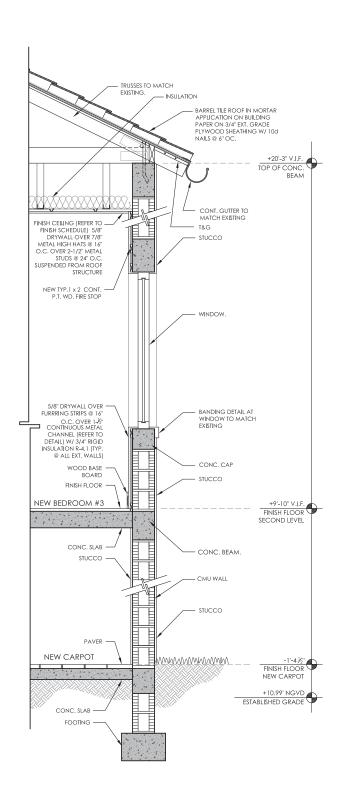SCALE: 3/8"=1'-0"

W	NDOW SCH	IEDULE			
NO.	TYPE	WIDTH	HEIGHT	FINISH	REMARKS
	A.1 FIXED	1'-6 1/2"			
A	A.2 FIXED	3'-3"	6'-5"	ESP/BR	W/ MULLIONS
'`	A.3 FIXED	1'-6 1/2"]		CUSTOM ARCH
В	FIXED	(2) 2'-3"	6'-5"	ESP/BR	CUSTOM ARCH - W/ MULLION
С	FIXED	4'-2"	4'-10"	ESP/BR	CUSTOM ARCH - W/ MULLION
D	FIXED	3'-8"	4'-10"	ESP/BR	CUSTOM ARCH - W/ MULLION
Е	FIXED	2'-8"	4'-10"	ESP/BR	CUSTOM ARCH - W/ MULLION
F	FIXED	1'-9"	4'-10"	ESP/BR	CUSTOM ARCH
G	FIXED	1'-9"	4'-10''	ESP/BR	CUSTOM ARCH
Н	FIXED	(2) 2'-2"	6'-5"	ESP/BR	W/ MULLION
	CASEMENT	(2) 4'-1 3/4"	4'-10"	ESP/BR	W/ MULLION - 4" SPHERE REJECTED
J	CASEMENT	(2) 2'-11 3/4"	4'-10"	ESP/BR	W/ MULLION - 4" SPHERE REJECTED
K	CASEMENT	(2) 2'-1 1/4"	4'-10"	ESP/BR	W/ MULLION - 4" SPHERE REJECTED
L	CASEMENT	3'-6"	4'-10"	ESP/BR	W/ MULLION - 4" SPHERE REJECTED
M	CASEMENT	3'-2"	4'-10"	ESP/BR	W/ MULLION - 4" SPHERE REJECTED
N	CASEMENT	2'-2"	4'-10"	ESP/BR	W/ MULLION - 4" SPHERE REJECTED
0	CASEMENT	4'-9"	3'-8"	ESP/BR	W/ MULLION - 4" SPHERE REJECTED
Р	CASEMENT	4'-2"	3'-10"	ESP/BR	W/ MULLION - 4" SPHERE REJECTED
Q	CASEMENT	4'-0''	3'-8"	ESP/BR	W/ MULLION - 4" SPHERE REJECTED
R	CASEMENT	3'-6"	3'-8"	ESP/BR	W/ MULLION - 4" SPHERE REJECTED
S	CASEMENT	3'-2"	3'-8"	ESP/BR	W/ MULLION - 4" SPHERE REJECTED
T	CASEMENT	3'-0''	3'-8"	ESP/BR	W/ MULLION - 4" SPHERE REJECTED
U	FIXED	2'-0"	2'-0"	ESP/BR	
V	CASEMENT	(2) 2'-8"	4'-6"	ESP/BR	W/ MULLION - 4" SPHERE REJECTED
l w	CASEMENT	2'-8"	4'-6"	ESP/BR	4" SPHERE REJECTED

SECURITY AND FORCED ENTRY PREVENTION (CHAPTER 36 SFBC)

- 1. PROVIDE INTRUSION AND BURGLARY SECURITY DEVICES AS SET FORTH IN CHAPTER 36 OF THE SOUTH FLORIDA BUILDING CODE.
 2. ALL LOCKS ON EXTERIOR DOORS SHALL BE CAPABLE OF RESISTING A FORCE OF 300 LBS. APPUED IN ANY MOVEABLE DIRECTION AN IN ACCORDANCE WITH RESISTANCE STANDARDS SET FORTH N THE SOUTH FLORIDA BUILDING CODE.
 3. ALL SINGLE EXTERIOR SWING DOORS SHALL HAVE A LOCK TO BE KEY OPERATEDFROM THE EXTERIOR WITH A MINIMUM OF 6000 POSSIBLE KEY CHANGES OR LOCKING AUXILIARY SINGLE DEAD BOLT WITH HAXDENDED BOLT INSERTS.
 4. THE ACTIVE LEAF OF PAIRS OF EXTERIOR SWING DOORS SHALL HAVE SAME LOCKS AS REQUIRED FOR SINGLE EXTERIOR SWING DOORS.
 THE INACTIVE LEAF SHALL HAVE MULTIPLED POINTS OF LOCKS WITH 5/8" MIN. THROW BOLTS WITH INSERTS.
 5. JAMBS OF ALL EXTERIOR OFFSET TYPE IN SWING DOORS SHALL BE RABBETED OR OFSIMILAR FABRICATION TO PREVENT DEFEATING THE PURPOSE OF THE STRIKE AND THE INTEGRITY OF THE LOCKS AND LATCHES.
 6. HINGES ON EXTERIOR OUT SWINGING DOORS SHALL HAVE NONREMOVABLE PINS AND NON-EXPOSED SCREWS.
 7. GLASS AND EXTERIOR OUTS SWINGING DOORS SHALL HAVE NONREMOVABLE PINS AND NON-EXPOSED SCREWS.
 8. VISION PANEL EXTERIOR DOORS SHALL COMPLY WITH THE AMERICAN NATIONAL STANDARDS INSTITUTE STANDARD 2971.
 8. VISION PANEL EXTERIOR DOORS OTHER THAN GLAZING WITHIN 40" OF THE INSIDE LOCKING ACTIVATING DEVICE OF LOOSE AND SWING DOORS SHALL COMPLY WITH THE AMERICAN NATIONAL STANDARD INSTITUTE STANDARD 2971.
 9. WINDOWS SHALL BE INSTALLED AND CONSTRUCTED SO THAT NO PANEL CAN BE LIFTED FROM THE TRACKS WHEN IN THE LOCKED POSITION AND SO AS TO COMPLY WITH THE AMERICAN NATIONAL STANDARD INSTITUTE STANDARDS FOR FORCE ENTRY RESISTANCE AAMA 13033 PROVIDE LOCKS AS PER SFBA 36032 (A), (B)2. (AA) AND (C) EXTERIORWINDOW SHALL BE LOCKED WITH DEVICE CAPABLE OF

- 13033 PROVIDE LOCKS AS PER SFBA 36032 (A), (B)2, (AA) AND (C) EXTERIOR WINDOW SHALL BE LOCKED WITH DEVICE CAPABLE OF WITHSTANDING A FORCE OF 150LBS, APPLIED IN AN OPERABLE DIRECTION.
- 10. EXTERIOR WINDOWS USED AS A MEANS OF ESCAPE SHALL ALSO COMPLY WITH A DOOR SCOPE OR VISION PANELS.
- 11. FRONT MAIN ENTRANCE DOORS SHALL BE PROVIDED WITH A DOOR SCOPE OR VISION PANELS.
 12. GLAZING WITHIN 36" HORIZONTALLY AND 60" VERTICALLY OF SHOWERS/TUBS SHALL BE" CAT II SAFETY GLASS" AS PER 2405.2 FBC
- 13. CONTRACTOR TO REFER TO PLANS, SECTIONS AND ELEVATIONS FORLOCATIONS AND DETAILS (IF ANY DISCREPANCIES ARE FOUND, ARCHITECT SHOULD BE NOTIFIED).

 14. GC. TO CONFIRM THAT ALL DIMENSION ARE CORRECT PRIOR TOFABRICATION OFDOORS AND WINDOWS
- 15. GC. TO PROVIDE SHOP DRAWINGS STAMPTED WITH THEIR TITLE BLOCK AND ACTION TAKEN. EITHER "APPROVED
- AS NOTED" OR "REJECTED AND RESUBMITED".

 16. GC. TO VERIFY THAT THE PRODUCT APPROVAL DOCUMENTS SUBMITTED FOR DOORSAND WINDOWS ARE IN COMPLIANCE WITH ARCHITECT DWGS.

- 16. GC. TO VERHY HAT HER PRODUCT APPROVAL DOCUMENTS SUBMITTED FOR DOCKSAND WINDOWS ARE IN COMPLIANCE WITH ARCHITECT DWGS.

 17. GC. IS RESPONSIBLE FOR OBTAINING FULL APPROVAL FROM BUILDING & ZONING DEPARTMENT FOR EXTERIOR

 WINDOWS AND DOORS SHOPDRAWINGS PRIOR TO PLACING ORDER.

 18. THE WIND LOAD CALCULATIONS, MASONRY OPENINGS AND MULLIONS REFLECTED IN THE ARCHITECTURAL DRAWINGS WILL NOT BE CONSIDERED

 FINAL UNTIL THE SHOP DRAWINGS HAVE RECEIVED FINAL APPROVAL FROM THE BUILDING AND ZONING DEPARTMENT.

 19. IN THE EVENT THAT THE WINDOWS AND DOORS ARE ORDERED AND/OR INSTALLED (WITHOUT RECEIVING PERMIT FROM CITY) THE G.C. WILL BE COMPLETELY

 RESPONSIBLE FOR ANY DISCREPANCIES THAT MAY RESULTEROM NOT HAVING APPROVED SET OF SHOP DRAWINGS BY THE BUILDING DEPT.
- 20. ALL FULL VIEW DOORS, FIXED & CASEMENT WINDOWS TO BE CGI IMPACT RESISTANT OR APPROVED EQUAL.
- 21. ALL DOOR HARDWARE TO BE APPROVED BY OWNER/ARCHITECT PRIOR TO PURCHASE.

 22. CONTRACTOR TO PROVIDE ARCHITECT WITH COMPLETE PACKAGE OF WINDOW AND EXTERIOR DOOR SUBMITTAL IN BINDER INCLUDING PRODUCT PPROVALS. THIS WILL INCLUDE SHOP DRAWINGS.
- 23. ALL OPENINGS (SIZE & LOCATION) TO BE COORDINATED WITH WINDOWSCHEDULE, STRUCTURAL DRAWINGS & MANUFACTURER'S MASONRY OPENING REQUIREMENTS. ARCHITEC TO BE NOTIFIED IN CASE OF ANYDISCREPANCES.
- 24. CONTRACTOR TO VERIFY SWING SIDE OF WINDOWS AND DOORS AS PERELEVATIONS AND OR FLOOR PLANS PRIOR TO PURCHASE

JOHN R. MEDINA & ASSOC.

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REVISIONS	DATE	BY
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Architects ciates, Assoc ⋖ Medina Richard John



JOHN RICHARD MEDINA AR 014867

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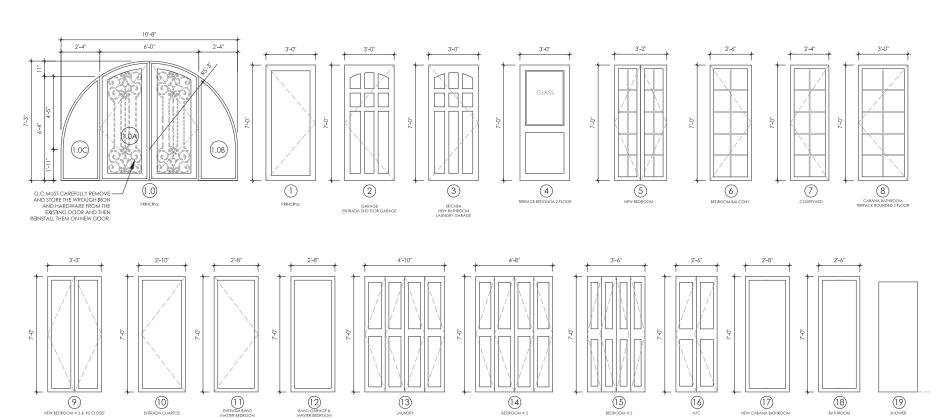
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WINDOWS SCHEDULE

DATE:09-2020 DRAWN: MR

BOA A 7.1 SCHEMATIC DESIGN



DOOR ELEVATIONS

SCALE: 3/8"=1'-0"

DOOR SCHEDULE								
No.	TYP	Έ	WIDTH	HEIGHT	THK	DOOR	FRAME	REMARKS
	1.0A	EXTERIOR FULL VIEW	6'-0"	7'-3"				
1.0	1.0B	SIDELITE	2'-4"	6'-4"	1' 3/4"	GL	ALUM.	
	1.0C	SIDELITE	2'-4"	6'-4"				
1	EXTERI	OR DOOR	3'-0"	7'-0"	1' 3/4"	WD	WD	
2	EXTERI	OR DOOR	3'-0"	7'-0"	1' 3/4"	WD	WD	HINGE AT LEFT
3	EXTERI	OR DOOR	3'-0"	7'-0"	1' 3/4"	WD	WD	HINGE AT RIGHT
4	EXTER	OR DOOR	3'-0"	7'-0"	1' 3/4"	WD	WD	W/ GLASS
5	EXTERI	OR DOOR	3'-2"	7'-0"	1' 3/4"	GL	ALUM.	
6	EXTER	OR DOOR	2'-6"	7'-0"	1' 3/4"	GL	ALUM.	HINGE AT RIGHT
7	EXTERI	OR DOOR	2'-4"	7'-0"	1' 3/4"	GL	ALUM.	HINGE AT LEFT
8	EXTER	OR DOOR	5'-8"	7'-0"	1' 3/4"	GL	ALUM.	
9	INTERI	OR SOLID	3'-3"	7'-0"	1' 3/4"	WD	WD	
10	INTERIO	OR SOLID	2'-10"	7'-0"	1' 3/4"	WD	WD	HINGE AT LEFT
11	INTERIO	OR SOLID	2'-8"	7'-0"	1' 3/4"	WD	WD	HINGE AT RIGHT
12	INTERIO	OR SOLID	2'-4"	7'-0"	1' 3/4"	WD	WD	
13	INTERIO	OR BY-FOLD DOOR	5'-5''	7'-0"	1' 3/4"	WD	WD	
14	INTERIO	OR BY-FOLD DOOR	4'-6"	7'-0"	1' 3/4"	WD	WD	
15	INTERIO	OR BY-FOLD DOOR	3'-6"	7'-0"	1' 3/4"	WD	WD	
16	INTERIO	OR BY-FOLD DOOR	2'-6"	7'-0"	1' 3/4"	WD	WD	
17	INTERIO	OR POCKET DOOR	2'-8"	7'-0"	1' 3/4"	WD	WD	
18	INTERI	OR POCKET DOOR	2'-6"	7'-0"	1' 3/4"	WD	WD	
19	SHOW	ER DOOR	2'-4"	6'-8"		GL	GL	HINGES & FRAME BRASS

NOTES:

- CONTRACTOR TO PROVIDE ARCHITECT WITH COMPLETE PACKAGE OF WINDOW AND EXTERIOR DOOR SUBMITTAL IN BINDER NCLUDING PRODUCT APPROVALS. THIS WILL INCLUDE SHOP DRAWINGS. - GENERAL CONTRACTOR TO VERIFY ACCEPTABILITY OF ALL PRODUCT APPROVALS FOR WINDOWS AND DOORS PRIOR
- O PURCHASE OF WINDOWS AND DOORS (TYPICAL).
- IO PORCHASE OF WINDOWS AND DOORS (11PICAL).

 *ALL FULL VIEW DOORS, FIXED, SINGLE HUNG & CASEMENT WINDOWS TO BE CGI IMPACT RESISTANT. (OR APPROVED EQUAL.)

 *-ALL FULL VIEW PANELS ADJACENT TO DOORS AND SHOWER ENCLOSURES SHALL BE CATEGORY II GLAZING.

 *-ALL EXTERIOR GLAZING ALUMINUM FRAMES TO BE " HUNTER GREEN " KEYNAR FINISH TO MATCH EXISTING. SAMPLE TO BE
- PROVIDED TO ARCHITECT PRIOR TO MANUFACTURING. ALL GLASS IN WINDOWS AND EXTERIOR DOORS TO BE CLEAR. (TYPICAL), SAMPLE TO BE PROVIDED TO OWNER FOR APPROVAL MPRIOR TO PURCHASE.
- GENERAL CONTRACTOR TO VERIFY SWING SIDE OF WINDOWS AND DOORS AS PER ELEVATIONS AND OR FLOOR PLANS
- CONTRACTOR TO FIELD VERIFY ALL DOOR & WINDOW DIMENSIONS PRIOR TO FABRICATION (TYPICAL) - G.C., TO STAMP THE SHOP DRWGS THAT THEY HAVE BEEN REVIEWED FOR PREFORMANCE AND EITHER APPROVED OR DISAPPROVED PRIOR TO SUBMITTAL TO ARCHITECT. ANY DISCREPANCIES SHOULD BE REPORTED AND FLAGGED UPON
- ALL DOOR HARDWARE TO BE APPROVED BY OWNER/ ARCHITECT PRIOR TO PURCHASE. G.C. TO PURCHASE AND INSTALL/COORDINATE INSTALLATION WITH SUB-CONTRACTORS.

 ALL STEEL COLUMNS TO HAVE COVER TO MATCH WINDOW FRAME MANUFACTURE
- PROVIDE FLASHING AROUND ALL EXTERIOR OPENINGS

SECURITY AND FORCED ENTRY PREVENTION (CHAPTER 36 SFBC)

- I. PROVIDE INTRUSION AND BURGLARY SECURITY DEVICES AS SET FORTH IN CHAPTER 36 OF THE SOUTH FLORIDA BUILDING
- CODE. 2. ALL LOCKS ON EXTERIOR DOORS SHALL BE CAPABLE OF RESISTING A FORCE OF 300 LBS. APPLIED IN ANY MOVEABLE DIRECTION AN IN ACCORDANCE WITH RESISTANCE STANDARDS SET FORTH NITHE SOUTH FLORIDA
- BUILDING CODE.

 3. ALL SINGLE EXTERIOR SWING DOORS SHALL HAVE A LOCK TO BE KEY OPERATEDFROM THE EXTERIOR WITH A MINIMUM OF 6000 POSSIBLE KEY CHANGES OR LOCKING AUXILIARY SINGLE DEAD BOLT WITHHARDENED BOLT INSERTS.

 4. THE ACTIVE LEAF OF PAIRS OF EXTERIOR SWING DOORS SHALL HAVE SAME LOCKS AS REQUIRED FOR
- SINGLE EXTERIOR SWING DOORS. THE INACTIVE LEAF SHALL HAVE MULTIPLIED POINTS OF LOCKS WITH 5/8" MIN. THROW
- BOLTS WITH INSERTS.

 5. JAMBS OF ALL EXTERIOR OFFSET TYPE IN SWING DOORS SHALL BE RABBETED OR OF SIMILAR FABRICATION TO PREVENT DEFEATING THE PURPOSE OF THE STRIKE AND THE INTEGRITY OF THE LOCKS AND LATCHES.
-). HINGES ON EXTERIOR OUT SWINGING DOORS SHALL HAVE NONREMOVABLE PINS AND NON-EXPOSED SCREWS. '. GLASS AND EXTERIOR DOORS SHALL COMPLY WITH THE AMERICAN NATIONAL STANDARDS INSTITUTE STANDARD 2971
- 8. VISION PANEL EXTERIOR DOORS OTHER THAN GLAZING WITHIN 40" OF THE INSIDE LOCKING ACTIVATING DEVICE OF
- LOOSE AND SWING DOORS SHALL COMPLY WITH THE AMERICAN NATIONAL STANDARD INSTITUTE STANDARD 2971.

 WINDOWS SHALL BE INSTALLED AND CONSTRUCTED SO THAT NO PANEL CAN BE LIFTED FROM THE TRACKS WHEN IN THE LOCKED POSITION AND SO AS TO COMPLY WITH THE ARCHITECTURAL ALUMINUM MGS. ASSOCIATION STANDARDS FOR FORCE ENTRY RESISTANCE AAMA 13033 PROVIDE LOCKS AS PER SFBA 36032 (A), (B)2, (AA) AND (C) EXTERIORWINDOW SHALL BE LOCKED WITH DEVICE CAPABLE OF WITHSTANDING A FORCE OF 150LBS, APPLIED IN AN OPERABLE DIRECTION 10. EXTERIOR WINDOWS USED AS A MEANS OF ESCAPE SHALL ALSO COMPLY WITH A DOOR SCOPE OR VISION PANELS.
- 11. FRONT MAIN ENTRANCE DOORS SHALL BE PROVIDED WITH A DOOR SCOPE OR VISION PANELS.
 12. GLAZING WITHIN 36" HORIZONTALLY AND 60" VERTICALLY OF SHOWERS/TUBS SHALL BE" CAT II SAFETY GLASS" AS PER 2405.2 FBC.
- 2405.2 FBC.

 13. CONTRACTOR TO REFER TO PLANS, SECTIONS AND ELEVATIONS FORLOCATIONS AND DETAILS (IF ANY DISCREPANCIES ARE FOUND, ARCHITECT SHOULD BE NOTIFIED).

 14. GC. TO CONFIRM THAT ALL DIMENSION ARE CORRECT PRIOR TOFABRICATION OFDOORS AND WINDOWS.

 15. GC. TO PROVIDE SHOP DRAWINGS STAMPTED WITH THEIR TITLE BLOCK AND ACTION TAKEN. EITHER "APPROVED AS NOTED" OR "REJECTED AND RESUBMITED".

- 16, GC, TO VERIFY THAT THE PRODUCT APPROVAL DOCUMENTS SUBMITTED FOR DOORSAND WINDOWS ARE IN COMPLIANCE WITH ARCHITECT DRAWINGS.

 17. GC. IS RESPONSIBLE FOR OBTAINING FULL APPROVAL FROM BUILDING &ZONING DEPARTMENT FOR EXTERIOR WINDOWS
- AND DOORS SHOPDRAWINGS PRIOR TO PLACING ORDER.

 8. THE WIND LOAD CALCULATIONS, MASONRY OPENINGS AND MULLIONS REFLECTED IN THE ARCHITECTURAL DRAWINGS WILL NOT BE CONSIDERED FINAL UNTIL THE SHOP DRAWINGS HAVE RECEIVED FINAL APPROVAL FROM THE BUILDING AND
- ZONING DEPARTMENT.
- 9. In the event that the Windows and doors are ordered and/or installed (without receiving permit from city) the G.C. will be completely responsible for any discrepancies that may result from not having APPROVED SET OF SHOP DRAWINGS BY THE BUILDING DEPT.

- APPROVED SET OF SHOP DIXAWINGS BY THE BUILDING DEPT.

 20. ALL FULL VIEW DOORS, FIXED & CASEMENT WINDOWS TO BE CGI IMPACT RESISTANT OR APPROVED EQUAL.

 21. ALL DOOR HARDWARE TO BE APPROVED BY OWNER/ARCHITECT PRIOR TO PURCHASE.

 22. CONTRACTOR TO PROVIDE ARCHITECT WITH COMPLETE PACKAGE OF WINDOW AND EXTERIOR DOOR SUBMITTAL IN BINDER INCLUDING PRODUCT PPROVALS. THIS WILL INCLUDE SHOP DRAWINGS.

 23. ALL OPENINGS (SIZE & LOCATION) TO BE COORDINATED WITH WINDOWSCHEDULE, STRUCTURAL DRAWINGS.
- MANUFACTURER'S MASONRYOPENING REQUIREMENTS, ARCHITEC TO BE NOTIFIED IN CASE OF ANYDISCREPANCES
- 24. CONTRACTOR TO VERIFY SWING SIDE OF WINDOWS AND DOORS AS PERELEVATIONS AND OR FLOOR PLANS PRIOR TO PURCHASE.

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Associates, Architects
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Sichard Medina

REVISIONS DATE

JOHN R. MEDINA & ASSOC.

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	JOHN RICHARD MEDINA AR 014867

John

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DOORS SCHEDULE

SCALE: AS SHOWN DATE:09-2020 DRAWN: MR

BOA A 7.2 SCHEMATIC DESIGN

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Associates, Architects John Richard Medina &

4 GREEN HUNTER IRON HANDRAIL

3 COURTYARD - TRAVERTINE RUNNING BOND PATTERN



5) WINDOWS & DOORS FRAMES CLEAR GLASS-GREEN HUNTER FRAMES




NEW ROOF - BARREL TILE





FADEL RESIDENCE

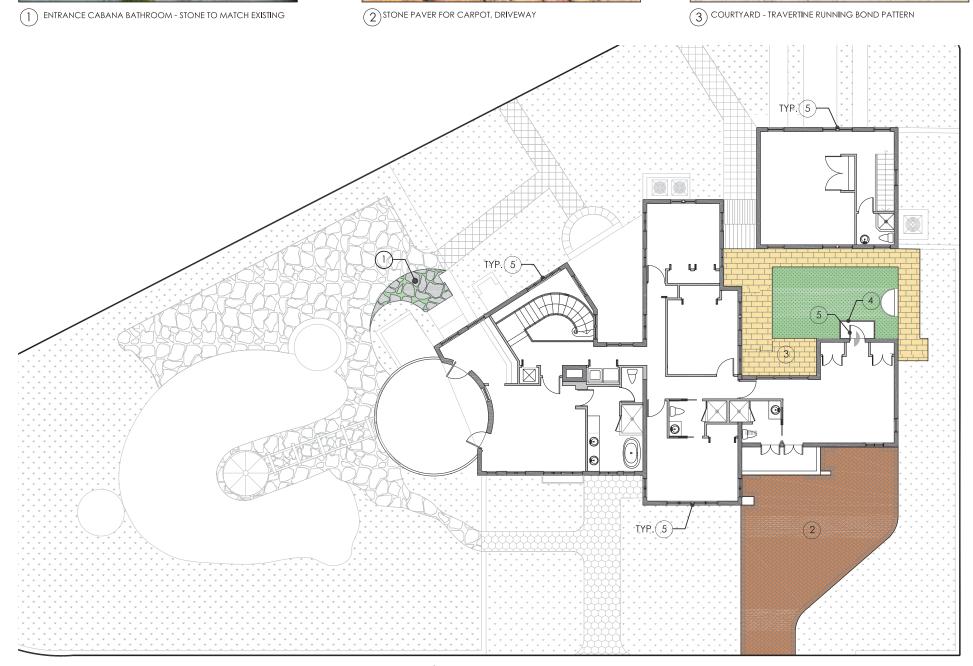

2) STONE PAVER FOR CARPOT, DRIVEWAY

