Tuesday, April 19, 2022

Mr. Ramon Trias
Planning and zoning Director
City of Coral Gables
427 Biltmore Way, 2nd Floor
Coral Gables, Florida 33134

Re: Statement of Use/ Conditional Use with Site Plan Review Application/ Property Located at 601 Sunset Drive, Coral Gables, Florida

Dear Mr. Trias:

On behalf of Sunset 8 LLC (the "Applicant"), we respectfully submit this Statement of Use in connection with the enclosed Planning Division Application for the proposed development of two (2) single family homes at the referenced property (the "Property") in accordance with section 3-206 of the City of Coral Gables Zoning Code. As discussed below, the proposed project will permit the construction of two beautiful single-family homes in scale and character with other homes in the neighborhood and consistent with the existing development trend along Sunset Drive.

I PROPERTY INFORMATION

The Property is comprised of 31,000 square feet of land and has a frontage along Sunset Drive, Tordera St. and Almansa St. The Property consists of six individually platted lots (lots 13 through 18, Block 236) of the plat entitled "Coral Gables, Riviera Section Part 11" as recorded in Plat Book 28, page 23 of the public Records of Miami-Dade County, Florida. The Property is currently vacant land.

Pursuant to the City's Future Land Use Map, the Property is currently designated Low Density and is zoned Single Family (SFR). The Applicant seeks approval for the separation of the Property into two distinct single-family lots ("**Proposed Lot Separation**"). As discussed further below, the approval of the Proposed Lot Separation will permit the development of appropriately scaled single family residences in harmony with the quality and size of the existing homes within the neighborhood. The proposed request is also consistent with the Property's underlying land use and zoning designations.

II ANALYSIS FOR PROPERTY SEPARATION

As detailed in the enclosed plans prepared by Studio Anda, the Applicant seeks to separate the Property into two lots and develop a high quality, single-family residence on each lot. The proposed separation would preserve the existing platted north-south boundary of the underlying lots to create a

western lot (the "West Parcel") and a eastern lot (the "East Parcel") of equal size, depth, and width. The proposed West parcel consists of lots 16 through 18 and is located at the northeast intersection of Tordera Street and Sunset Drive while the East Parcel consists of lots 13 through 15 and is located at the northwest intersection of Almansa Street and Sunset Drive. As discussed below, The Proposed Lot Separation and construction of single-family residences on the West and East Parcel comply with the applicable criteria established in Section 3-206(F) of Zoning Code and should be approved.

1. That the building site(s) created would have a lot area equal to or larger than the majority of the existing building sites of the same zoning designation within a minimum of one thousand (1,000) feet of the perimeter of the subject property. The Development Review Official may determine that the comparison of building sites within one thousand (1,000) feet of the subject property shall be based on one (1) or more of the following: building sites located on the same street as the subject property; building sites with similar characteristics such as golf course frontage, water frontage, cul-de-sac frontage; and, building sites within the same platted subdivision.

As mentioned above, the Proposed Lot Separation would divide the Property along Sunset Drive into two distinct building sites with a lot size of approximately 15,500 square feet each. By comparison, most of the properties along Sunset Drive and within the Rivera Section 11 plat are either equal or smaller than the proposed lots at the property. As illustrated in the Chart, over 90% of the properties fronting directly onto Sunset Drive contain a lot size equal to or less than 15,000 square feet. As such, the Proposed Lot Separation would result in creating a building site that will be more in proportion to the residential properties in the neighborhood. Additionally, the Proposed Lot Separation is consistent with the character of the surrounding neighborhood with respect to the scale and intensity.

	Address	Lot Size (Sq. ft.)
1	6950 Granada Blvd	15,000
2	6845 Veronese St.	10,000
3	533 Sunset Dr.	29,453
4	545 Sunset Dr.	7,950
5	6945 Almansa St.	7,950
6	615 Sunset Dr.	10,400
7	629 Sunset Dr.	10,400
8	705 Sunset Dr.	10,300
9	711 Sunset Dr.	12,700
10	741 Sunset Dr.	18,880
11	6930 Altamira St.	10,100
12	811 Sunset Dr.	10,100
13	825 Sunset Dr.	10,000
14	855 Sunset Dr.	10,000
15	901 Sunset Dr.	5,000*
16	921 Sunset Dr.	
17	925 Sunset Dr.	
18	927 Sunset Dr.	
19	929 Sunset Dr.	
20	937 Sunset Dr.	10,000

21	1001 Sunset Dr.	12,400
22	1011 Sunset Dr.	12,400
23	1025 Sunset Dr.	8,184
24	1075 Sunset Dr.	13,640
25	1101 Sunset Dr.	13,128
26	1111 Sunset Dr.	12,000
27	1221 Sunset Dr.	12,000
28	1131 Sunset Dr.	11,500
29	1141 Sunset Dr.	9,500
30	1151 Sunset Dr.	12,000
31	1161 Sunset Dr.	12,000
32	6945 Almansa St.	7,950
33	545 Sunset Dr.	7,950
34	533 Sunset Dr.	29,453
35	6945 Veronese St	10,000
36	6950 Granada Bldv	15,000
37	6945 Almansa St	7,950

2 That exceptional or unusual circumstances exist, that are site specific such as unusual site configuration or partially platted lots, or are code specific such as properties having two (2) or more zoning or land use designations, multiple facings or through-block sites, which would warrant the separation or establishment of a building site(s).

The existing Property comprises the entire front portion of the block fronting onto sunset Drive. Additionally, the property is uniquely situated in that it has three frontages with access onto Sunset Drive, Almansa St. and Tordera St. The Existing Property is one of the only properties fronting Sunset Drive, a major arterial roadway, that maintains a lot area over 20,000 square feet. The sizeable lot area of the Property coupled with the potential to construct a "McMansion" would disrupt the appealing scale and aptly designed residences in the area, and specifically along Sunset Drive. Thus, the Proposed Lot Separation would reduce the building site into lots of comparable size with those of the surrounding neighborhood, assist with reducing the building massing along Sunset Drive, and alleviate the number of frontage roads.

3. That the proposed building site(s) maintains and preserves open space and specimen trees, promotes neighborhood compatibility, preserves historic character, maintains property values and enhances visual attractiveness of the area.

The proposed development on the West Parcel and East Parcel are designed to provide over 60% green area on each lot where only 40% is required. The enhanced landscaping and preservation of certain specimen trees at the Property promotes the lush canopy setting unique to the City of Coral Gables and enhances the visual attractiveness of the Property for the residents, neighbors and commuters traveling along sunset Drive.

4. That the application satisfies at least three (3) of the following four (4) criteria:

a. That the building site(s) created would have a street frontage, golf course frontage (if applicable), and water frontage (if applicable) equal to or larger than the majority of the existing building sites of the same zoning designation within a minimum of one thousand (1,000) feet of the perimeter of the subject property. For a cul-de-sac building site(s), the comparison of street frontages and water frontages (if applicable) shall include those similarly situated cul-de-sac building sites within one thousand (1,000) feet. If no cul-de-sac building sites exist within one thousand (1,000) feet then the comparison may be expanded to include all cul-de-sac building sites within the platted subdivision and any adjacent platted subdivision.

The Property is uniquely situated along three street frontages: Almansa St. to the east, Tordera St. to the west and Sunset Dr. to the south. The property existing primary frontage along Sunset Dr. is approximately 200 feet wide with a depth of approximately 154 feet along both Almansa St and Tordera St. However, the Proposed Lot Separation will reduce the width of the building sites along Sunset Dr. to approximately 100 feet, which is more in line with the width of other lots along this corridor. Additionally, as discussed above, the Proposed Lot Separation will create two building sites that are still larger than most of the other lots in the area.

b. That the building site(s) separated or established would not result in any existing structures becoming non-conforming as it relates to setbacks, lot area, lot width and depth, ground coverage and other applicable provisions of the Zoning Code, Comprehensive Plan and City Code. The voluntary demolition of a building or structure within the last ten (10) years which eliminates any of the conditions identified in this criterion shall result in non-compliance with this criterion.

The Development of the Project is designed in accordance to the specific development regulations provided in Section 4-101 of the City's Zoning Code. As detailed in then site plan, the Project is incompliance with the minimum setbacks, lot width and depth, lot area and ground coverage required for SFR zoned properties.

c. That no restrictive covenants, encroachments, easements, or the like exist which would prevent the separation of the site. The voluntary demolition of a building or structure within the last ten (10) years which eliminates any of the conditions identified in this criterion shall result in non-compliance with this criterion.

The Property is currently vacant land. At one point there was an abandon house which was deemed an Unsafe structure by the city.

d. That the building site(s) created has been owned by the current owner continuously for a minimum of ten (10) years prior to an application submittal for conditional use for a building site determination.

The current owner acquired the property in 2019, At the time the Applicant obtained the property it was vacant land. Although the applicant has not owned the property for 10 years, he has been a resident of coral cables all his life and currently lives four streets from the current property. The applicant purchased the property in an effort build his family a home and enhanced the property, making two beautiful homes and making the neighborhood prettier.

III CONCLUSION

In light of the forgoing, the proposed separation of the property into two distinct lots is consistent with the scale and character of the surrounding residential neighborhood and complies with the applicable criteria for approval under City's Zoning code. The proposed project will also finally replace the demolished unsafe home with two new beautiful homes that will for certain enhance the visual aesthetics and property values in the area.

We look forward to your favorable consideration of our application. As always, should you have any questions or need any additional information, please don't hesitate to call me. 786-201-2563

Thank you,

Andres Mejia

City of Coral Gables Planning Division Application

305.460.5211

planning@coralgables.com

www.coralgables.com

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Appl	ı c a	t i o n 🔻	rec	uest	1

Abandonme Annexation Coral Gables Comprehens Comprehens Comprehens Comprehens Comprehens Conditional	ed applicant(s)/agent(s)/property owner(s) reque cation(s) (please check all that apply): ent and Vacations s Mediterranean Architectural Design Special Loc sive Plan Map Amendment - Small Scale sive Plan Map Amendment - Large Scale sive Plan Text Amendment Use - Administrative Review Use without Site Plan			eration and review of the
	Use with Site Plan			
☐ Developme				
	nt of Regional Impact			
☐ Developme	nt of Regional Impact - Notice of Proposed Chang	ge		
☐ Mixed Use S				
	ea Development Designation and Site Plan			
	ea Development Major Amendment			
	Covenants and/or Easements			
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<u> </u>	Establishment of a Building Site			
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	e Text Amendment			
Other:	rext Amendment			
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General	information			
	American State Charles (State Charles State			
Street address	of the subject property: 601 Sunset DR			<u> </u>
Property/proje	ct name: Sunset			
Legal description	on: Lot(s) PB 28-23 LOTS 13 THRU 18		1 2 m <u></u> 9	
Block(s) 236	Section (s	C GABLES RIV	IERA SEC 11 REV F	PL
Property owne	r(s): Sunset 8 LLC			
Property owne	er(s) mailing address: 7800 Red Rd ste 206 miami, 33	3143	4.	
Telephone:	Business 7862012563			
	Other			@ amminvestments.com

2186				
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Applicant(s)/a	agent(s): andres mejia			
Applicant(s)/a	agent(s) mailing address: 7800 Red Ro	d ste 206 miami fl 33143		
Telephone:	7000040500	Fax		
	Other	Email	andres	<u>@ anninivestifients.com</u>
Propert	:y information			
Current land	use classification(s): vacant residentia	1		
	g classification(s): single family-gener			
	d use classification(s) (if applicable):			
	ing classification(s) (if applicable): _			
t in the call				
Suppor	ting information (to	be completed b	y Plannin	g Staff)
information n Handbook, Se	ion Conference is required with the ecessary to be filed with the applicat ection 3.0, for an explanation of each wes the right to request additional info	ion(s). Please refer to the I	Planning Divison additional sheets	Development Review Process to application. The Planning
☐ Aerial.				
	roviding for property owner's author	rization to process applicat	tion.	
	n supporting materials.			
Application		in the second of the second		
	n representation and contact inform	nation.		
☐ Appraisal.	ral/building elevations.			
☐ Building flo				
	nsive Plan text amendment justifica	tion		
	nsive Plan analysis.	tion.		
	cy impact statement.			
Encroachm				
The second second	ental assessment.			
<u> </u>	ntextual study and/or historical sign	ificance determination.		
☐ Landscape				
Lighting pl	an.			
Transition -	nodel and/or 3D computer model.			
	al Gables Annual Registration Applic	cation and Issue Application	n Lobbyist forms	
	s, resolutions, covenants, developm			
Parking stu				
☐ Photograp	hs of property, adjacent uses and/o	r streetscape.		
☐ Plat.				
☐ Property s	urvey and legal description.			

☐ Property survey and legal description.					
☐ Public Realm Improvements Plan for mixed use projects.					
Public school preliminary concurrency analysis (residential la	and use/zo	ning applicat	ions on	ly).	
☐ Sign master plan.					
☐ Site plan and supporting information.					
☐ Statement of use and/or cover letter.					
☐ Streetscape master plan.					
☐ Traffic accumulation assessment.					
☐ Traffic impact statement.					
☐ Traffic impact study.					
☐ Traffic stacking analysis.					
Utilities consent.					
☐ Utilities location plan.					
☐ Vegetation survey.					
☐ Video of the subject property.					
☐ Warranty Deed.					
Zoning Analysis (Preliminary).					
☐ Zoning Code text amendment justification.					
Other:					

Application submittal requirements

- Hard copies. The number of application binders to be submitted shall be determined by Staff at the preapplication meeting. The application shall include all the items identified in the preapplication meeting.
- Digital media copy. One (1) thumb-drive of the entire application including all items identified in the Preapplication
 Conference. Each document shall be separated into PDF files (i.e., application; site plan, landscape plan; etc.).
 Please include a "Table of Contents" identifying all PDF file name(s). Each PDF file size shall not exceed 10 MB.

Applicant/agent/property owner affirmation and consent

- (I) (We) affirm and certify to all of the following:
- 1. Submission of the following:
 - a. Warranty deed/tax record as proof of ownership for all properties considered as a part of the application request; or
 - b. Authorized as the applicant(s)/agent(s) identified herein to file this application and act on behalf of all current property owner(s) and modify any valid City of Coral Gables entitlements in effect during the entire review process.
- 2. This request, application, application supporting materials and all future supporting materials complies with all provisions and regulations of the Zoning Code, Comprehensive Land Use Plan and Code of Ordinances of the City of Coral Gables unless identified and approved as a part of this application request or other previously approved applications. Applicant understands that any violation of these provisions renders the application invalid.
- 3. That all the information contained in this application and all documentation submitted herewith is true to the best of (my) (our) knowledge and belief.
- 4. Understand that the application, all attachments and fees become a part of the official records of the City of Coral Gables and are not returnable.

- 5. Failure to provide the information necessary pursuant to the established time frames included but not limited to application submittal, submission of revised documents, etc. for review by City Staff and the designated reviewing entity may cause application to be deferred without further review until such time the requested information is submitted.
- 6. All representatives of the application have registered with and completed lobbyist forms for the City of Coral Gables City Clerk's office.
- 7. Understand that under Florida Law, all the information submitted as part of the application are public records.
- 8. Additional costs in addition to the application fees may be assessed associated with the review of applications by the City. These are costs that may be incurred by the applicant due to consultant fees paid by City to review the application. The types of reviews that could be conducted may include but are not limited to the following: property appraisals; traffic impact analyses; vegetation/environmental assessments; archeological/historic assessments; market studies; engineering studies or reports; and legal fees. Such fees will be assessed upon finalization of the City application review.

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Property owner(s) signature(s):	Property owner(s) print name:			
The state of the s	Sunset 8 LLC/ Alvoro Andrew Megiq			
Property owner(s) signature(s):	Property owner(s) print name:			
Property owner(s) signature(s):	Property owner(s) print name:			
Address: 601 Sonset Dr Coial Gables &C 33	146			
Telephone: 786-201-2563 Fax:	Email: andres pamminues then to			
NOTARIZATION STATE OF FLORIDA/COUNTY OF Migm. Dade The foregoing instrument was acknowledged before me this 24th day of February, 2021 by Alvaro Andres Meying (Signature of Notary Public - State of Florida) GARY L. FOGAL NOTARY PUBLIC STATE OF FLORIDA Comm# GG218519 Expires 6/3/2022				
(Print, Type or Stamp Commissioned Name of Notary Public) Personally Known OR A Produced Identification; Type of Identification Produced 「こしゃ」 アンシャン・シャン・シャン・シャン・シャン・シャン・シャン・シャン・シャン・シャン				

SUNSET RESIDENCE 601 SUNSET DRIVE - EAST

CORAL GABLES, FLORIDA

SUBMITTAL COMPARISONS




1. RESTUDY FRONT MASSING AND USE OF PLANTERS


2. CORRECT PLANS TO REPRESENT WHAT IS BEING SHOWN AND DETAILING

3. DETAIL DESIGN


4. GARAGE IS APPROPRIATE IN FRONT, RESTUDY MATERIAL USE.




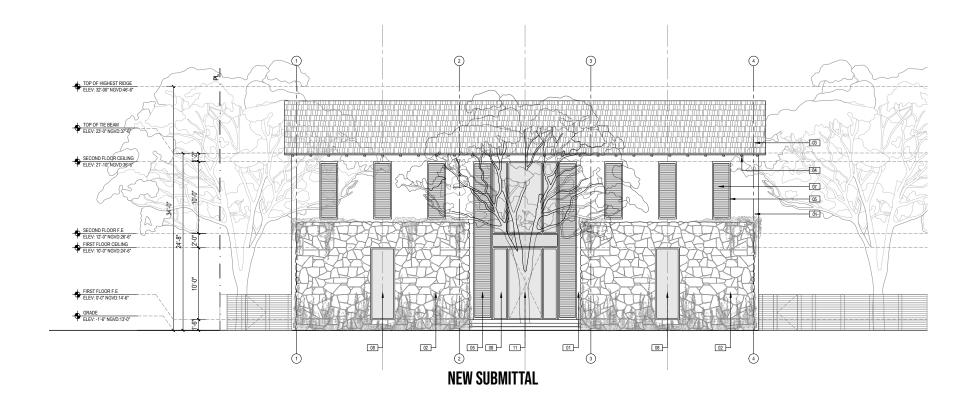

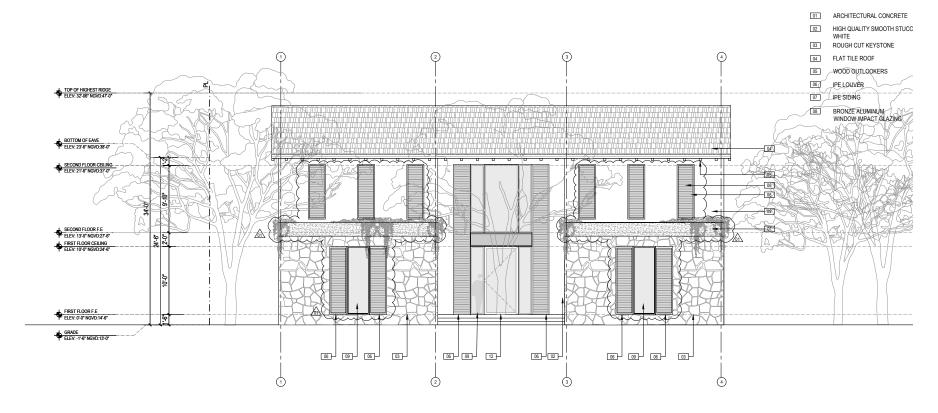




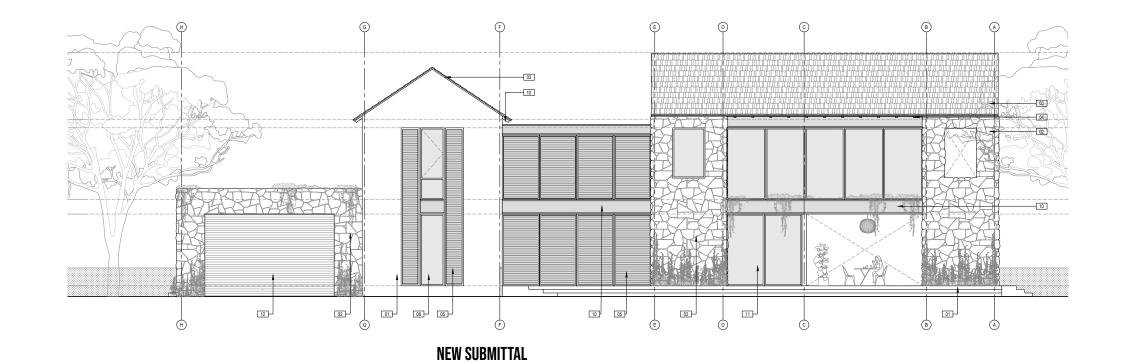

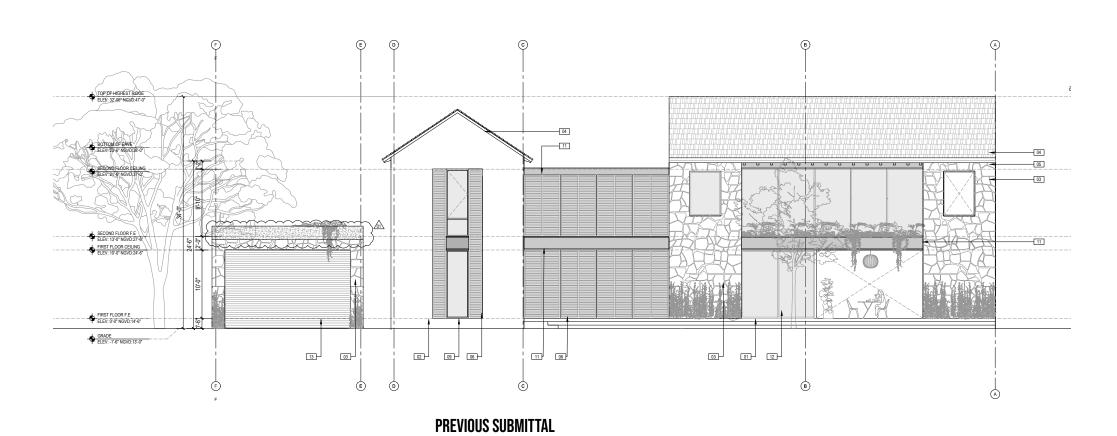




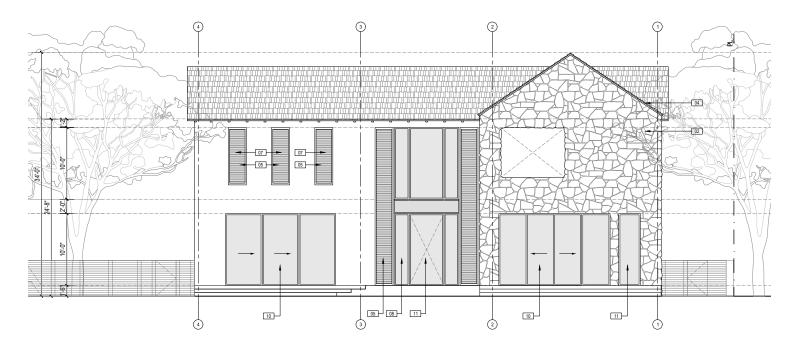


NEW SUBMITTAL





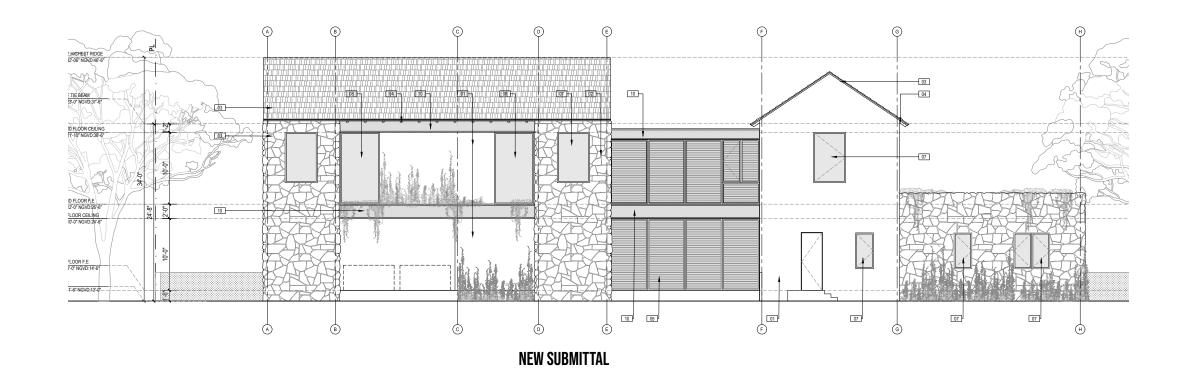

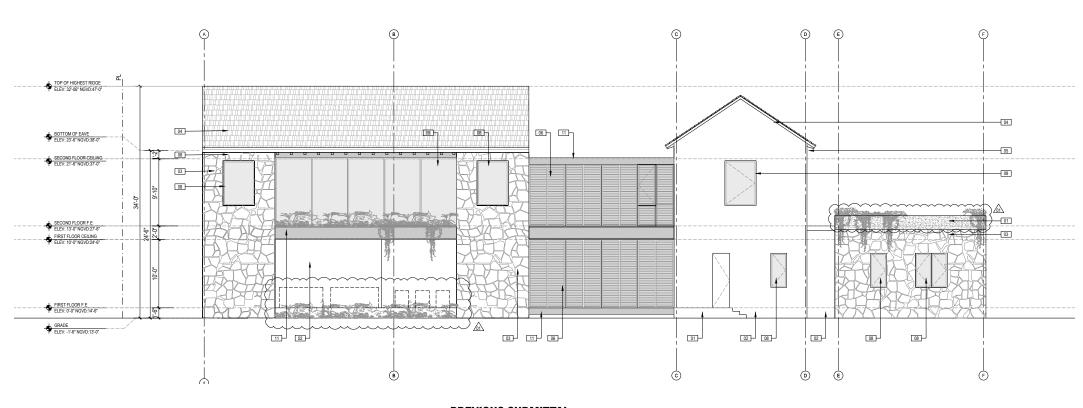





CORAL GABLES RESIDENCE



CORAL GABLES RESIDENCE



1920 GRANADA BLVD

CORAL GABLES RESIDENCE



CORAL GABLES COUNTRY CLUB



CORAL GABLES COUNTRY CLUB







SUNSET RESIDENCE - EAST

PROJECT LOCATION: 601 SUNSET DRIVE CORAL GABLES, FL 33143

PROJECT CLIENT/OWNER(S): SUNSET 8, LLC

ARCHITECT:
ANA GUARACAO SERRANO
LIC#:AR100664
1800 N BAYSHORE DRIVE, #402
MIAMI,FL 33132
PH:(214)708-7454

STRUCTURAL ENGINEERING:

MEP ENGINEERING:

LANDSCAPE ARCHITECT:

PROFESSIONAL SEALS:



<u>√02</u> 04.07.2022 BOA REV.2

01.28.2022

DATE DESCRIPTION

BOA REV.1

SHEET ISSUE/ REVISION LOG

This drawing is the property of Studio Anda LLC unless otherwise provided for by contract. The contents of this drawing are confidential and shall not be transmitted to any other party except as agreed to by the architect.

"In my professional judgement and to the best of my knowledge and belief, these plans and specifications comply with F.B.C. 7th Edition (2021).

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PROJECT ID:	DRAWN BY:
1001	MG
PRINT DATE:	SCALE:
04.07.22	NA

DRAWING TITLE:

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STUDIO ANDA

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DRAWING TITLE:

RENDER

ARCHITECTURE SHEET INDEX

GENERAL

INDEX AND DATA

CONTEXT AND EXISTING PHOTOS

CONTEXT AND EXISTING PHOTOS

SITE SURVEY

ZONING DATA SITE PLAN

FIRST FLOOR PLAN

SECOND FLOOR PLAN


A102 A103 **ROOF PLAN**

ELEVATIONS


ELEVATIONS SECTIONS


A500 DETAIL

GRAPHICAL SYMBOLS

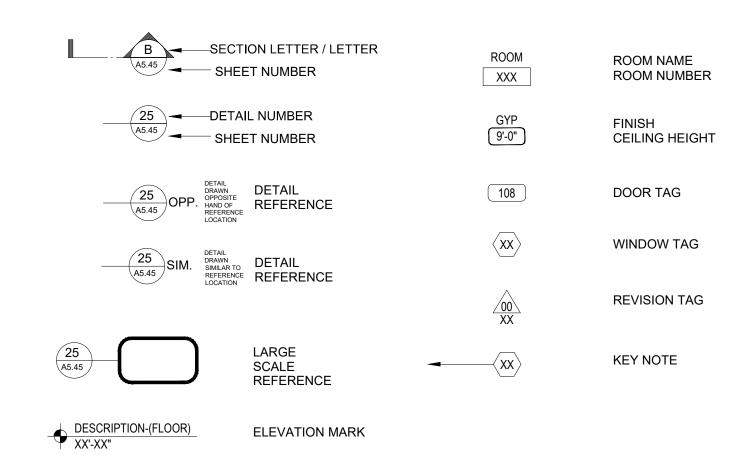

LOCATION:

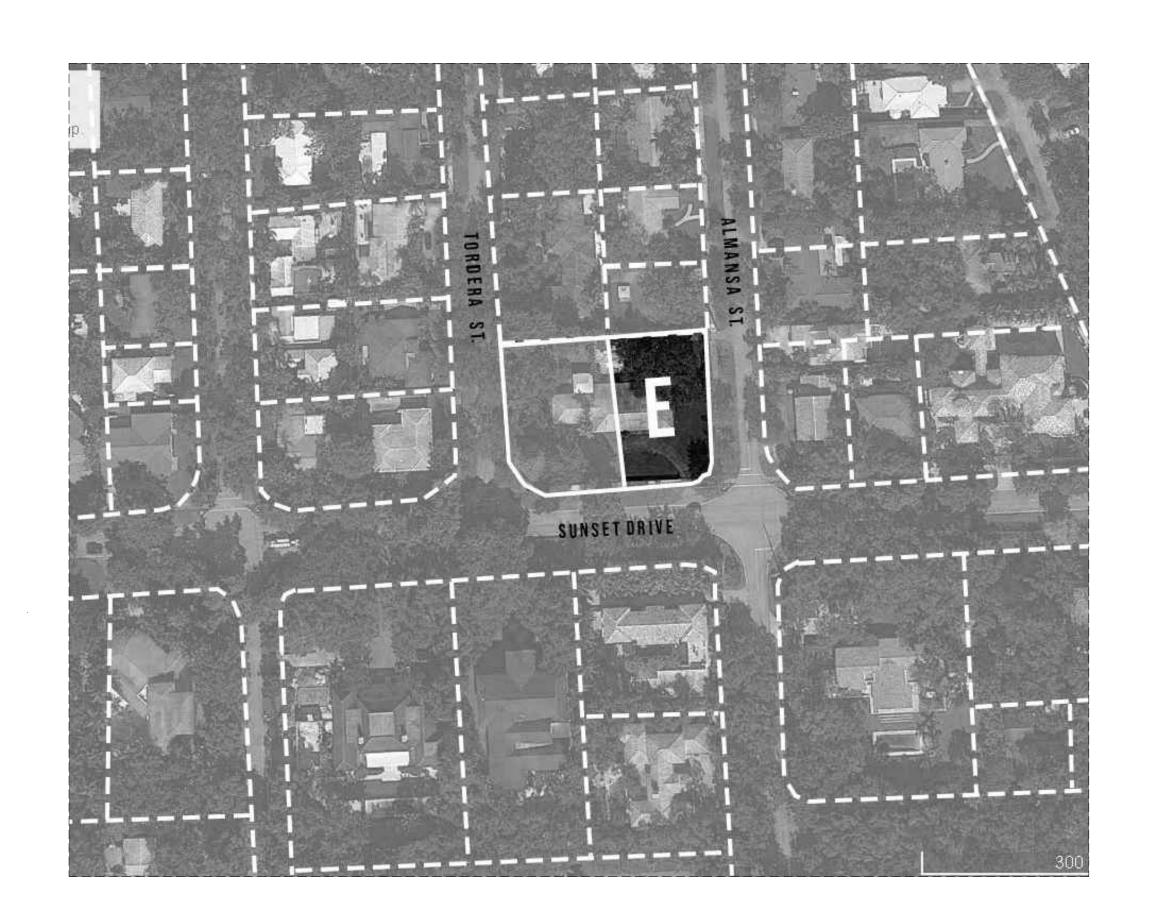

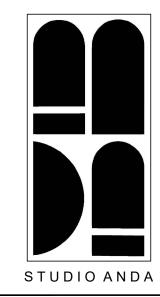

PROJECT TITLE:

SUNSET 8, LLC

SUNSET RESIDENCE - EAST

PROJECT LOCATION: 601 SUNSET DRIVE CORAL GABLES, FL 33143

PROJECT CLIENT/OWNER(S):


ARCHITECT: ANA GUARACAO SERRANO LIC#:AR100664 1800 N BAYSHORE DRIVE, #402 MIAMI,FL 33132 PH:(214)708-7454

STRUCTURAL ENGINEERING:

MEP ENGINEERING:

LANDSCAPE ARCHITECT:

PROFESSIONAL SEALS:

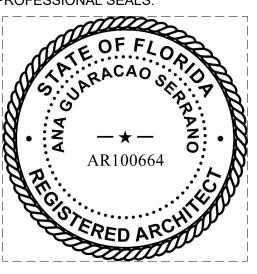

<u>02</u> 04.07.2022 BOA REV.2

<u>01\</u> 01.28.2022

DESCRIPTION

SHEET ISSUE/ REVISION LOG

BOA REV.1

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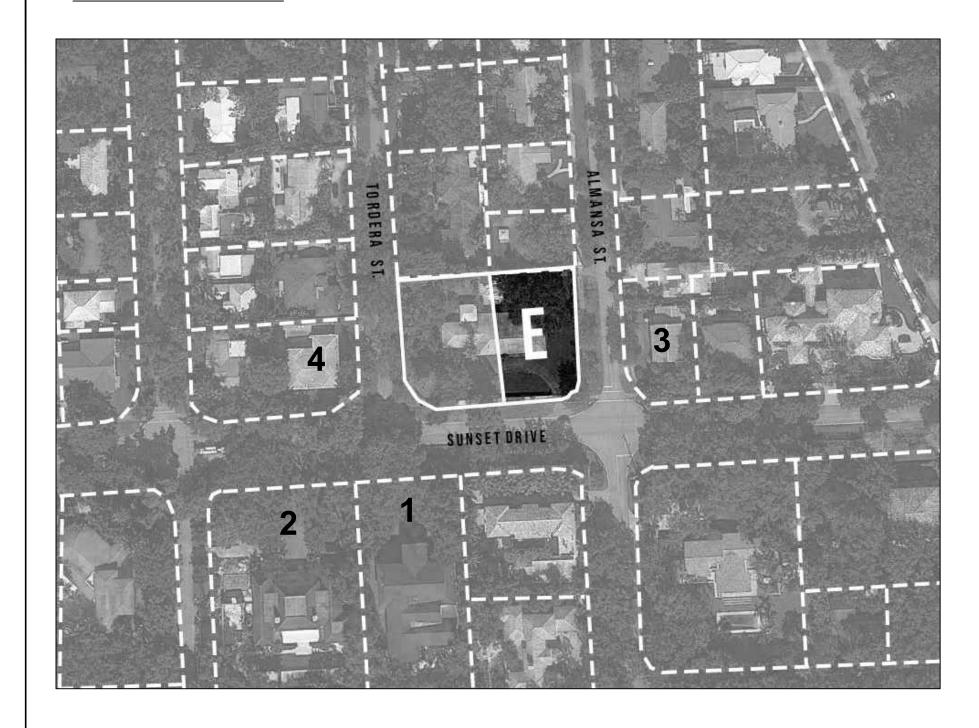
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PROJECT ID:	DRAWN BY:
1001	MG
PRINT DATE:	SCALE:
04.07.22	

DRAWING TITLE:

INDEX & DATA

KEY MAP:





6945 ALMANSA STREET

MEP ENGINEERING:

STUDIO ANDA

SUNSET RESIDENCE - EAST

PROJECT TITLE:

PROJECT LOCATION:

SUNSET 8, LLC

601 SUNSET DRIVE CORAL GABLES, FL 33143

PROJECT CLIENT/OWNER(S):

ARCHITECT:
ANA GUARACAO SERRANO
LIC#:AR100664
1800 N BAYSHORE DRIVE, #402
MIAMI,FL 33132
PH:(214)708-7454

STRUCTURAL ENGINEERING:

LANDSCAPE ARCHITECT:



4600 SUNSET DRIVE



615 SUNSET DRIVE Scale: N.T.S



613 SUNSET DRIVE Scale: N.T.S

02 04.07.2022 BOA REV.2

<u>/01</u> 01.28.2022 BOA REV.1

SHEET ISSUE/ REVISION LOG

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PROJECT ID: DRAWN BY: 1001 PRINT DATE: SCALE:

04.07.22

DRAWING TITLE:

CONTEXT IMAGES





Scale: N.T.S





NORTH WEST SITE VIEW



NORTH SITE VIEW Scale: N.T.S

SIDE WALK PICTURES Scale: N.T.S

STUDIO ANDA PROJECT TITLE: SUNSET RESIDENCE - EAST

PROJECT LOCATION: 601 SUNSET DRIVE CORAL GABLES, FL 33143

PROJECT CLIENT/OWNER(S): SUNSET 8, LLC


ARCHITECT: ANA GUARACAO SERRANO LIC#:AR100664 1800 N BAYSHORE DRIVE, #402 MIAMI,FL 33132 PH:(214)708-7454

STRUCTURAL ENGINEERING:

MEP ENGINEERING:

LANDSCAPE ARCHITECT:

PROFESSIONAL SEALS:

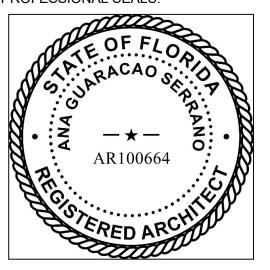

<u>∕02</u> 04.07.2022 BOA REV.2

DESCRIPTION

SHEET ISSUE/ REVISION LOG

BOA REV.1

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PROJECT ID: DRAWN BY: 1001 PRINT DATE: SCALE:

DRAWING TITLE:

04.07.22

SITE IMAGES

COUNTY-WIDE LAND SURVEYORS

LAND SURVEYORS - PLANHERS

P.O. BOX 823271 SOUTH FLORIDA, FL. 33082-3271 (305) 772-0766

15358 S.W. 140 St. Miami, Fl. 33196

LEGAL DESCRIPTION

Lots 13 thru 18 in Block 236 of REVISED PLAT OF CORAL GABLES RIVIERA SECTION PART 11, according to the plat thereof, as recorded in Plat Book 28 at Page 23 of the Public Records of Miami-DadeeCounty, Florida.

SURVEYORS NOTES:

- 1). Legal description provided by client.
- Only record plat easements are shown.
 Right of way information obtained from record plat.

CERTIFIED TO:

SUNSET 8, LLC, a Florida Limited Liabality Company Halpern Rodriguez, LLP Old Republic National Title Insurance Company

TREE LEGEND

NO.	SPECIE	DIAMETER	HEIGHT	CANOPY
1	Orchid	1.5'	35'	30 '
2	Black Olive	0.8'	30'	15 '
3	Oak	2.5'	35'	40'
4	Ficus	Cluster		
5	Tropical Almond	1.4'	25'	15 '
6	Gumbo Limbo	1.0'	20'	15 '
77-8	Oak	0.8'	25'	15 '
9	Oak	0.3'	15 '	8 '
10	Oak (2)	1.5'	45'	40'
11	Gumbo Limbo	1.5'	451	30'

BOUNDARY SURVEY SURVEY FOR: SUNSET 8, LLC 601 Sunset Dr. Coral Gables, Fl. 33143

SURVEYORS CERTIFICATE: NOTE: "NOT VALID UNLESS SEALED WITH AN EMBOSSED SURVEYORS SEAL. I HEREBY CERTIFY THAT THE SURVEY REPRESENTED HEREON COMPLIES WITH THE MINIMUM TECHNICAL STANDARDS ADOPTED BY THE PLORIDA BOARD OF SURVEYORS AND MAPPERS IN CHAPTER .5J-17 , FLORIDA
ADMINISTRATIVE CODE, PURSURANT TO SECTION 472.027, FLORIDA STATUTES,

LB#4680

JOSEPH L. MARTIN ! PROFESSIONAL LAND SURVEYOR # 4368. STATE OF FLORIDA

	REVISIONS TREES			BY DATE	
				ZCM	12-18-2019
)	DRAWN BY	SCALE	DATE 4-4-7019	FB./PG.	JOB ## 2019-

LEBAL FO 30 R/W 30' RIV REBAL FO 101 18 LOT 13 010 Od LOT 16 607 14 607 17 LUT 15 5.85 CWC.WIK. - - "

NO.	SPECIE	Diameter	height	canopy
12	Oak	2.0	45'	30'
13	Mango	1.5'	35 '	20'
14	Oak	0.7'	25'	15'
15	Oak	1.3'	30 '	25'
16	Oak	1.1'	30 '	20 *
17-18	Queen Palm	071	35 '	10 '
19	Oak	2.3'	35'	45 '
20	Avocado	0 - 7 '	25 '	151

PROJECT TITLE:

SUNSET RESIDENCE - EAST

PROJECT LOCATION: 601 SUNSET DRIVE CORAL GABLES, FL 33143

PROJECT CLIENT/OWNER(S): SUNSET 8, LLC

ARCHITECT: ANA GUARACAO SERRANO LIC#:AR100664 1800 N BAYSHORE DRIVE, #402 MIAMI,FL 33132


STRUCTURAL ENGINEERING:

MEP ENGINEERING:

PH:(214)708-7454

LANDSCAPE ARCHITECT:

PROFESSIONAL SEALS:

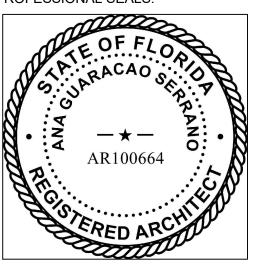

<u>02</u> 04.07.2022 BOA REV.2 BOA REV.1

SHEET ISSUE/ REVISION LOG


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PROJECT ID: DRAWN BY: PRINT DATE: SCALE: 04.07.22

DRAWING TITLE:


TREE SURVEY




FLOOR AREA CALCULATIONS - SECOND FLOOR

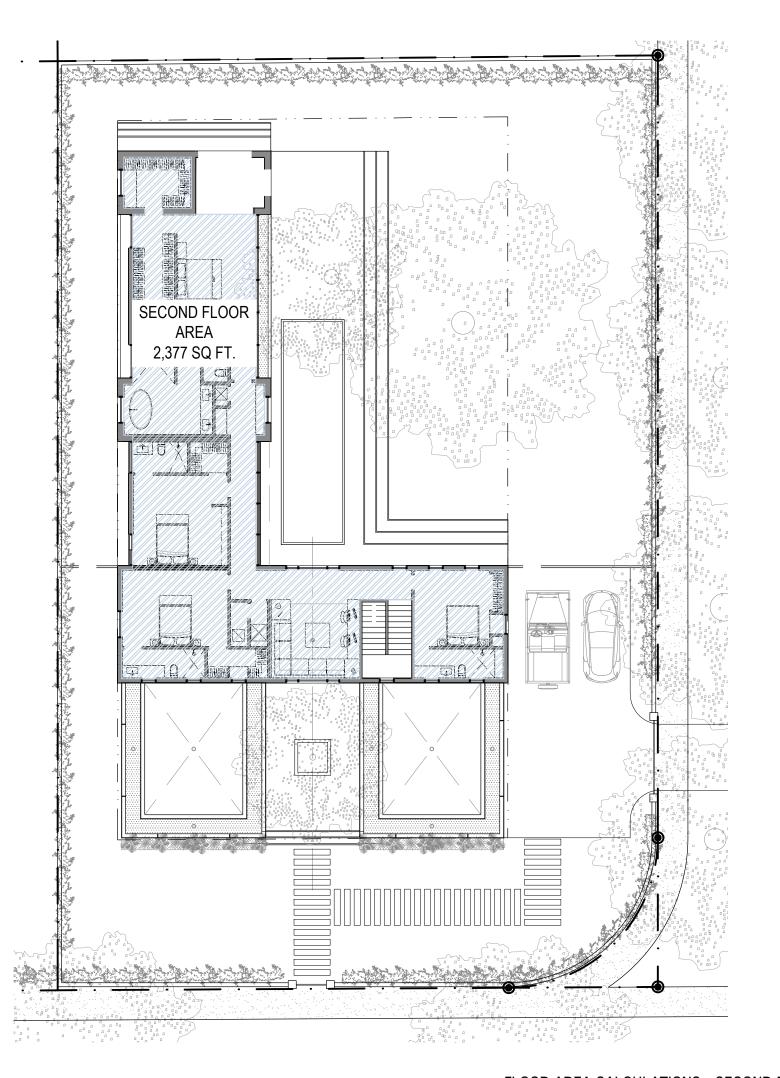
FLOOR AREA CALCULATIONS - FIRST FLOOR

Scale: 1/16" = 1'-0"

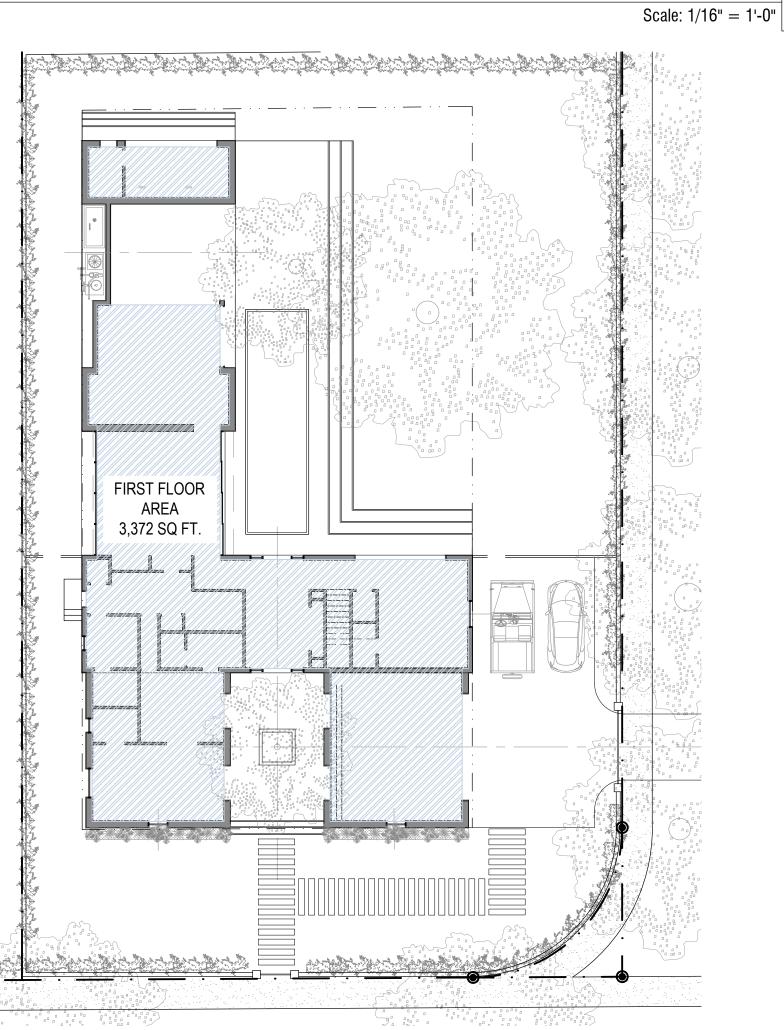

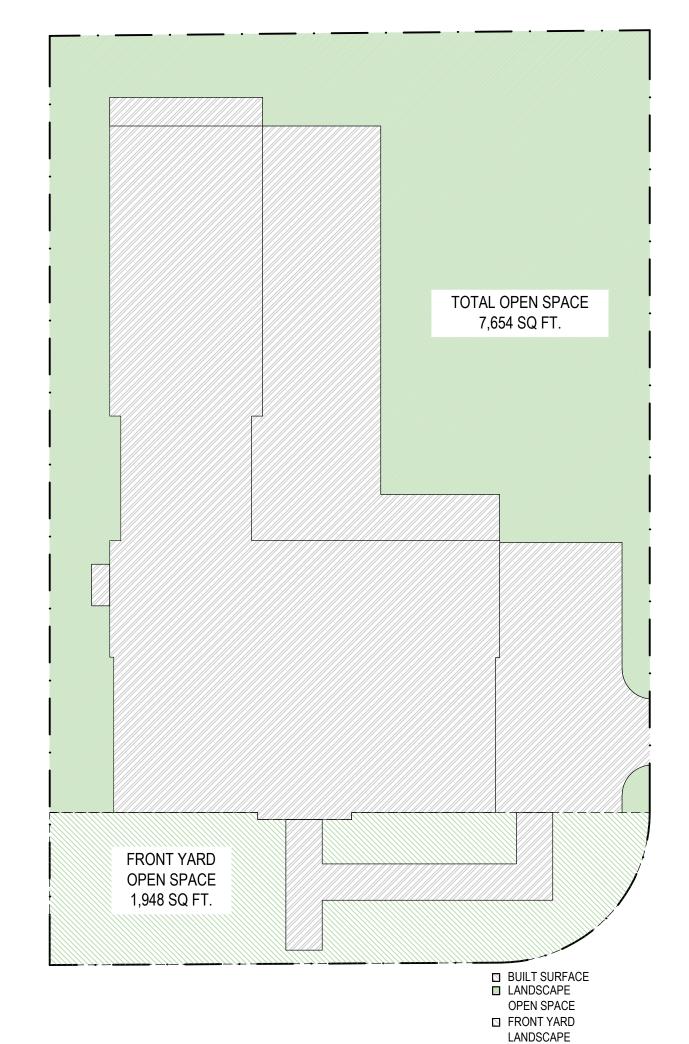

OPEN SPACE OPEN SPACE DIAGRAMS

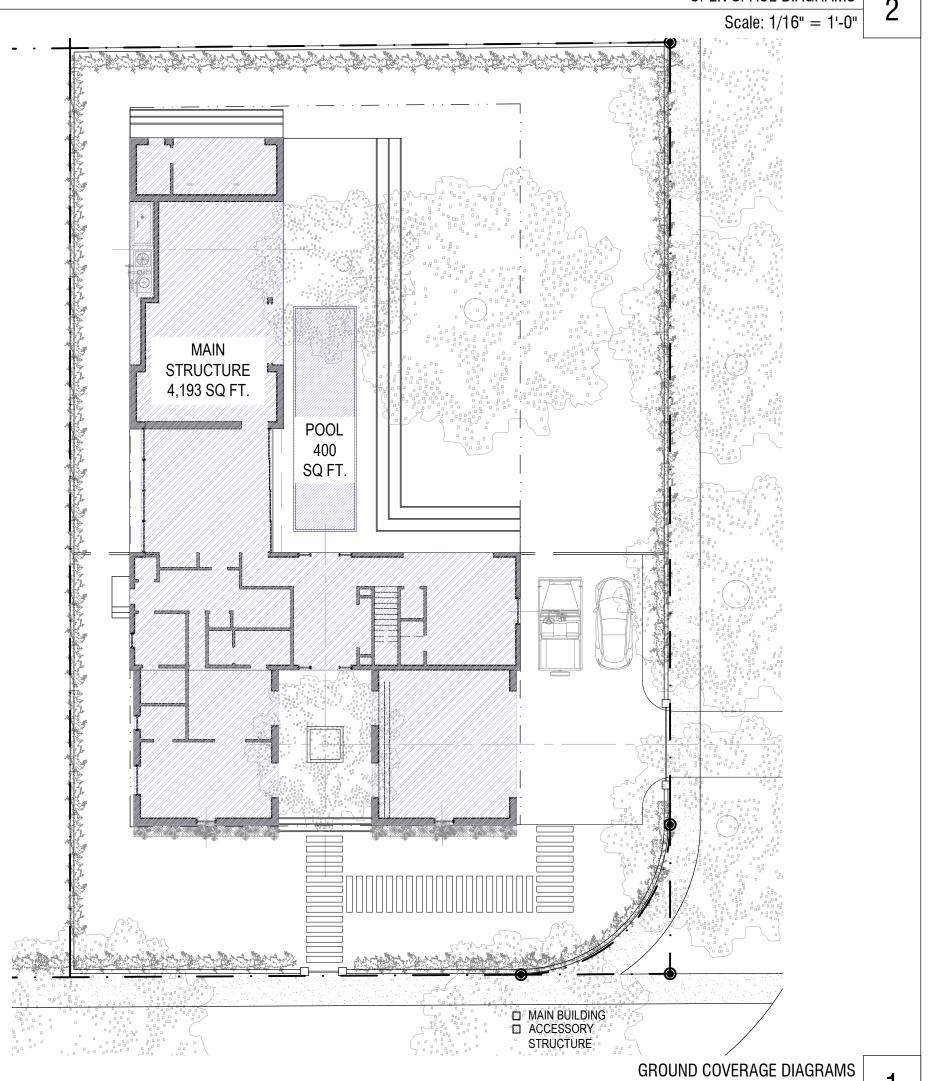

PROJECT & ZONING DATA

SITE INFORMATION:

LEGAL DESCRIPTION

FEMA FIRM ZONE

:SFR TYPE

:15,500 Sq.Ft LOT AREA

> :LOTS 13, 14, AND 15, BLOCK 236, "REVISED PLAT OF CORAL GABLES RIVIERA SECTION PART II", ACCORDING TO THE PLAT THEREOF AS RECORDED IN PLAT BOOK 28, PAGE 23, OF THE PUBLIC RECORDS OF MIAMI-DADE

> > (TO EAVE)

COUNTY, FLORIDA. LOT SIZE 100' X 154'-8" :FLOOD ZONE X

PROPOSED GROUND COVERAGE: MAX ALLOWED MAIN STRUCTURE :35% (5,425 Sq.Ft) : 4,193 Sq.Ft. : 4,593 Sq.Ft. :45% (6,975 Sq.Ft) TOTAL (INC AUX.)

PROPOSED LANDSCAPE OPEN SPACE: MIN ALLOWED : 7,654 Sq.Ft :40%(6,200 Sq.Ft) :20%(1,240 Sq.Ft) : 1,948 Sq.Ft FRONT YARD

MAX F.A.R. MAX ALLOWED : 2,400 Sq. Ft 48% OF 5,000 35% OF NEXT 5.000 : 1,750 Sq. Ft : 1,650 Sq. Ft 30% OF REMAINING : 5,800 Sq. Ft TOTAL

PROPOSED F.A.R PROPOSED FIRST FLOOR : 3,372 Sq. Ft. : 2,377 Sq. Ft. SECOND FLOOR : 5,749 Sq. Ft. TOTAL

MAX PROPOSED **BUILDING HEIGHT:** MAX ALLOWED :25' :23'-6"

(TO EAVE) **MAIN BUILDING**

REQUIRED PROPOSED SETBACKS: FRONT :25' :25' :25' :25' SIDE (STREET) SIDE (INTERIOR) :10' :10' REAR :10' :10'

PROJECT TITLE:

SUNSET RESIDENCE - EAST

STUDIO ANDA

PROJECT LOCATION: 601 SUNSET DRIVE CORAL GABLES, FL 33143

PROJECT CLIENT/OWNER(S):

SUNSET 8, LLC


ARCHITECT: ANA GUARACAO SERRANO LIC#:AR100664 1800 N BAYSHORE DRIVE, #402 MIAMI,FL 33132 PH:(214)708-7454

STRUCTURAL ENGINEERING:

MEP ENGINEERING:

LANDSCAPE ARCHITECT:

PROFESSIONAL SEALS:

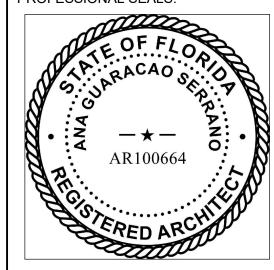

04.07.2022 BOA REV.2

01.28.2022

DESCRIPTION

BOA REV.1

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"In my professional judgement and to the best of my knowledge and belief, these plans and specifications comply with F.B.C. 7th Edition (2021).

PROJECT ID:	DRAWN BY:
1001	MG
PRINT DATE:	SCALE:
04.07.22	

DRAWING TITLE:

ZONING DATA


SHEET NO.

A005

Scale: 1/16" = 1'-0"

- REFER TO LANDSCAPE DRAWINGS FOR LANDSCAPE DETAILS - ALL RAINWATER MUST BE RETAINED WITHIN PRIVATE PROPERTY. - ALL REQUIREMENTS FOR LANDSCAPE AS LISTED IN ZONING CODE

ARTICLE 5, DIVISION 11 WILL BE COMPLIED WITH. -ALL POOL GATES ARE SELF CLOSING AND SELF LATCHING

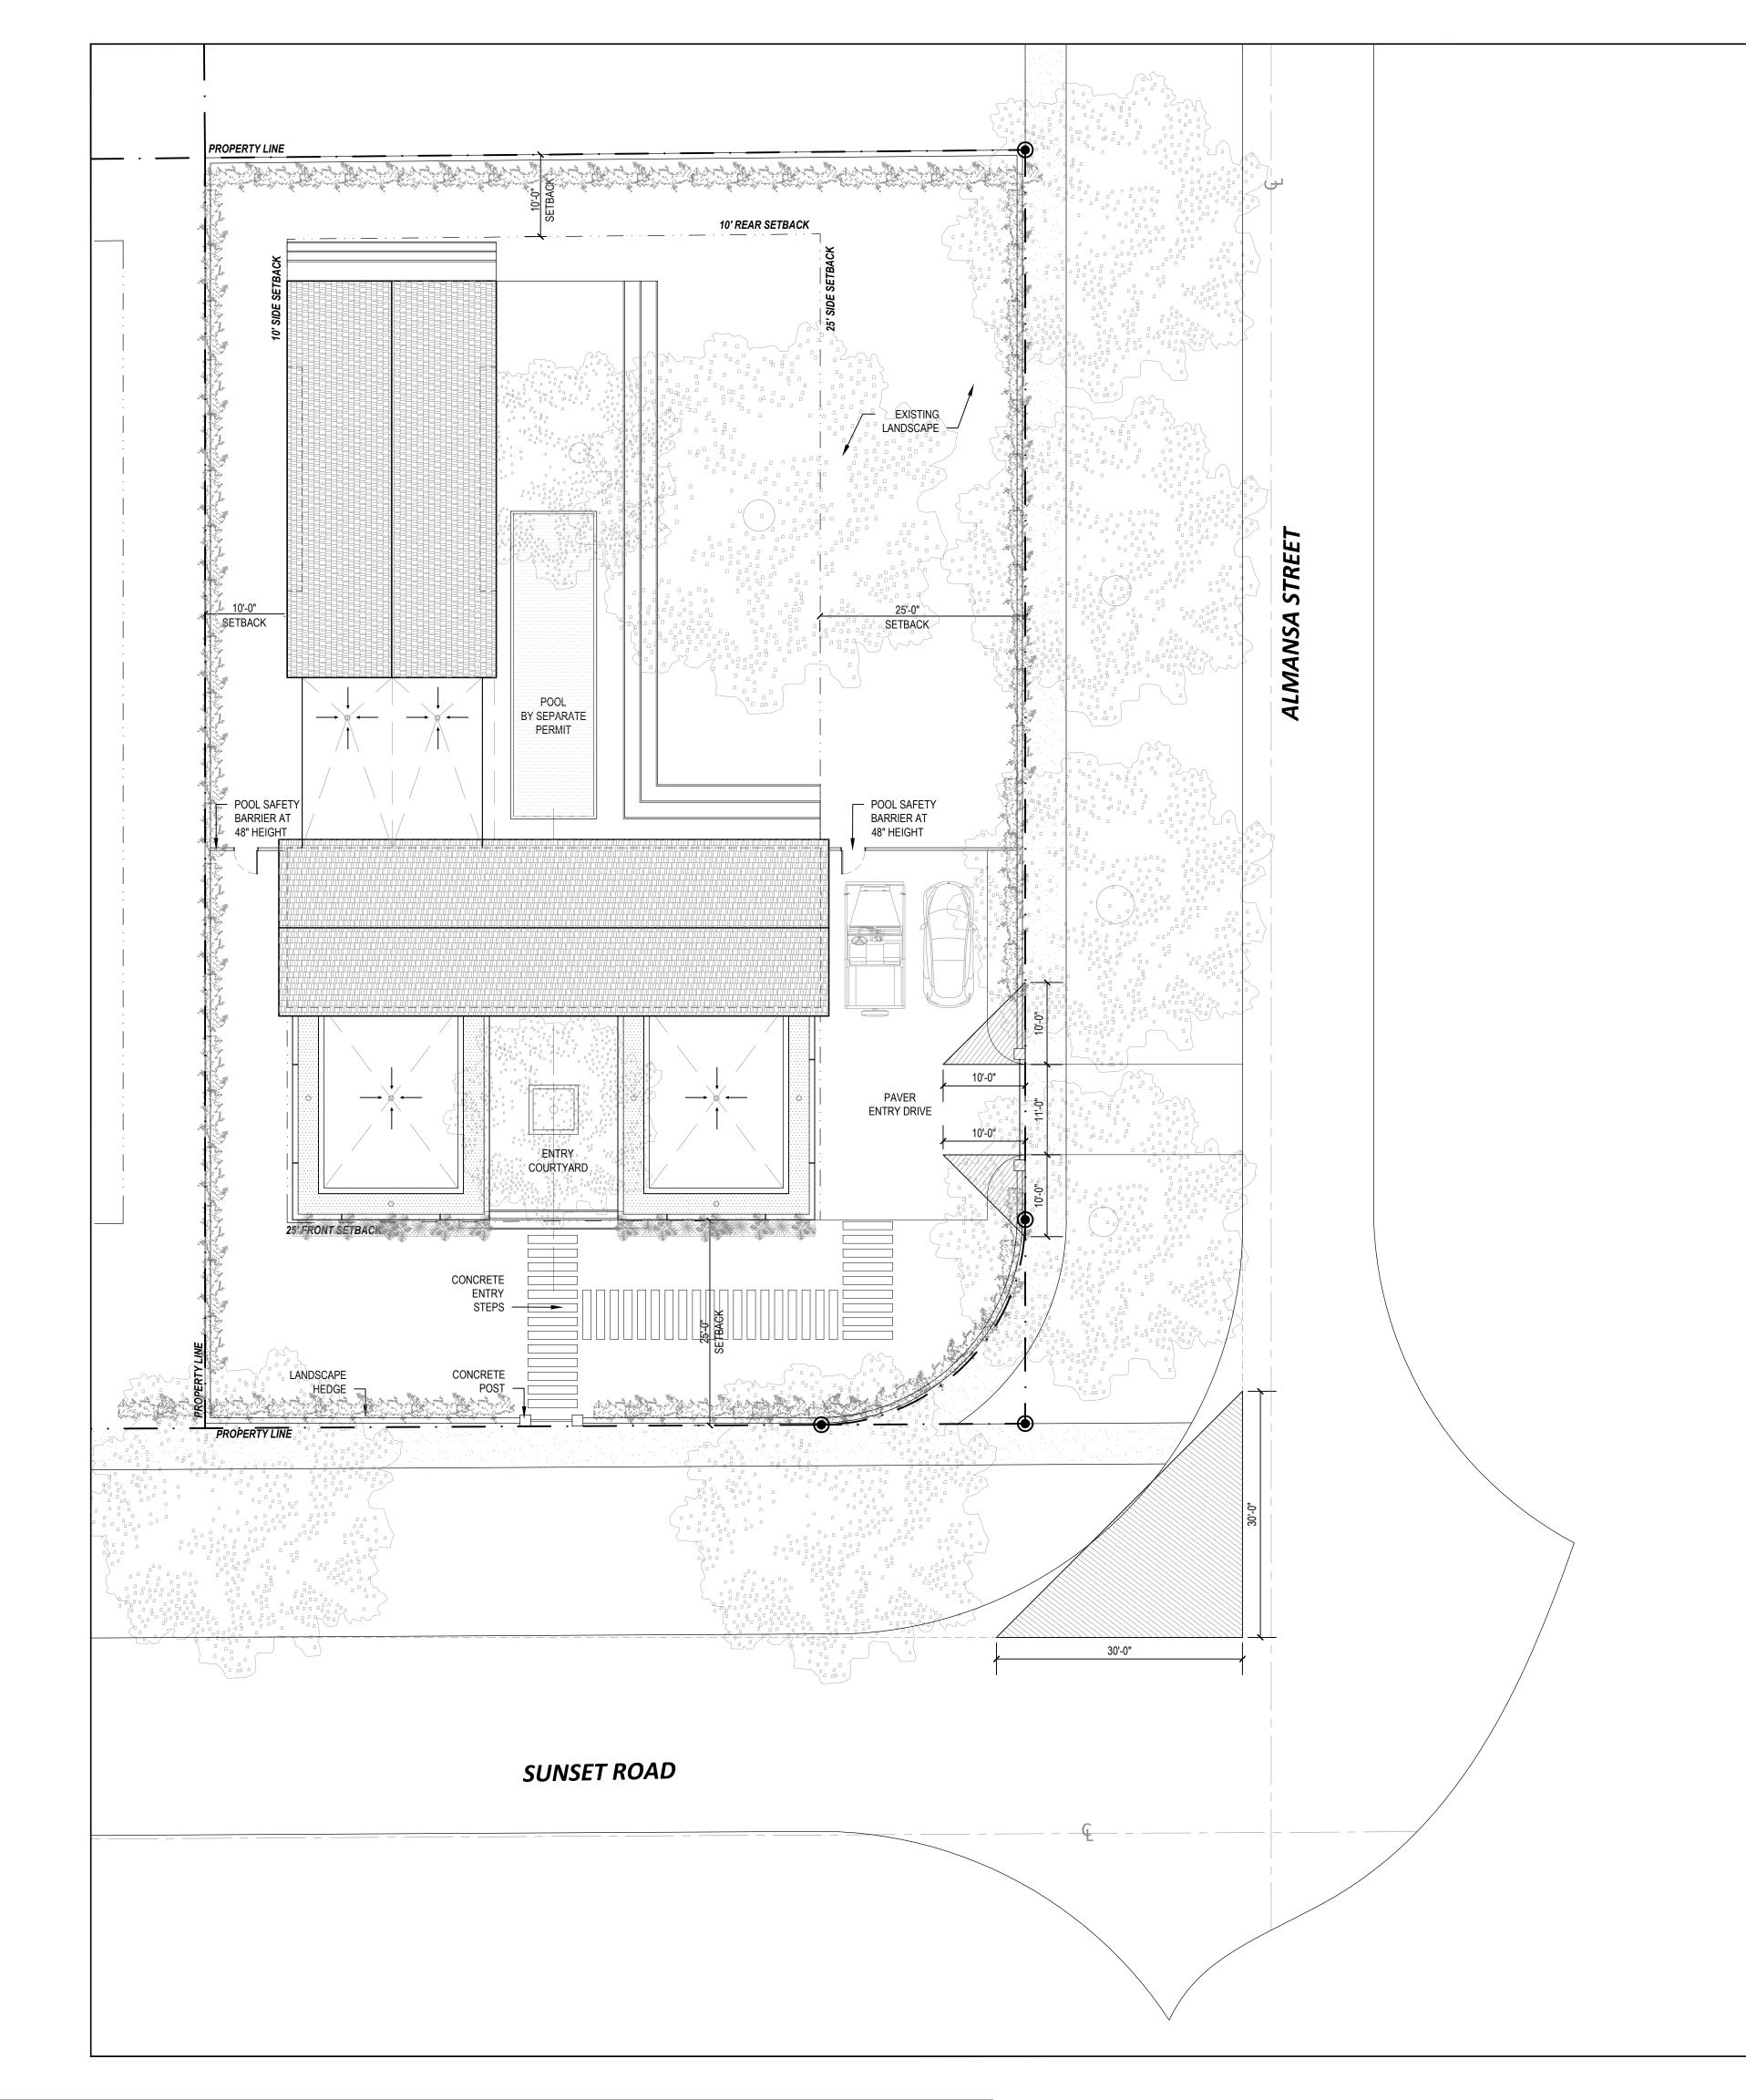

PROJECT & ZONING DATA

SITE INFORMATION:

FEMA FIRM ZONE

FRONT YARD

TYPE

:SFR LOT AREA :15,500 Sq.Ft

LEGAL DESCRIPTION :LOTS 13, 14, AND 15, BLOCK 236, "REVISED PLAT OF CORAL GABLES

> RIVIERA SECTION PART II", ACCORDING TO THE PLAT THEREOF AS RECORDED IN PLAT BOOK 28, PAGE 23, OF THE PUBLIC RECORDS OF MIAMI-DADE

> > : 1,948 Sq.Ft

COUNTY, FLORIDA. LOT SIZE 100' X 154'-8" :FLOOD ZONE X

MAX ALLOWED **PROPOSED GROUND COVERAGE:**

MAIN STRUCTURE :35% (5,425 Sq.Ft) : 4,193 Sq.Ft. :45% (6,975 Sq.Ft) : 4,593 Sq.Ft. TOTAL (INC AUX.) **PROPOSED** LANDSCAPE OPEN SPACE: MIN ALLOWED :40%(6,200 Sq.Ft) : 7,654 Sq.Ft

:20%(1,240 Sq.Ft)

MAX F.A.R. MAX ALLOWED : 2,400 Sq. Ft 48% OF 5,000 : 1,750 Sq. Ft 35% OF NEXT 5,000 : 1,650 Sq. Ft 30% OF REMAINING : 5,800 Sq. Ft TOTAL

F.A.R PROPOSED **PROPOSED** FIRST FLOOR : 3,372 Sq. Ft. : 2,377 Sq. Ft. SECOND FLOOR : 5,749 Sq. Ft. TOTAL

MAX PROPOSED **BUILDING HEIGHT:** MAX ALLOWED :25' :23'-6"

(TO EAVE) (TO EAVE)

MAIN BUILDING REQUIRED PROPOSED **SETBACKS:** FRONT :25' :25' SIDE (STREET) :25' :25' SIDE (INTERIOR) :10' :10' REAR :10' :10'



PROJECT TITLE:

SUNSET RESIDENCE - EAST

PROJECT LOCATION: 601 SUNSET DRIVE CORAL GABLES, FL 33143

PROJECT CLIENT/OWNER(S):

SUNSET 8, LLC


ARCHITECT: ANA GUARACAO SERRANO LIC#:AR100664 1800 N BAYSHORE DRIVE, #402 MIAMI,FL 33132 PH:(214)708-7454

STRUCTURAL ENGINEERING:

MEP ENGINEERING:

LANDSCAPE ARCHITECT:

PROFESSIONAL SEALS:

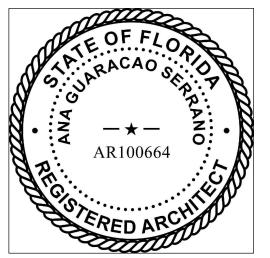

04.07.2022 BOA REV.2

DESCRIPTION

SHEET ISSUE/ REVISION LOG

BOA REV.1

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PROJECT ID:	DRAWN BY:
1001	MG
PRINT DATE:	SCALE:
04.07.22	3/32"-1'-0"

DRAWING TITLE:

SITE PLAN

SHEET NO.


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NOTES:

- REFER TO LANDSCAPE DRAWINGS FOR LANDSCAPE DETAILS - ALL RAINWATER MUST BE RETAINED WITHIN PRIVATE PROPERTY.

- ALL REQUIREMENTS FOR LANDSCAPE AS LISTED IN ZONING CODE ARTICLE 5, DIVISION 11 WILL BE COMPLIED WITH.

-ALL POOL GATES ARE SELF CLOSING AND SELF LATCHING



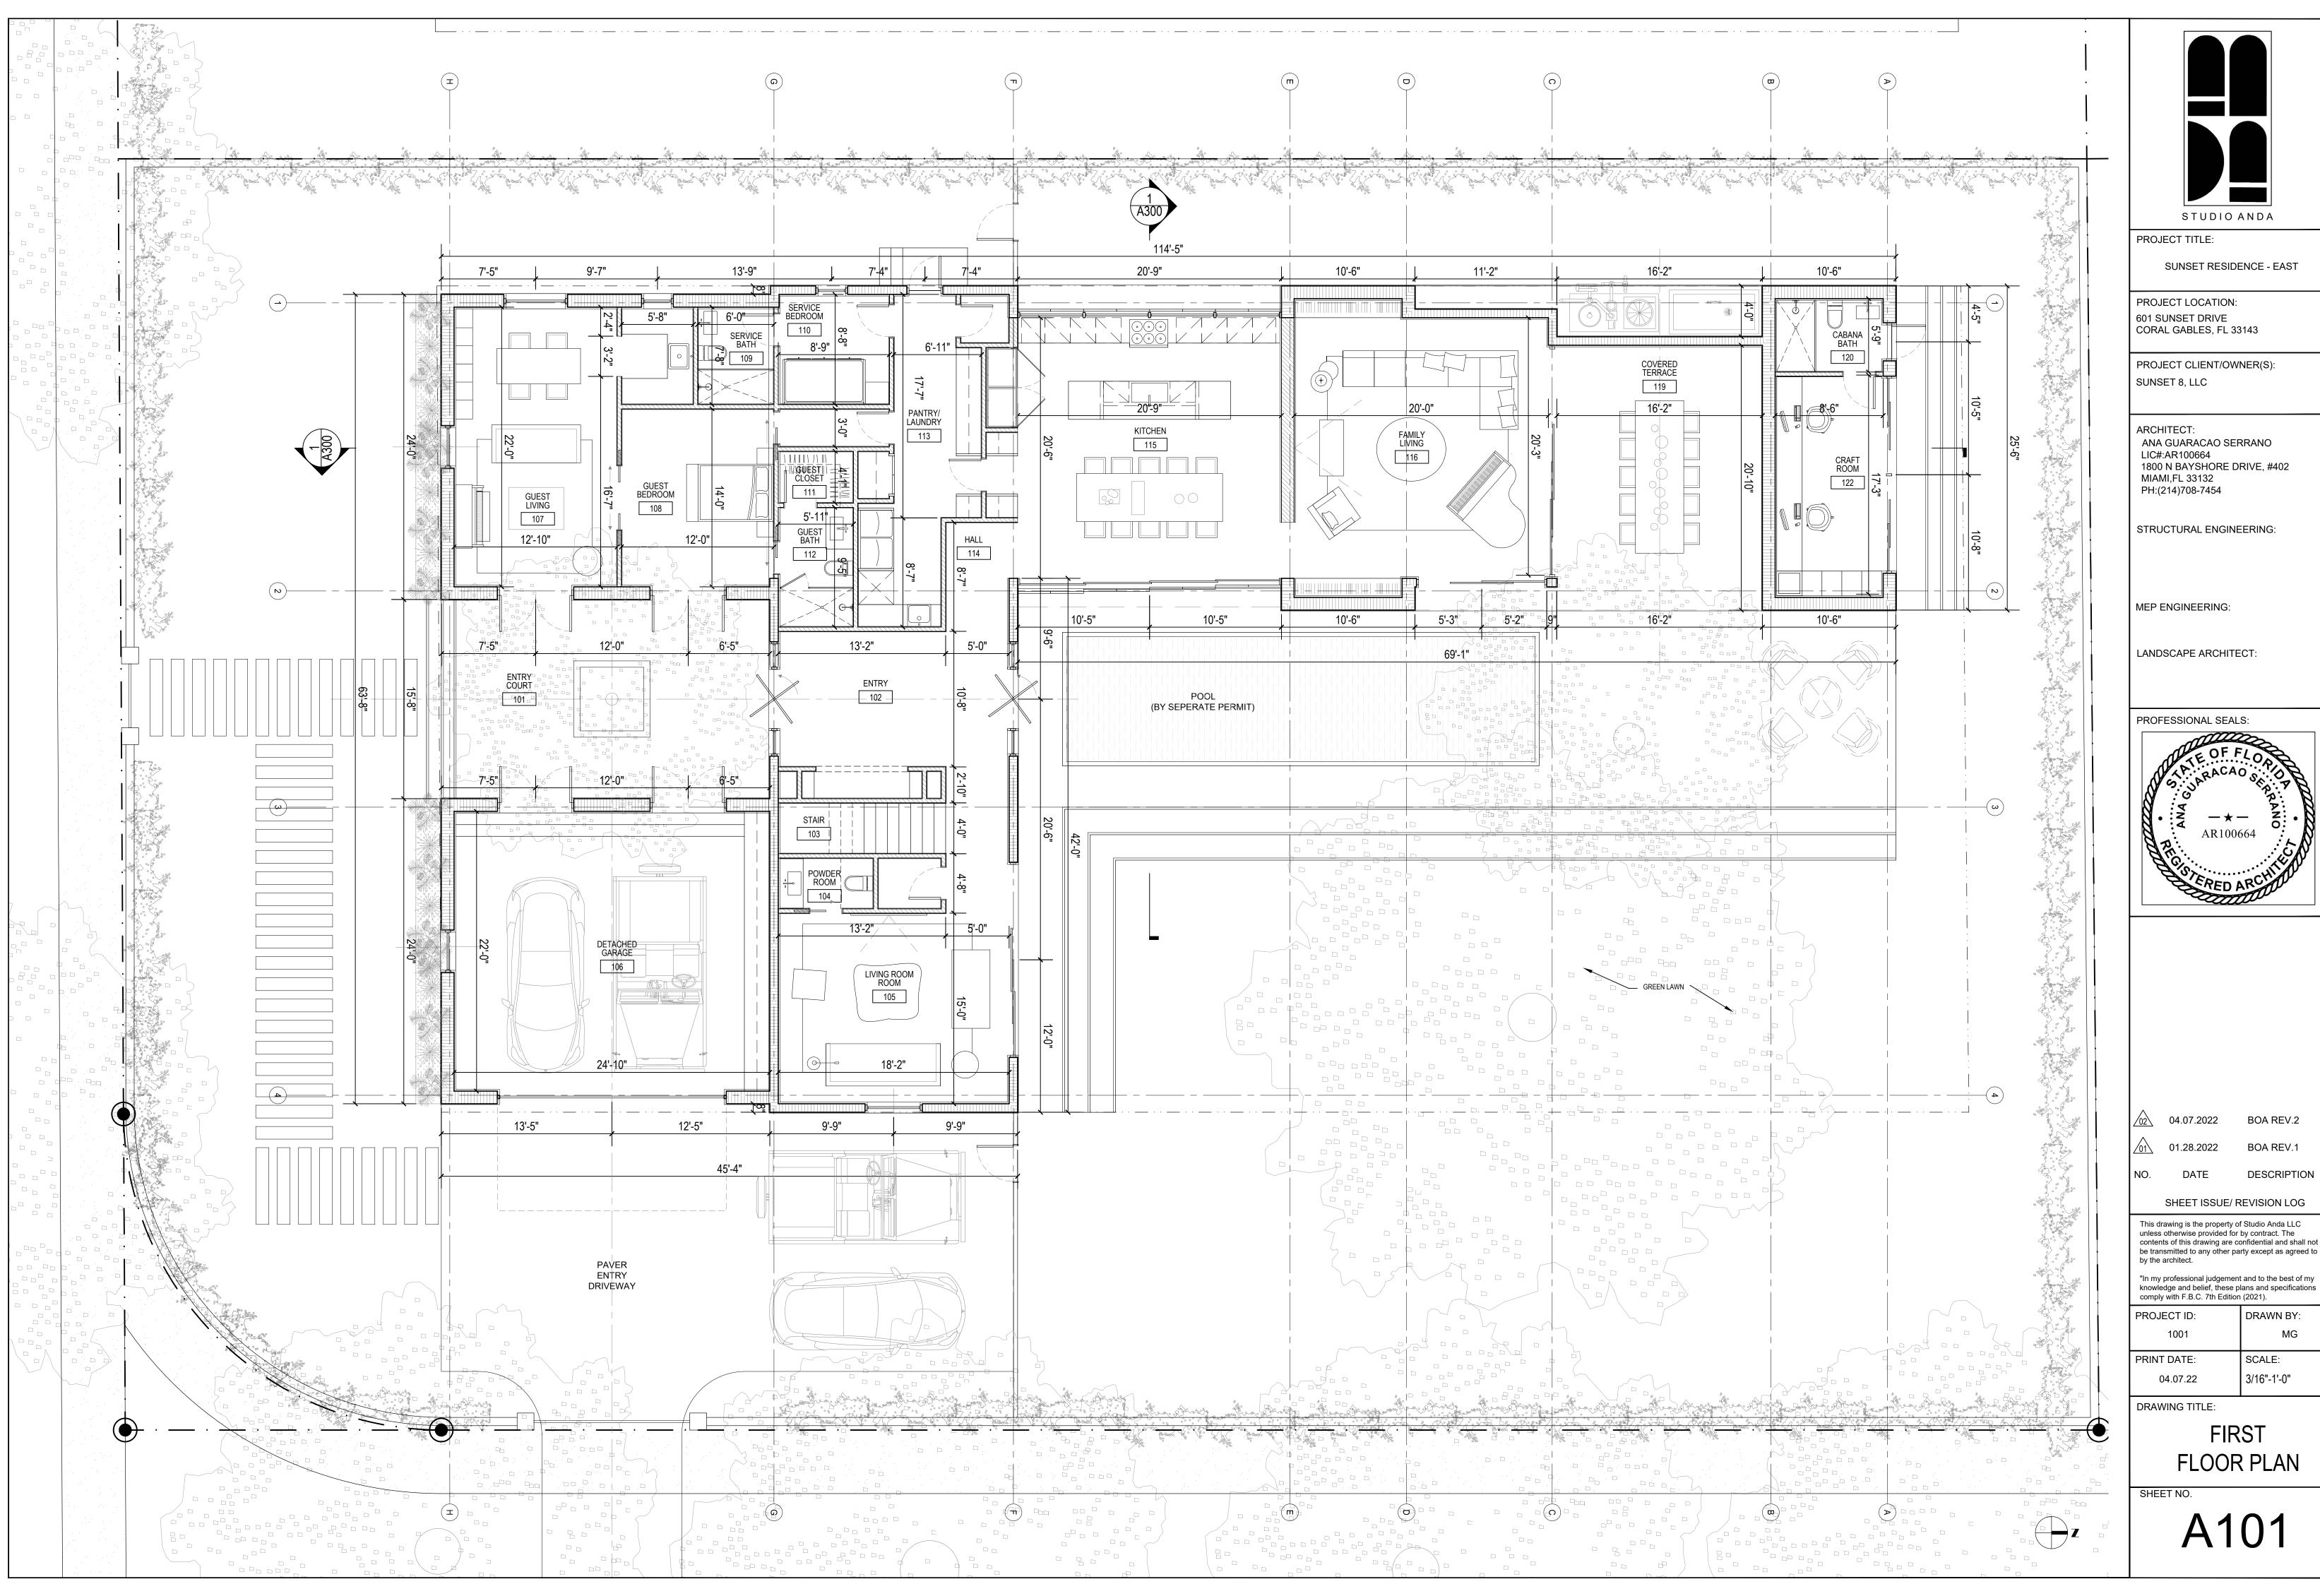

SUNSET RESIDENCE - EAST


601 SUNSET DRIVE CORAL GABLES, FL 33143

ANA GUARACAO SERRANO LIC#:AR100664 1800 N BAYSHORE DRIVE, #402 MIAMI,FL 33132

STRUCTURAL ENGINEERING:

LANDSCAPE ARCHITECT:

PROFESSIONAL SEALS:

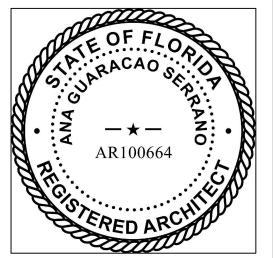

04.07.2022 BOA REV.2

SHEET ISSUE/ REVISION LOG


BOA REV.1


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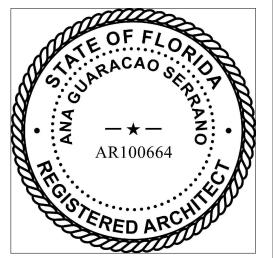
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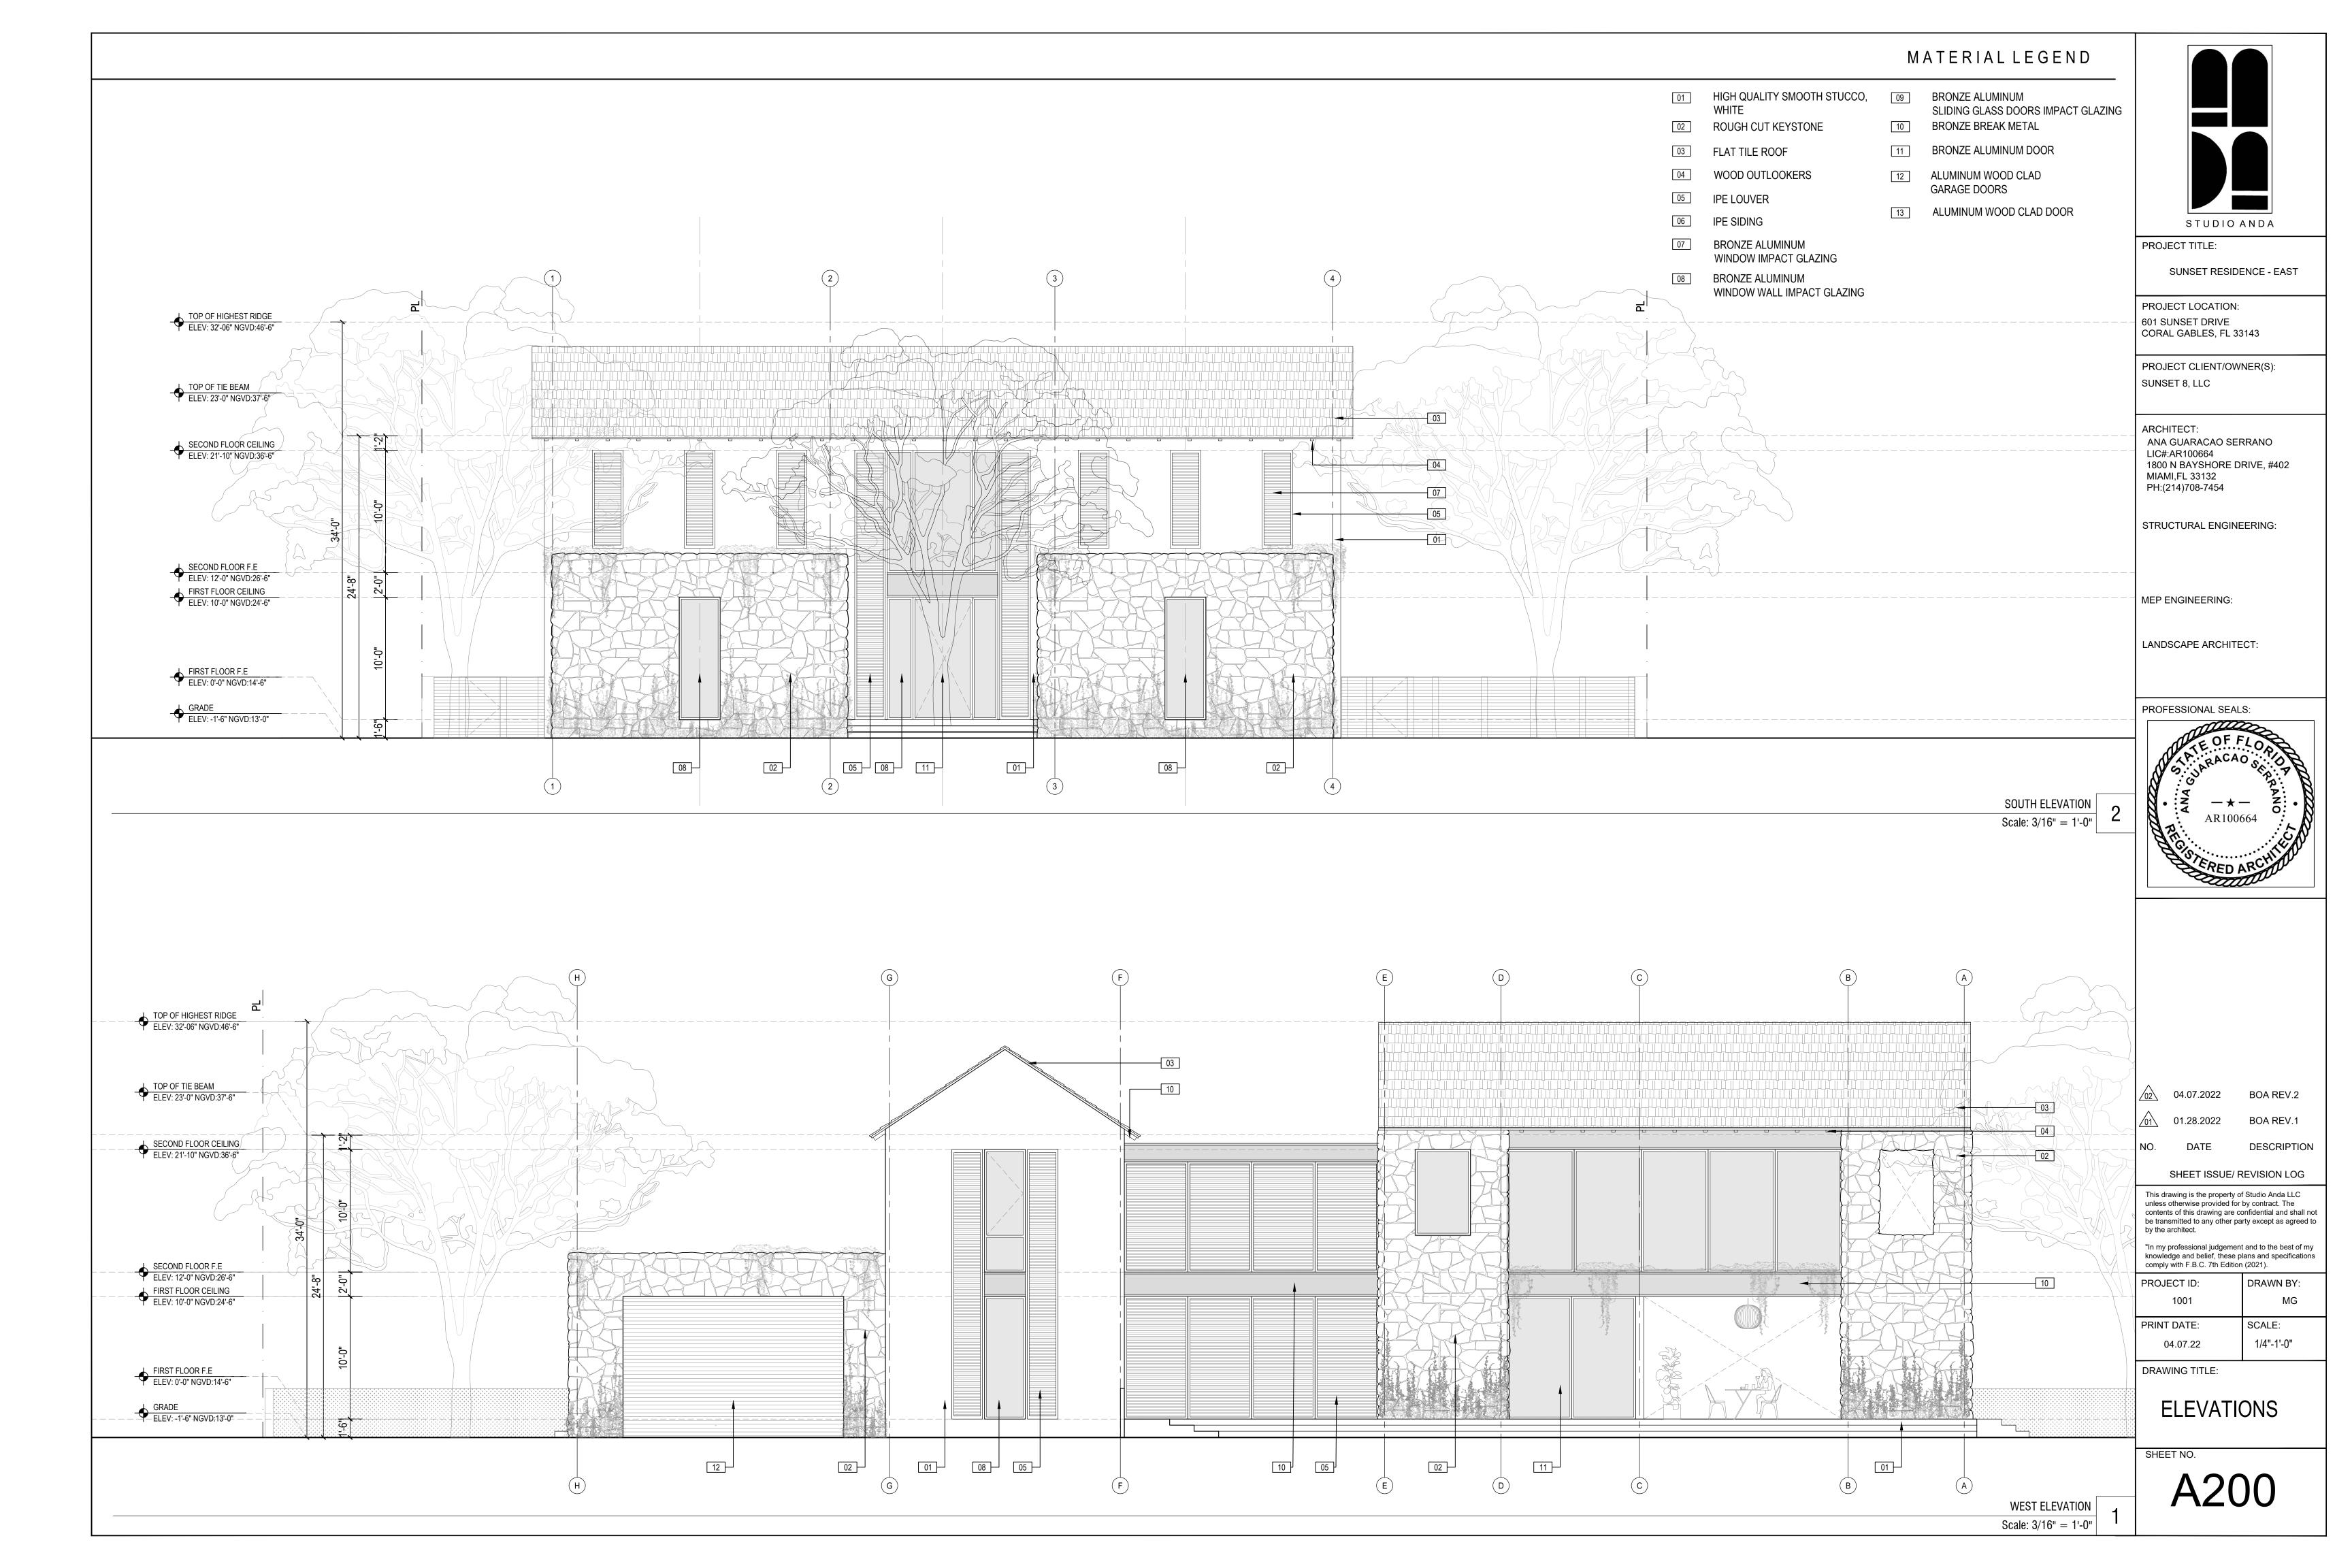
FIRST FLOOR PLAN

3/16"-1'-0"







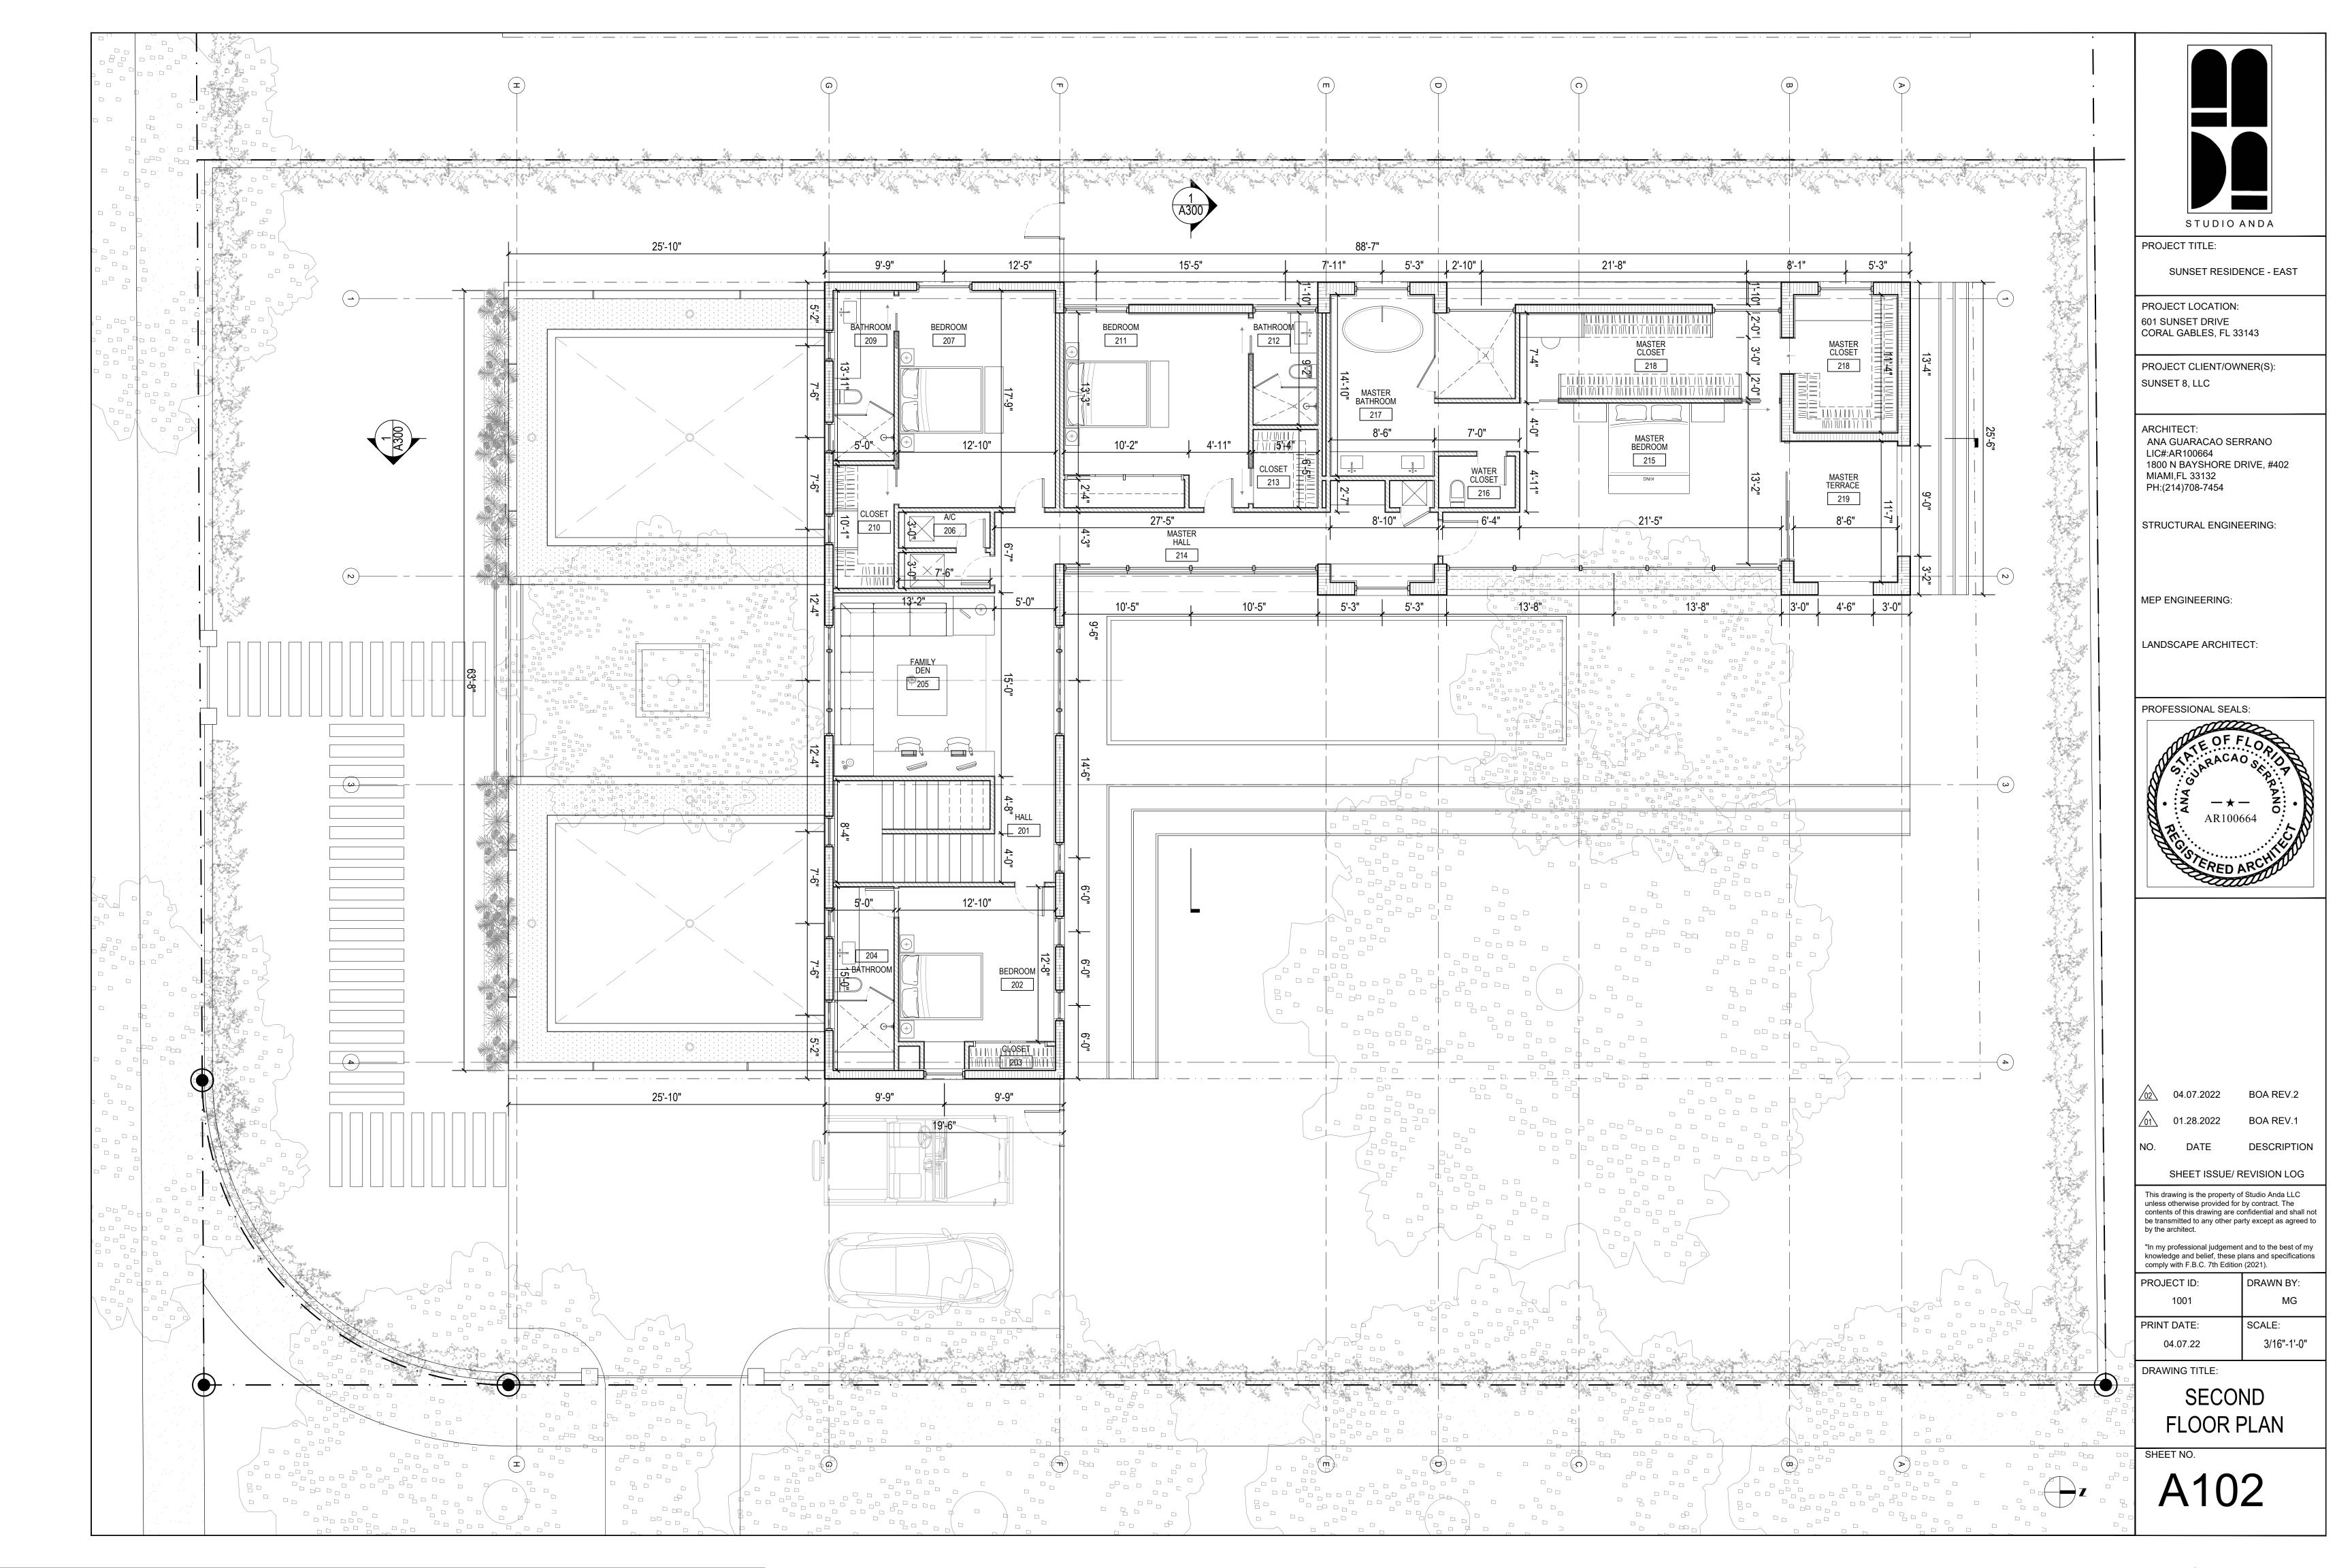


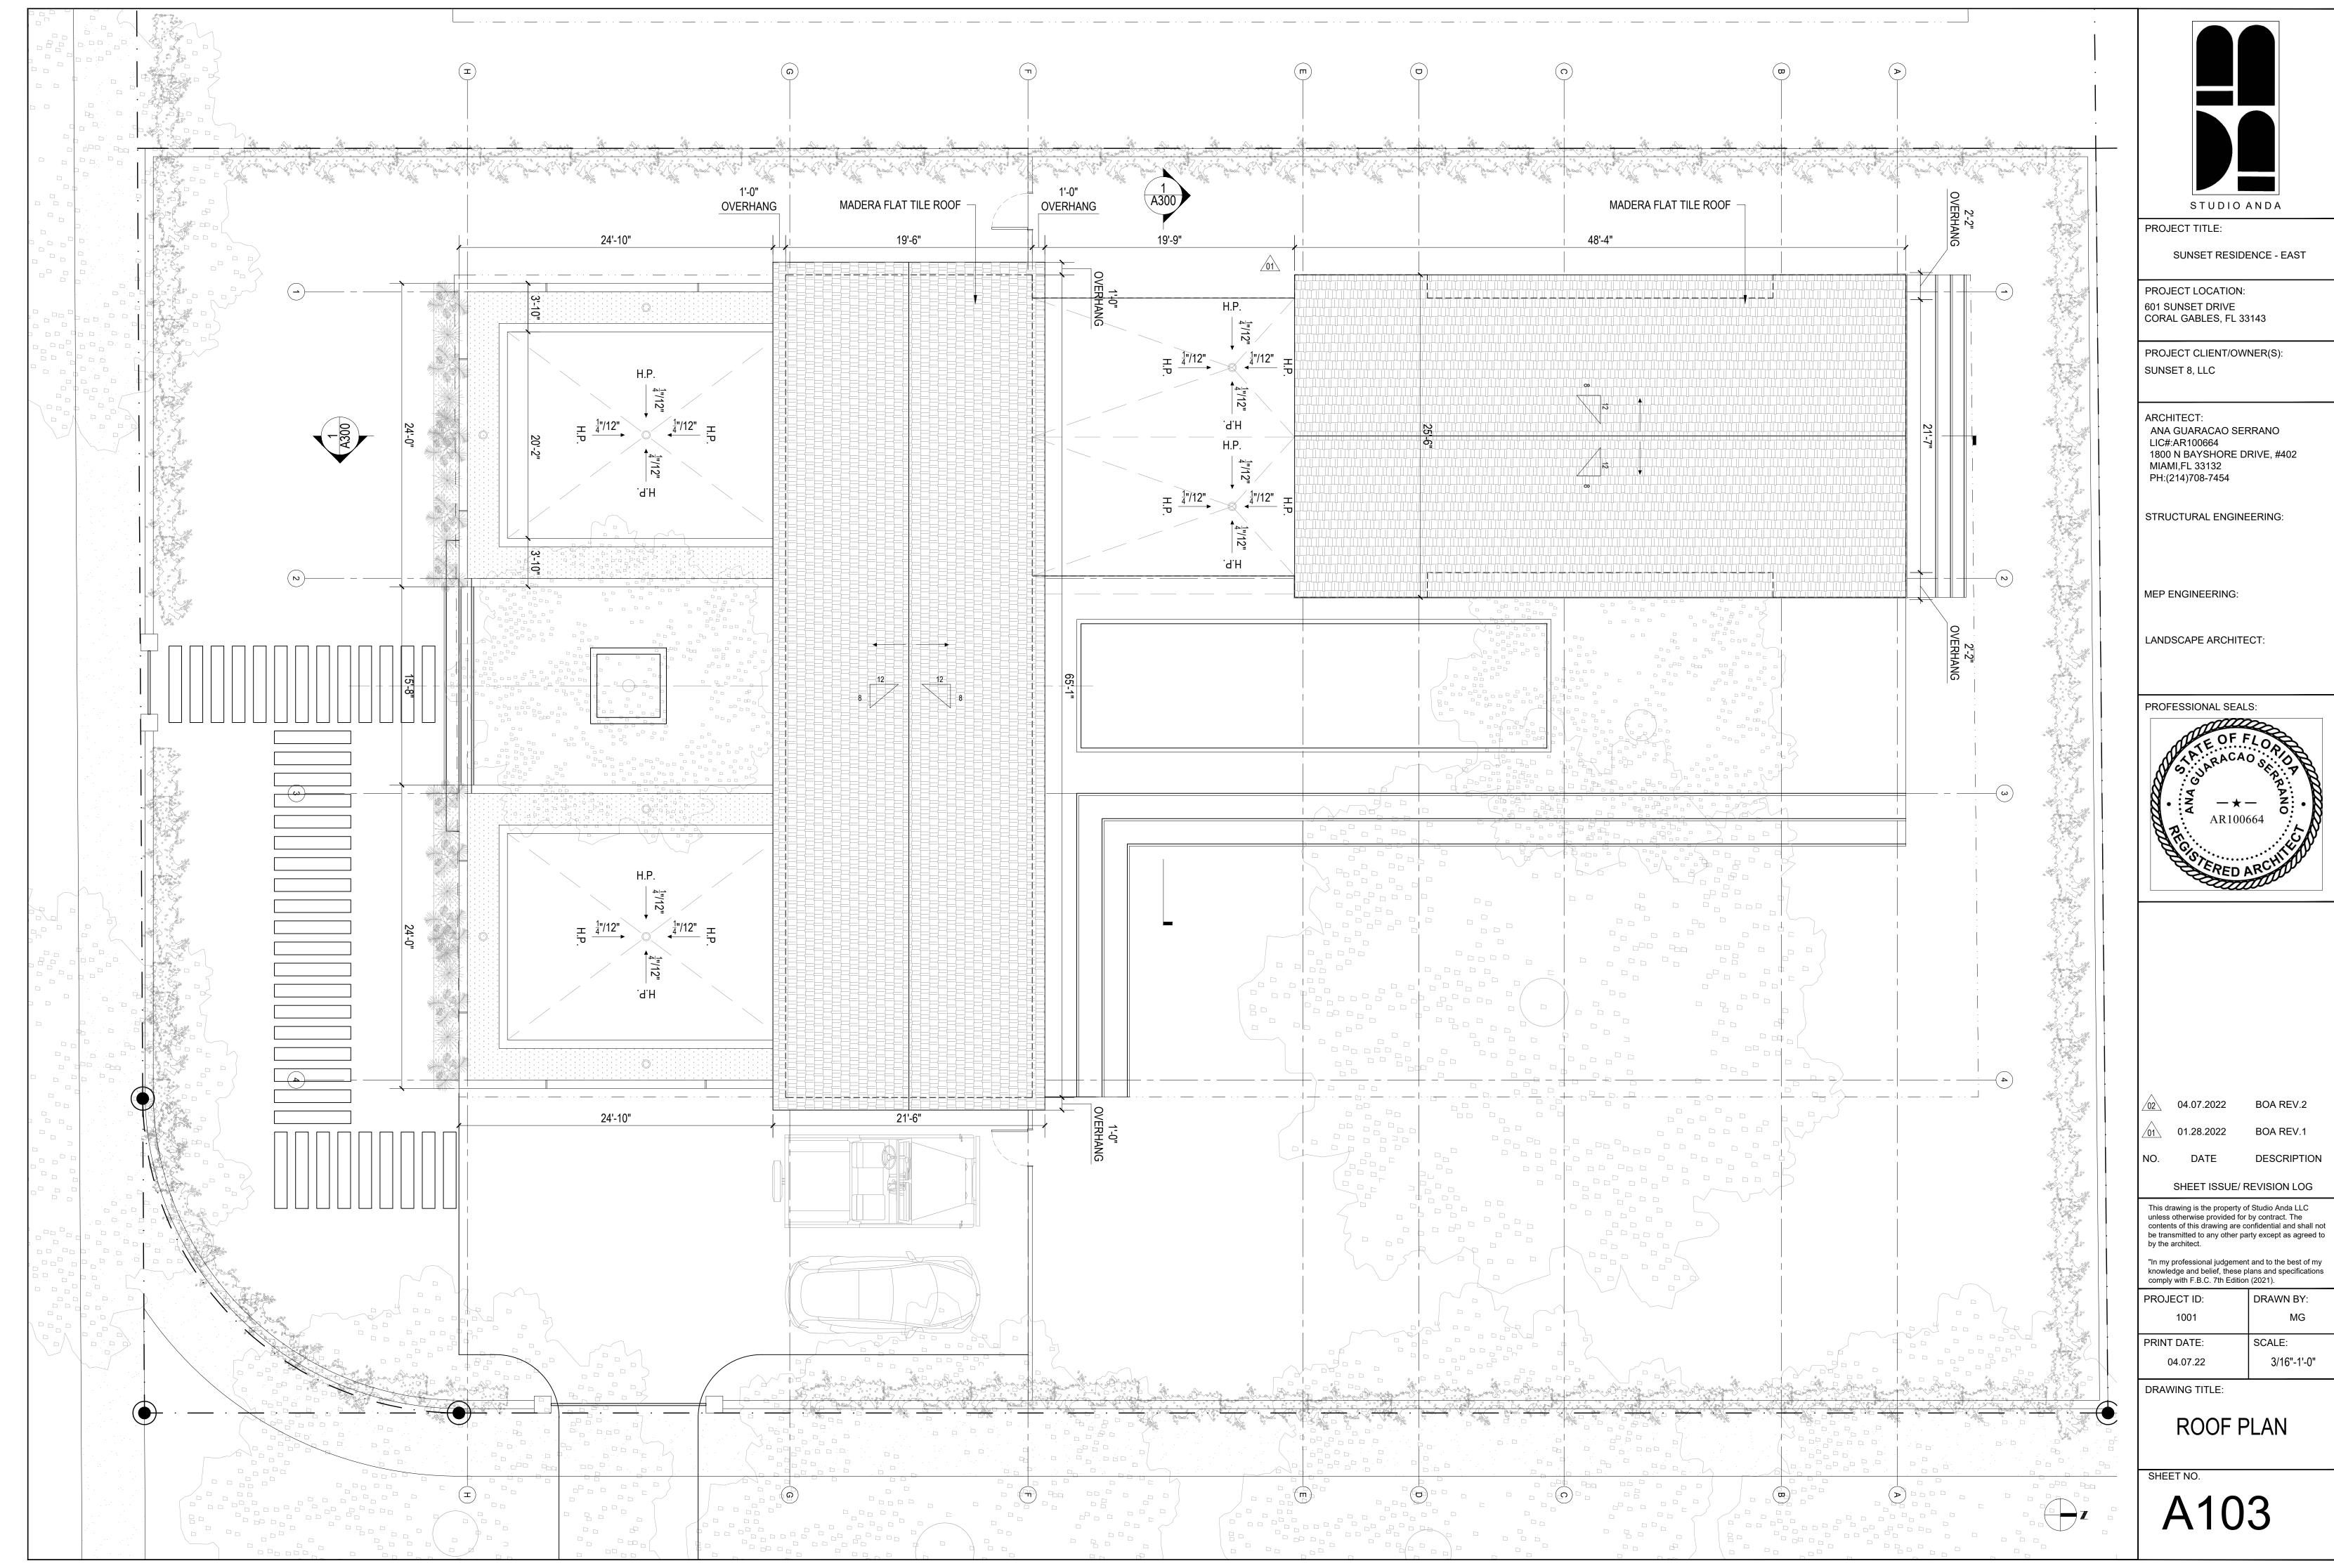



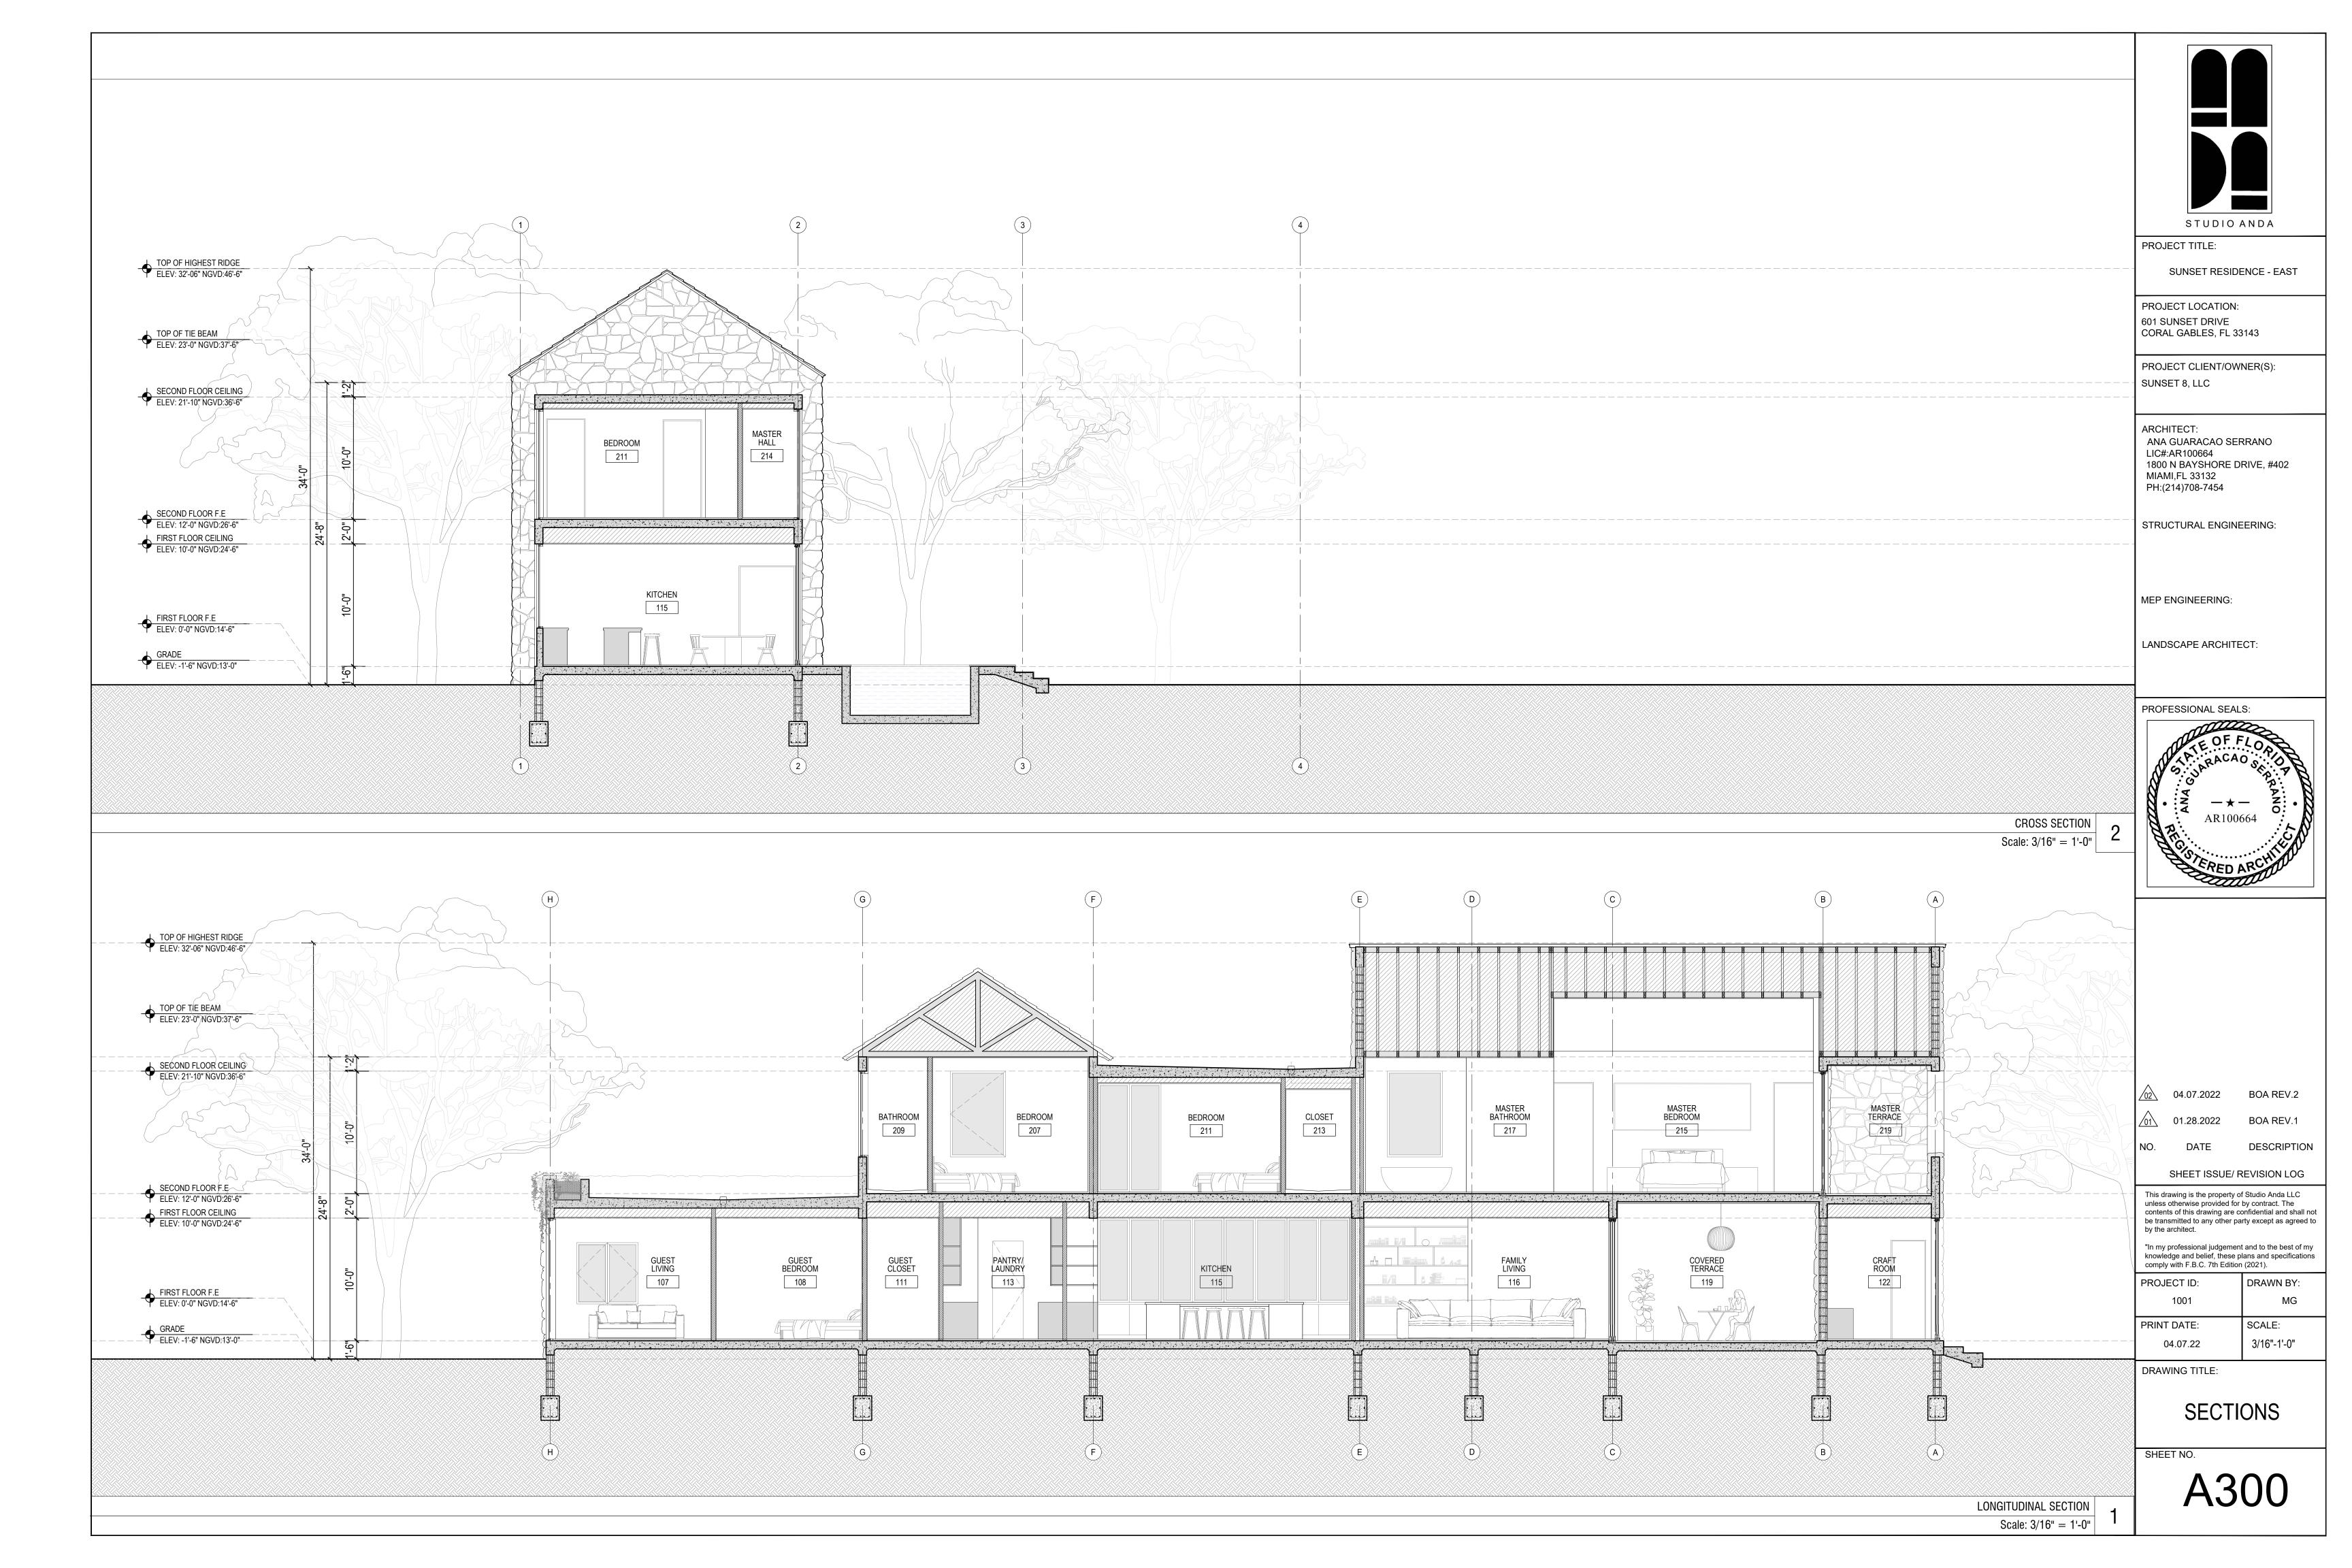

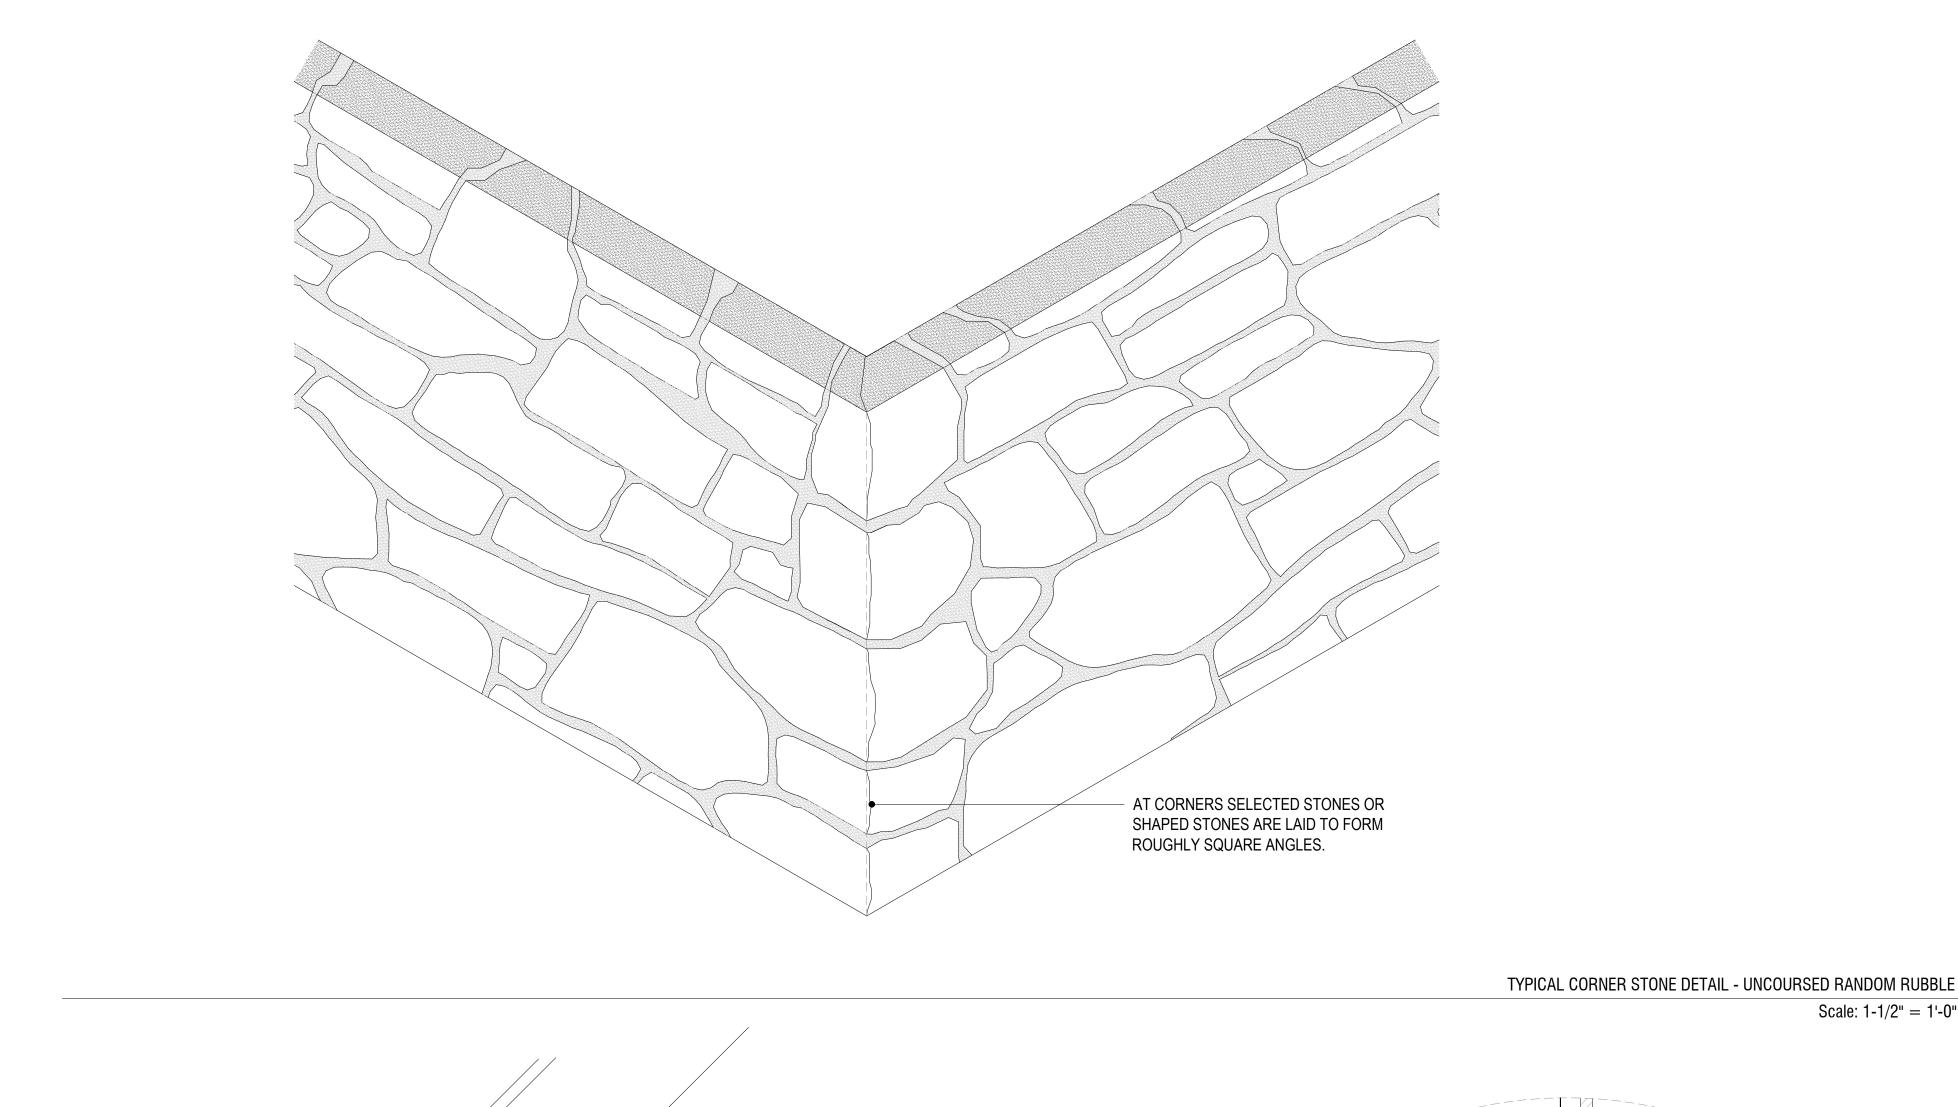

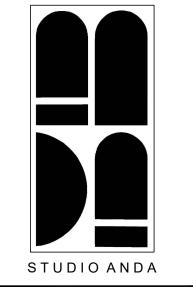

SUNSET RESIDENCE - EAST

PROJECT LOCATION: 601 SUNSET DRIVE CORAL GABLES, FL 33143

PROJECT CLIENT/OWNER(S): SUNSET 8, LLC


ARCHITECT: ANA GUARACAO SERRANO LIC#:AR100664 1800 N BAYSHORE DRIVE, #402 MIAMI,FL 33132 PH:(214)708-7454


STRUCTURAL ENGINEERING:

MEP ENGINEERING:

LANDSCAPE ARCHITECT:

Scale: 1-1/2" = 1'-0"

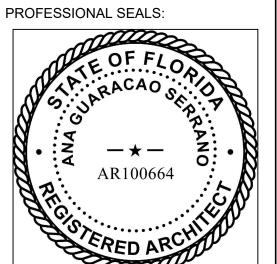

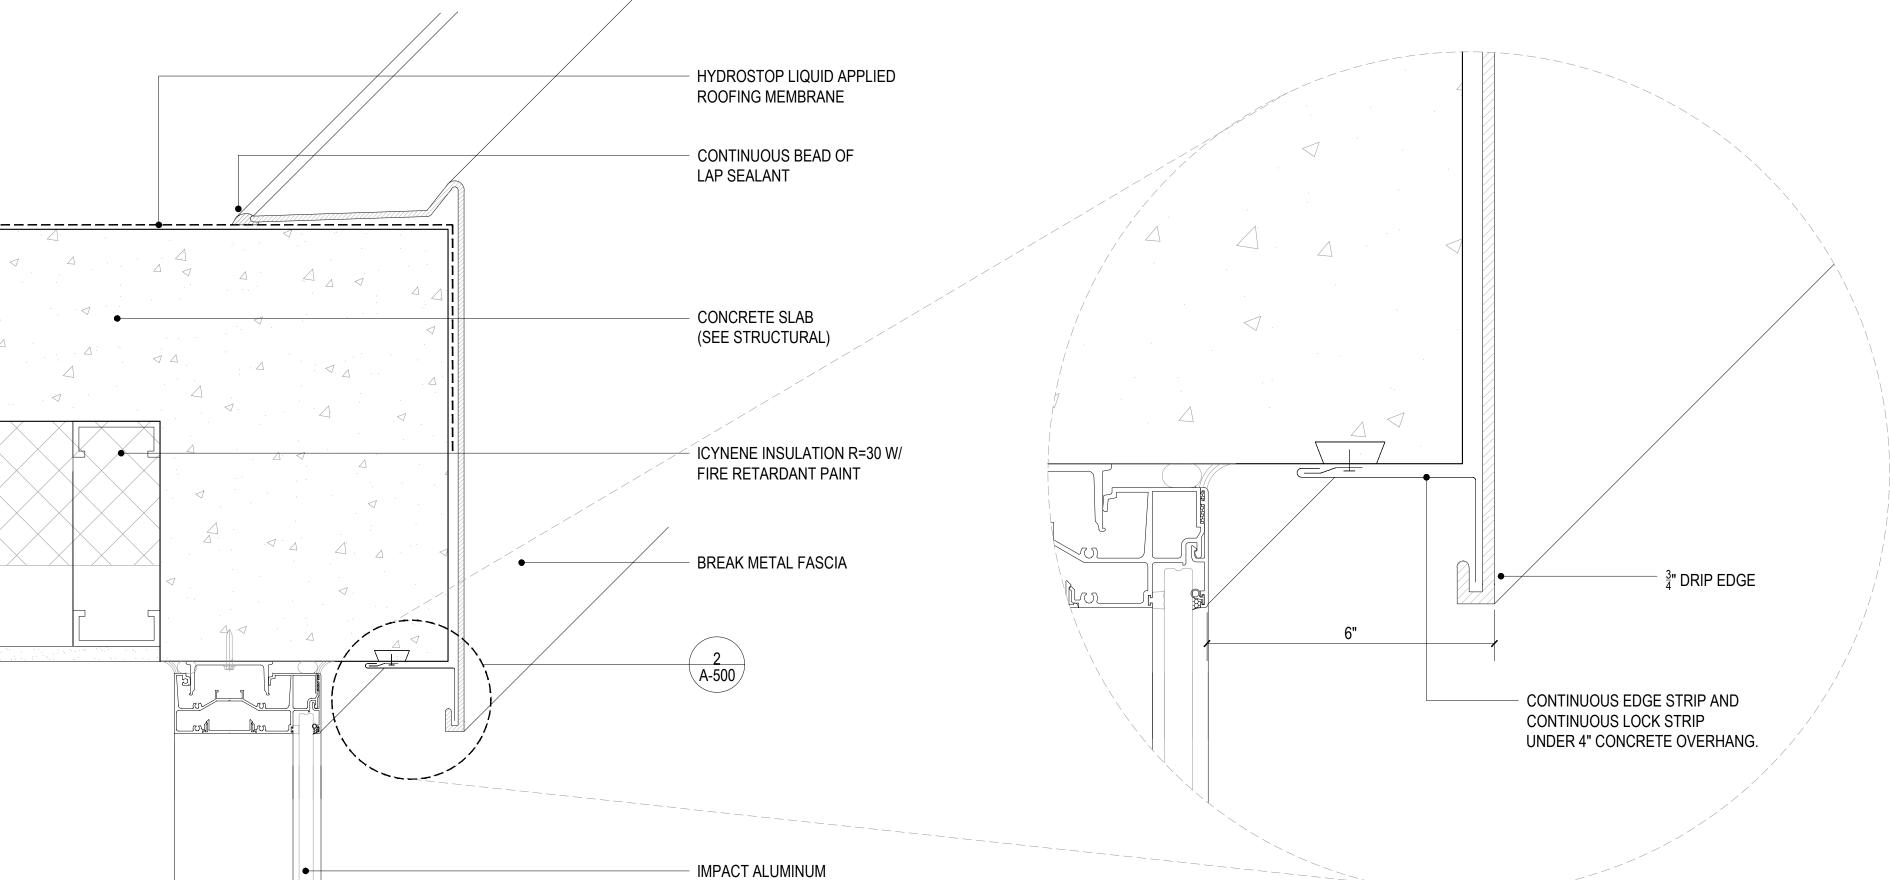

WINDOW WALL

<u>02</u> 04.07.2022 BOA REV.2

<u>01</u> 01.28.2022 BOA REV.1 DESCRIPTION

SHEET ISSUE/ REVISION LOG

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"In my professional judgement and to the best of my knowledge and belief, these plans and specifications comply with F.B.C. 7th Edition (2021).

PROJECT ID: DRAWN BY: 1001 MG PRINT DATE: SCALE: 2"=-1'-0" 04.07.22

DRAWING TITLE:

WALL **DETAILS**

SHEET NO.

TYP. BREEZEWAY- FLAT ROOF EDGE DETAIL.

Scale: 3" = 1'-0"

SUNSET RESIDENCE 601 SUNSET DRIVE - WEST


CORAL GABLES, FLORIDA


SUBMITTAL COMPARISONS




- 1. RESTUDY FRONT FACADE.
- 2. RESTUDY MASSING AT LIVING ROOM.
- 3. RESTUDY CONNECTION TO ENTRY ELEMENTS.
- 4. RESTUDY GARAGE SIZE / DOOR SIZE / DOOR STYLE.
 - **5. RECONFIGURE FRONT LIVING / ENTRY AREA**



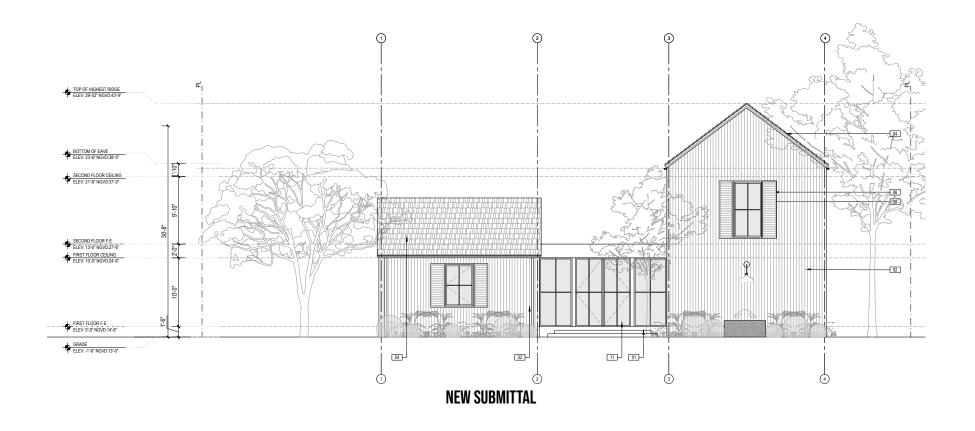


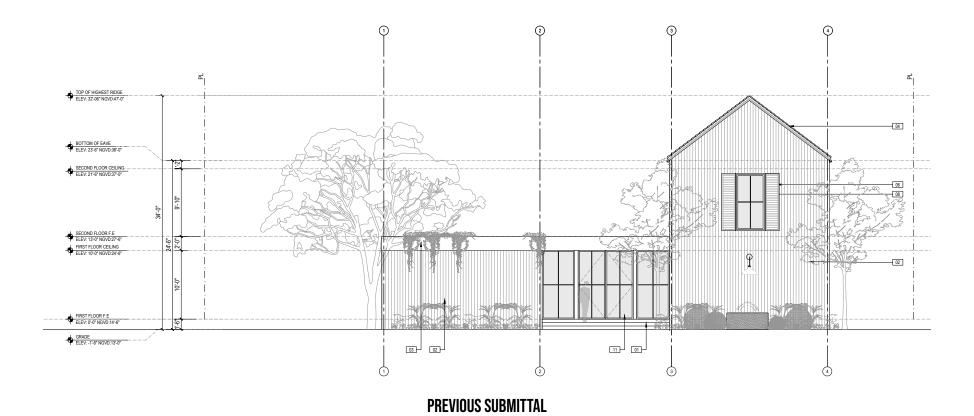




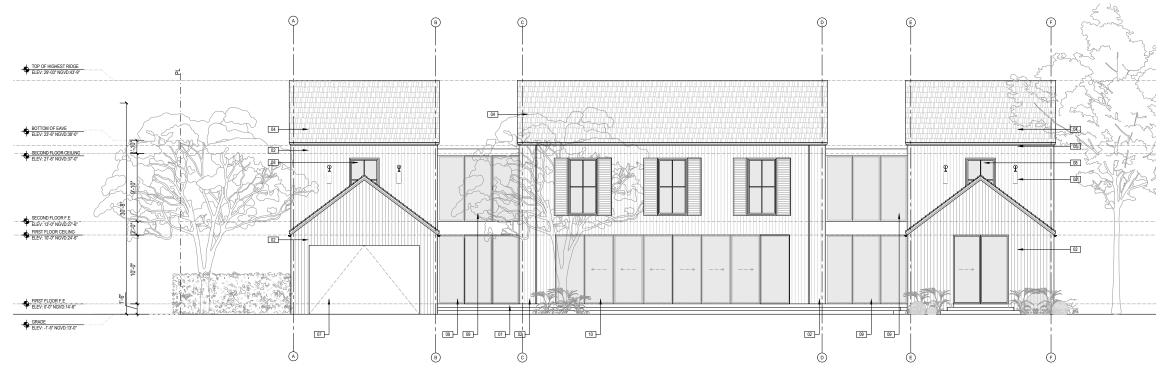


NEW SUBMITTAL

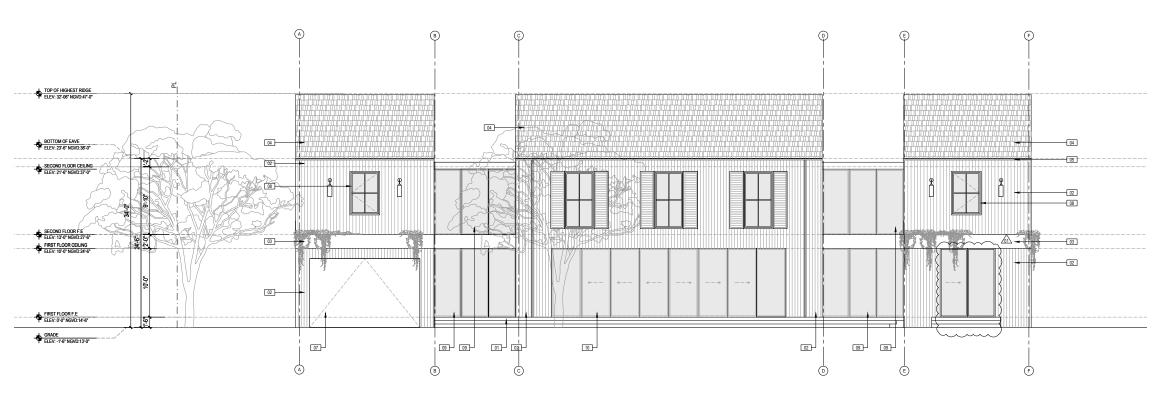



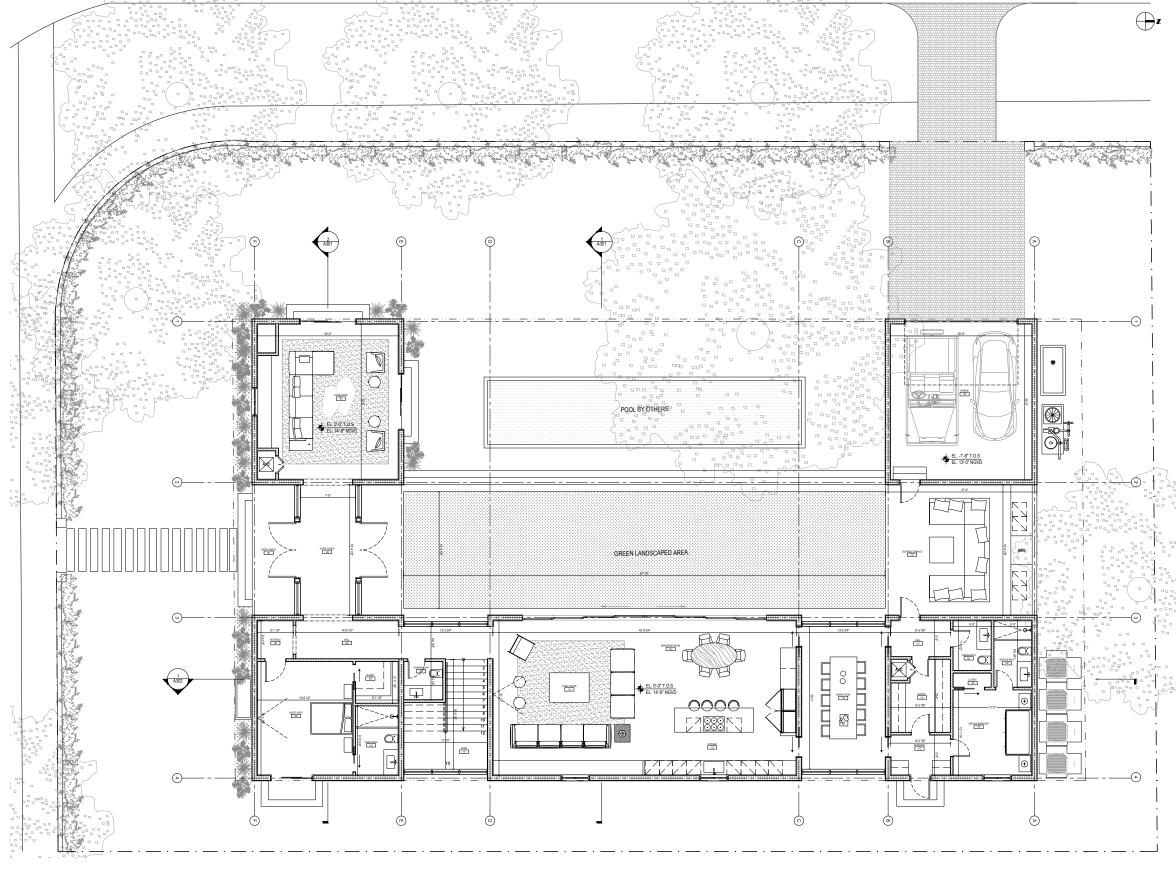



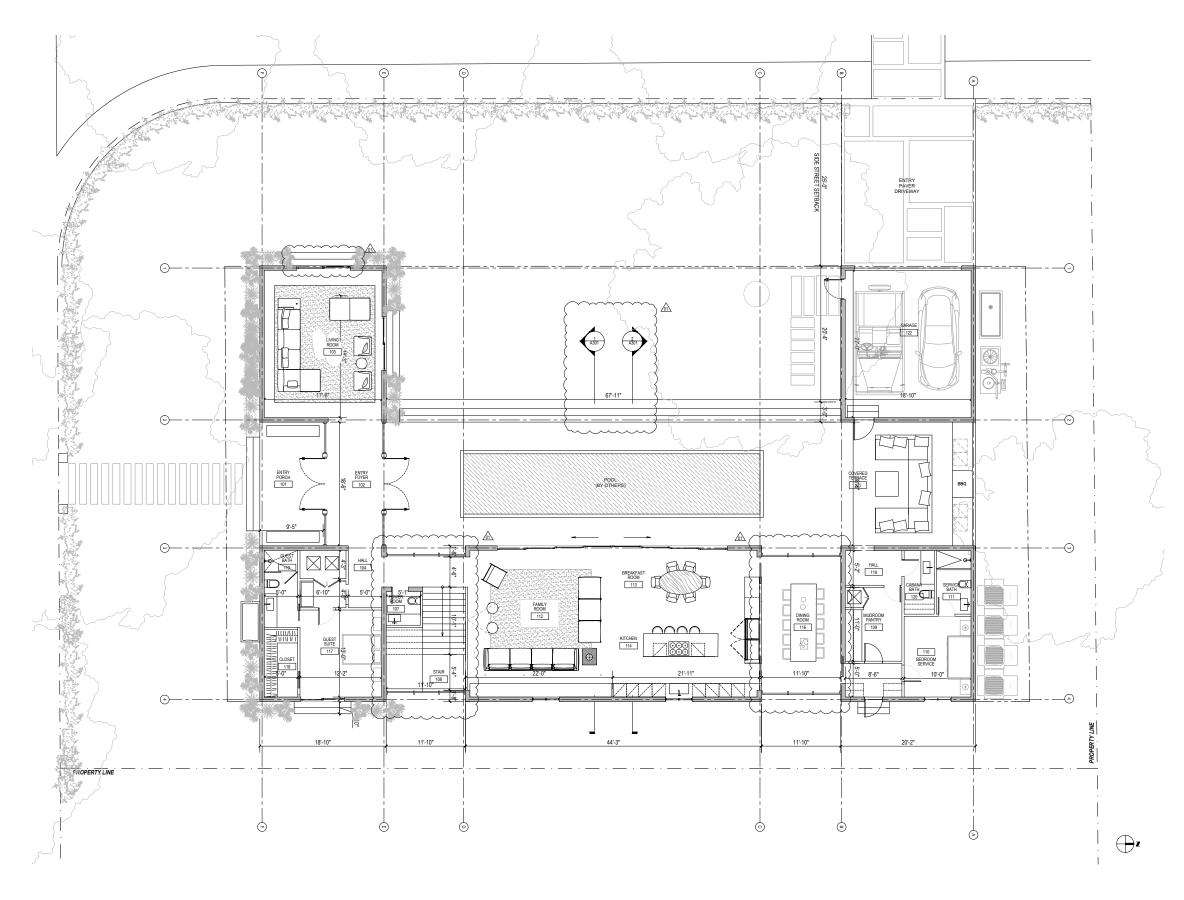







SUNSET RESIDENCE - WEST

PROJECT LOCATION: 601 SUNSET DRIVE CORAL GABLES, FL 33143

PROJECT CLIENT/OWNER(S): SUNSET 8, LLC


ARCHITECT:
ANA GUARACAO SERRANO
LIC#: AR100664
1800 NORTH BAYSHORE DRIVE, #402
MIAMI, FL 33132
PH: (214)708-1454

STRUCTURAL ENGINEERING:

MEP ENGINEERING:

LANDSCAPE ARCHITECT:

PROFESSIONAL SEALS:

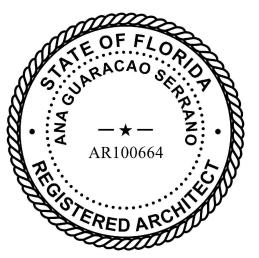

02 04.07.2022 BOA REV.2

01 01.28.2022

NO. DATE DESCRIPTION

SHEET ISSUE/ REVISION LOG

BOA REV.1

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PROJECT ID:	DRAWN BY:
1001	AB
PRINT DATE:	SCALE:
04.07.22	1/4"-1'-0"

DRAWING TITLE:

RENDERING

SHEET NO.





SUNSET RESIDENCE - WEST

PROJECT LOCATION: 601 SUNSET DRIVE CORAL GABLES, FL 33143

PROJECT CLIENT/OWNER(S): SUNSET 8, LLC

ARCHITECT:
ANA GUARACAO SERRANO
LIC#: AR100664
1800 NORTH BAYSHORE DRIVE, #402
MIAMI, FL 33132
PH: (214)708-1454

STRUCTURAL ENGINEERING:

MEP ENGINEERING:

LANDSCAPE ARCHITECT:

PROFESSIONAL SEALS:



02 04.07.2022 BOA REV.2

01 01.28.2022

NO. DATE DESCRIPTION

BOA REV.1

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SHEET ISSUE/ REVISION LOG

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PROJECT ID: DRAWN BY:

1001 AB

PRINT DATE: SCALE:

04.07.22 1/4"-1'-0"

DRAWING TITLE:

RENDERING

SHEET NO.





SUNSET RESIDENCE - WEST

PROJECT LOCATION: 601 SUNSET DRIVE CORAL GABLES, FL 33143

PROJECT CLIENT/OWNER(S): SUNSET 8, LLC

ARCHITECT:
ANA GUARACAO SERRANO
LIC#: AR100664
1800 NORTH BAYSHORE DRIVE, #402
MIAMI, FL 33132
PH: (214)708-1454

STRUCTURAL ENGINEERING:

MEP ENGINEERING:

LANDSCAPE ARCHITECT:

PROFESSIONAL SEALS:



02 04.07.2022 BOA REV.2

01 01.28.2022

NO. DATE DESCRIPTION

SHEET ISSUE/ REVISION LOG

BOA REV.1

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PROJECT ID:	DRAWN BY:
1001	AB
PRINT DATE:	SCALE:
04.07.22	1/4"-1'-0"

DRAWING TITLE:

RENDERING

SHEET NO.





SUNSET RESIDENCE - WEST

PROJECT LOCATION: 601 SUNSET DRIVE CORAL GABLES, FL 33143

PROJECT CLIENT/OWNER(S): SUNSET 8, LLC

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1800 NORTH BAYSHORE DRIVE, #402
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STRUCTURAL ENGINEERING:

MEP ENGINEERING:

LANDSCAPE ARCHITECT:

PROFESSIONAL SEALS:



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1001	АВ
PRINT DATE:	SCALE:
04.07.22	1/4"-1'-0"

DRAWING TITLE:

RENDERING

SHEET NO.





SUNSET RESIDENCE - WEST

PROJECT LOCATION: 601 SUNSET DRIVE CORAL GABLES, FL 33143

PROJECT CLIENT/OWNER(S): SUNSET 8, LLC


ARCHITECT:
ANA GUARACAO SERRANO
LIC#: AR100664
1800 NORTH BAYSHORE DRIVE, #402
MIAMI, FL 33132
PH: (214)708-1454

STRUCTURAL ENGINEERING:

MEP ENGINEERING:

LANDSCAPE ARCHITECT:

PROFESSIONAL SEALS:

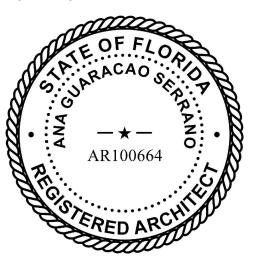

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1001 AB

PRINT DATE: SCALE:

04.07.22 1/4"-1'-0"

DRAWING TITLE:

RENDERING

SHEET NO.

ARCHITECTURE SHEET INDEX

GENERAL

A001 INDEX AND DATA

CONTEXT AND EXISTING PHOTOS

CONTEXT AND EXISTING PHOTOS

A004 SURVEY

SITE PLAN

ZONING DATA

FIRST FLOOR PLAN


SECOND FLOOR PLAN **ROOF PLAN**

A200 **ELEVATIONS**


ELEVATIONS


SECTIONS SECTIONS

GRAPHICAL SYMBOLS

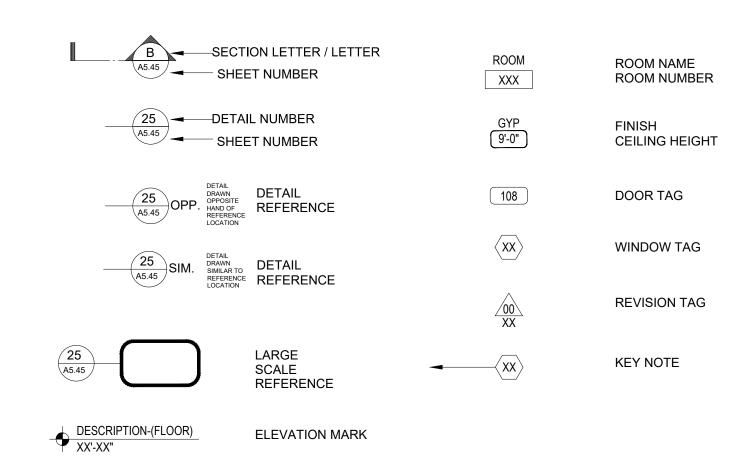

LOCATION:

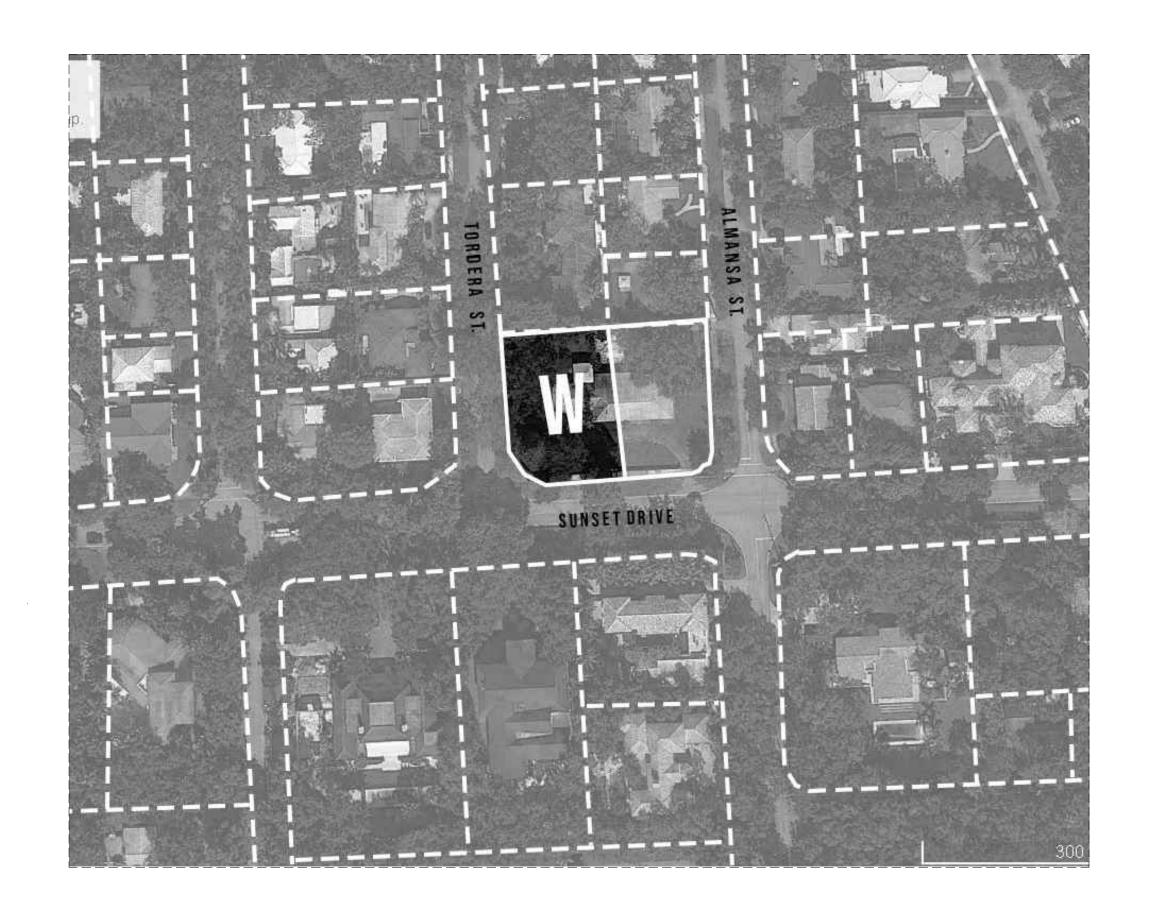

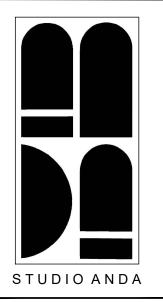

PROJECT TITLE:

SUNSET 8, LLC

SUNSET RESIDENCE - WEST

PROJECT LOCATION: 601 SUNSET DRIVE CORAL GABLES, FL 33143

PROJECT CLIENT/OWNER(S):

ARCHITECT: ANA GUARACAO SERRANO


LIC#: AR100664 1800 NORTH BAYSHORE DRIVE, #402 MIAMI, FL 33132 PH: (214)708-1454

STRUCTURAL ENGINEERING:

MEP ENGINEERING:

LANDSCAPE ARCHITECT:

PROFESSIONAL SEALS:

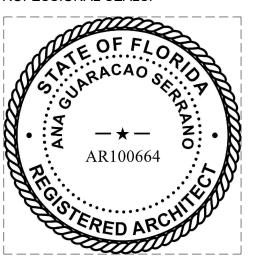

02 04.07.2022 BOA REV.2

01 01.28.2022 BOA REV.1

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semply warr is of rar Edition (2020).		
PROJECT ID:	DRAWN BY:	
1001	AB	
PRINT DATE:	SCALE:	
04.07.22		

DRAWING TITLE:

INDEX & DATA

SHEET NO.

KEY MAP:





MEP ENGINEERING: LANDSCAPE ARCHITECT: PROFESSIONAL SEALS:

STUDIO ANDA

SUNSET RESIDENCE - WEST

PROJECT TITLE:

PROJECT LOCATION:

SUNSET 8, LLC

601 SUNSET DRIVE CORAL GABLES, FL 33143

PROJECT CLIENT/OWNER(S):

STRUCTURAL ENGINEERING:

ARCHITECT:
ANA GUARACAO SERRANO
LIC#: AR100664
1800 NORTH BAYSHORE DRIVE, #402
MIAMI, FL 33132
PH: (214)708-1454

630 SUNSET DRIVE Scale: N.T.S

Scale: N.T.S

02 04.07.2022 BOA REV.2

DESCRIPTION

01 01.28.2022

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BOA REV.1

"In my professional judgement and to the best of my knowledge and belief, these plans and specifications comply with F.B.C. 7th Edition (2020). PROJECT ID: DRAWN BY: 1001

PRINT DATE: SCALE: 04.07.22

DRAWING TITLE:

CONTEXT IMAGES

SHEET NO.





613 SUNSET DRIVE

615 SUNSET DRIVE Scale: N.T.S 4





SITE PICTURES Scale: N.T.S







SIDE WALK PICTURES Scale: N.T.S

STUDIO ANDA

SUNSET RESIDENCE - WEST

PROJECT LOCATION: 601 SUNSET DRIVE CORAL GABLES, FL 33143

PROJECT CLIENT/OWNER(S):

SUNSET 8, LLC


ARCHITECT: ANA GUARACAO SERRANO LIC#: AR100664 1800 NORTH BAYSHORE DRIVE, #402 MIAMI, FL 33132 PH: (214)708-1454

STRUCTURAL ENGINEERING:

MEP ENGINEERING:

LANDSCAPE ARCHITECT:

PROFESSIONAL SEALS:

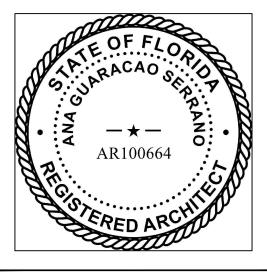

02 04.07.2022 BOA REV.2

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PROJECT ID: DRAWN BY: PRINT DATE: SCALE:

04.07.22

DRAWING TITLE:

SITE IMAGES

SHEET NO.

COUNTY-WIDE LAND SURVEYORS INC.

LAND SURVEYORS - PLANHERS

P.O. BOX 823271 SOUTH FLORIDA, FL. 33082-3271 (305) 772-0766

15358 S.W. 140 St. Miami, Fl. 33196

LEGAL DESCRIPTION

Lots 13 thru 18 in Block 236 of REVISED PLAT OF CORAL GABLES RIVIERA SECTION PART 11, according to the plat thereof, as recorded in Plat Book 28 at Page 23 of the Public Records of Miami-DadeeCounty, Florida.

SURVEYORS NOTES:

- Legal description provided by client.
 Only record plat easements are shown.
 Right of way information obtained from record plat.

CERTIFIED TO:

SUNSET 8, LLC, a Florida Limited Liabality Company Halpern Rodriguez, LLP Old Republic National Title Insurance Company


TREE LEGEND

1	• <u>OV</u>	SPECIE	DIAMETER	<u>HEIGHT</u>	CANOPY
	1	Orchid	1.5'	35'	30¹
	2	Black Olive	0.8'	30'	15 '
	3	Oak	2.5'	35'	40 ¹
	4	Ficus	Cluster		
	5	Tropical Almond	1.4'	25 '	15 '
	6	Gumbo Limbo	1.0'	201	15 '
1	77-8	Oak	0.8'	251	15 '
	9	Oak	0.3'	15'	8 *
•	10	Oak (2)	1.5'	45'	40 '
•	11	Gumbo Limbo	1.5'	451	30 '

BOUNDARY SURVEY		
	601 Sunset Dr. Coral Gables, Fl. 3	3143
SURVEYORS CERTIFICATE: NOTE: "NOT VALID UNLESS SURVEYORS SEAL." I HEREBY CERTIFY THAT THE SECOMPLIES WITH THE MINIMUM TECHNICAL STANDARDS BOARD OF SURVEYORS AND MAPPERS IN CHAPTER .5J. ADMINISTRATIVE CODE, PURSURANT TO SECTION 472	URVEY REPRESENTED HEREON ADOPTED BY THE PLORIDA	LB # 4680

· · · · · · · · · · · · · · · · · · ·	~~~
JOSEPH L. MARTIN 1 PROFESSIONAL LAND SURVEYOR # 4368. STATE OF FLORIDA	Y

REVISION	3		BY	DATE
TREES			JCW	15-18-5016
XAWN BY LM	11530.	4-4-749	FB./PG.	2019-
	TREES	RAWN BY SCALE	TREES RAWN BY SCALE DATE	TREES JUM RAWN BY SCALE DATE EB./PG.

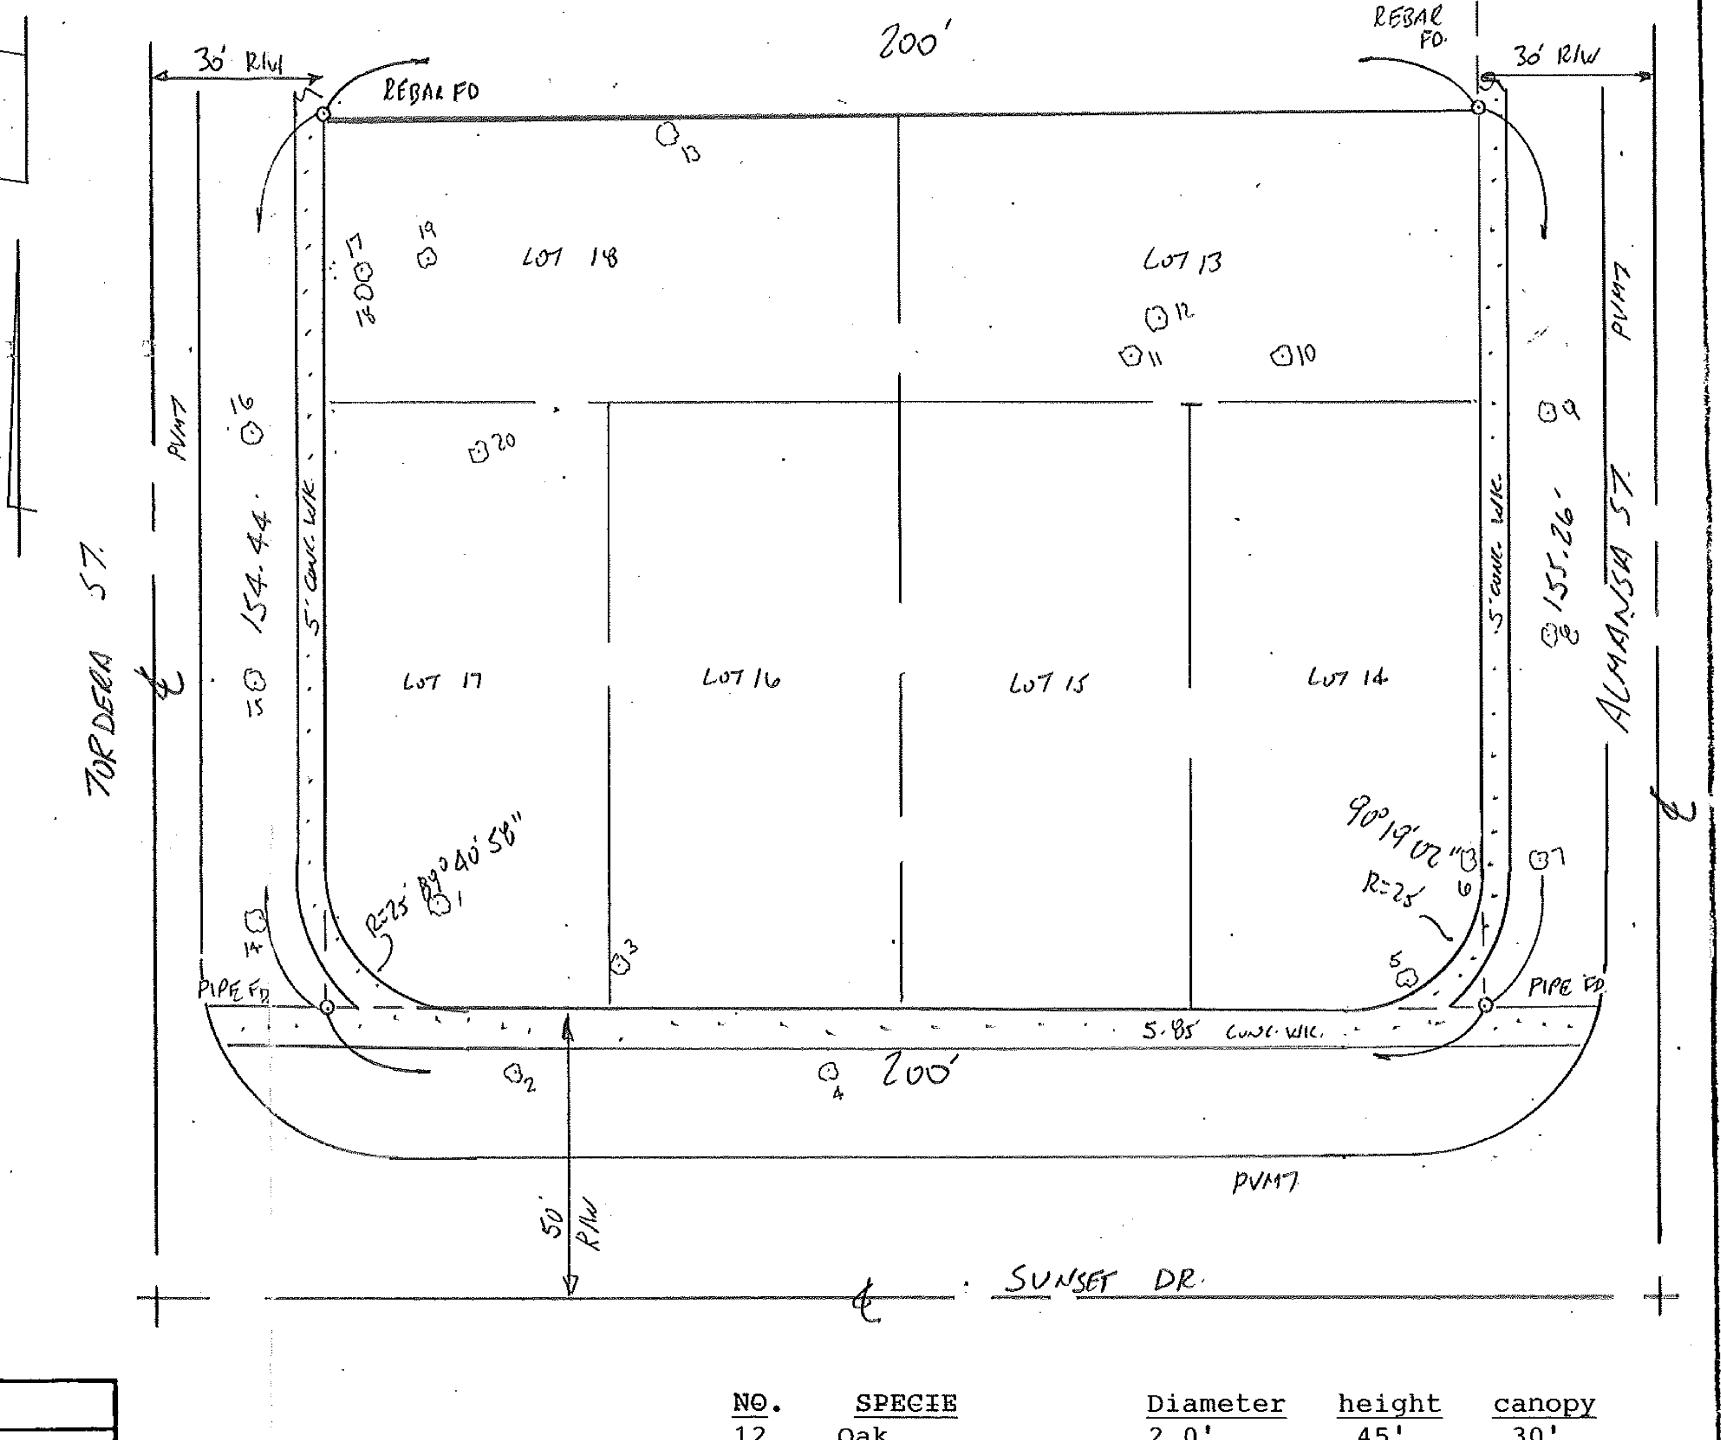

<u>N</u> ⊖.	SPECIE	Diameter	height	canopy
12	Oak	2.0	45'	30 '
13	Mango	1.5 *	35 †	201
14	Oak	0.7 *	25 *	15 '
15	Oak	1.31	30¹	25'
16	Oak	1.1'	30 '	20'
17-18	Queen Palm	0 7 "	35 '	10 '
19	Oak	2.3'	35'	45 '
20	Avocado	0.7'	25'	15'



PROJECT TITLE:

SUNSET RESIDENCE - WEST

PROJECT LOCATION: 601 SUNSET DRIVE CORAL GABLES, FL 33143

PROJECT CLIENT/OWNER(S):

SUNSET 8, LLC


ARCHITECT: ANA GUARACAO SERRANO LIC#: AR100664 1800 NORTH BAYSHORE DRIVE, #402 MIAMI, FL 33132 PH: (214)708-1454

STRUCTURAL ENGINEERING:

MEP ENGINEERING:

LANDSCAPE ARCHITECT:

PROFESSIONAL SEALS:

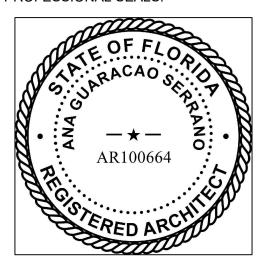

02 04.07.2022

DESCRIPTION

SHEET ISSUE/ REVISION LOG

BOA REV.2

BOA REV.1

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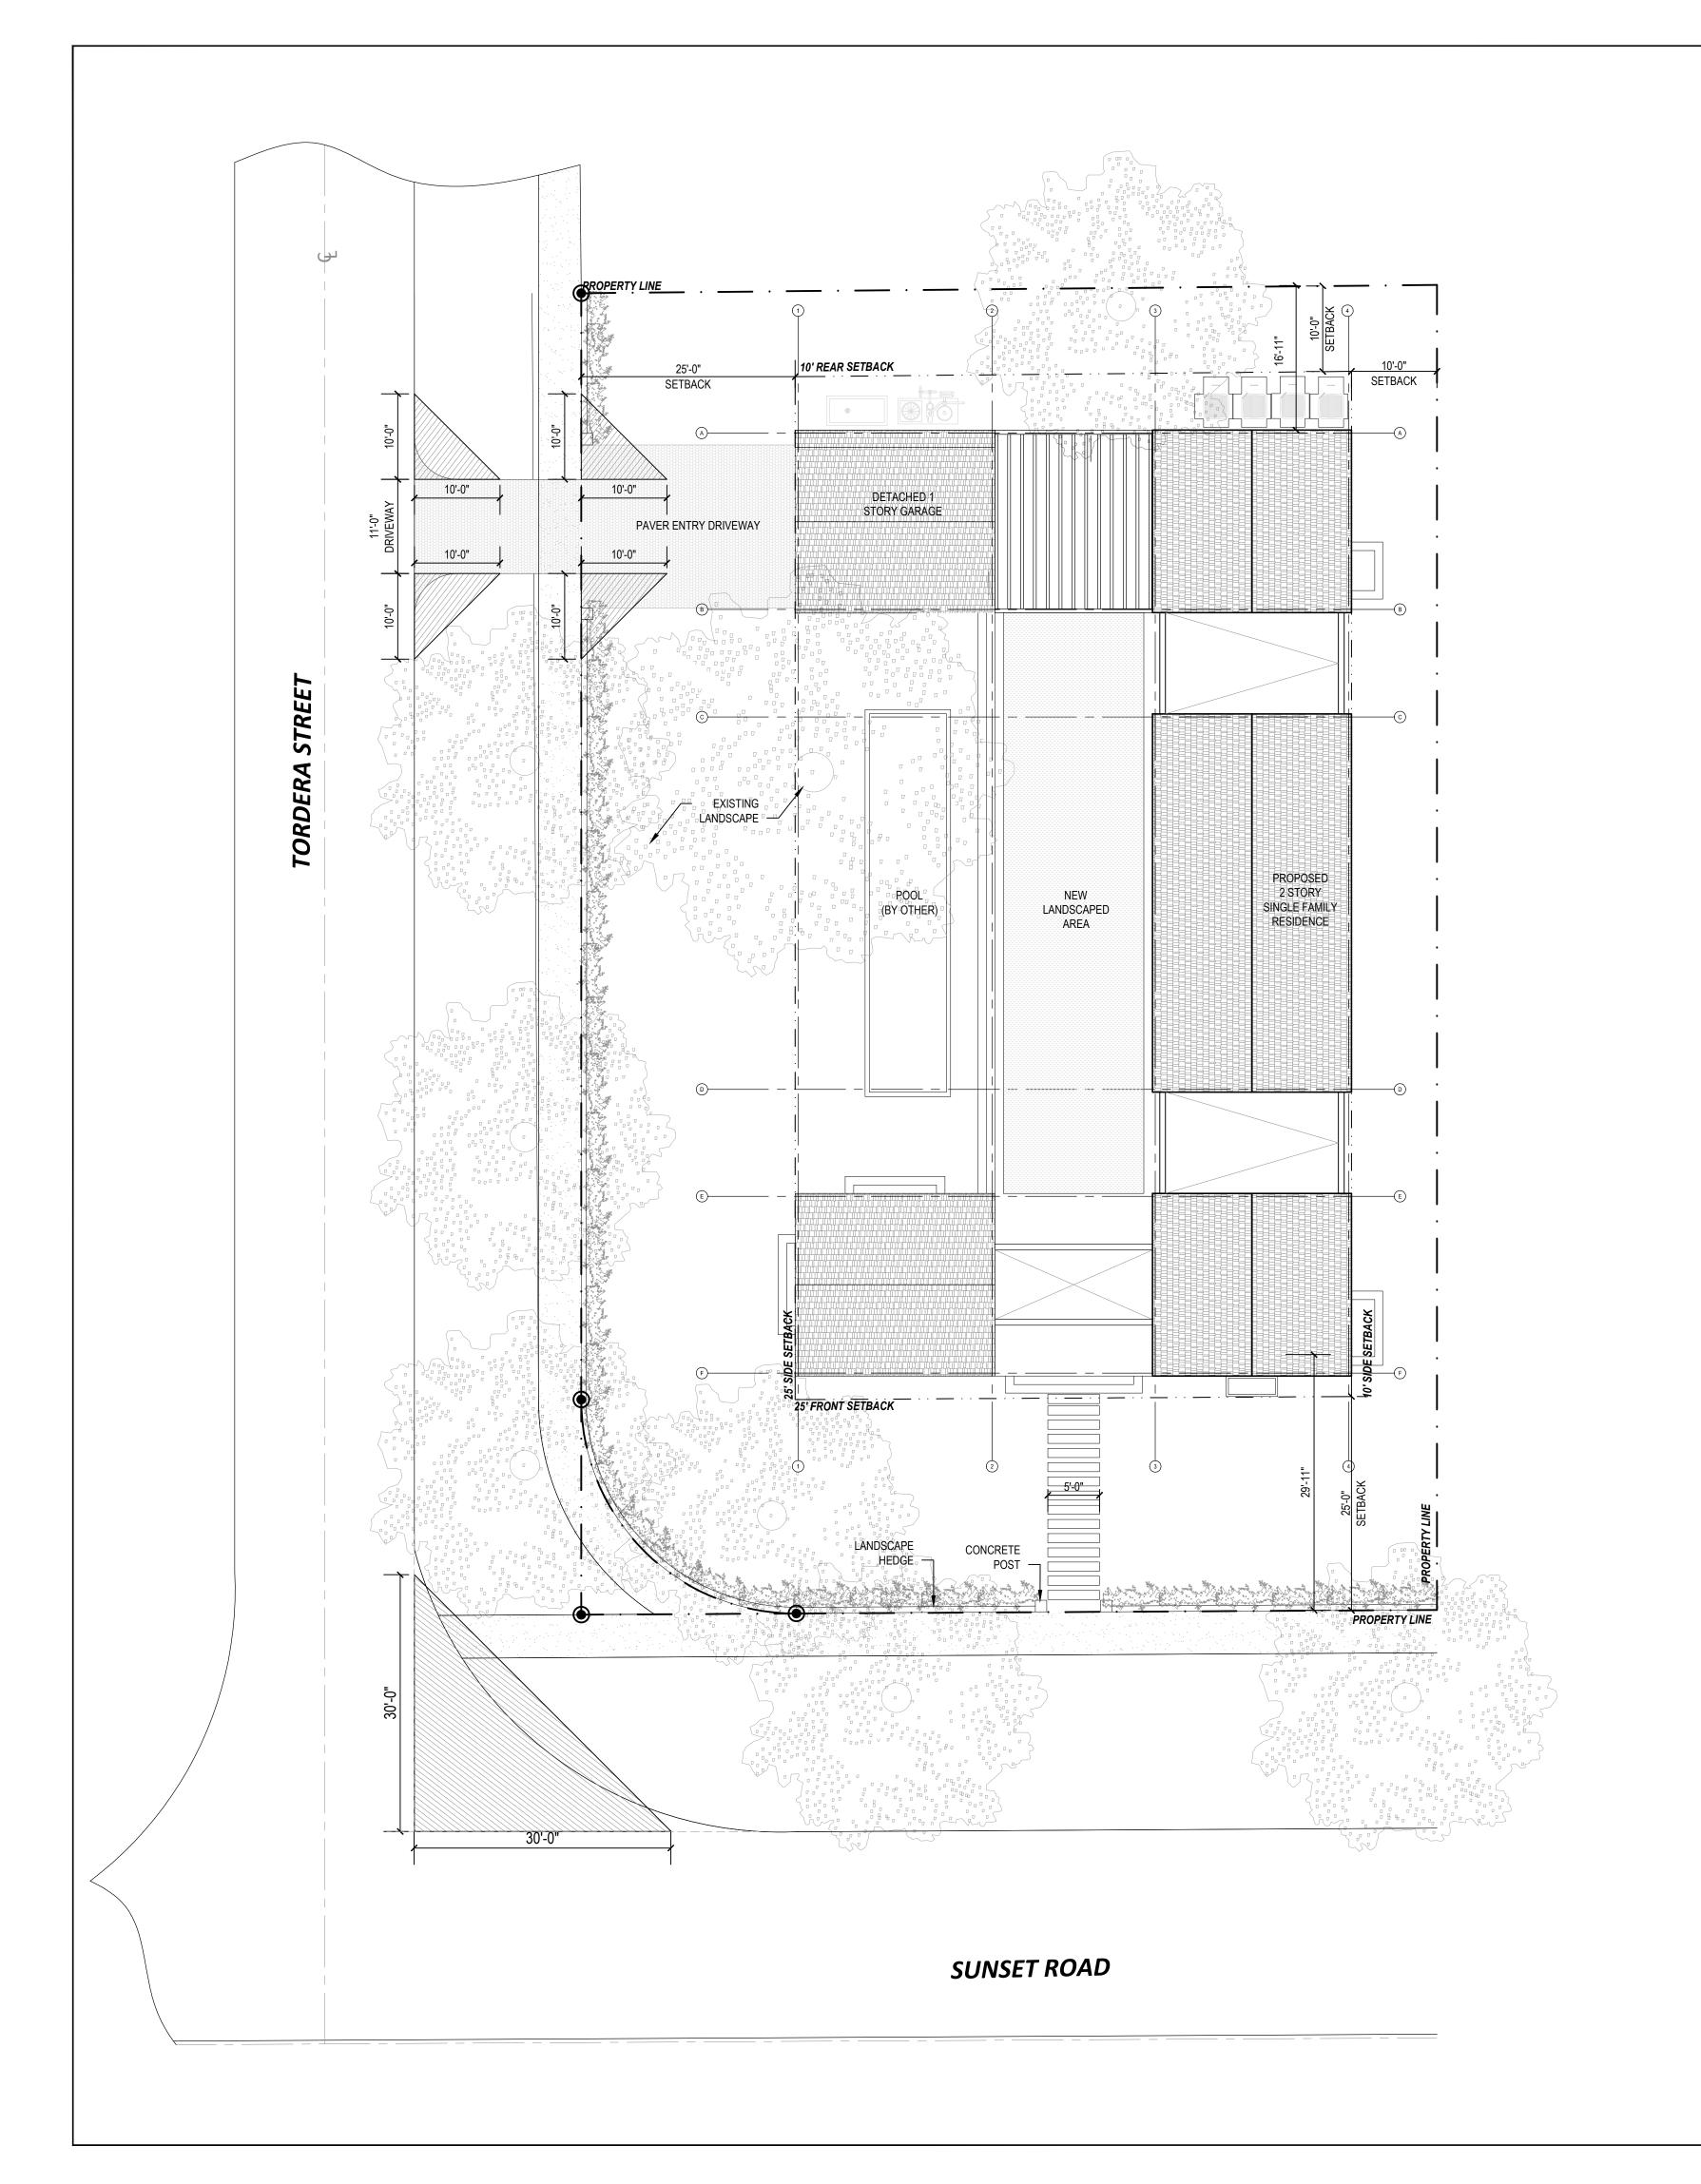
PROJECT ID: DRAWN BY: SCALE: PRINT DATE:

04.07.22

DRAWING TITLE:

TREE SURVEY

SHEET NO.



PROJECT & ZONING DATA

TYPE	:SFR	
OT AREA	:15,500 Sq.Ft	
EGAL DESCRIPTION	:LOTS 16, 17, AND 18,	BLOCK 236,
	"REVISED PLAT OF CO	ORAL GABLES
	RIVIERA SECTION PAI	RT II".ACCORDING
	TO THE PLAT THEREO	
	IN PLAT BOOK 28, PAG	
	PUBLIC RECORDS OF	
	COUNTY, FLORIDA.	WW WW 57 (52
	LOT SIZE 100' X 154'-8	II .
EMA FIRM ZONE	:FLOOD ZONE X	
ROUND COVERAGE:	MAX ALLOWED	PROPOSED
MAIN STRUCTURE	:35% (5,425 Sq.Ft)	: 3,628 Sq.Ft.
TOTAL (INC AUX.)	:45% (6,975 Sq.Ft)	: 4,520 Sq.Ft.
ANDSCAPE OPEN SPACE:	MIN ALLOWED	PROPOSED
OTAL OPEN SPACE	:40%(6,200 Sq.Ft)	: 10,281 Sq.Ft
RONT YARD	:20%(1,240 Sq.Ft)	: 2,630 Sq.Ft
MAX F.A.R.	MAX ALLOWED	
8% OF 5,000	: 2,400 Sq. Ft	
35% OF NEXT 5,000	: 1,750 Sq. Ft	
0% OF REMAINING	: 1,650 Sq. Ft	
OTAL	: 5,800 Sq. Ft	
OTAL	. 0,000 - 04.11	
A.R PROPOSED	PROPOSED	
IRST FLOOR	: 2,939 Sq. Ft.	
GARAGE	: 440 Sq. Ft.	
SECOND FLOOR	: 2,346 Sq. Ft.	
OTAL	: 5,725 Sq.Ft.	
BUILDING HEIGHT:	MAX ALLOWED	MAX PROPOSED
	:25'	:23'-6"
	(TO EAVE)	(TO EAVE)
MAIN BUILDING		
SETBACKS:	REQUIRED	PROPOSED
RONT	:25'	:29'-11"
SIDE (STREET)	:25'	:25'
SIDE (INTERIOR)	:10'	:10'
		:18'


OTES:

- REFER TO LANDSCAPE DRAWINGS FOR LANDSCAPE DETAILS
- ALL RAINWATER MUST BE RETAINED WITHIN PRIVATE PROPERTY.

- ALL REQUIREMENTS FOR LANDSCAPE AS LISTED IN ZONING CODE ARTICLE 5, DIVISION 11 WILL BE COMPLIED WITH.

-ALL POOL GATES ARE SELF CLOSING AND SELF LATCHING



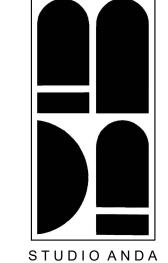

PROJECT TITLE:

SUNSET RESIDENCE - WEST

PROJECT LOCATION: 601 SUNSET DRIVE CORAL GABLES, FL 33143

PROJECT CLIENT/OWNER(S): SUNSET 8, LLC


ARCHITECT:
ANA GUARACAO SERRANO
LIC#: AR100664
1800 NORTH BAYSHORE DRIVE, #402
MIAMI, FL 33132
PH: (214)708-1454

STRUCTURAL ENGINEERING:

MEP ENGINEERING:

LANDSCAPE ARCHITECT:

PROFESSIONAL SEALS:

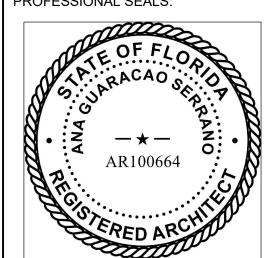

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PRINT DATE: SCALE:


04.07.22 3/32"-1'-0"

DRAWING TITLE:


SITE PLAN


SHEET NO.

4100

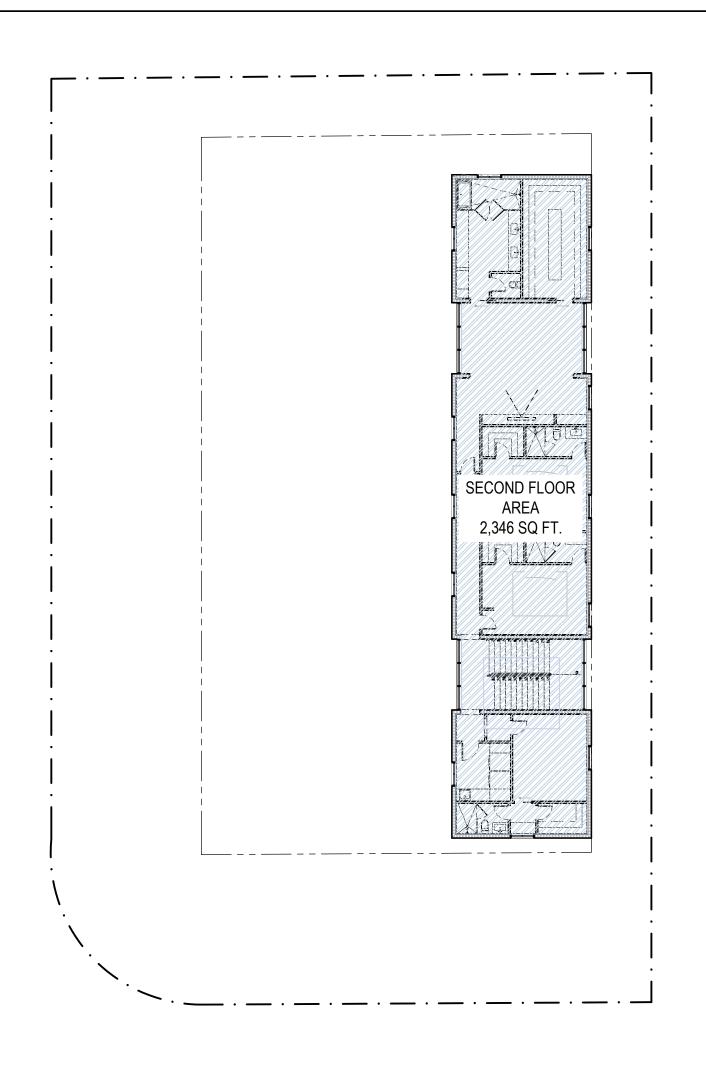

FLOOR AREA CALCULATIONS - SECOND FLOOR

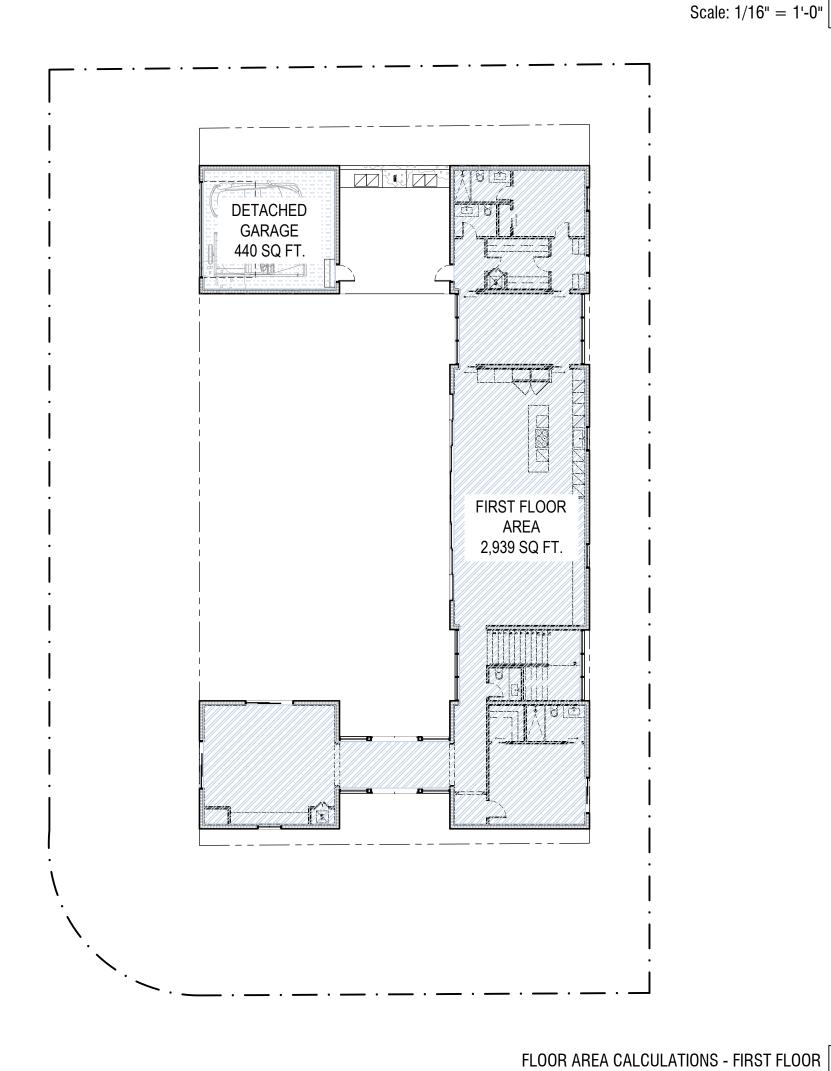

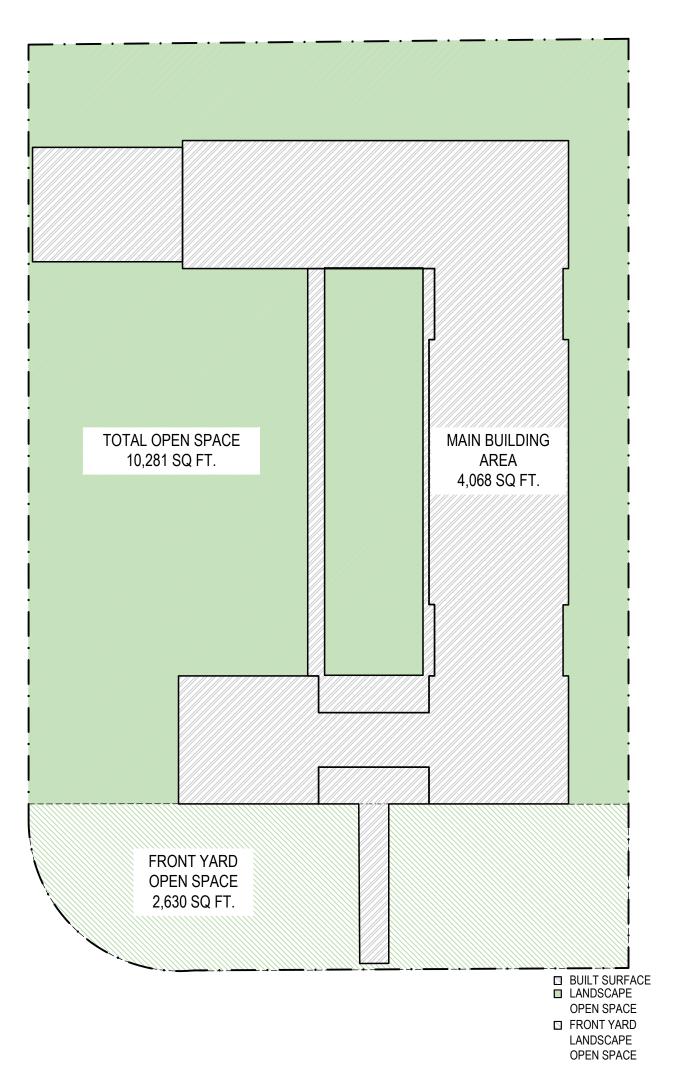

OPEN SPACE DIAGRAMS
Scale: 1/16" - 11 0"

Scale: 1/16" = 1'-0"


MAIN BUILDING

SETBACKS:

SIDE (STREET)

SIDE (INTERIOR)

FRONT

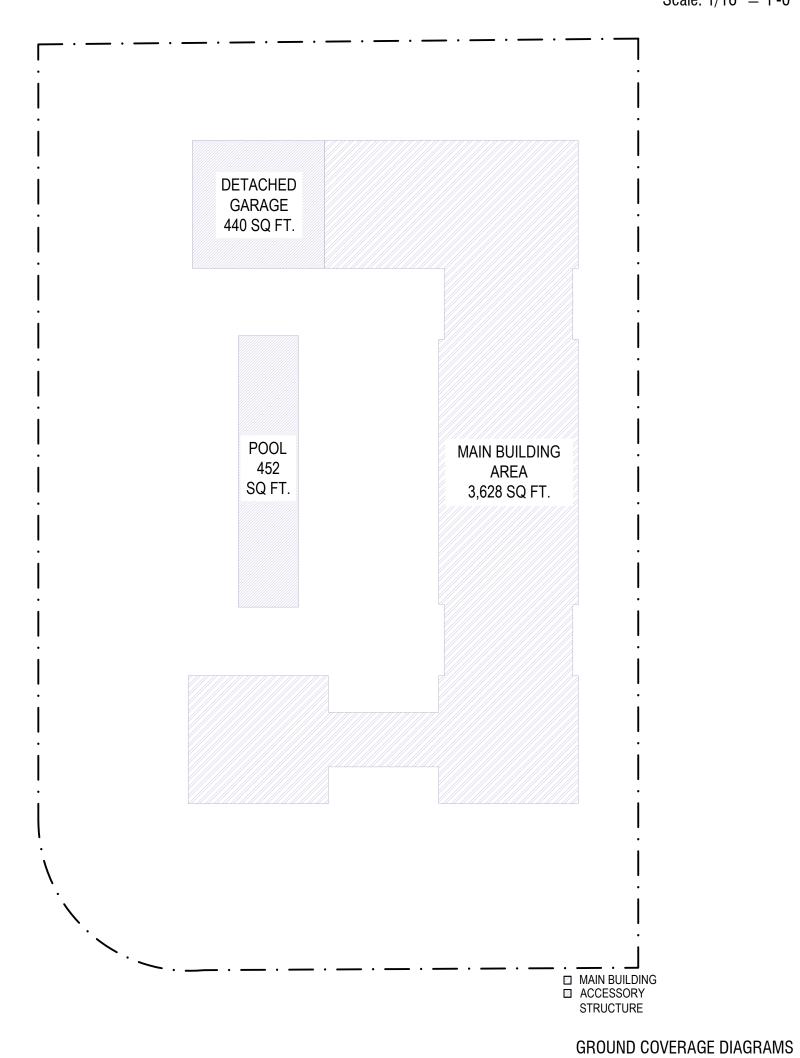

PROJECT & ZONING DATA

SITE INFORMATION: TYPE	:SFR	
OT AREA	:15,500 Sg.Ft	
EGAL DESCRIPTION	:LOTS 16, 17, AND 18, E	31 OCK 236
	"REVISED PLAT OF CO	
	RIVIERA SECTION PAR	
	TO THE PLAT THEREO	· ·
	IN PLAT BOOK 28, PAG	E 23, OF THE
	PUBLIC RECORDS OF	
	COUNTY, FLORIDA.	
	LOT SIZE 100' X 154'-8"	1
FEMA FIRM ZONE	:FLOOD ZONE X	
GROUND COVERAGE:	MAX ALLOWED	PROPOSED
MAIN STRUCTURE	:35% (5,425 Sq.Ft)	: 3,628 Sq.Ft.
OTAL (INC AUX.)	:45% (6,975 Sq.Ft)	: 4,520 Sq.Ft.
ANDSCAPE OPEN SPACE:	MIN ALLOWED	PROPOSED
OTAL OPEN SPACE	:40%(6,200 Sq.Ft)	: 10,281 Sq.Ft
RONT YARD	:20%(1,240 Sq.Ft)	: 2,630 Sq.Ft
MAX F.A.R.	MAX ALLOWED	
18% OF 5,000	: 2,400 Sq. Ft	
35% OF NEXT 5,000	: 1,750 Sq. Ft	
80% OF REMAINING	: 1,650 Sq. Ft	
OTAL	: 5,800 Sq. Ft	
F.A.R PROPOSED	PROPOSED	
FIRST FLOOR	: 2,939 Sq. Ft.	
GARAGE	: 440 Sq. Ft.	
SECOND FLOOR	: 2,346 Sq. Ft.	
OTAL	: 5,725 Sq.Ft.	
BUILDING HEIGHT:	MAX ALLOWED	MAX PROPOSED
	:25'	:23'-6"
	(TO EAVE)	(TO EAVE)

REQUIRED

:25'

:25'

:10'


:10'

PROPOSED

:29'-11"

:25'

:10'

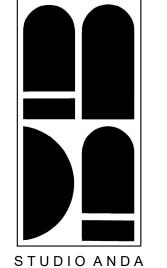

PROJECT TITLE:

SUNSET RESIDENCE - WEST

PROJECT LOCATION: 601 SUNSET DRIVE CORAL GABLES, FL 33143

PROJECT CLIENT/OWNER(S):

SUNSET 8, LLC


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ANA GUARACAO SERRANO
LIC#: AR100664
1800 NORTH BAYSHORE DRIVE, #402
MIAMI, FL 33132
PH: (214)708-1454

STRUCTURAL ENGINEERING:

MEP ENGINEERING:

LANDSCAPE ARCHITECT:

PROFESSIONAL SEALS:

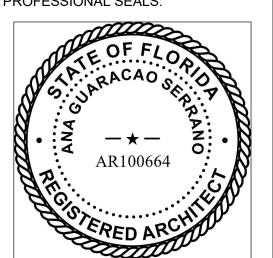

02 04.07.2022 BOA REV.2

01 01.28.2022 BOA REV.1

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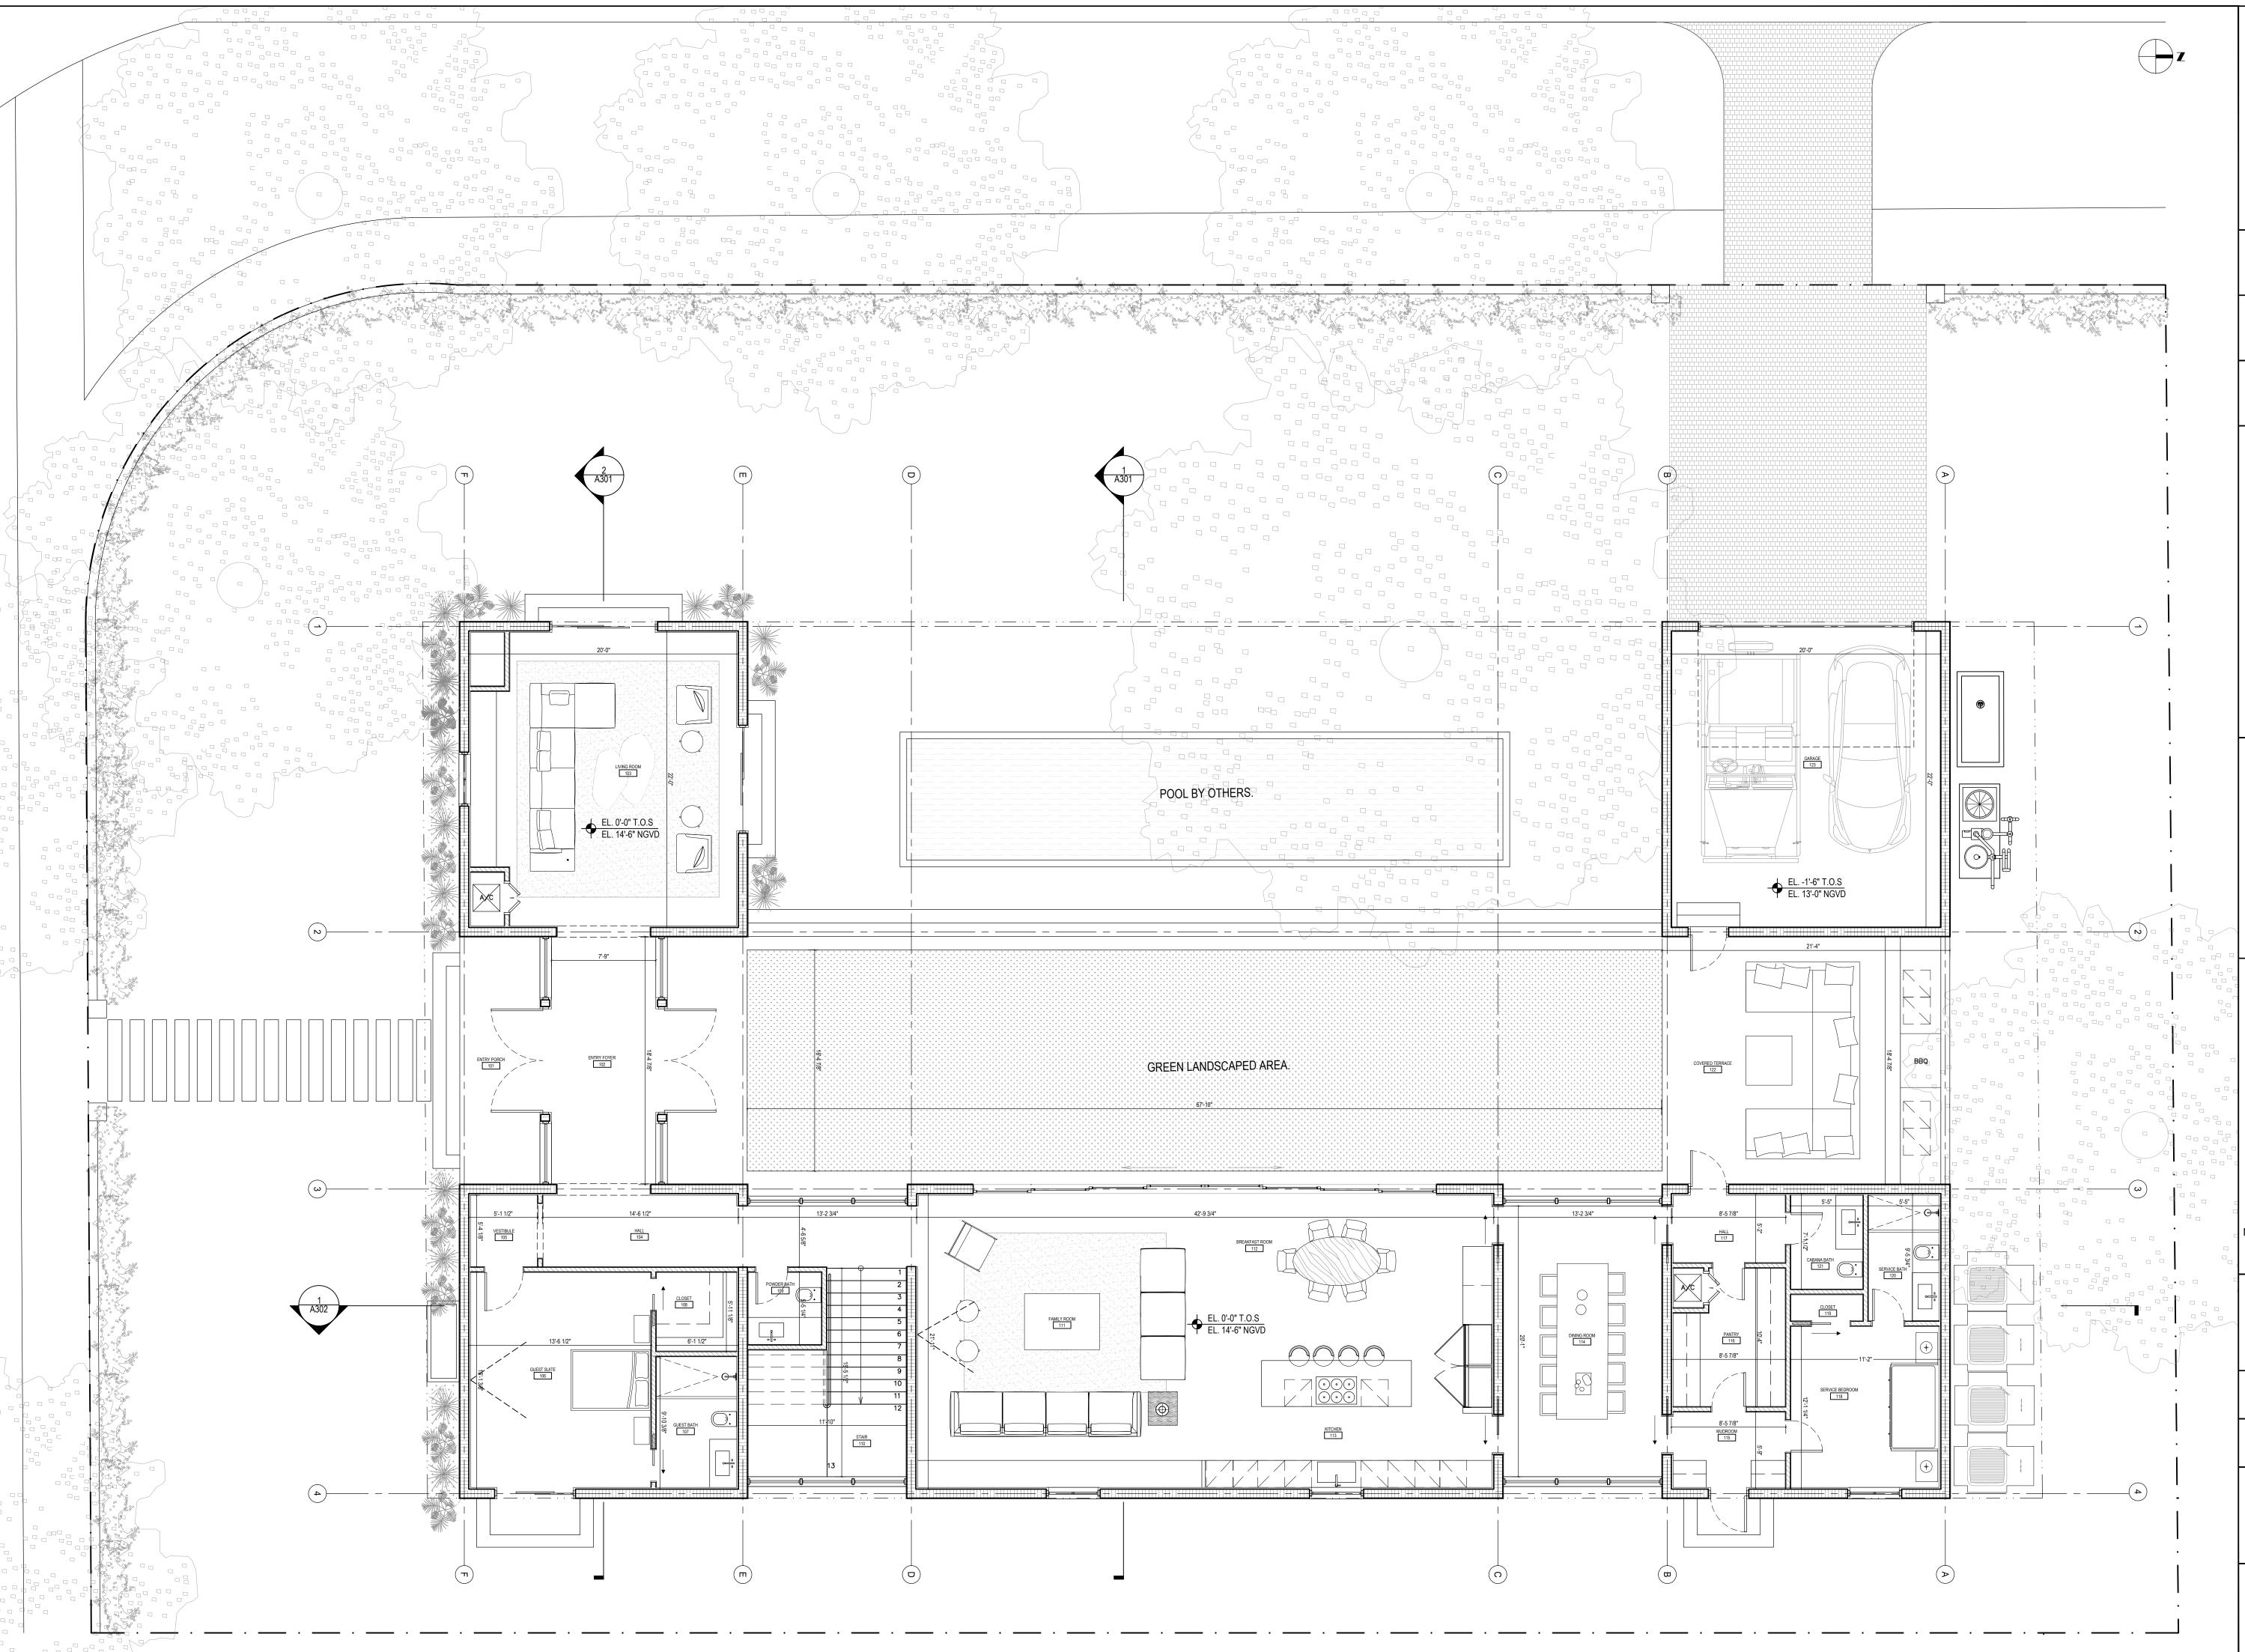
04.07.22


DRAWING TITLE:

ZONING DATA

SHEET NO.

A100B



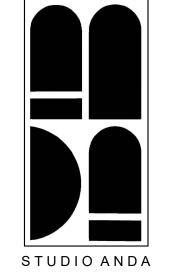

SUNSET RESIDENCE - WEST

PROJECT LOCATION: 601 SUNSET DRIVE CORAL GABLES, FL 33143

PROJECT CLIENT/OWNER(S): SUNSET 8, LLC


ARCHITECT:
ANA GUARACAO SERRANO
LIC#: AR100664
1800 NORTH BAYSHORE DRIVE, #402
MIAMI, FL 33132
PH: (214)708-1454

STRUCTURAL ENGINEERING:

MEP ENGINEERING:

LANDSCAPE ARCHITECT:

PROFESSIONAL SEALS:

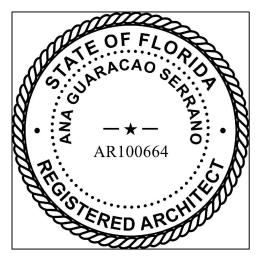

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comply with F.B.C. 7th Edition (2020).		
PROJECT ID:	DRAWN BY:	
1001	AB	
PRINT DATE:	SCALE:	

DRAWING TITLE:


04.07.22


FIRST FLOOR PLAN

3/16"-1'-0"

SHEET NO.

A101

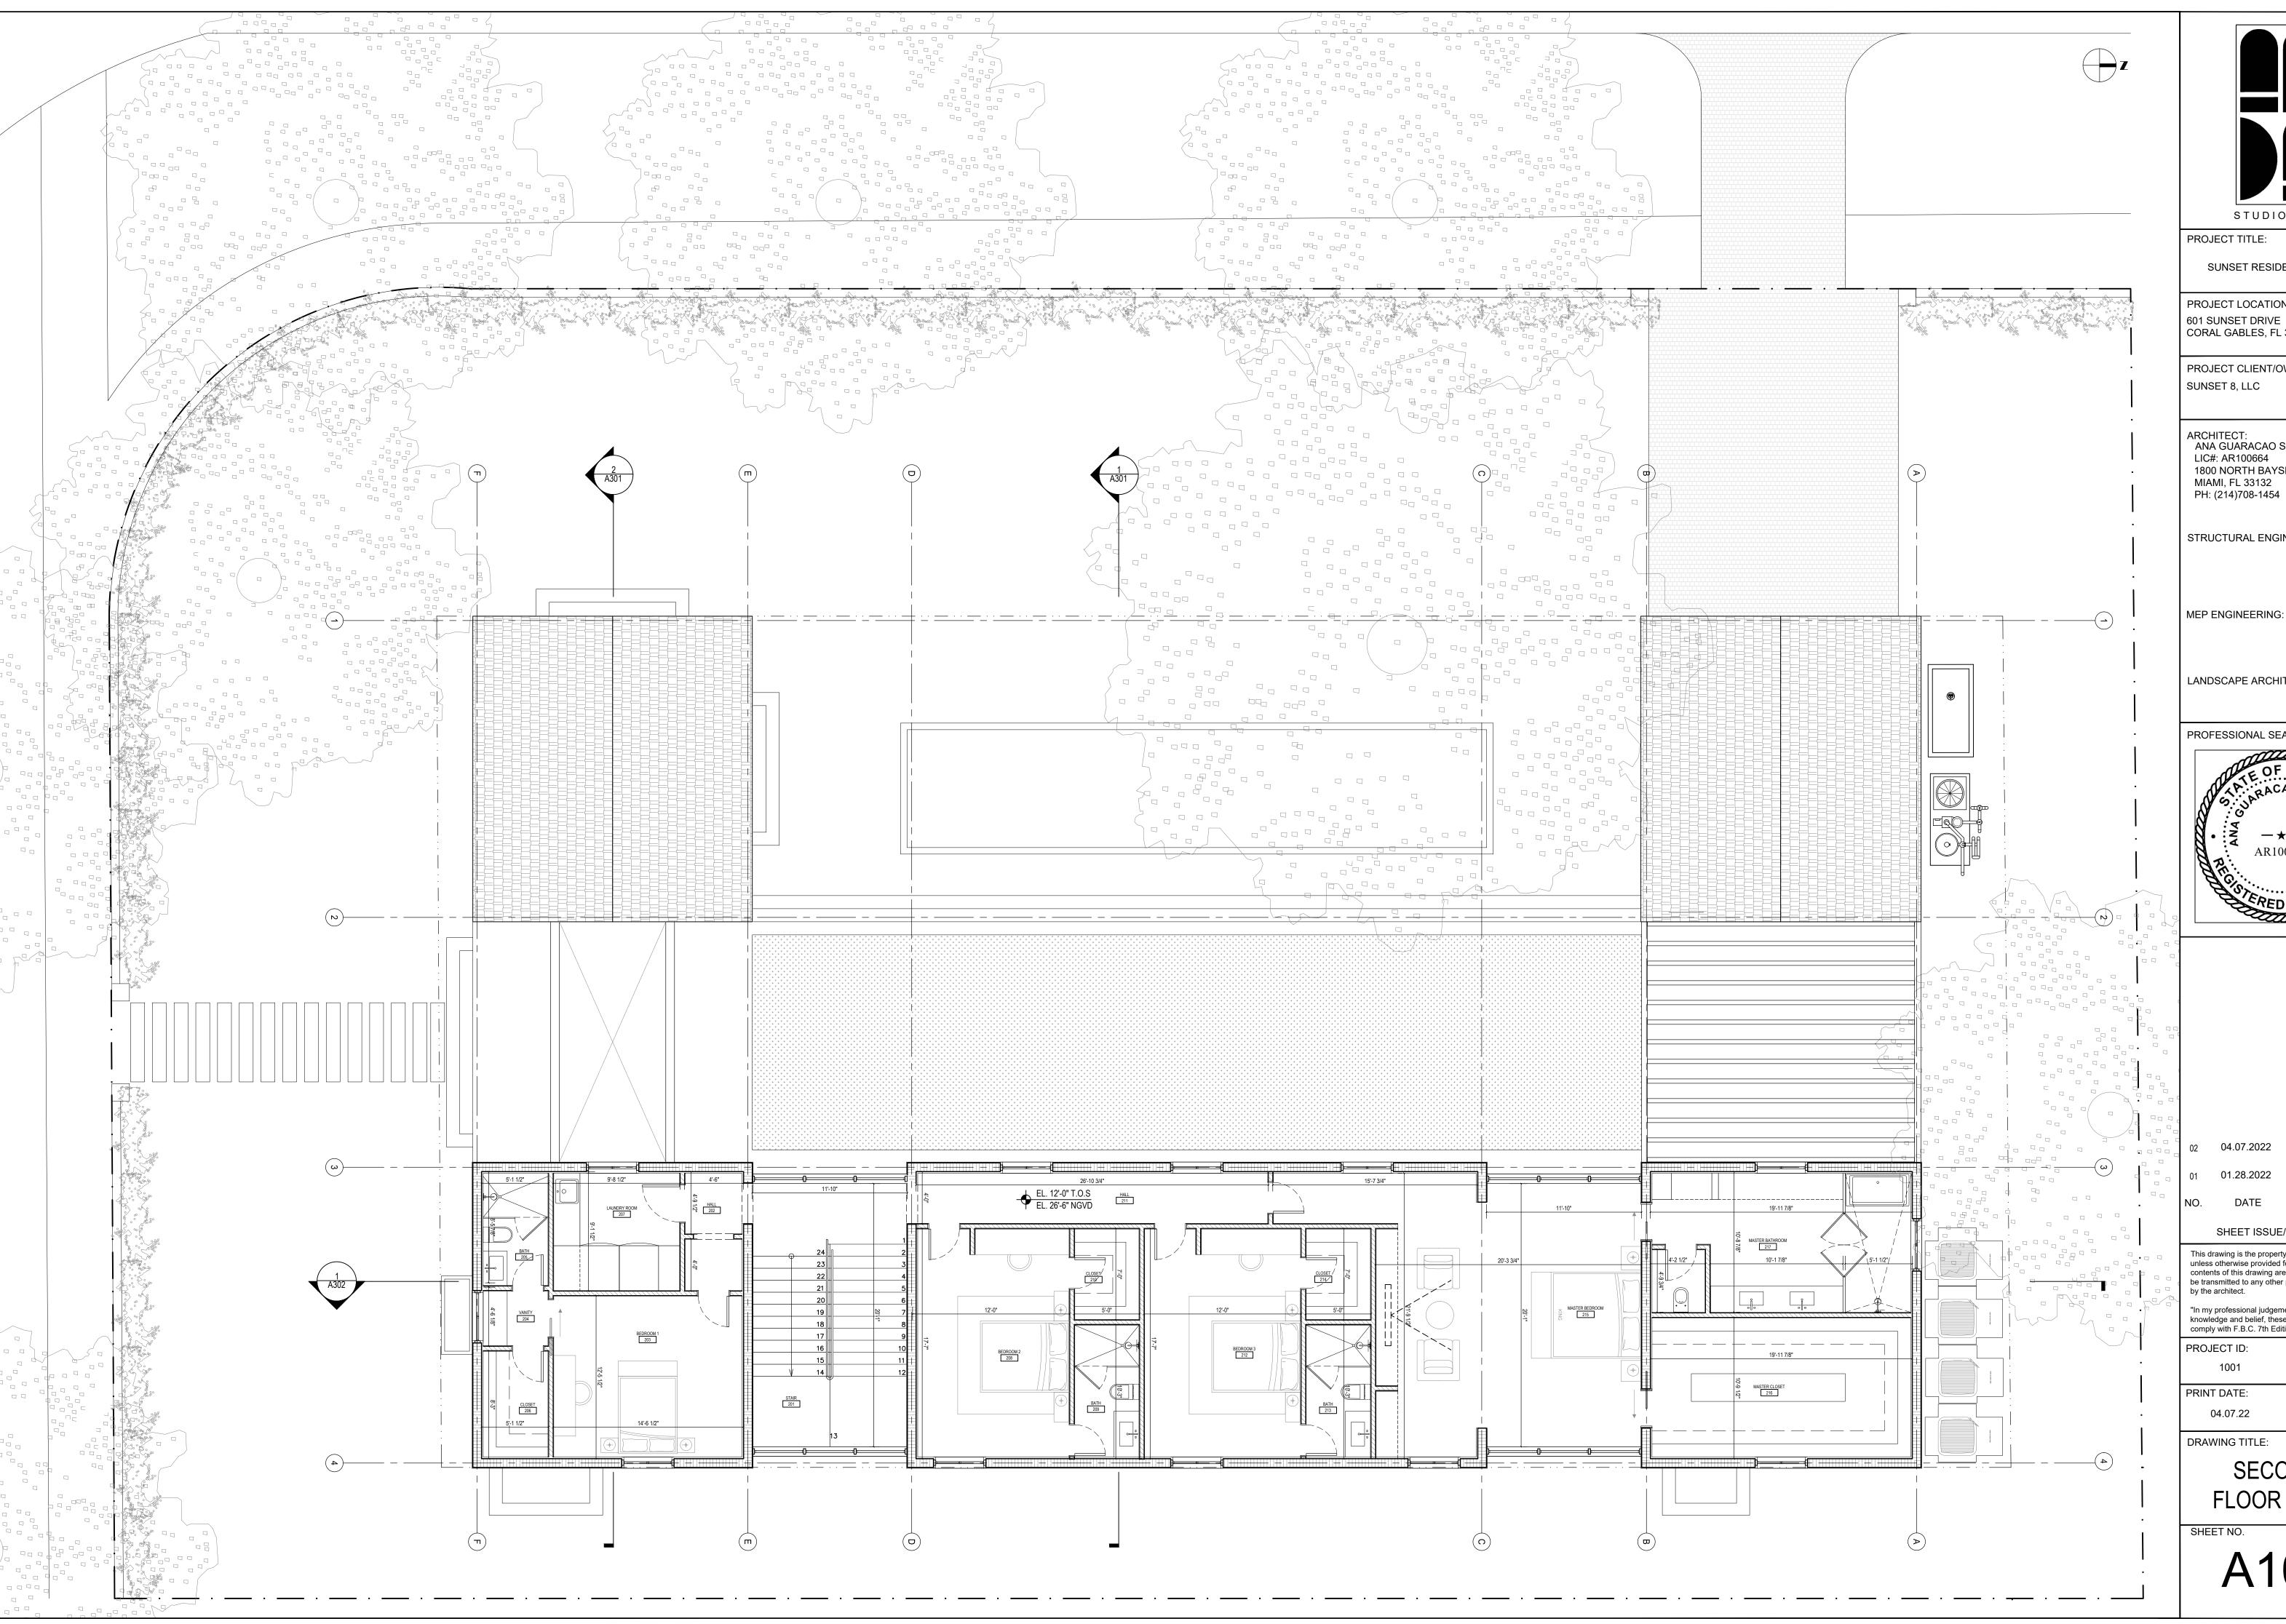

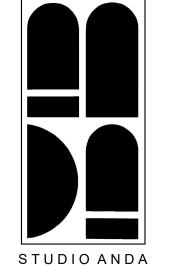

SUNSET RESIDENCE - WEST

PROJECT LOCATION: 601 SUNSET DRIVE CORAL GABLES, FL 33143

PROJECT CLIENT/OWNER(S):


ARCHITECT: ANA GUARACAO SERRANO LIC#: AR100664 1800 NORTH BAYSHORE DRIVE, #402

STRUCTURAL ENGINEERING:

MEP ENGINEERING:

LANDSCAPE ARCHITECT:

PROFESSIONAL SEALS:

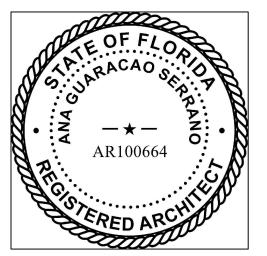

02 04.07.2022 BOA REV.2

01.28.2022 BOA REV.1 DESCRIPTION

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"In my professional judgement and to the best of my knowledge and belief, these plans and specifications comply with F.B.C. 7th Edition (2020).


PROJECT ID: DRAWN BY: 1001 PRINT DATE: SCALE:


3/16"-1'-0"

DRAWING TITLE:

SECOND FLOOR PLAN

A102

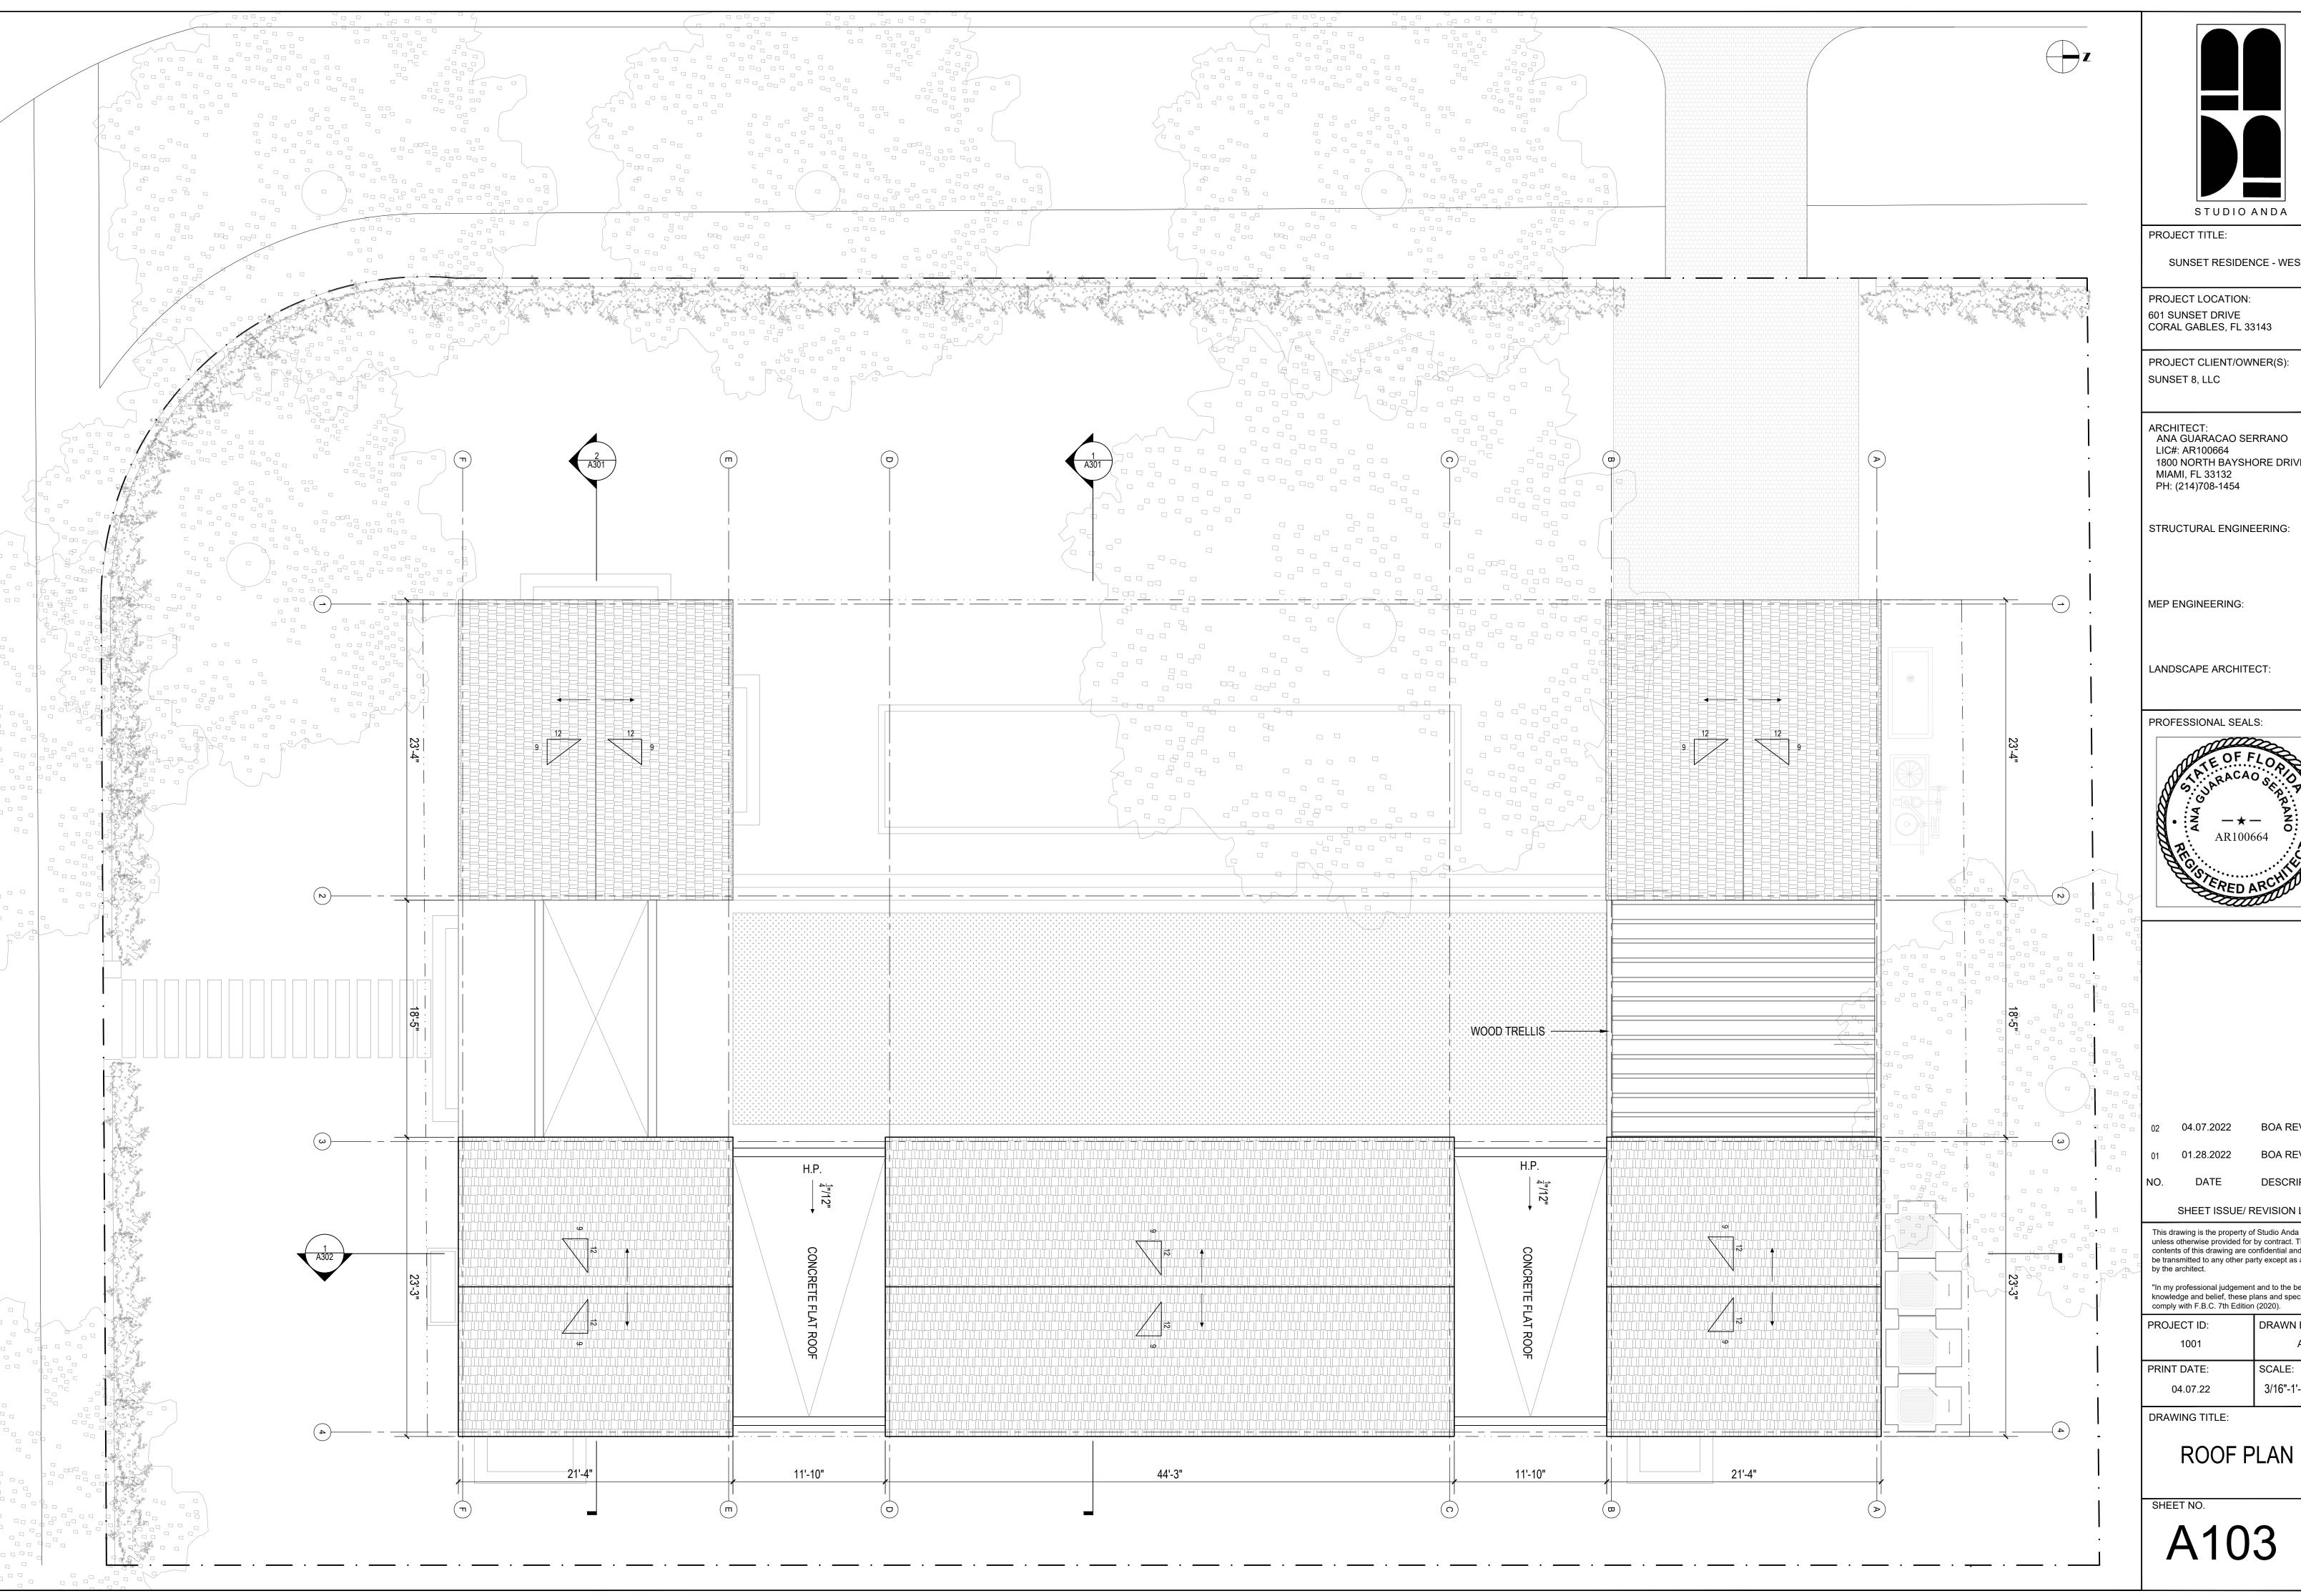

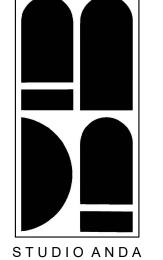

SUNSET RESIDENCE - WEST

PROJECT LOCATION: 601 SUNSET DRIVE CORAL GABLES, FL 33143

PROJECT CLIENT/OWNER(S):

ARCHITECT: ANA GUARACAO SERRANO LIC#: AR100664 1800 NORTH BAYSHORE DRIVE, #402

STRUCTURAL ENGINEERING:

MEP ENGINEERING:

LANDSCAPE ARCHITECT:

PROFESSIONAL SEALS:



02 04.07.2022 BOA REV.2

01.28.2022 BOA REV.1

DESCRIPTION

SHEET ISSUE/ REVISION LOG

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comply with F.B.C. 7th Edition (2020).	
PROJECT ID:	DRAWN BY:
1001	AB
PRINT DATE:	SCALE:

3/16"-1'-0"

04.07.22

DRAWING TITLE:





